

PROJECT DATA
USE: OFFICE
ZONING: BP/TO
PARCEL: 118 117320
PARKING SUMMARY: PARKING REQUIRED: 106 – 282 SPACES PARKING PROVIDED: 210 SPACES ELIMINATED FOR CONNECTIONS: 12 SPACES ADS SPACES REQUIRED: 201–300 1 VAN ACCESSIBLE 6 HANDICAP ADA SPACES PROVIDED: 2 VAN ACCESSIBLE 6 HANDICAP
CALCULATION (COUNTY): OFFICE: 3–8 PER 1,000 SF 35.2 X 3 = 105.6 SPACES, 35.2 X 8 = 281.6 SPACES
CALCULATION (TTCDA): OFFICE: 3–4.5 PER 1,000 SF 35.2 X 3 = 105.6 SPACES, 35.2 X 4.5 = 158.4 SPACES (WAIVER REQUESTED FOR MAXIMUM)
SETBACKS: FRONT: (BP) 50', (TO) 75' SIDE: (BP) 20', (TO) 40' REAR: (BP) 20', (TO) 30'
BUILDING AREA: 35,200 SF 2 STORY
PARCEL AREA: 11.37 AC (INCLUDING OFFICE WAREHOUSE PROPERTY ACROSS CREEK) 4.97 ACRES CONSIDERED IN SITE CALCULATIONS FOR THIS DEVELOPMENT
IMPERVIOUS AREA: 2.39 AC
FLOOR AREA RATIO: 16.3 % IMPERVIOUS AREA RATIO: 48 % GROUND AREA COVERAGE: 8.1 %

10-A-19-UR Revised: 8/29/2019 **£** 535.25'

Θ------Θ

\_\_\_\_

------ SD ------

------ SS ------

— W -

—— NG —

— W -

 $\bigcirc$ 

(W)

 $\bigcirc$ 

NA

NA

NA

NA

NA

535.25'

NA

NA

—— PW ——

—— NG ——

—— FW ——

 $\odot$ 

\_\_\_\_\_X\_\_\_\_\_X·

SPOT ELEVATION

PROPERTY LINE

STORM DRAIN

SANITARY SEWER

POTABLE WATER

FIRE PROTECTION

WATER METER

FIRE HYDRANT

INLET PROTECTION

CONCRETE PAVEMENT

ASPHALT PAVEMENT

SILT FENCING

CURB


NATURAL GAS

MANHOLE


EDGE OF PAVEMENT

STRUCTURE

EASEMENT

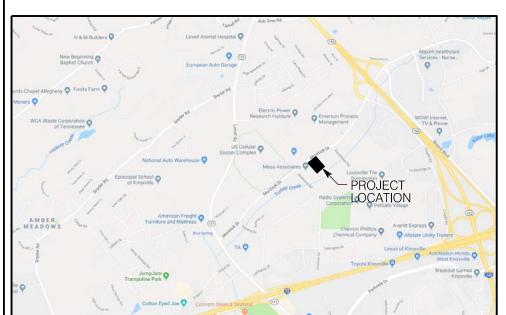

PROJECT LOCATION MAP - NOT TO SCALE

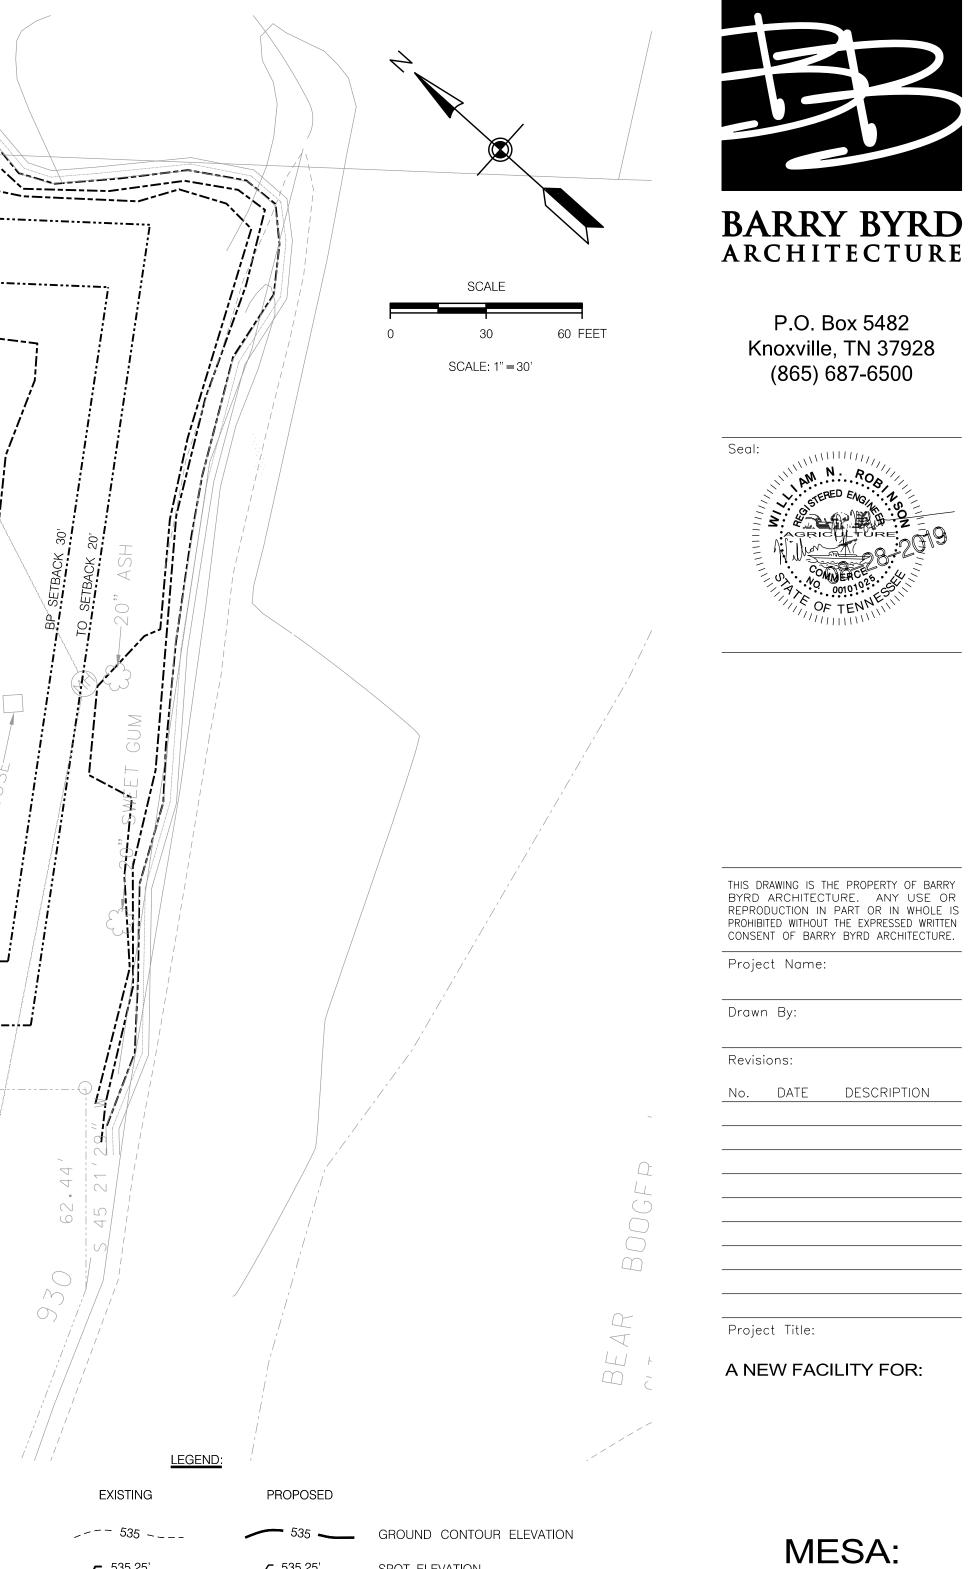



PROPOSED NEW **OFFICE BUILDING** (EAST PROPERTY) 10-A-19-UR/ 9-B-19-TOB


Location:

Sheet Contents:

Sheet Number: MPC01

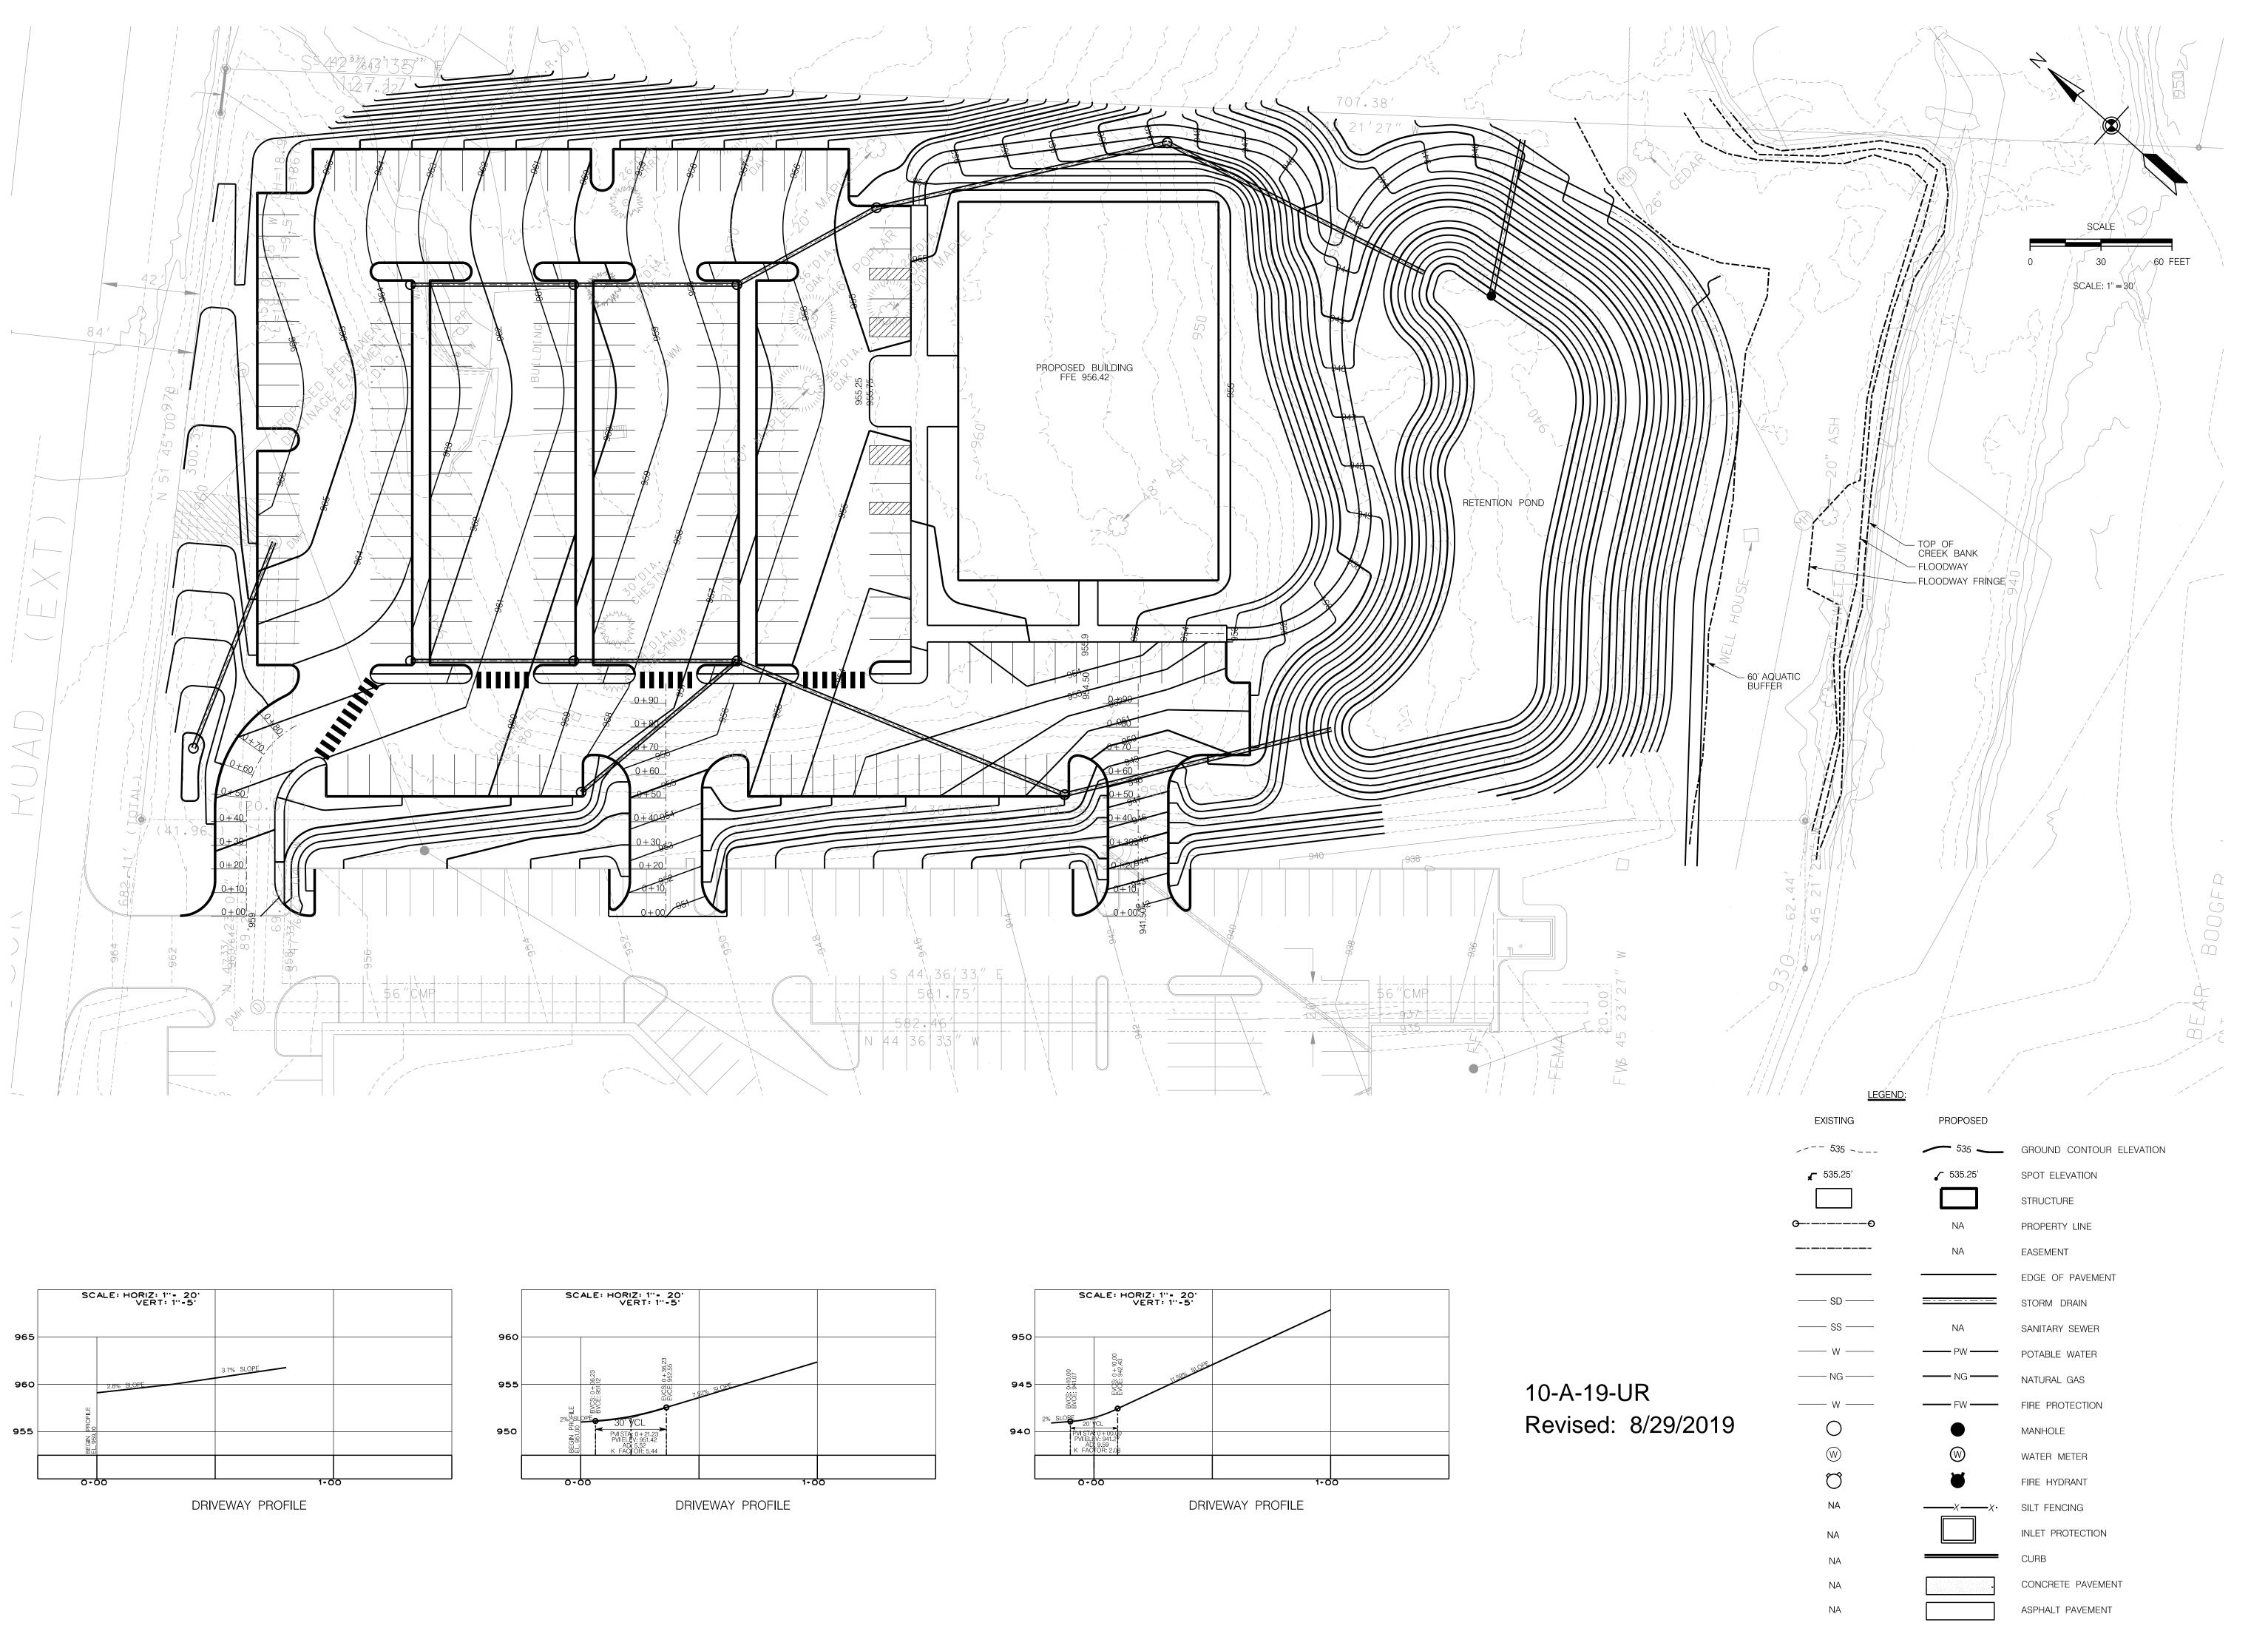

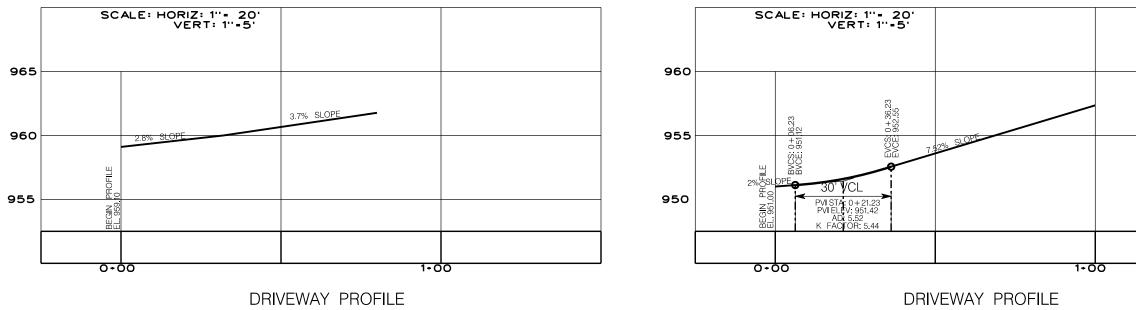

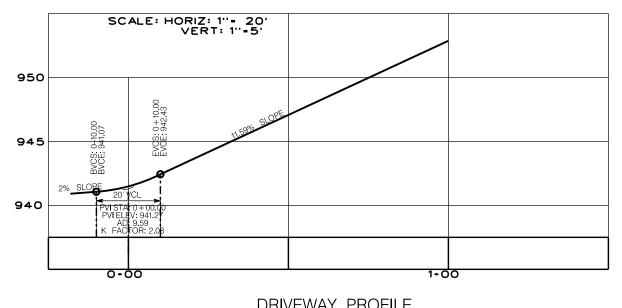

Seal:   Seal:
Knoxville, TN 37928 (865) 687-6500
AGRICHTURE
THIS DRAWING IS THE PROPERTY OF BARR BYRD ARCHITECTURE. ANY USE OF REPRODUCTION IN PART OR IN WHOLE PROHIBITED WITHOUT THE EXPRESSED WRITTE CONSENT OF BARRY BYRD ARCHITECTURE
Project Name:
Drawn By:
Revisions:
No. DATE DESCRIPTION

Project Title:

A NEW FACILITY FOR:

### MESA:

PROPOSED NEW **OFFICE BUILDING** (EAST PROPERTY) 10-A-19-UR/ 9-B-19-TOB

Location:

Sheet Contents:

Date:

Sheet Number: MPC01

**GENERAL NOTES & SPECIFICATIONS** 

LAWN INSTALLATION: Lawn areas shall be fine graded to a smooth, positively draining slope, removing all stones over 3/4". Agricultural limestone shall be incorporated into the soil at a rate of 50 pounds per 1000 square feet. Apply specified seed at recommended rate. Straw mulch or hydromulch shall be used as deemed necessary by the Landscape Contractor and Landscape Architect. The Landscape Contractor shall be responsible to establish a full stand of grass and will repair any bare spots 1'- 0" square due to uneven seed distribution, drought or erosion. SOD INSTALLATION: Sodded lawn areas shall be fine graded to a smooth, positively draining

slope, removing all stones over 3/4". Sod shall be healthy, thick sod placed so that joints are butt tight. Staple as necessary. Sod shall be trimmed to match bed lines shown on plan. Startup fertilizer shall be incorporated into the soil at the manufacturer's recommended rate. Any area of sod that fails to root, settles or dies will be replace by the Landscape Contractor.

UTILITY LOCATION: The Landscape Contractor is responsible for contacting the utility locator service and is responsible for any damage done to utilities.

QUANTITIES Plant quantities are shown for the contractor's convenience only. PLANTS SHALL BE INSTALLED AS SHOWN. Contractor is responsible for confirming all quantities prior to bidding and installation.

BIDS In order to keep all bids standard, all bids are to have unit prices listed. The Owner has the option to delete any portion of the contract prior to signing the contract or beginning work. This will be a unit price contract.

PLANT QUALITY All plants shall be nursery grown, have a full habit of growth as is characteristic of that species, and shall be free of disease or insects. General plant quality shall be as specified in the "USA Standard for Nursery Stock" (published by the American Association of Nurserymen). Please contact the Landscape Architect if there is difficulty in locating a particular plant. If necessary, a substitute plant will be recommended by the Landscape Architect.

PLANTING HOLES Trees and shrubs: Remove rock and construction debris from planting area. Dig holes two to three times as wide as the rootball and only as dep as the height of the root ball. Soil at the bottom ot the hole is left undisturbed. See planting detail additional information.

SETTING OF PLANTS The root ball of container grown plants shall be scarified in several places prior to planting. Plant shrubs and trees so that the top of the root ball will be even with or slightly above the adjacent soil line. SINGLE PLANTING HOLE - backfill bottom half of space around the rootball with loosened original soil (use amended soil only when necessary for good soil tilth, (See ORGANIC AMENDMENTS). Tamp lightly. Finish filling the hole with loose soil and gently tamp again. SHRUB BEDS - Backfill bottom half of bed surrounding shrubs with amended backfill (see ORGANIC AMENDMENTS). Tamp lightly and water to settle soil Finish filling hole with llose amended backfill and gently tamp again. Water shrub bed to settle soil. PLANTINGS NOT DONE IN THIS MANNER SHALL BE REMOVED AND PROPERLY REPLANTED.

ORGANIC AMENDMENTS Organic amendments should be added to backfill for all shrub beds and when deemed necessary to improve soil tilth of single planting holes. Organic matter should comprise approximately 10 to 20 percent of this total soil volume.

PREPARATION OF GROUND COVER AND SEASONAL COLOR BEDS : The existing soil in ground cover and seasonal color beds shall be thoroughly cultivated 6 inches deep, to a fine texture (no clods over 1/2") with a mechanical tiller. A plant mix of 60% screened shredded topsoil, 20% sand, and 20% well rotted sawdust or peat shall then be thoroughly incorporated into the existing soil with the tiller so that the soil mix (6" deep) is 1/2 original soil and 1/2 plant mix. All groundcover and seasonal color beds shall receive a 2" layer of fine textured, screened, pine bark mulch, or equal. PLANTINGS NOT DONE IN THIS MANNER SHALL BE REMOVED AND PROPERLY REPLANTED.

FERTILIZING Upon completion of plantings, all shrubs shall receive 1/6 cup of 16-4-8 fertilizer (50% of nitrogen slow release) evenly broadcast at the base of the plants. Trees shall receive 1/4 cup of 16-4-8 fertilizer (50% of nitrogen slow release) per inch of caliper. Ground cover beds shall be fertilized at the rate of 20 pounds of 16-4-8 ( 50% of nitrogen slow release) per 1000 square feet.

STAKING OF TREES Trees should only be staked if necessary, such as when planted in areas of high winds or steep slopes. Under certain circumstances, others may be staked at the discretion of the Landscape Contractor or Landscape Architect. The Landscape Contractor is responsible for all wind damage to trees, (provided winds are less than 60 mph) during the guarantee period, and may stake other trees (for his own protection) at his option. Landscape Contractor will be responsible for removal of all staking material one year after installation.

TRANSPLANTS All plant material to be transplanted shall be transplanted according to guidelines set by AAN standards. Transplanted material will not be guaranteed by the landscape contractor.

MULCHING As specified on planting list. Hardwood mulch: All beds to receive a 3" layer of aged hardwood bark mulch (free of wood chips or large chunks of bark). Fresh hardwood bark mulch is not recommended to be used, as water run-off may cause staining on adjacent concrete surfaces. All damages incurred by the use of fresh hardwood mulch shall be the responsibility of the landscape contractor. Pinestraw: All beds to receive a 4" layer (prior to compaction) of pinestraw. After natural compaction, pinestraw should have a depth of 2". All trees located in lawn areas shall receive a 3' diameter ring of mulch. Mulch in these areas

is to follow the above listed guidelines.

GRADING All final grading shall be the responsibility of the landscape contractor. The responsibility for any additional grading (if needed) shall be determined prior to bidding.

BACKFILL Landscape contractor to verify any additional backfill/topsoil needed prior to beginning work. A unit price for topsoil shall be included in all bid documents to allow for circumstances that might arise during installation.


CLEAN UP Final clean up of any disturbances occurring as a result of landscape operations shall be the responsibility of the landscape contractor.


INSPECTION It shall be the contractor's responsibility to provide for inspection of the plant material by the Landscape Architect prior to installation. All plant material will be inspected. Plants not conforming precisely to the plant list will not be accepted and shall be replaced at the contractor's own expense.

LICENSES The contractor will be responsible for obtaining all licenses necessary to complete the work.

INSURANCE With the submittal of bid documents, the landscape contractor shall also submit a certificate of insurance for workman's compensation and a contractor's general liability. Contractors not providing evidence of such insurance will be ineligible to recieve the contract for the job

GUARANTEE All plant material and workmanship to be guaranteed for one year from the date of acceptance by the Owner. Plant replacement to occur only once. The contractor will not be responsible for defects resulting from neglect by the Owner, abuse or damage by others, or unusual phenomena or incidents beyond the landscape contractors control which result from natural causes such as floods, lightning, storms, freezing rains, or winds over 60 miles per hour, fire, vandalism or theft.

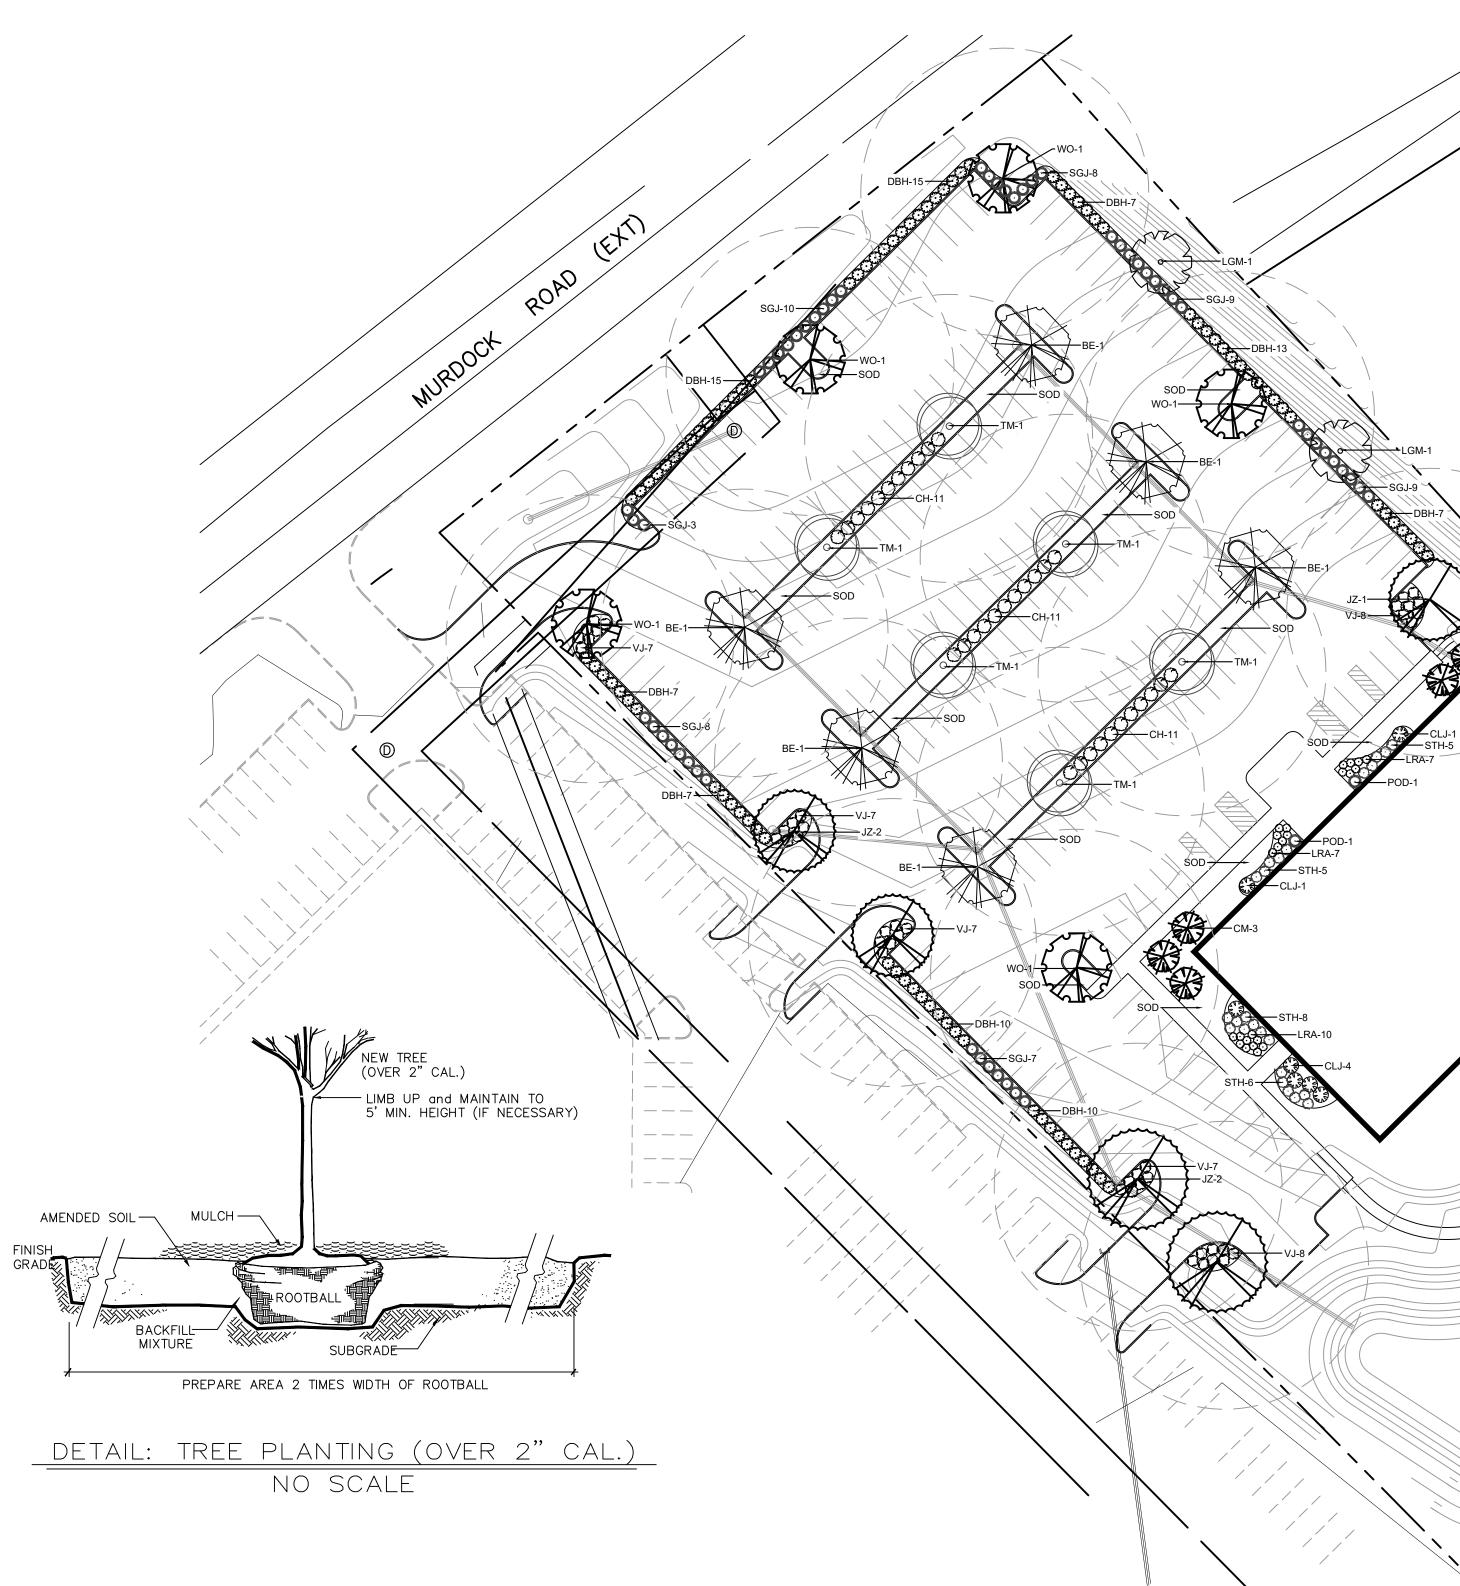

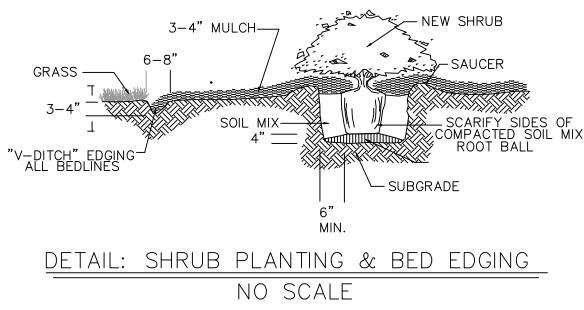

	KEY	QUANTITY	COMMON NAME	BOTANICAL NAME	INIMUM SIZE AT TIN
•	BE CM JZ LGM TM WO	6 6 5 2 6 4	BOSQUE ELM CRAPE MYRTLE JAPANESE ZELKOVA LITTLE GEM MAGNOLIA TRIDENT MAPLE WILLOW OAK	ULMUS PARVIFOLIA 'UPMTF' LAGERSTROEMIA (I.X. FAURIEI 'SIOUX) ZELKOVA SERRATA MAGNOLIA GRANDIFLORA 'LITTLE GEM' ACER RUBRUM 'BUERGERIANUM' QUERCUS PHELLOS	2 1/2" CALIPE 6' HEIGHT (3 ( 2 1/2" CALIPE 2 1/2" CALIPE 2 1/2" CALIPE 2 1/2" CALIPE 2 1/2" CALIPE
	CH CLJ DBH LRA POD VJ SGJ STH	33 6 105 24 2 29 55 24	COMPACTA HOLLY CLEYERA DWARF BURFORD HOLLY LITTLE RICHARD ABELIA PODOCARPUS VINTAGE JADE SEA GREEN JUNIPER SOFT TOUCH HOLLY	ILEX CRENATA 'COMPACTA' CLEYERA JAPONICA ILEX CORNUTA 'BURFORDII NANA' ABELIA x 'LITTLE RICHARD' PODOCARPUS MACROPHYLLUS VAR. M/ DISTYLIUM 'VINTAGE JADE' pp23,128 JUNIPERUS CHINENSE 'SEA GREEN' ILEX CRENATA 'SOFT TOUCH'	3 GALLON 3 GALLON 3 GALLON 3 GALLON 3 GALLON 3 GALLON 3 GALLON 3 GALLON
	SOD MULCH	BERMUDA HARDWOOD 4" DEPTH NOTES:			

PLANT LIST

1. PLANT MATERIAL / SOD / MULCH SHALL BE VERIFIED BY THE LANDSCAPE CONTRACTOR PRIOR TO BIDDING. ANY DISCREPANCIES SHALL BE REPORTED TO THE LANDSCAPE ARCHITECT IMMEDIATELY. LANDSCAPE ARCHITECT ASSUMES NO LIABILITY FOR QUANTITY DISCREPANCIES. 2. CONTRACTOR TO VERIFY THAT ALL PLANT MATERIALS ARE AVAILABLE, AS SPECIFIED, WHEN

- PROPOSAL IS SUBMITTED. 3. NO PLANT MATERIAL SUBSTITUTIONS WILL BE ACCEPTED WITHOUT WRITTEN APPROVAL BY THE LANDSCAPE ARCHITECT PRIOR TO INSTALLATION.
- 4. LANDSCAPE ARCHITECT OR OWNER SHALL HAVE THE RIGHT, AT ANY STAGE OF THE CONSTRUCTION OPERATION, TO REJECT ANY AND ALL WORK WHICH, IN HIS OPINION, DO NOT MEET THE REQUIREMENTS OF THESE PLANS OR SPECIFICATIONS.

#### LANDSCAPE REGULATIONS FOR KNOX COUNTY

PARKING AREAS LOCATED CLOSER THAN FIFTY (50) FEET TO PUBLIC RIGHT-OF-WAY SHALL BE SCREENED BY EVERGREEN PLANTING

LANDSCAPE REQUIREMENTS FOR TECHNOLOGY CORRIROR

#### **SECTION 3.1 SITE**

10 LARGE MATURING TREES PER ACRE OF YARD SPACE YARD SPACE = APPROX. 1.6 ACRES x 10 / 16 TREES REQUIRED PROVIDED:

#### SECTION 3.3 BUILDINGS

AREAS AROUND BUILDINGS EQUAL TO 50% OF THE AREA OF EACH FRONT AND SIDE ELEVATION SHALL BE PLANTED WITH ORNAMENTAL TREES, SHRUBBERY AND BEDDING

#### SECTION 3.4 PARKING

TREES SHALL BE REQUIRED AT THE RATE OF ONE (1) TREE FOR EVERY TEN PARKING SPACES PROVIDED 208 PARKING SPACES / 10 = 21 TREES REQUIRED PROVIDED:



REVISED PER COMMENTS GMA 08/29/2019 SUBMITTED FOR APPROVAL GMA 07/16/2019 REVISIONS

U 5 S Ш U 2 U 0 0 5 S 5 Ш Е

THIS DOCUMENT IS THE PROPERTY O McLEOD LANDSCAPE ARCHITECTS, LLC.

THE UNAUTHORIZED USE. REPRODUCTI

OR COPYING OF THIS DOCUMENT IS

STRICTLY PROHIBITED AND IS TO BE RETURNED UPON REQUEST.

DRAWN

GMA

CHECKED

JPMc

DATE **JULY, 2019** SCALE

1"=40'


JOB. NO.

19027

SHEET


IME OF PLANTING CANE MIN / 5 CANE MAX)

> 10-A-19-UR Revised: 8/29/2019

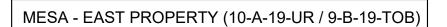



The materials on this building are intended to match the existing materials on the main MESA building.

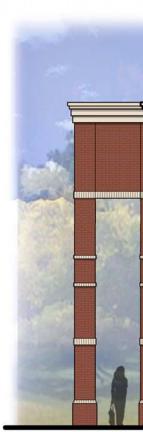



 $\underbrace{2}_{1/8"} \underbrace{\text{WEST ELEVATION (FACING MAIN MESA CAMPUS)}}_{1/8"} = 1'-0"$ 

## PROPOSED OFFICE BUILDING MESA ASSOCIATES MURDOCK DR., KNOXVILLE, TN

Project # 10-A-19-UR / 9B-19-TOB Revised August 29, 2019



The materials on this building are intended to match the existing materials on the main MESA building.




EIFS Trim to match existing

Brick to match existing building

Building





### PROPOSED OFFICE BUILDING MESA ASSOCIATES MURDOCK DR., KNOXVILLE, TN

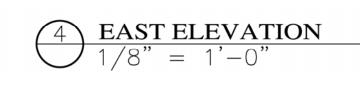





Project # 10-A-19-UR / 9B-19-TOB Revised August 29, 2019

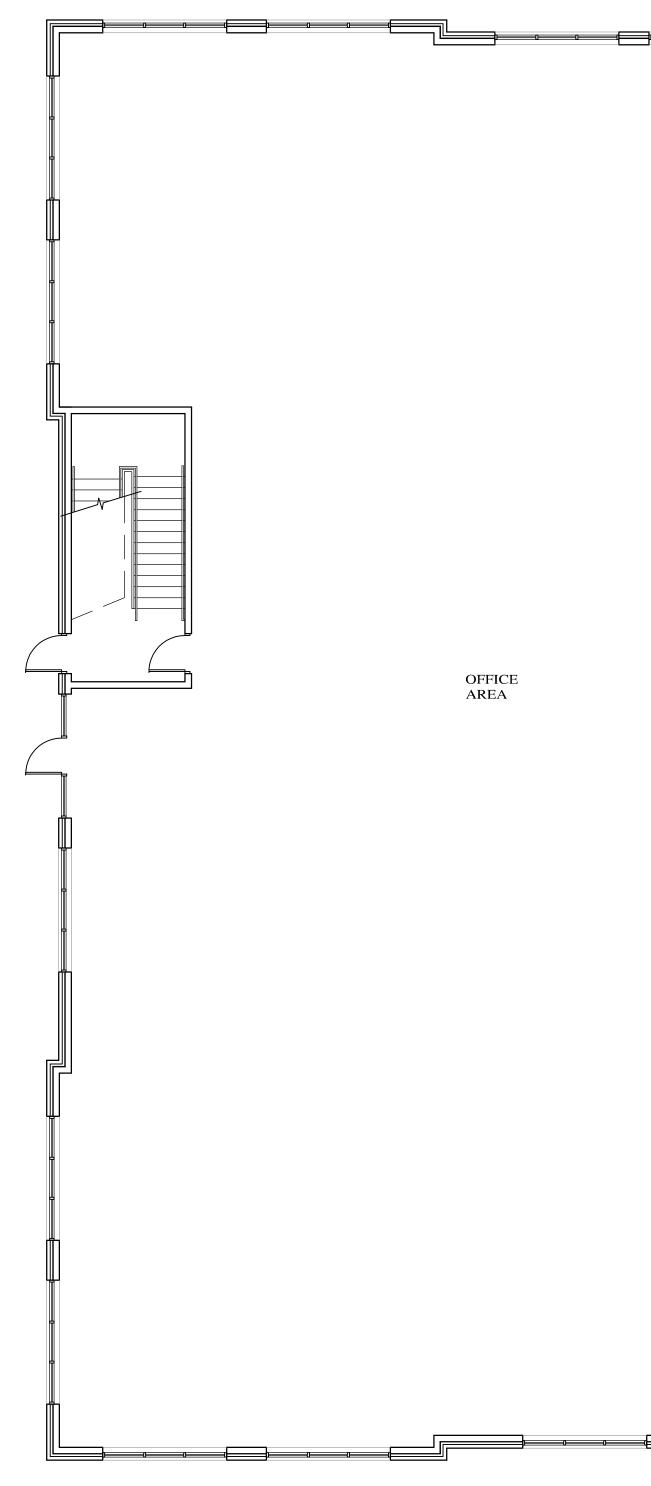

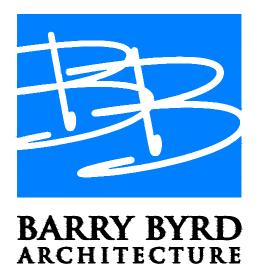



# PROPOSED OFFICE BUILDING MESA ASSOCIATES MURDOCK DR., KNOXVILLE, TN

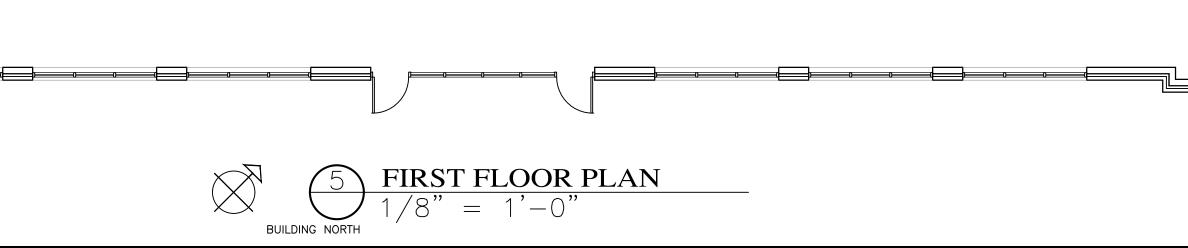

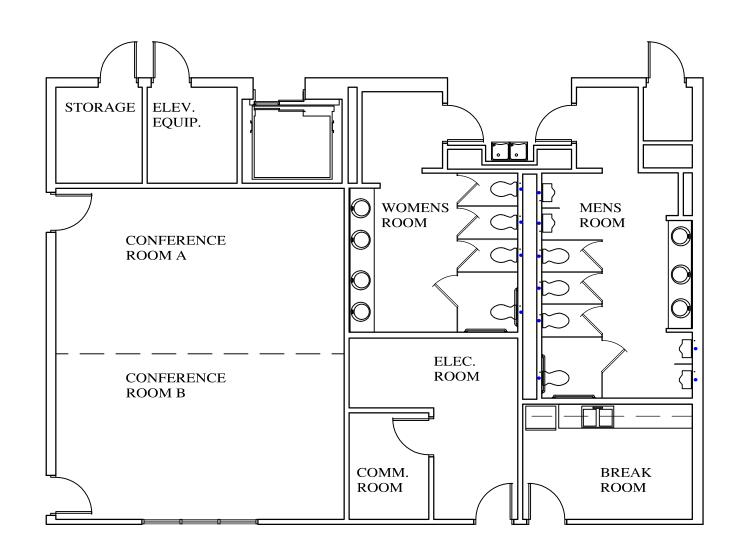



OFFICE AREA

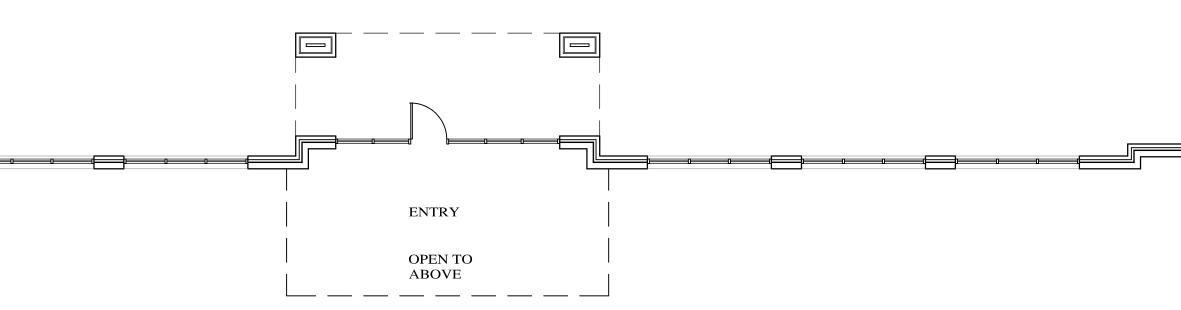

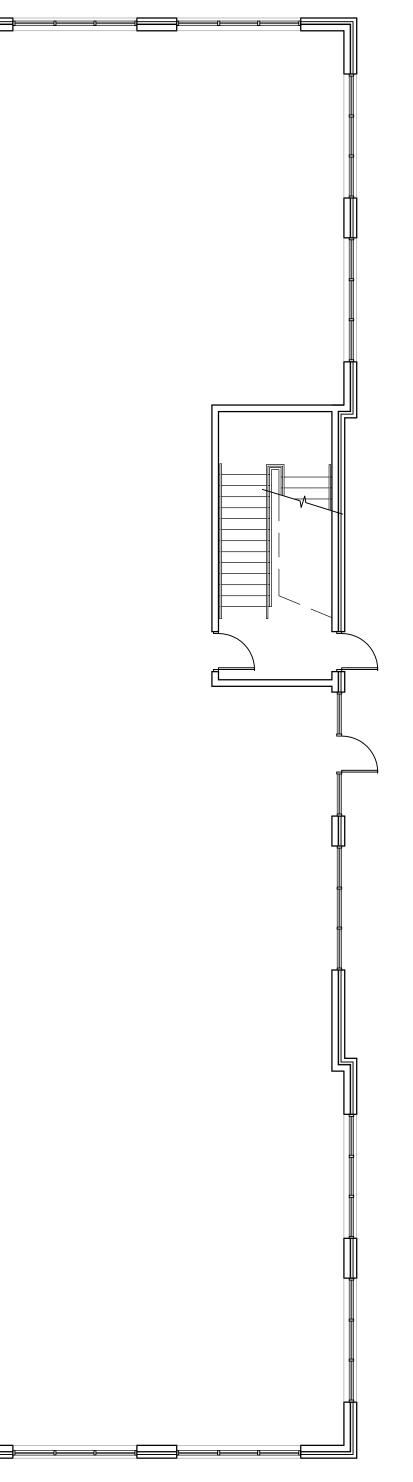



Revised: 8/29/2019

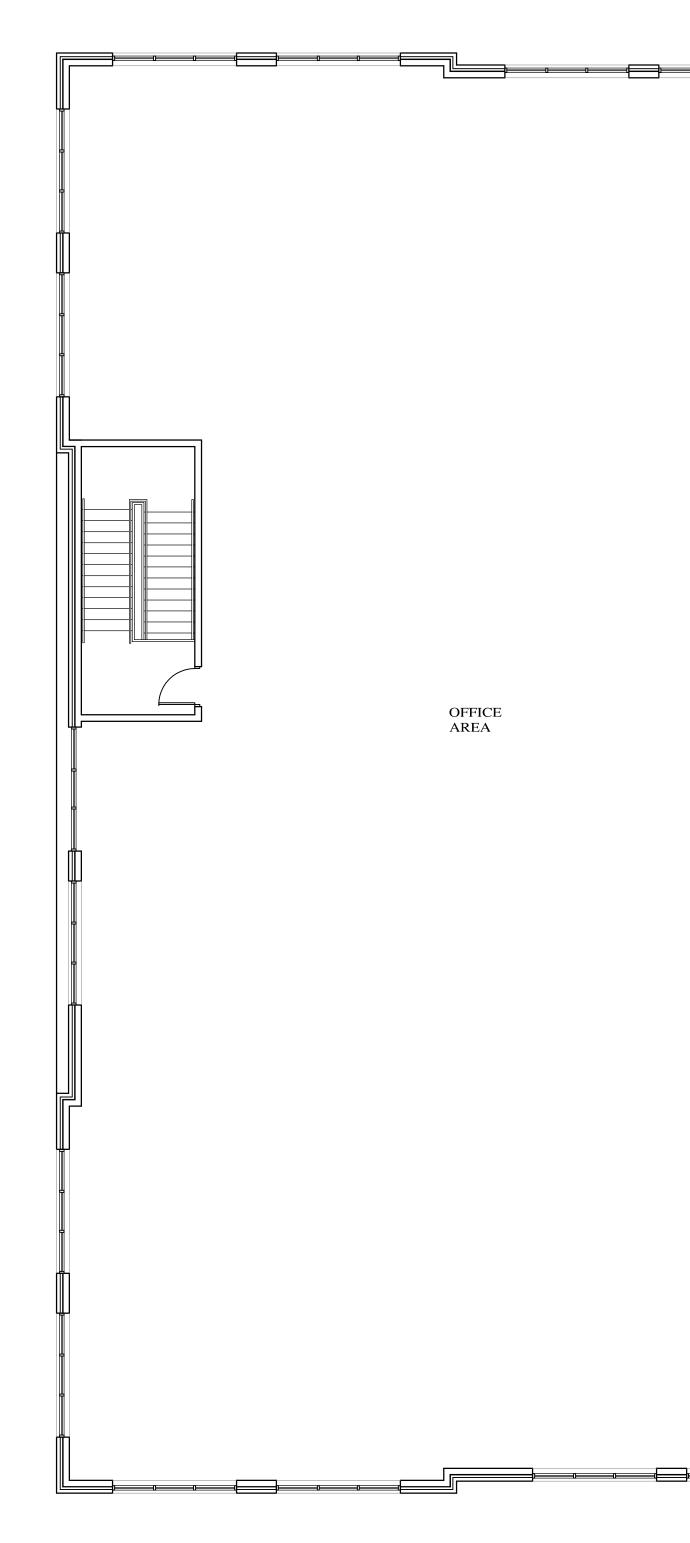

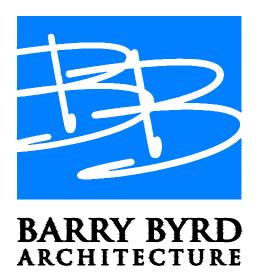



# PROPOSED OFFICE BUILDING MESA ASSOCIATES MURDOCK DR., KNOXVILLE, TN

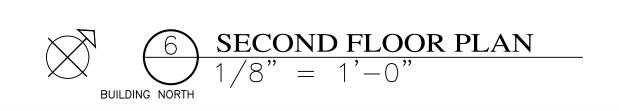

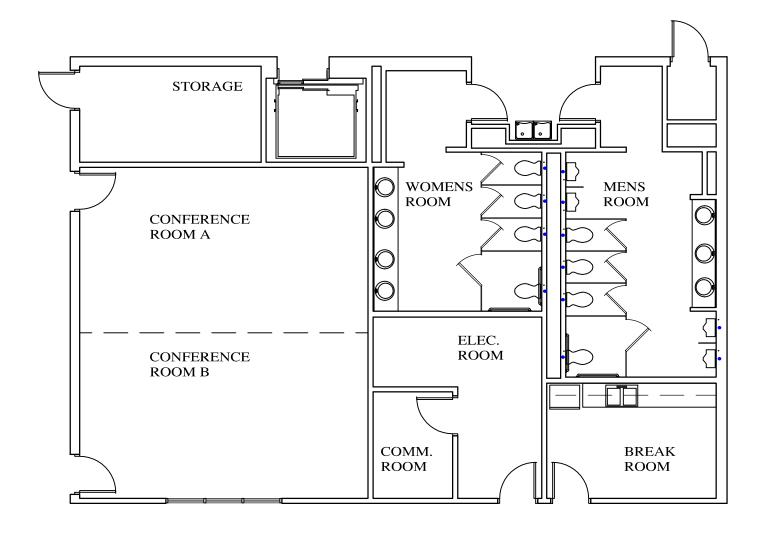

OFFICE AREA

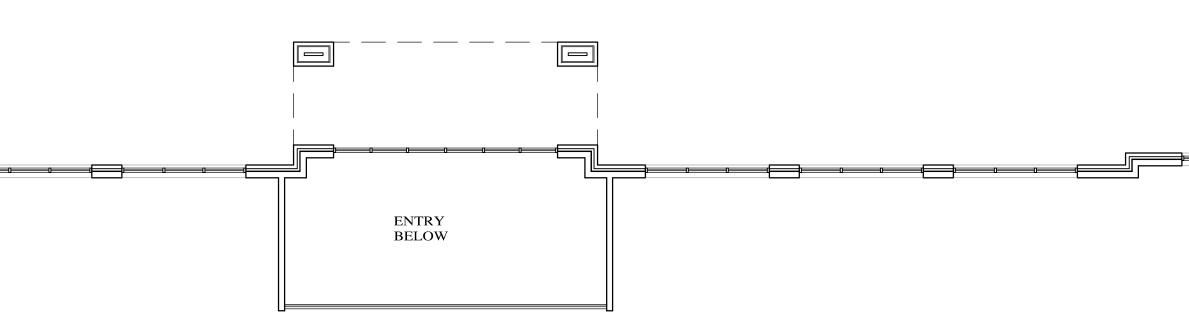

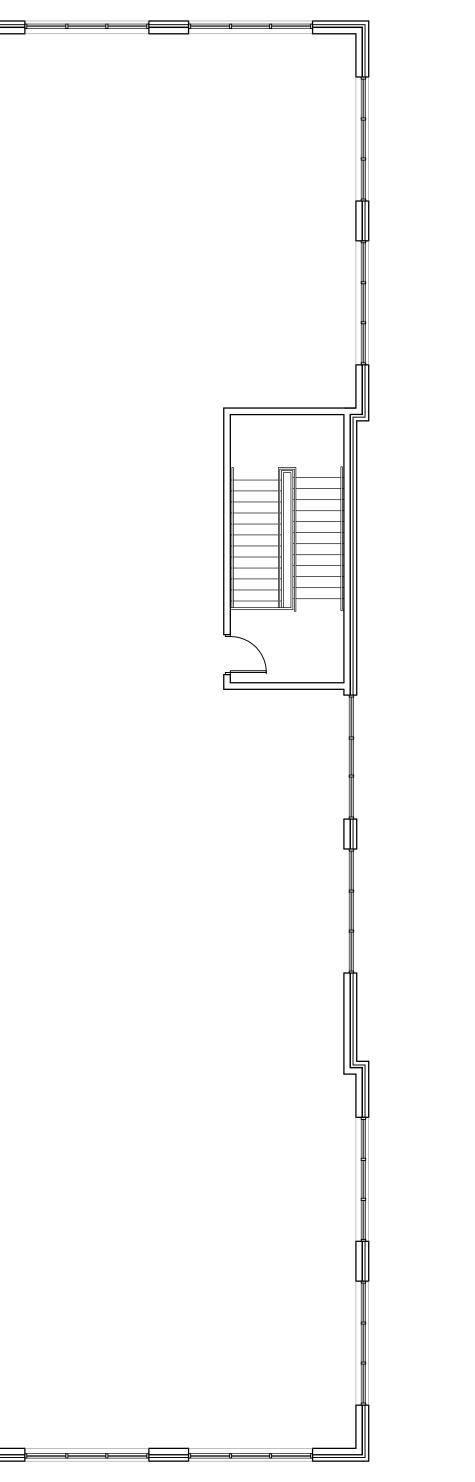

Revised: 8/29/2019