




ven Flositz Friday, September 02, 2016 P:\3887 - TAPESTRY AT KNOXVILLE\DRAWINGS\1_APARTMENT\00_CURRENT\3887

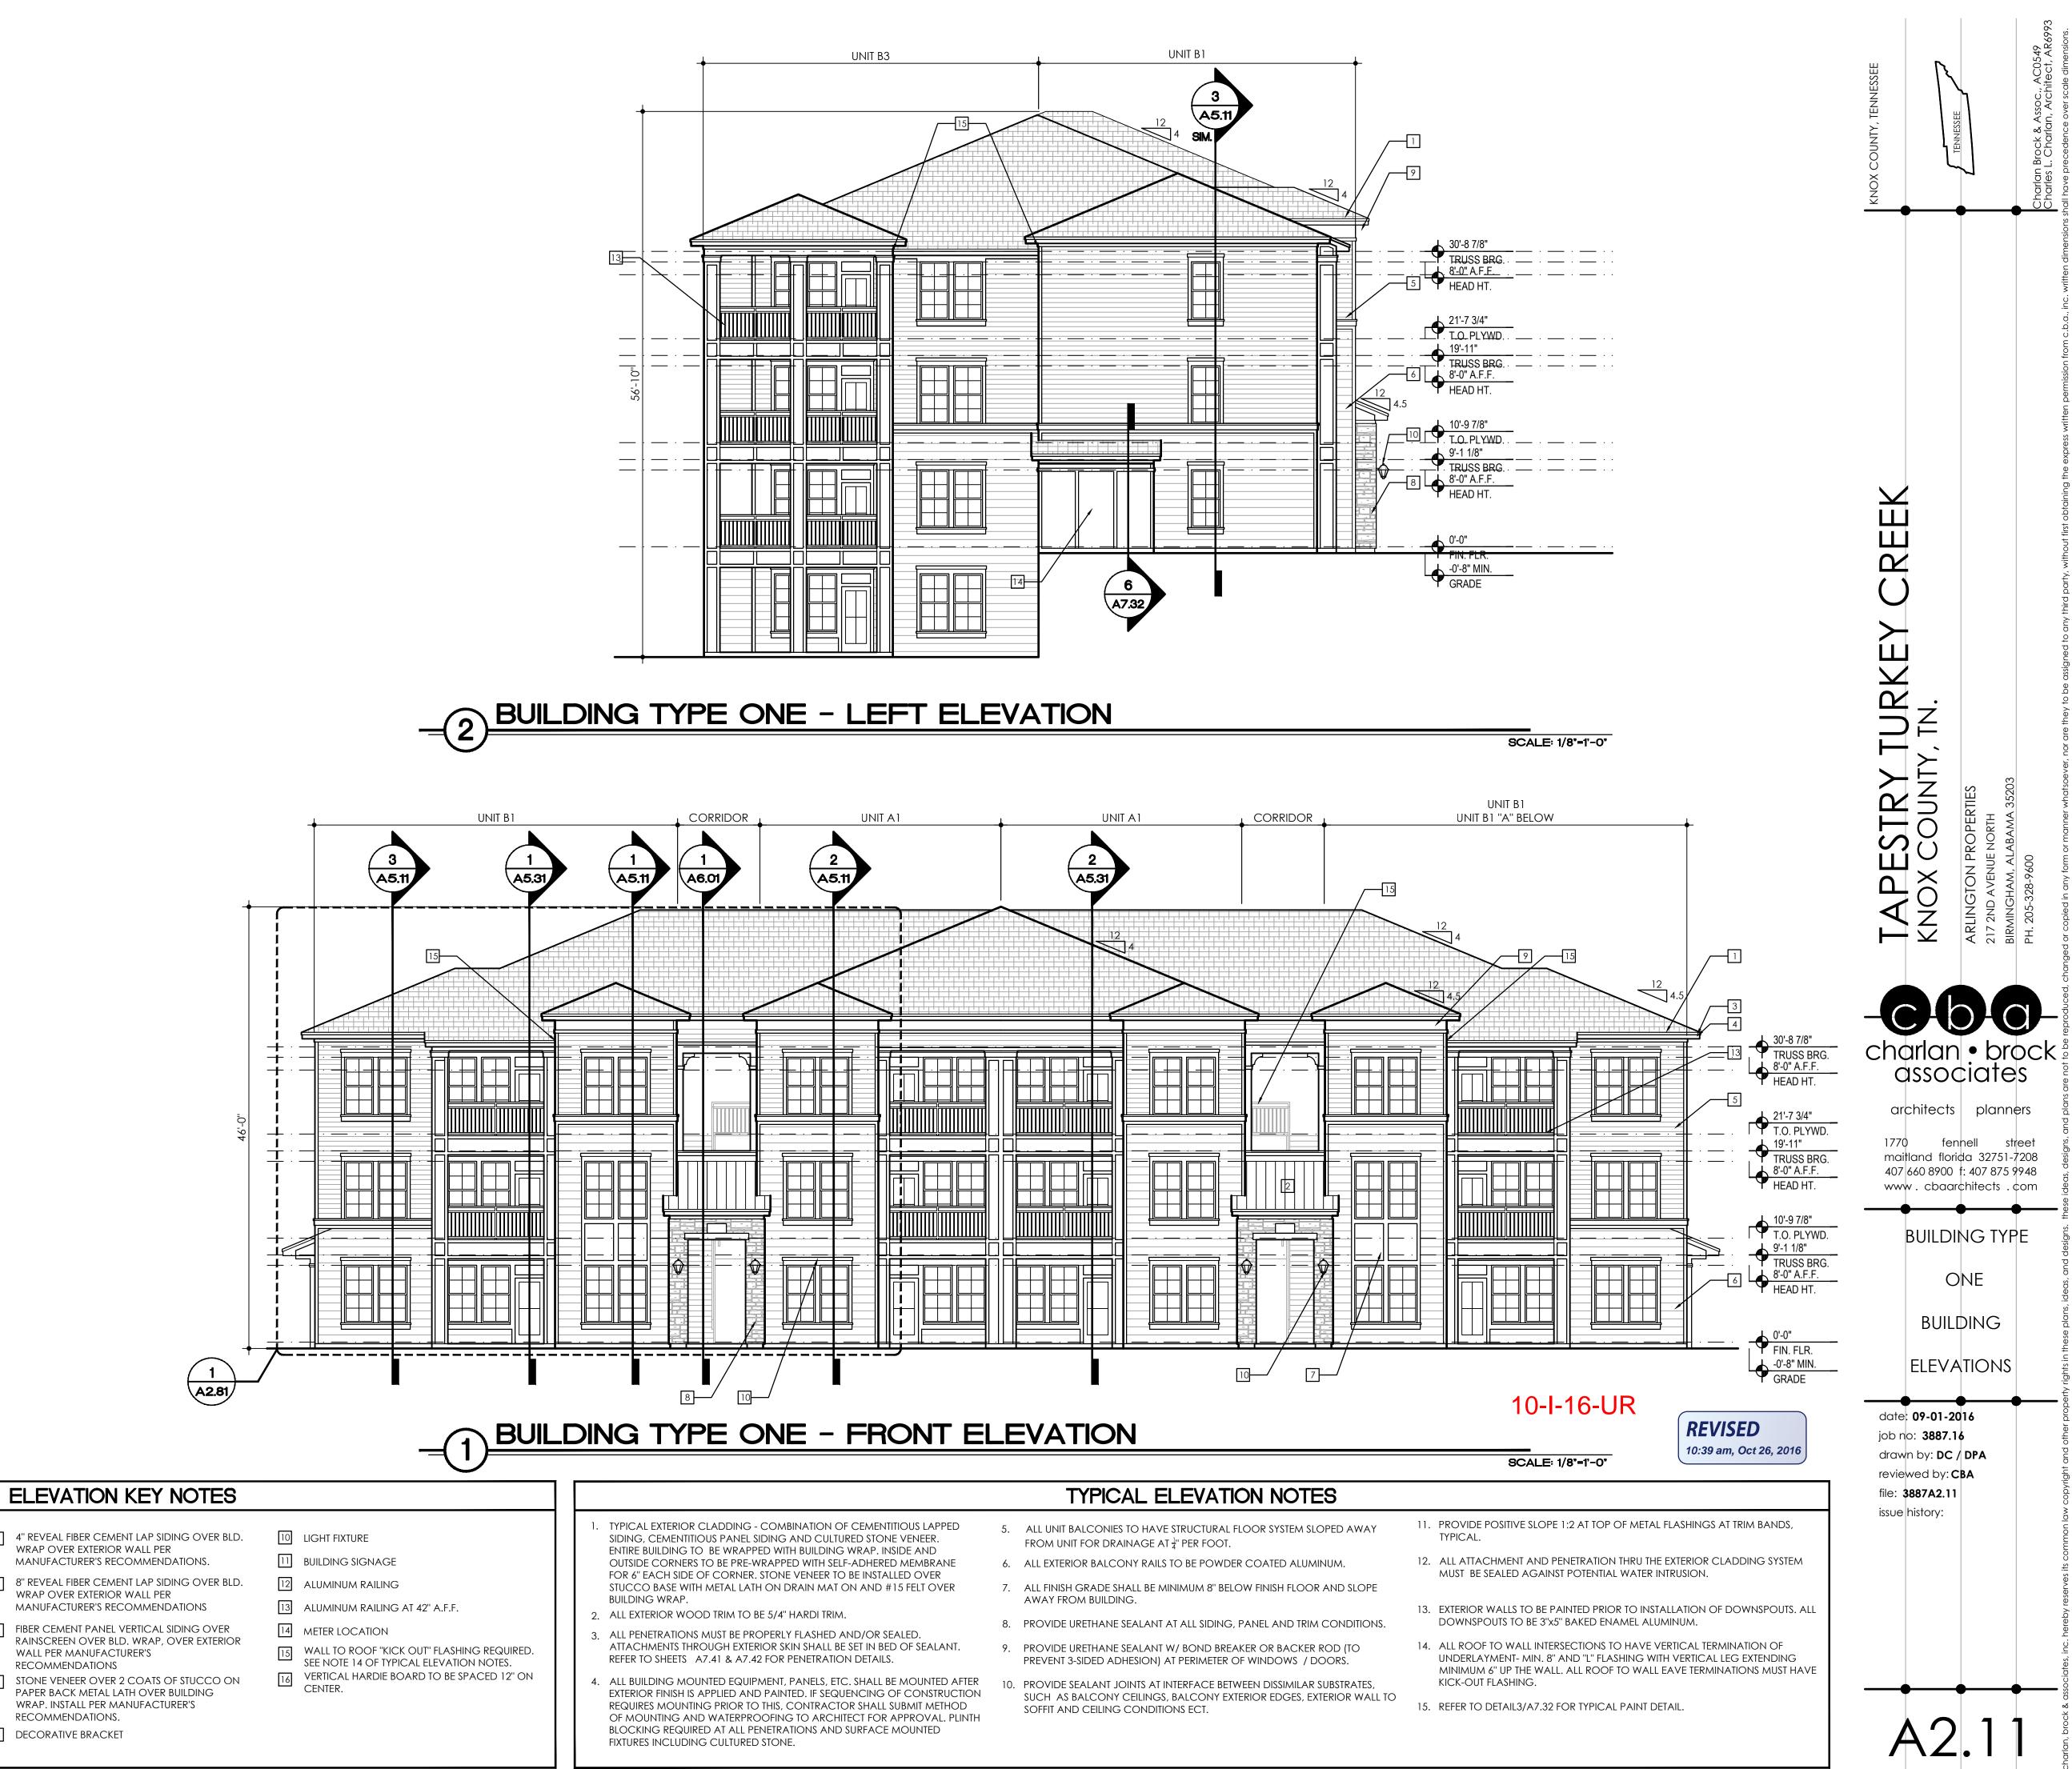


ARCHITECTURAL STYLE SHINGLES, OVER #30 5 4" REVEAL FIBER CEMENT LAP SIDING OVER BLD. FELT, OVER ROOF SHEATHING, OVER WRAP OVER EXTERIOR WALL PER PRE-EGINEERED ROOF TRUSSES. PROVIDE 36" MANUFACTURER'S RECOMMENDATIONS. WIDE 30 MIL SELF-ADHERING MEMBRANE, 6 8" REVEAL FIBER CEMENT LAP SIDING OVER BLD. CENTERED IN VALLEYS, OVER ROOF SHEATHING. WRAP OVER EXTERIOR WALL PER 2 STANDING SEAM METAL ROOF OVER 40 MIL. MANUFACTURER'S RECOMMENDATIONS HIGH TEMPERATURE MEMBRANE. INSTALL PER 7 FIBER CEMENT PANEL VERTICAL SIDING OVER MANUFACTURER'S RECOMMENDATIONS. RAINSCREEN OVER BLD. WRAP, OVER EXTERIOR 3 ALUMINUM DRIP EDGE ON ALUMINUM WRAPPED WALL PER MANUFACTURER'S TREATED 1X3 ON TREATED 2X10 FASCIA BOARD RECOMMENDATIONS WITH ALUMINUM GUTTER PER ROOF PLAN 8 STONE VENEER OVER 2 COATS OF STUCCO ON PAPER BACK METAL LATH OVER BUILDING 4 ANODIZED ALUMINUM GUTTER & DOWNSPOUT WRAP. INSTALL PER MANUFACTURER'S SYSTEM RECOMMENDATIONS. 9 DECORATIVE BRACKET

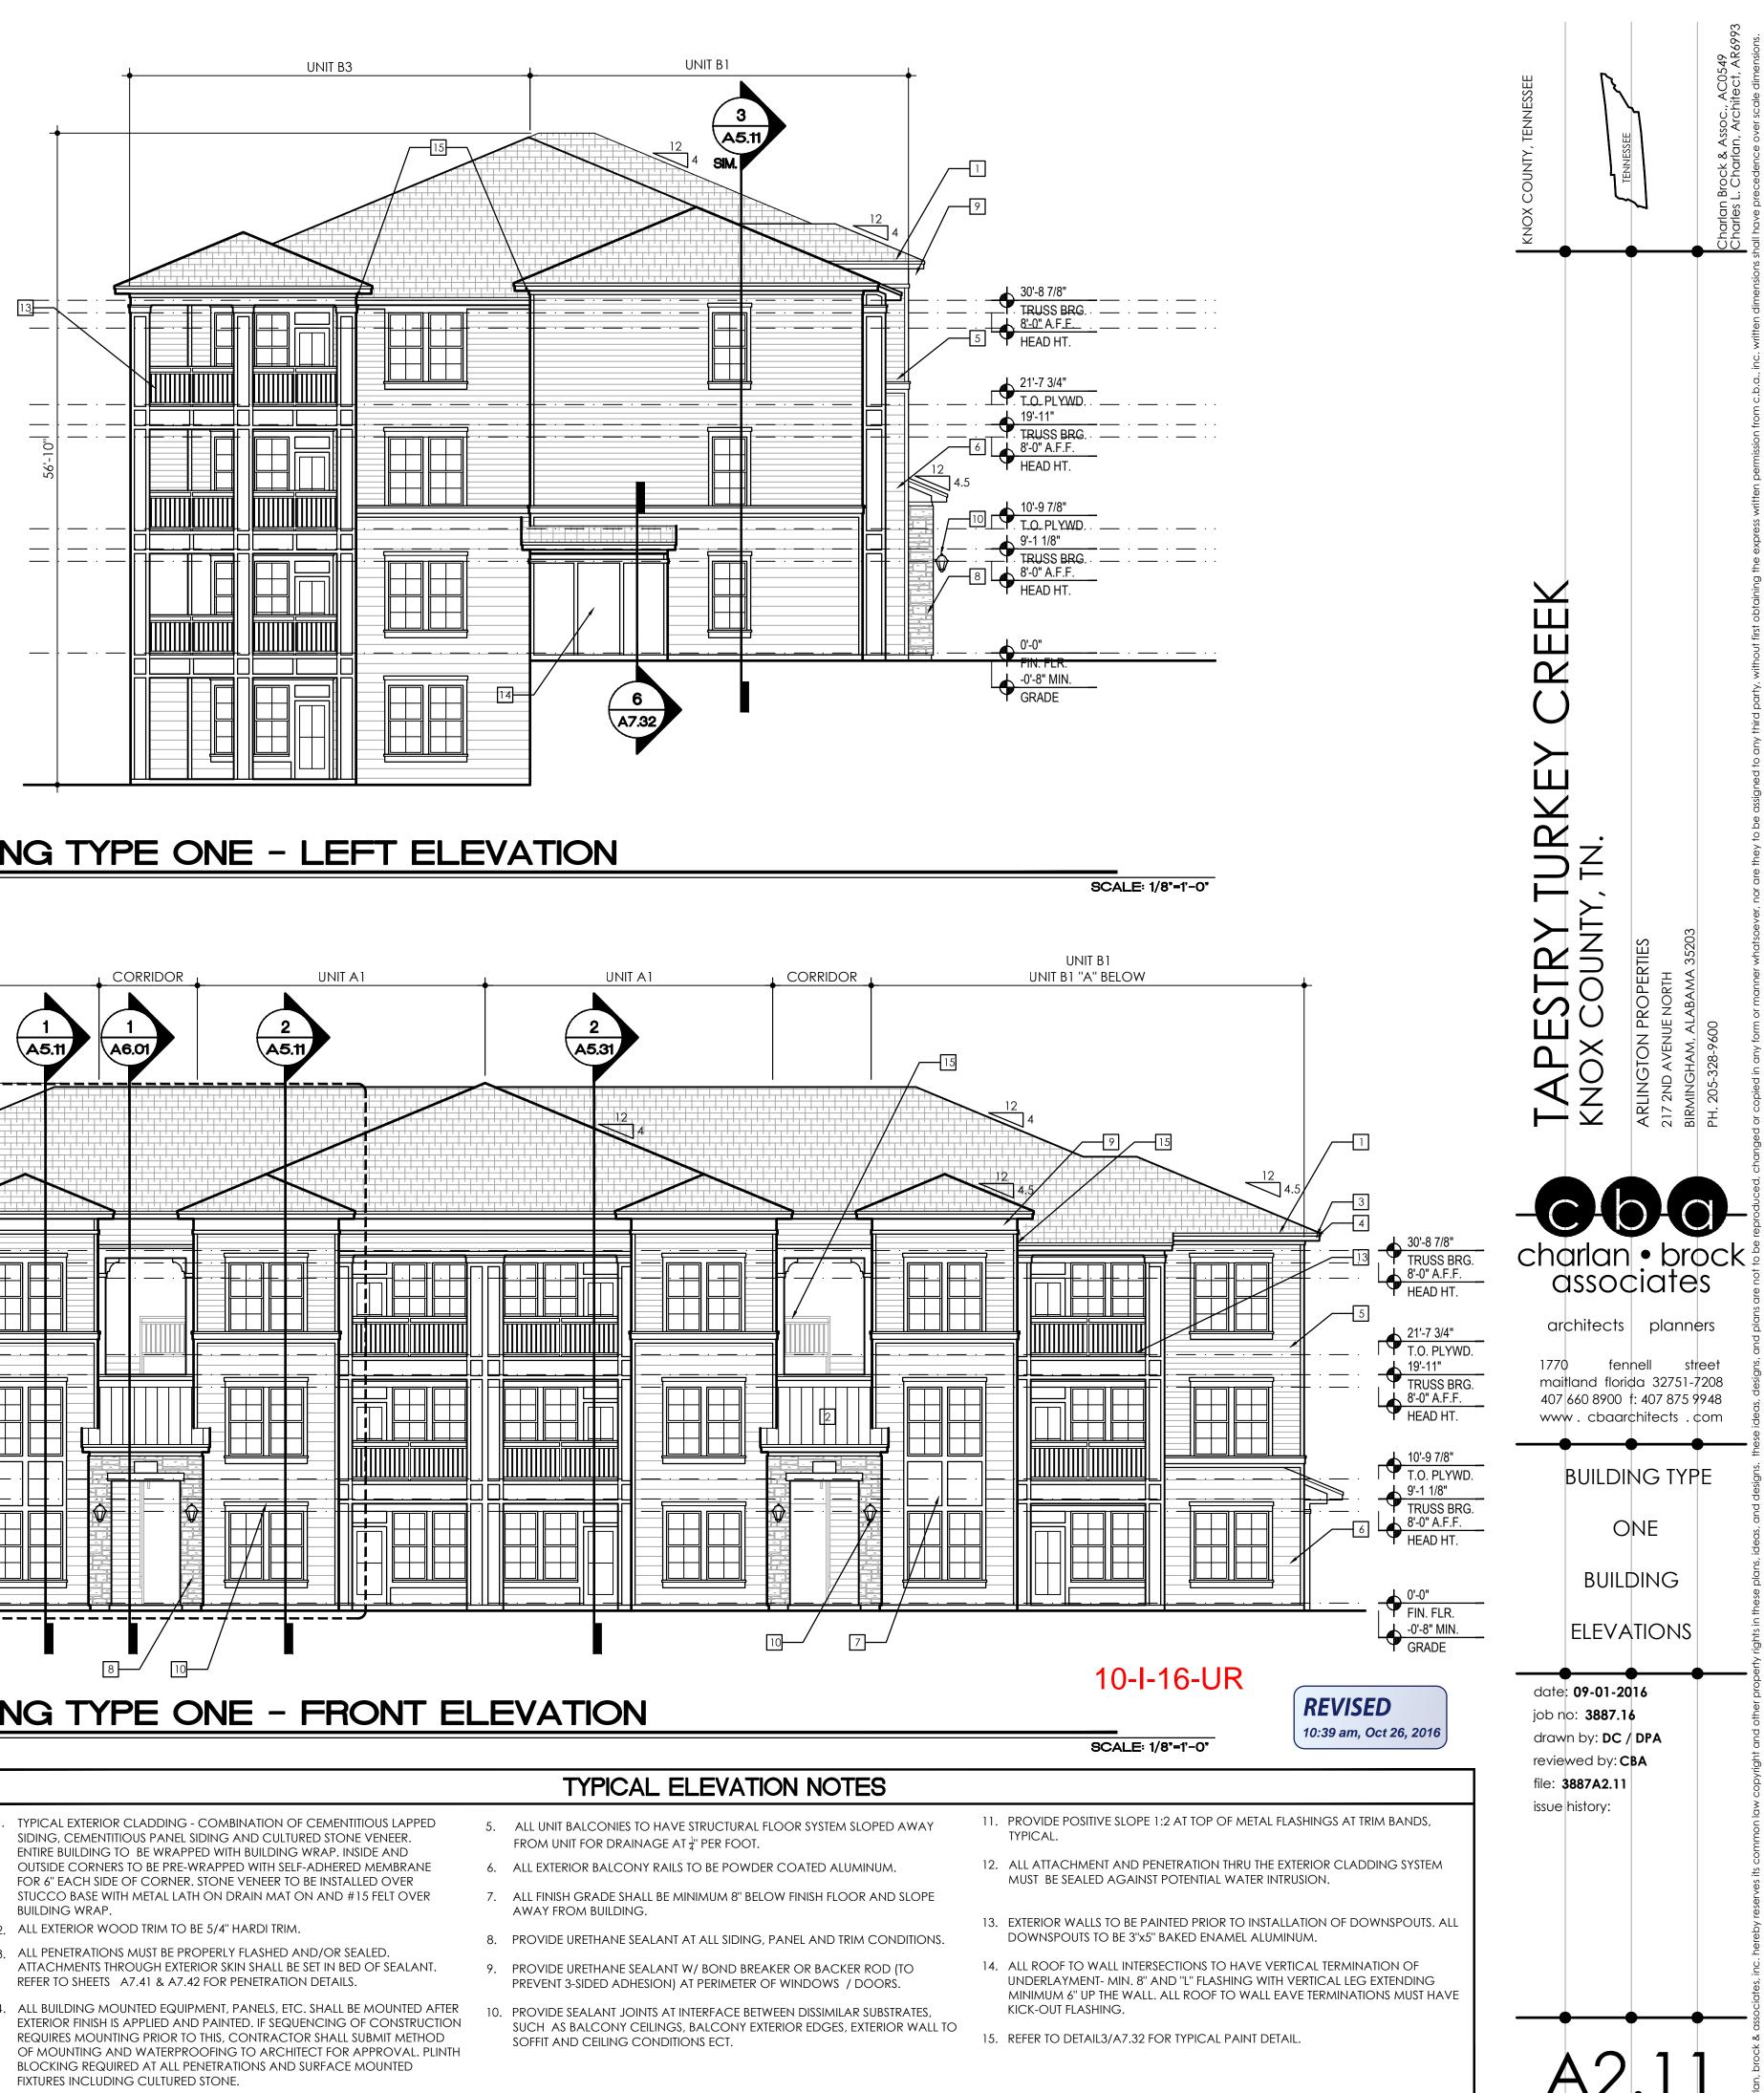

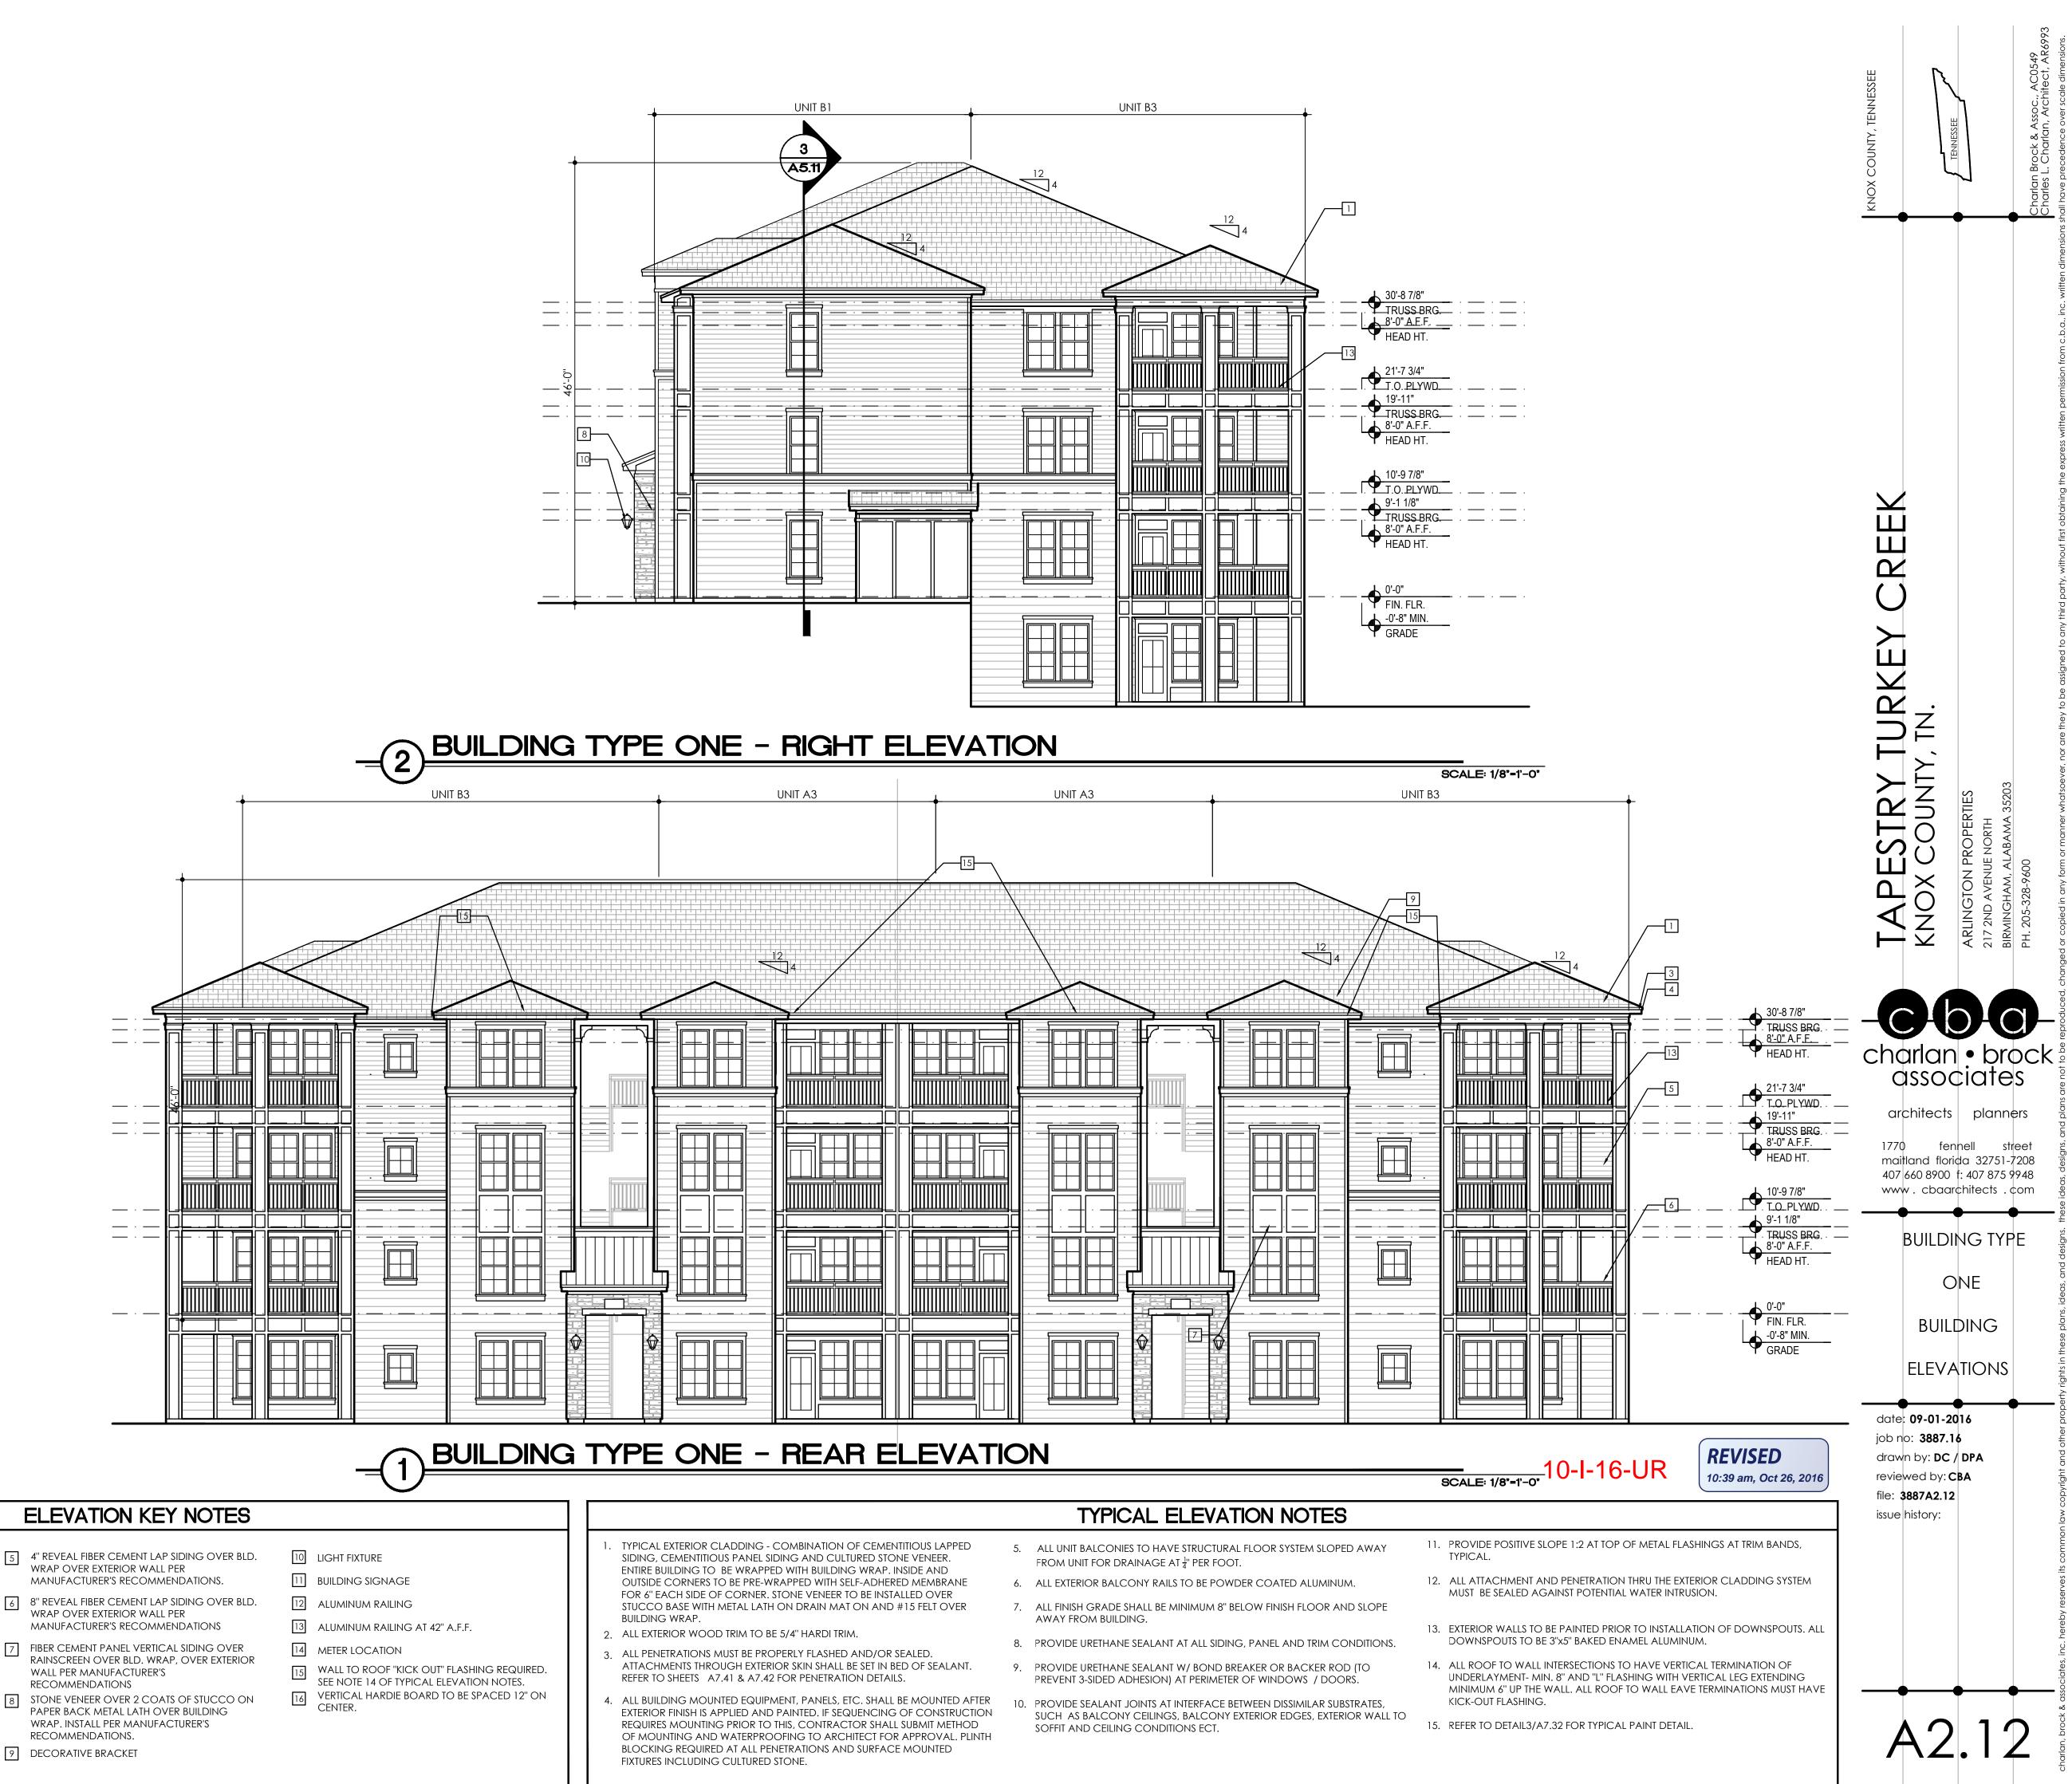

ARCHITECTURAL STYLE SHINGLES, OVER #30 5 4" REVEAL FIBER CEMENT LAP SIDING OVER BLD. FELT, OVER ROOF SHEATHING, OVER WRAP OVER EXTERIOR WALL PER PRE-EGINEERED ROOF TRUSSES. PROVIDE 36" MANUFACTURER'S RECOMMENDATIONS. WIDE 30 MIL SELF-ADHERING MEMBRANE, 6 8" REVEAL FIBER CEMENT LAP SIDING OVER BLD. CENTERED IN VALLEYS, OVER ROOF SHEATHING. WRAP OVER EXTERIOR WALL PER 2 STANDING SEAM METAL ROOF OVER 40 MIL. MANUFACTURER'S RECOMMENDATIONS HIGH TEMPERATURE MEMBRANE. INSTALL PER 7 FIBER CEMENT PANEL VERTICAL SIDING OVER MANUFACTURER'S RECOMMENDATIONS. RAINSCREEN OVER BLD. WRAP, OVER EXTERIOR 3 ALUMINUM DRIP EDGE ON ALUMINUM WRAPPED WALL PER MANUFACTURER'S TREATED 1X3 ON TREATED 2X10 FASCIA BOARD RECOMMENDATIONS WITH ALUMINUM GUTTER PER ROOF PLAN 8 STONE VENEER OVER 2 COATS OF STUCCO ON PAPER BACK METAL LATH OVER BUILDING 4 ANODIZED ALUMINUM GUTTER & DOWNSPOUT WRAP. INSTALL PER MANUFACTURER'S SYSTEM **RECOMMENDATIONS.**



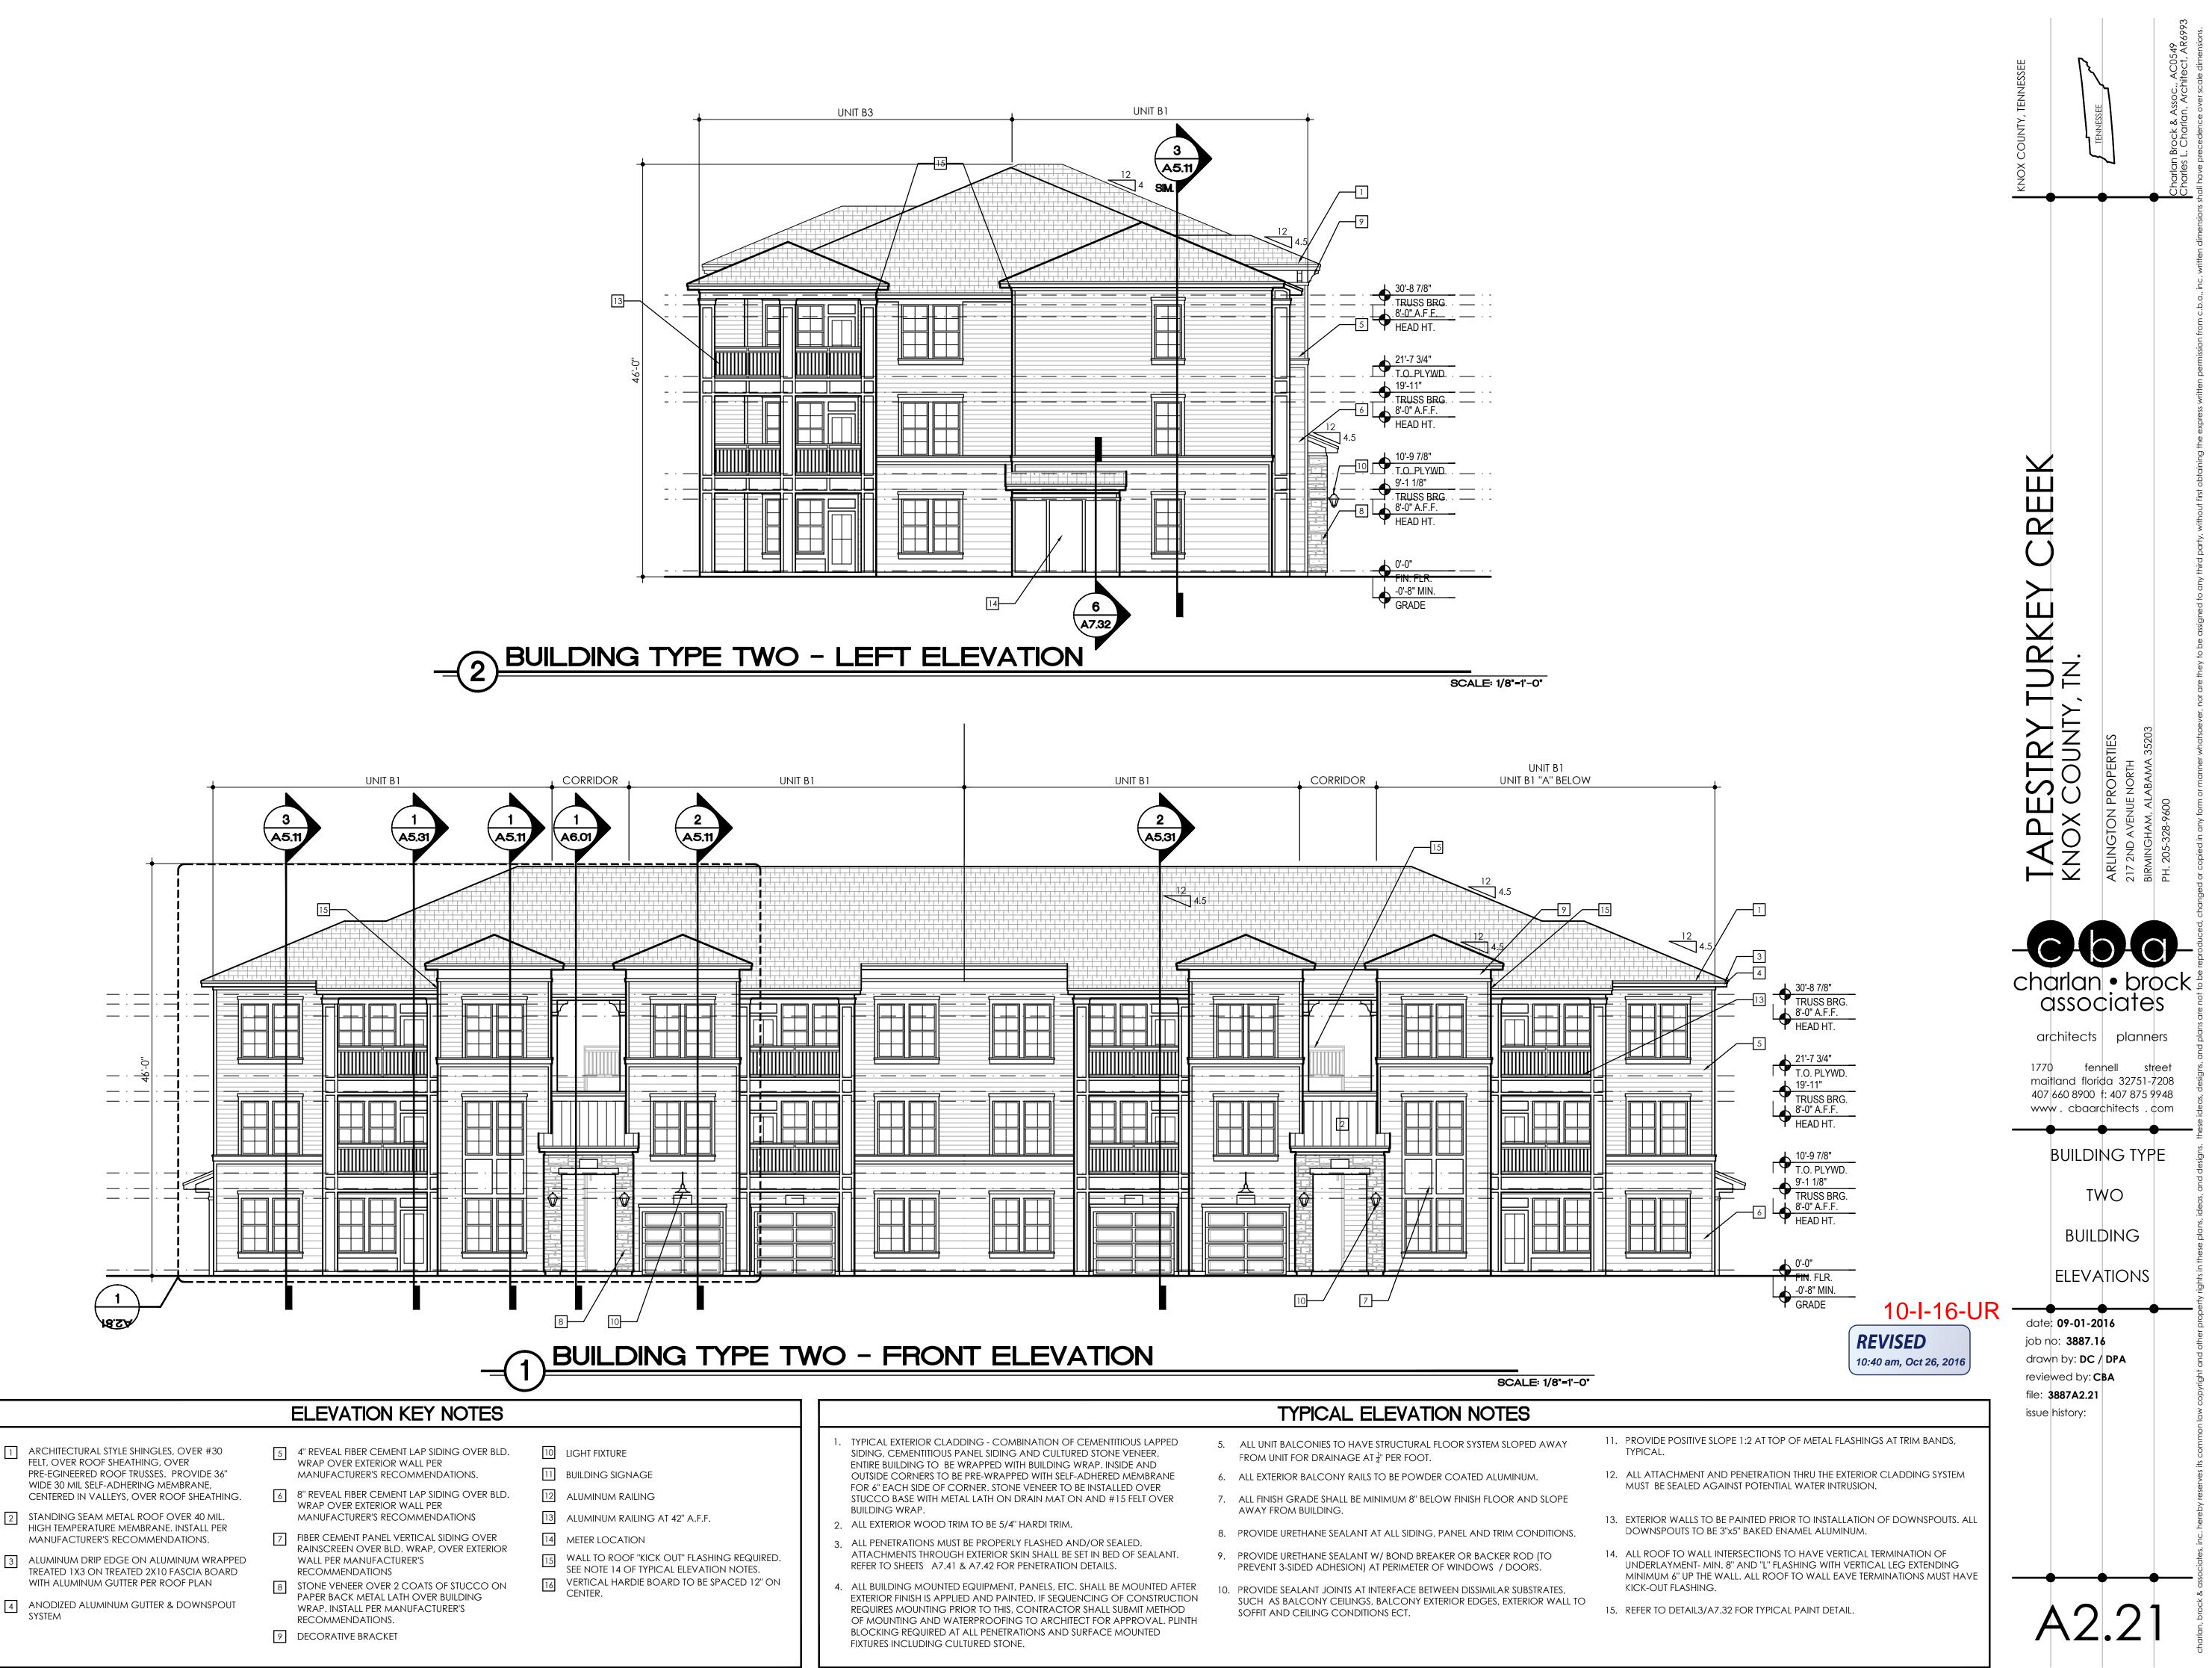







ARCHITECTURAL STYLE SHINGLES, OVER #30 FELT, OVER ROOF SHEATHING, OVER PRE-EGINEERED ROOF TRUSSES. PROVIDE 36" WIDE 30 MIL SELF-ADHERING MEMBRANE, CENTERED IN VALLEYS, OVER ROOF SHEATHING. 2 STANDING SEAM METAL ROOF OVER 40 MIL. HIGH TEMPERATURE MEMBRANE. INSTALL PER MANUFACTURER'S RECOMMENDATIONS. 3 ALUMINUM DRIP EDGE ON ALUMINUM WRAPPED TREATED 1X3 ON TREATED 2X10 FASCIA BOARD WITH ALUMINUM GUTTER PER ROOF PLAN 4 ANODIZED ALUMINUM GUTTER & DOWNSPOUT SYSTEM




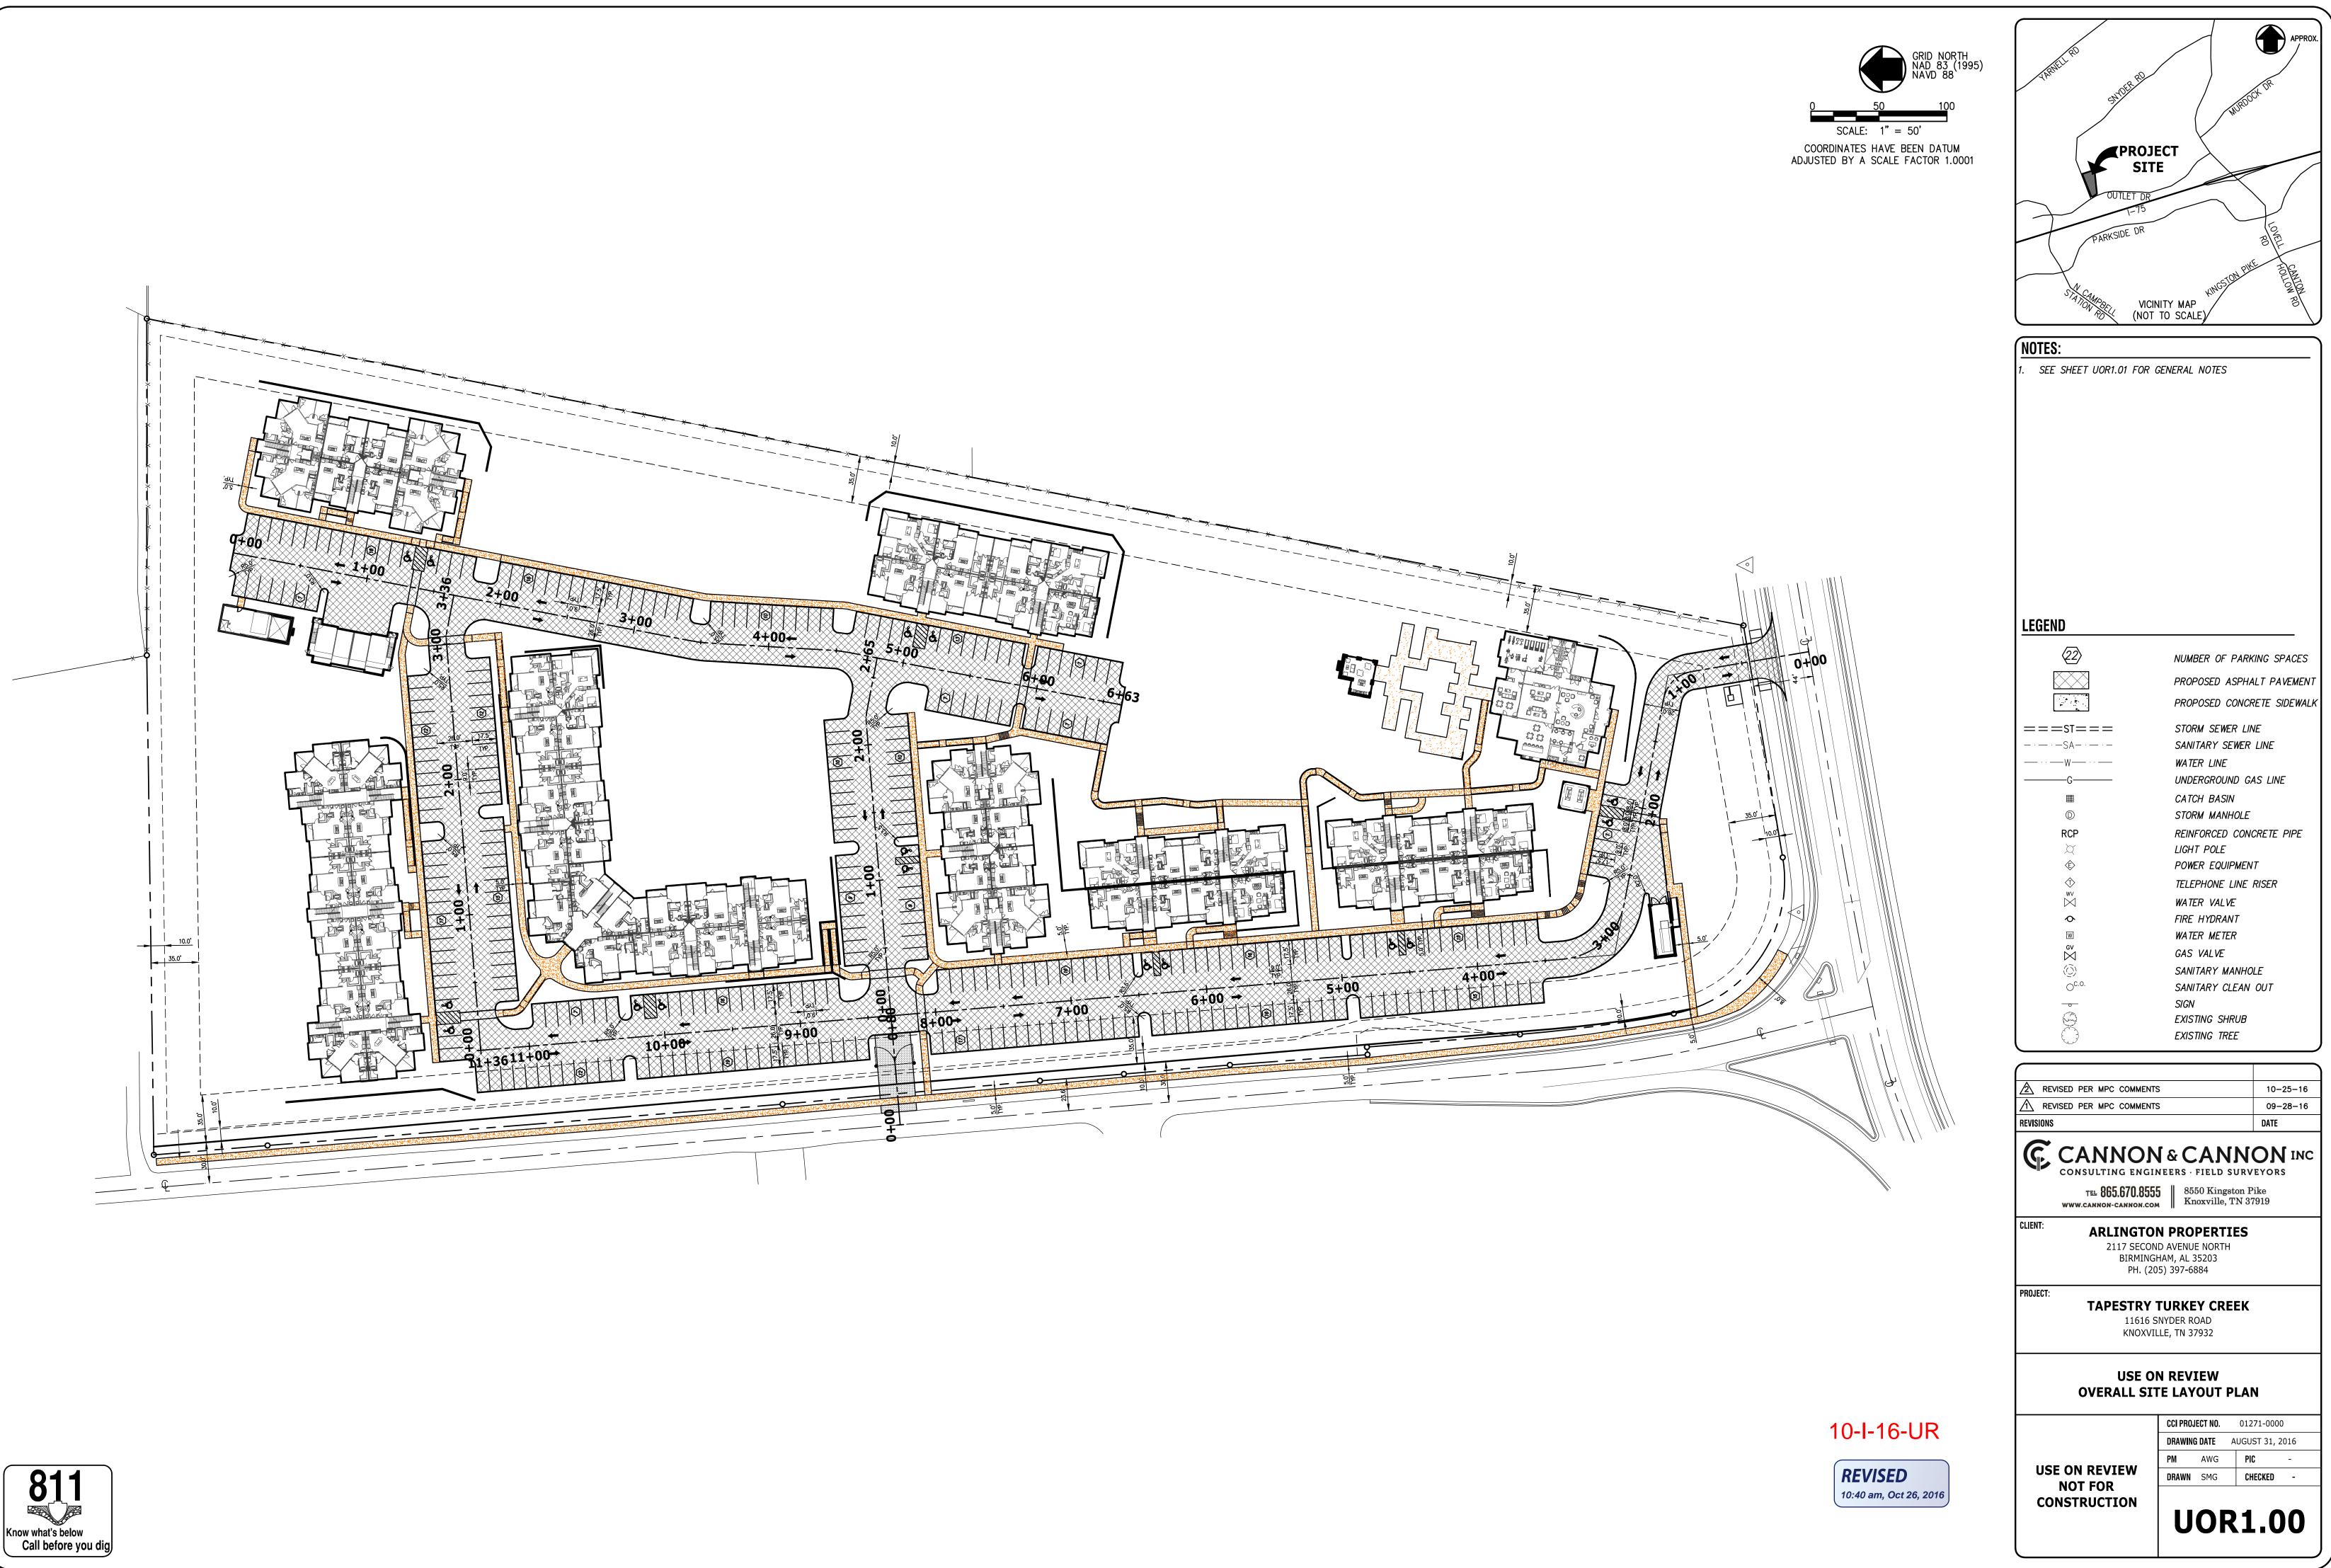





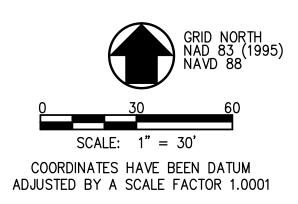

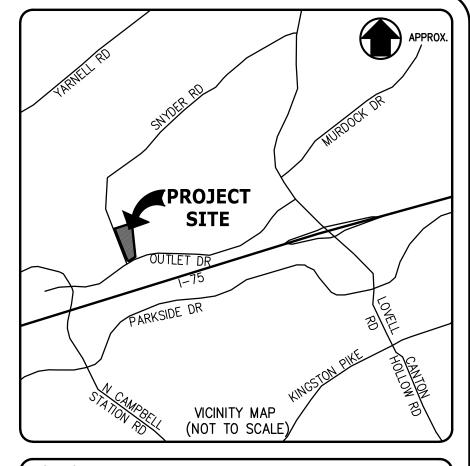

NOTES:

 STORM WATER DETENTION AND WATER QUALITY TO BE EVALUATED AS PART OF FINAL DRAINAGE DESIGN.
 DETAILED LANDSCAPING PLAN SHALL BE SUBMITTED FOR MPC STAFF APPROVAL PRIOR TO OBTAINING BUILDING PERMIT.

SPECIAL NOTE

EVALUATION OF EITHER RETENTION PONDS OR DRAINAGE EASEMENTS TO OFF-SITE SINKHOLES TO BE DETERMINED IN

10-I-16-UR

10:40 am, Oct 26, 2016

REVISED

REVISED PER MPC COMMENTS 10-25-16 REVISED PER MPC COMMENTS 09-28-16 REVISIONS DATE **CANNON & CANNON** INC CONSULTING ENGINEERS - FIELD SURVEYORS TEL 865.670.8555 WWW.CANNON-CANNON.COM CLIENT: **ARLINGTON PROPERTIES** 2117 SECOND AVENUE NORTH BIRMINGHAM, AL 35203 PH. (205) 397-6884 PROJECT: TAPESTRY TURKEY CREEK 11616 SNYDER ROAD KNOXVILLE, TN 37932 **USE ON REVIEW** SITE GRADING PLAN **CCI PROJECT NO.** 01271-0000 DRAWING DATE AUGUST 31, 2016 PM AWG PIC -**USE ON REVIEW** DRAWN SMG CHECKED **NOT FOR**


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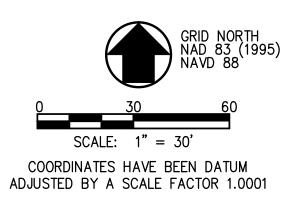
CONSTRUCTION


LEGEND	
1040	PROPOSED CONTOUR LINE
1040	EXISTING CONTOUR LINE
===ST===	STORM SEWER LINE
SA	SANITARY SEWER LINE
—— · · —— W—— · · · ——	WATER LINE
G	UNDERGROUND GAS LINE
	CATCH BASIN
D	STORM MANHOLE
RCP	REINFORCED CONCRETE PIPE
X	LIGHT POLE
¢	POWER EQUIPMENT
\Diamond	TELEPHONE LINE RISER
wv M	WATER VALVE
	FIRE HYDRANT
W	WATER METER
GV	GAS VALVE
$(\overline{\bigcirc})$	SANITARY MANHOLE
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<u> </u>	SIGN

90

SIGN EXISTING SHRUB EXISTING TREE



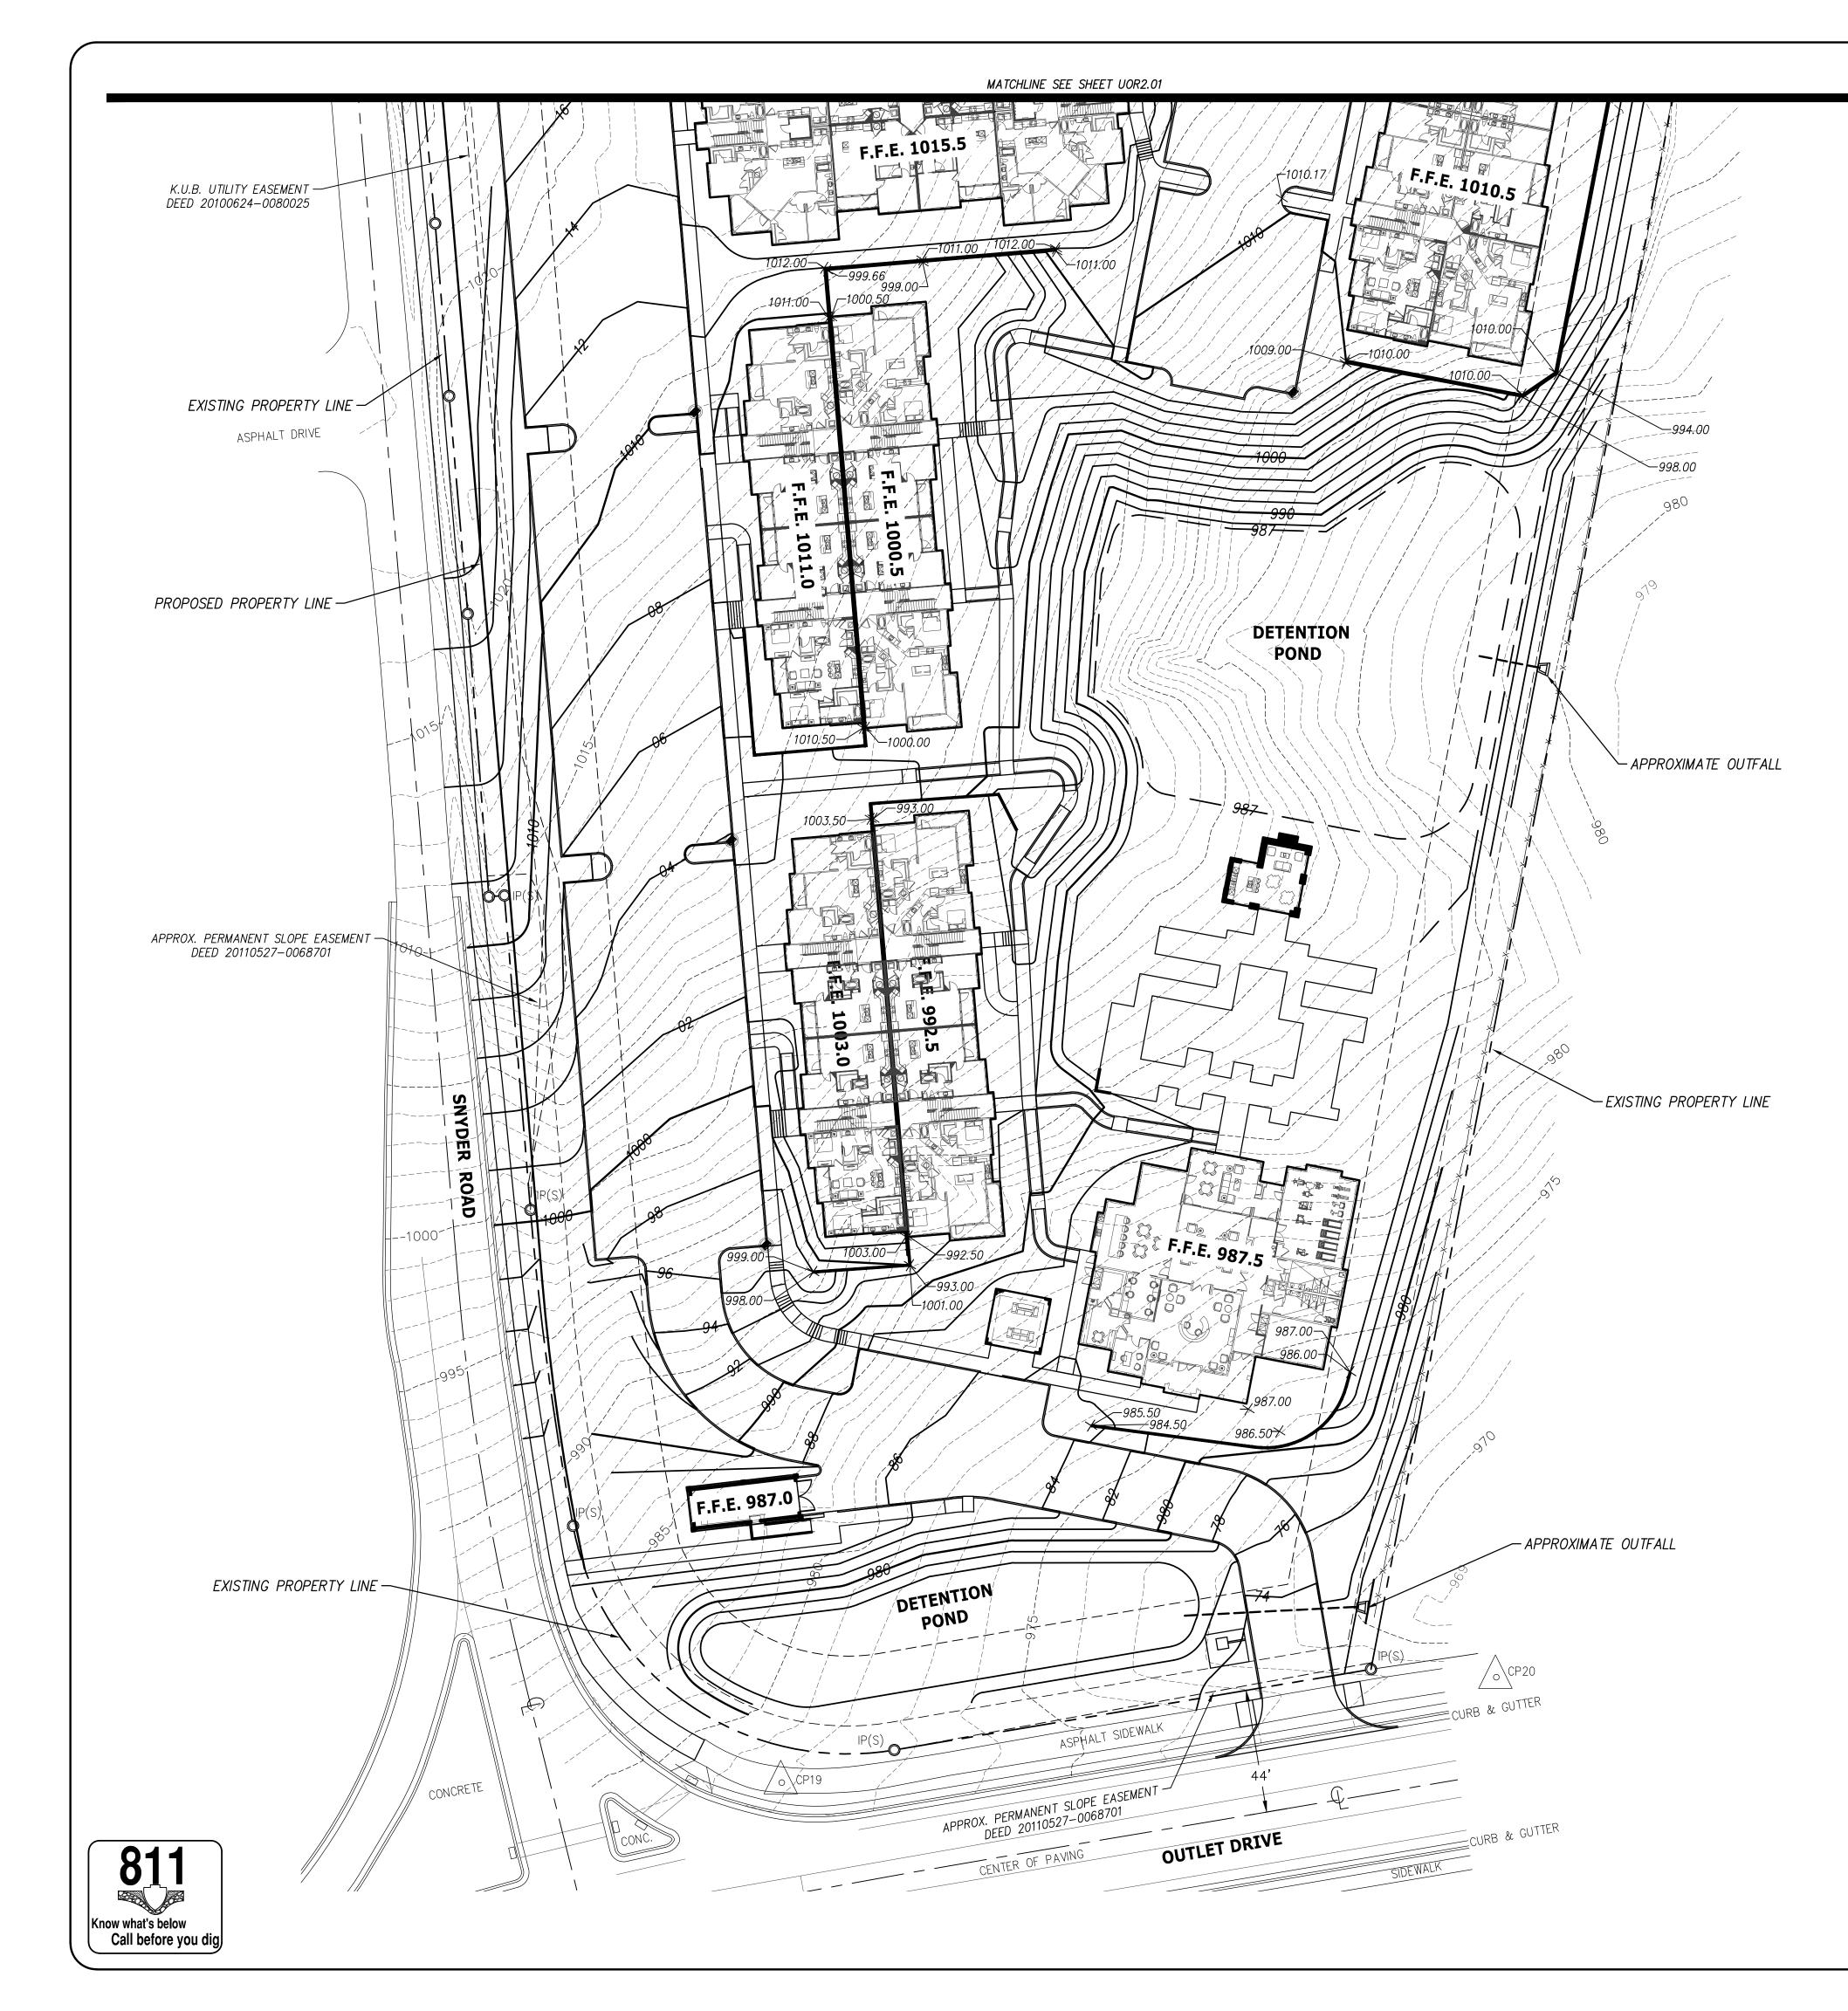


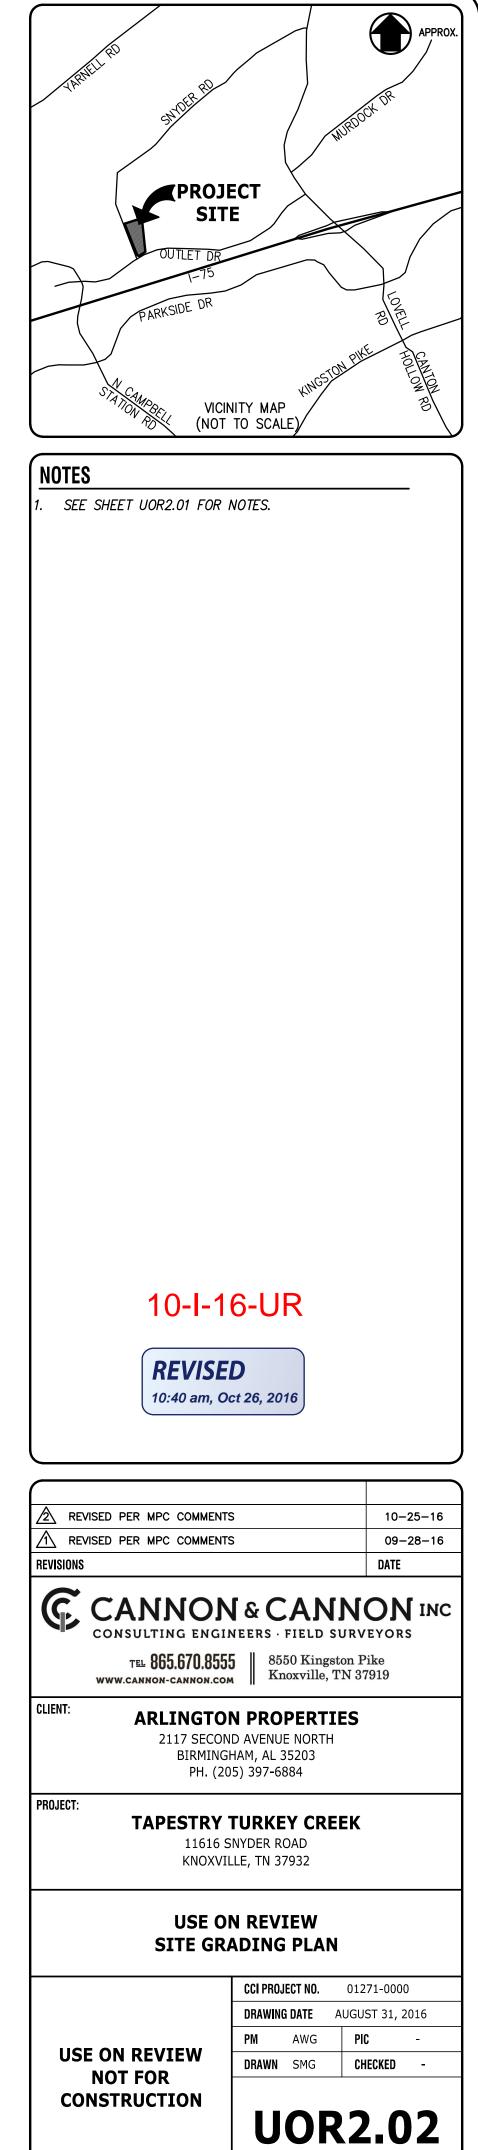


LEGEND


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PROPOSED CONTOUR LINE EXISTING CONTOUR LINE STORM SEWER LINE SANITARY SEWER LINE WATER LINE UNDERGROUND GAS LINE CATCH BASIN STORM MANHOLE REINFORCED CONCRETE PIPE LIGHT POLE POWER EQUIPMENT TELEPHONE LINE RISER WATER VALVE FIRE HYDRANT WATER METER GAS VALVE SANITARY MANHOLE SANITARY CLEAN OUT SIGN EXISTING SHRUB EXISTING TREE



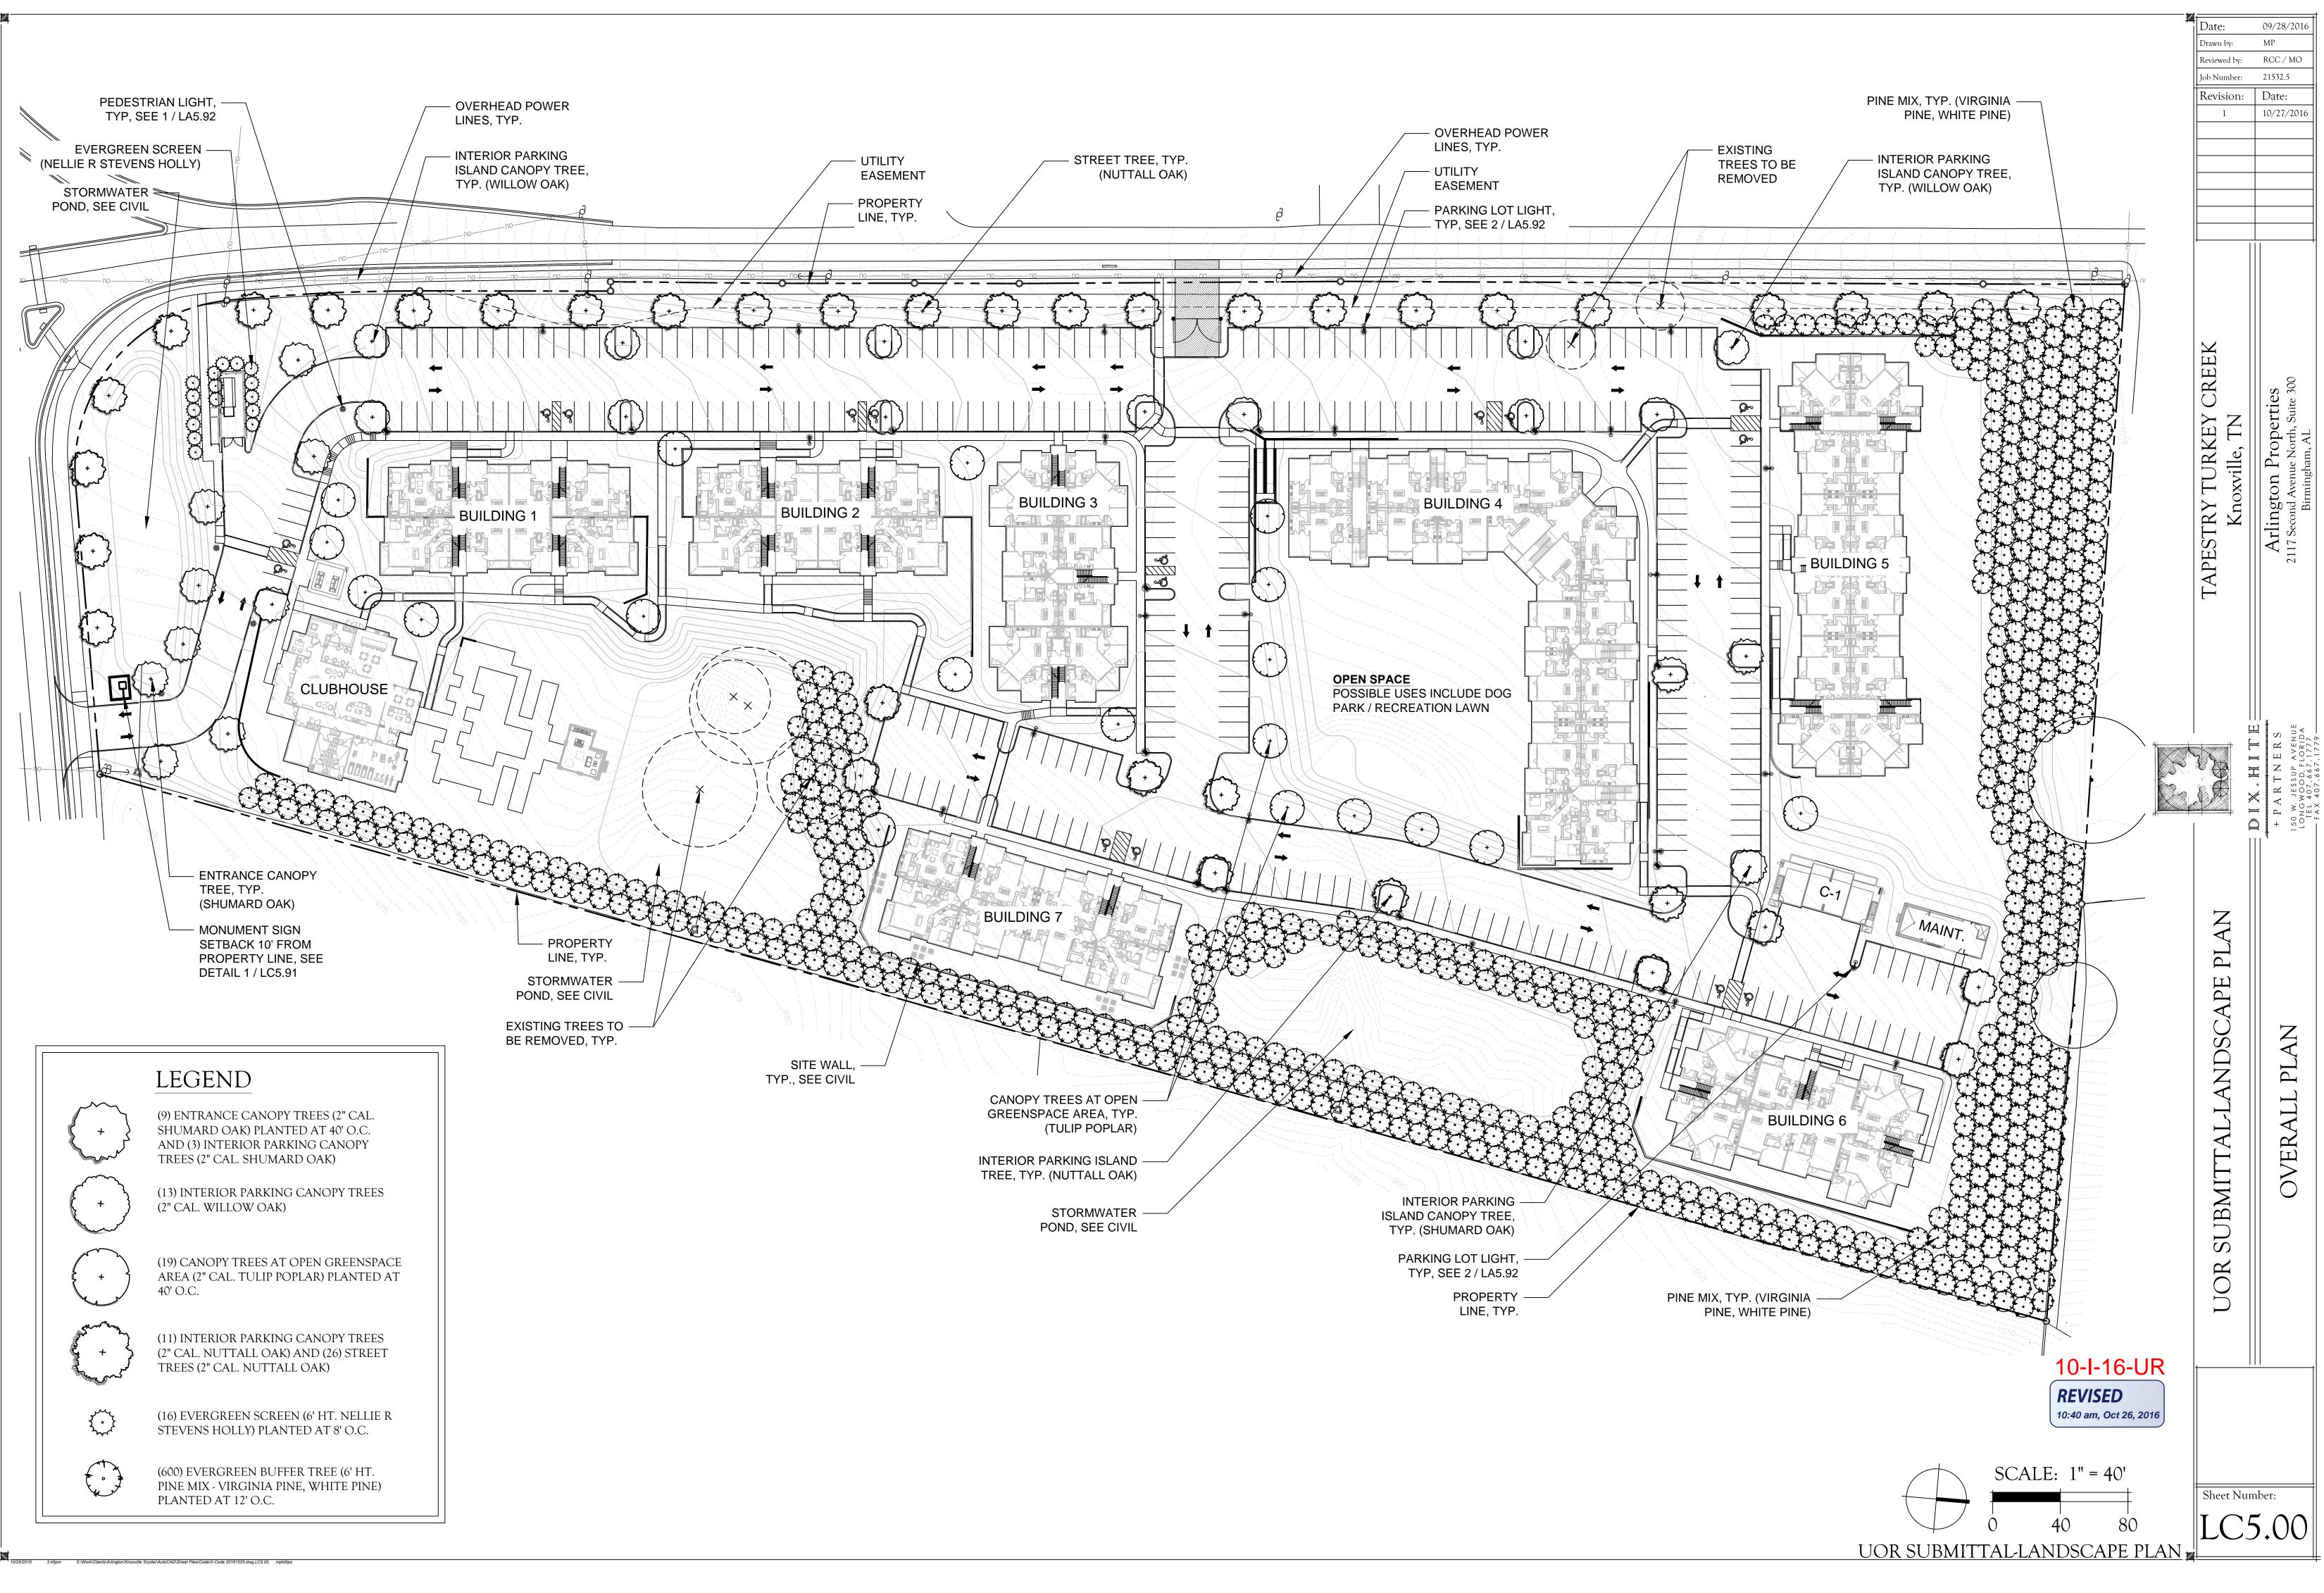
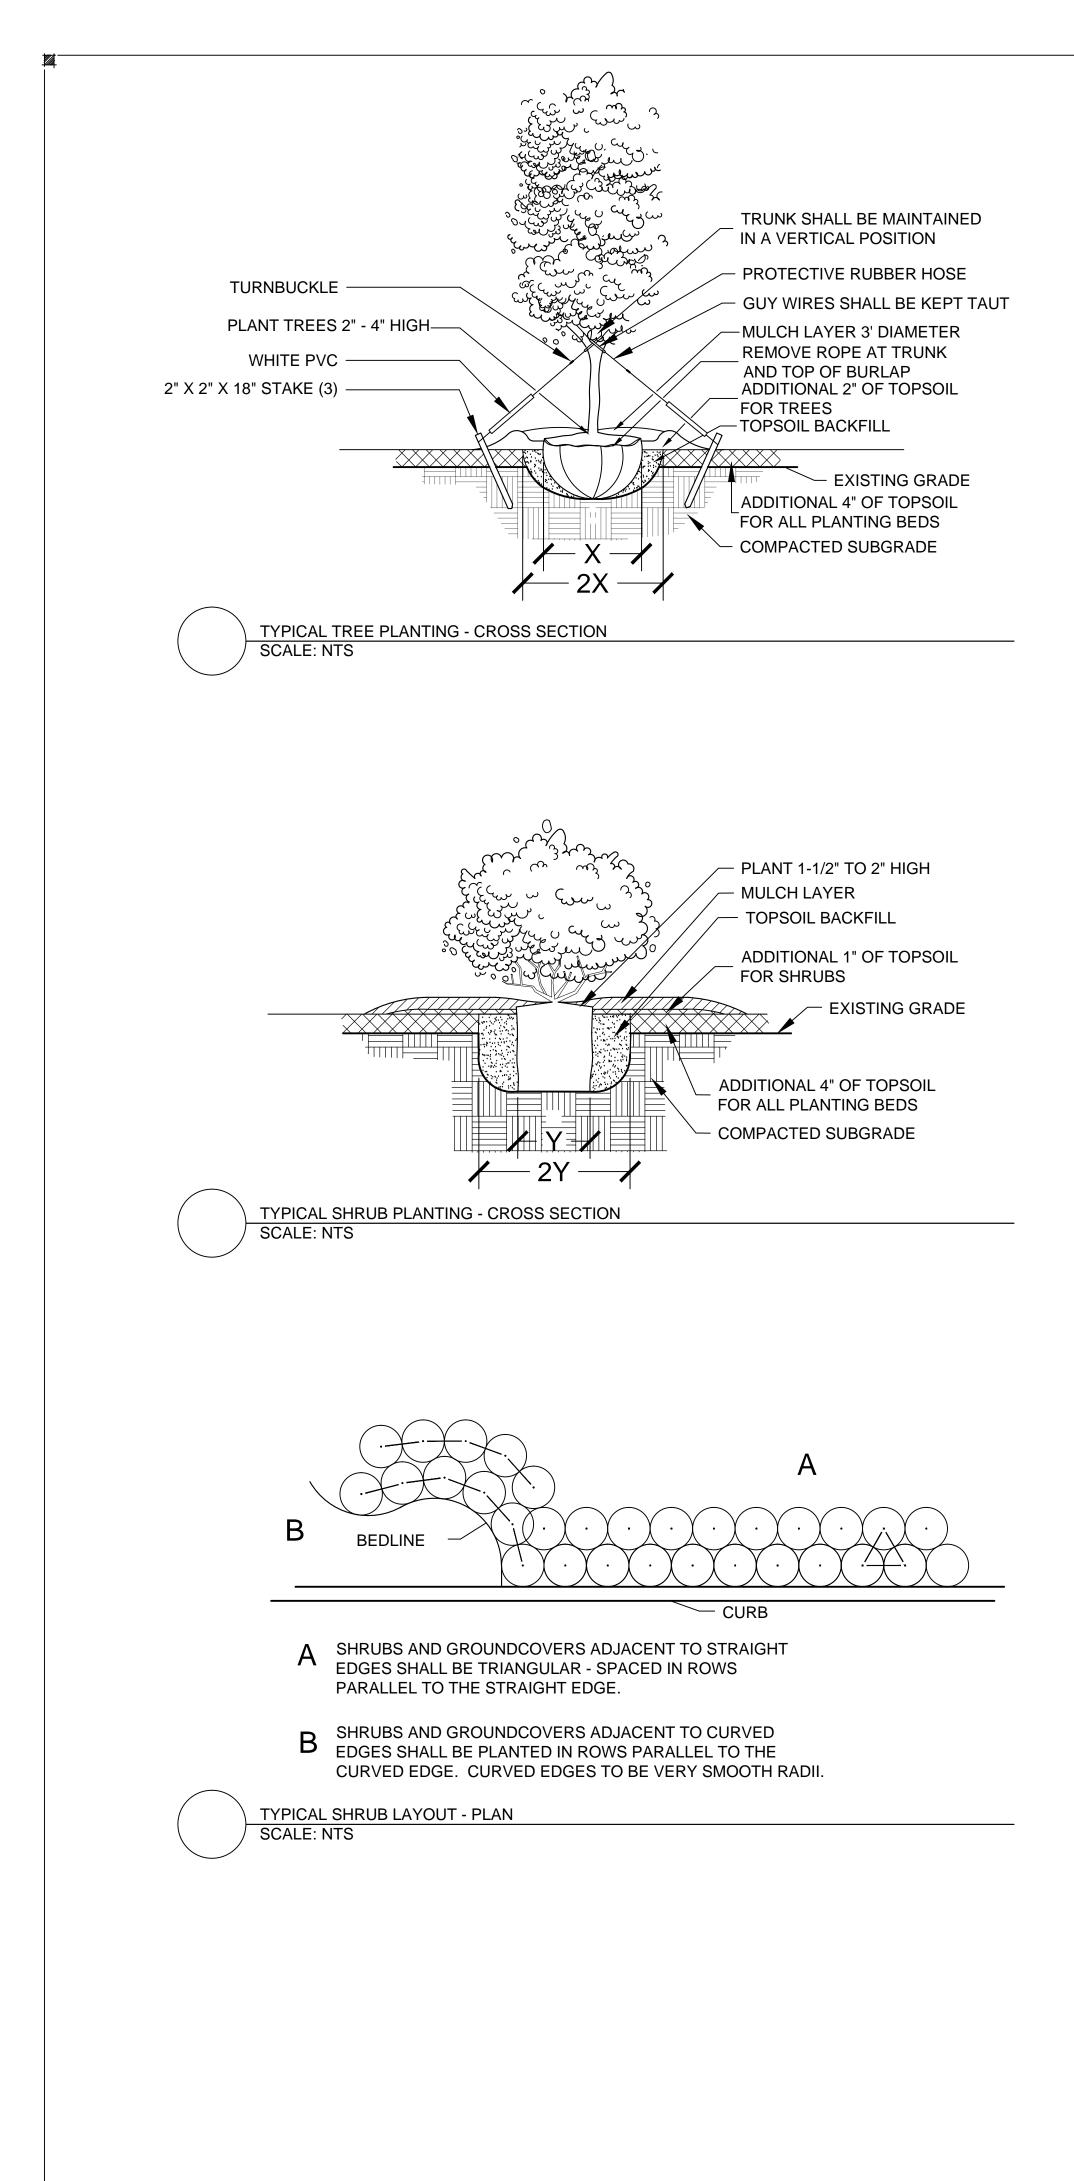
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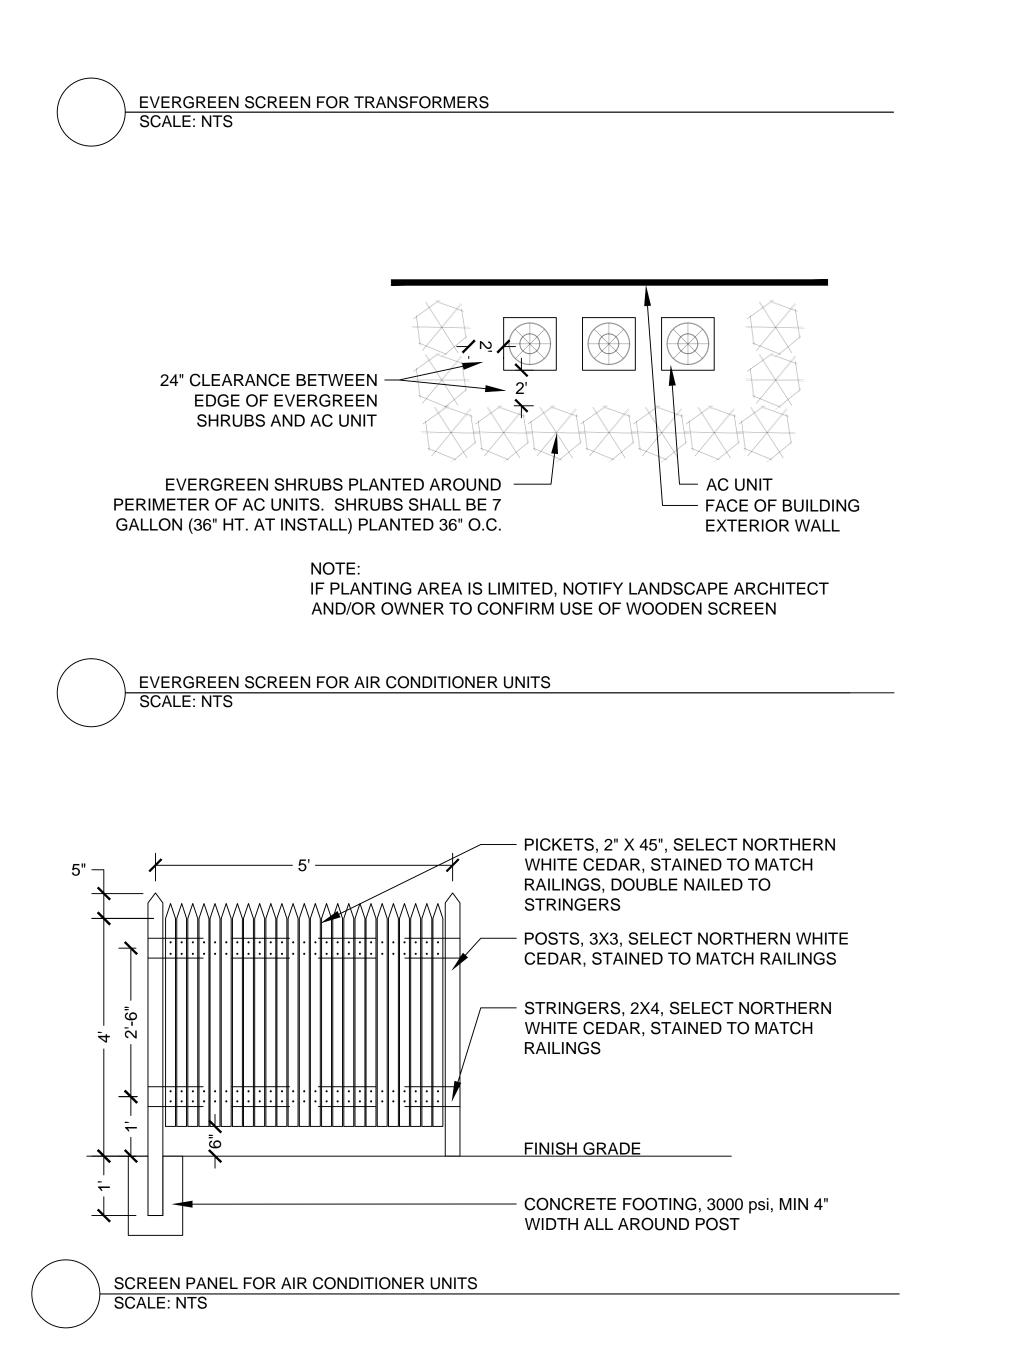


- TRANSFORMER

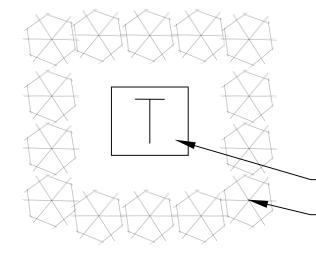EVERGREEN SHRUBS PLANTED AROUND PERIMETER OF TRANSFORMERS. SHRUBS SHALL BE 7 GALLON (36" HT. AT INSTALL) PLANTED 36" O.C.


NOTE:

REFER TO LOCAL CODE FOR CLEARANCE REQUIREMENTS. PLANTINGS SHOULD COMPLETELY SURROUND TRANSFORMER TO SCREEN VIEWS FROM UNITS, SIDEWALKS AND ROADS. NOTIFY LANDSCAPE ARCHITECT OF DISCREPANCY BETWEEN PLAN AND SITE CONDITIONS.




			Date: Drawn by: Reviewed by:	09/28/2016 MP RCC / MO
			Job Number: Revision:	21532.5 Date:
LA	NDSCAPE NOTES		1	10/27/2016
1.	CONTRACTOR IS EXPECTED TO CARRY OUT ALL REPONSIBILITIES SET FORTH IN THESE LANDSCAPE NOTES AND IN THE LANDSCAPE SPECIFICATIONS. THEY WILL BE STRICTLY ENFORCED BY THE OWNER/L.A.			
2.	ALL PLANT MATERIAL SHALL BE ANSI Z60.1-2004 OR BETTER ACCORDING TO THE CURRENT NURSERY GRADES AND STANDARDS.			
3.	ALL PLANT BEDS SHALL BE DRESSED WITH 3" LAYER OF MULCH. ALL OTHER AREAS SHALL RECEIVE SOD.			
4.	CONTRACTOR SHALL VERIFY ALL EXISTING UTILITIES PRIOR TO INSTALLATION.			
5.	ALL PLANTS SHALL MEET SIZE, CONTAINER, AND SPACING SPECIFICATIONS. ANY MATERIAL NOT MEETING SPECIFICATIONS SHALL BE REMOVED AND REPLACED AT THE CONTRACTOR'S EXPENSE.		CREEK	S 300
6.	CONTRACTOR SHALL BE RESPONSIBLE TO RECEIVE THE LANDSCAPE ARCHITECT'S APPROVAL OF ALL PLANT BED LAYOUTS AND TREE LOCATIONS PRIOR TO INSTALLATION. IF PLANT MATERIAL IS INSTALLED PRIOR TO LANDSCAPE ARCHITECT'S APPROVAL, CONTRACTOR WILL BE SUBJECT TO RELOCATING THE MATERIAL AT THE LANDSCAPE ARCHITECT'S REQUEST AND THE CONTRACTOR'S OWN EXPENSE.		TURKEY (axville, TN	ington Properties cond Avenue North, Suite 300 Birmingham, AL
7.	ALL SHRUBS SHALL BE PLANTED 1-1/2" AND TREES 2-1/2" ABOVE GRADE. CONTRACTOR SHALL BE RESPONSIBLE FOR PROPER PLANT HEALTH IN ON-SITE SOILS.		STRY Kno	rlin_ Secon
8.	CONTRACTOR SHALL PERFORM SOIL TESTING PRIOR TO CONSTRUCTION 1) TO DETERMINE NUTIRIENT STATUS AND PH OF SOIL AND 2) TO DETERMINE THE SOIL TEXTURE IN THE TOP 6" - 12" OF SOIL, AND THEN AMEND THE SOIL BASED ON THE RESULTS OF THE TESTS. SEE THE LANDSCAPE SPECIFICATIONS FOR MORE INFORMATION.		TAPES	A-2117
9.	CONTRACTOR SHALL BE RESPONSIBLE FOR FINE GRADING. GRADING SHALL BE SUBJECT TO THE APPROVAL OF THE LANDSCAPE ARCHITECT.			
	REFER TO SPECIFICATIONS FOR ADDITIONAL REQUIREMENTS.			
	CONTRACTOR SHALL SUBMIT UNIT PRICES FOR ALL BID ITEMS. SOIL SHALL BE FREE FROM LIME ROCK AND CONSTRUCTION	د		
13.	DEBRIS. IN THE EVENT OF A CONFLICT BETWEEN QUANTITIES REPRESENTED ON THE FINAL LANDSCAPE PLAN VS. QUANTITIES SHOWN ON THE PLANT LIST, THE PLAN SHALL CONTROL.		\$₽ >	PARTNE ARTNE W. Jessup A UGWOOD, FL
14.	CONTRACTOR SHALL MAINTAIN TREES IN A STRAIGHT AND PLUMB POSITION FOR ONE YEAR. CONTRACTOR SHALL STAKE ALL TREES IF REQUIRED BY THE JURISDICTION.	~		
15.	PRIOR TO REMOVAL OF ANY TREES, THE TREES TO BE RETAINED SHALL HAVE PROTECTIVE TREE BARRIERS.			
16.	LANDSCAPE CONTRACTOR SHALL BE RESPONSIBLE FOR THEIR OWN TAKE OFFS AND QUANTITIES. THE QUANTITIES ON THE PLANT LIST SERVE ONLY AS A GUIDE TO THE OWNER AND L.A. THIS INCLUDES SOD AND MULCH QUANTITIES OF WHICH THE CONTRACTOR SHALL BE HELD TO BID QUANTITIES.		PLAN	
17.	SUCCESSFUL BIDDER SHALL LOCK UP ALL MATERIALS IMMEDIATELY AFTER CONTRACT ASSIGNMENT. PLANTS SHALL BE HELD DURING THE PERIOD FROM CONTRACT TO INSTALLATION TO ALLOW ADDITIONAL GROWTH. ALL PLANTS WILL BE REQUIRED TO BE FULL AND HEALTHY. CONTRACTOR SHALL ARRANGE FOR PLANT APPROVAL PRIOR TO DELIVERY, EITHER BY SAMPLES. PHOTOS, OR NURSERY VISITS.		NDSCAPE	DETAILS
18.	CONTRACTOR SHALL BE RESPONSIBLE FOR WARRANTY OF HEALTH OF PLANTS IN ON-SITE SOILS. IF, DURING DIGGING, CONTRACTOR DISCOVERS WATER-LOGGED, CLAYEY, COMPACTED OR SIMILARLY POORLY DRAINED SOILS, IT SHOULD BE BROUGHT TO THE ATTENTION OF OWNER/LANDSCAPE ARCHITECT FOR REMEDIAL ACTION.		TAL-LAN	CAPE
19.	CONTRACTOR SHALL ANTICIPATE THE FIRST FIVE FEET AROUND BUILDING PERIMETER WILL BE COMPACTED AND FOUNDATION BEDS SHOULD BE TILLED AND IMPROVED TO SUSTAIN VIGOROUS, HEALTHY PLANT GROWTH.		R SUBMIT	LANDS
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UOR SUBMITTAL-LANDSCAPE PLAN

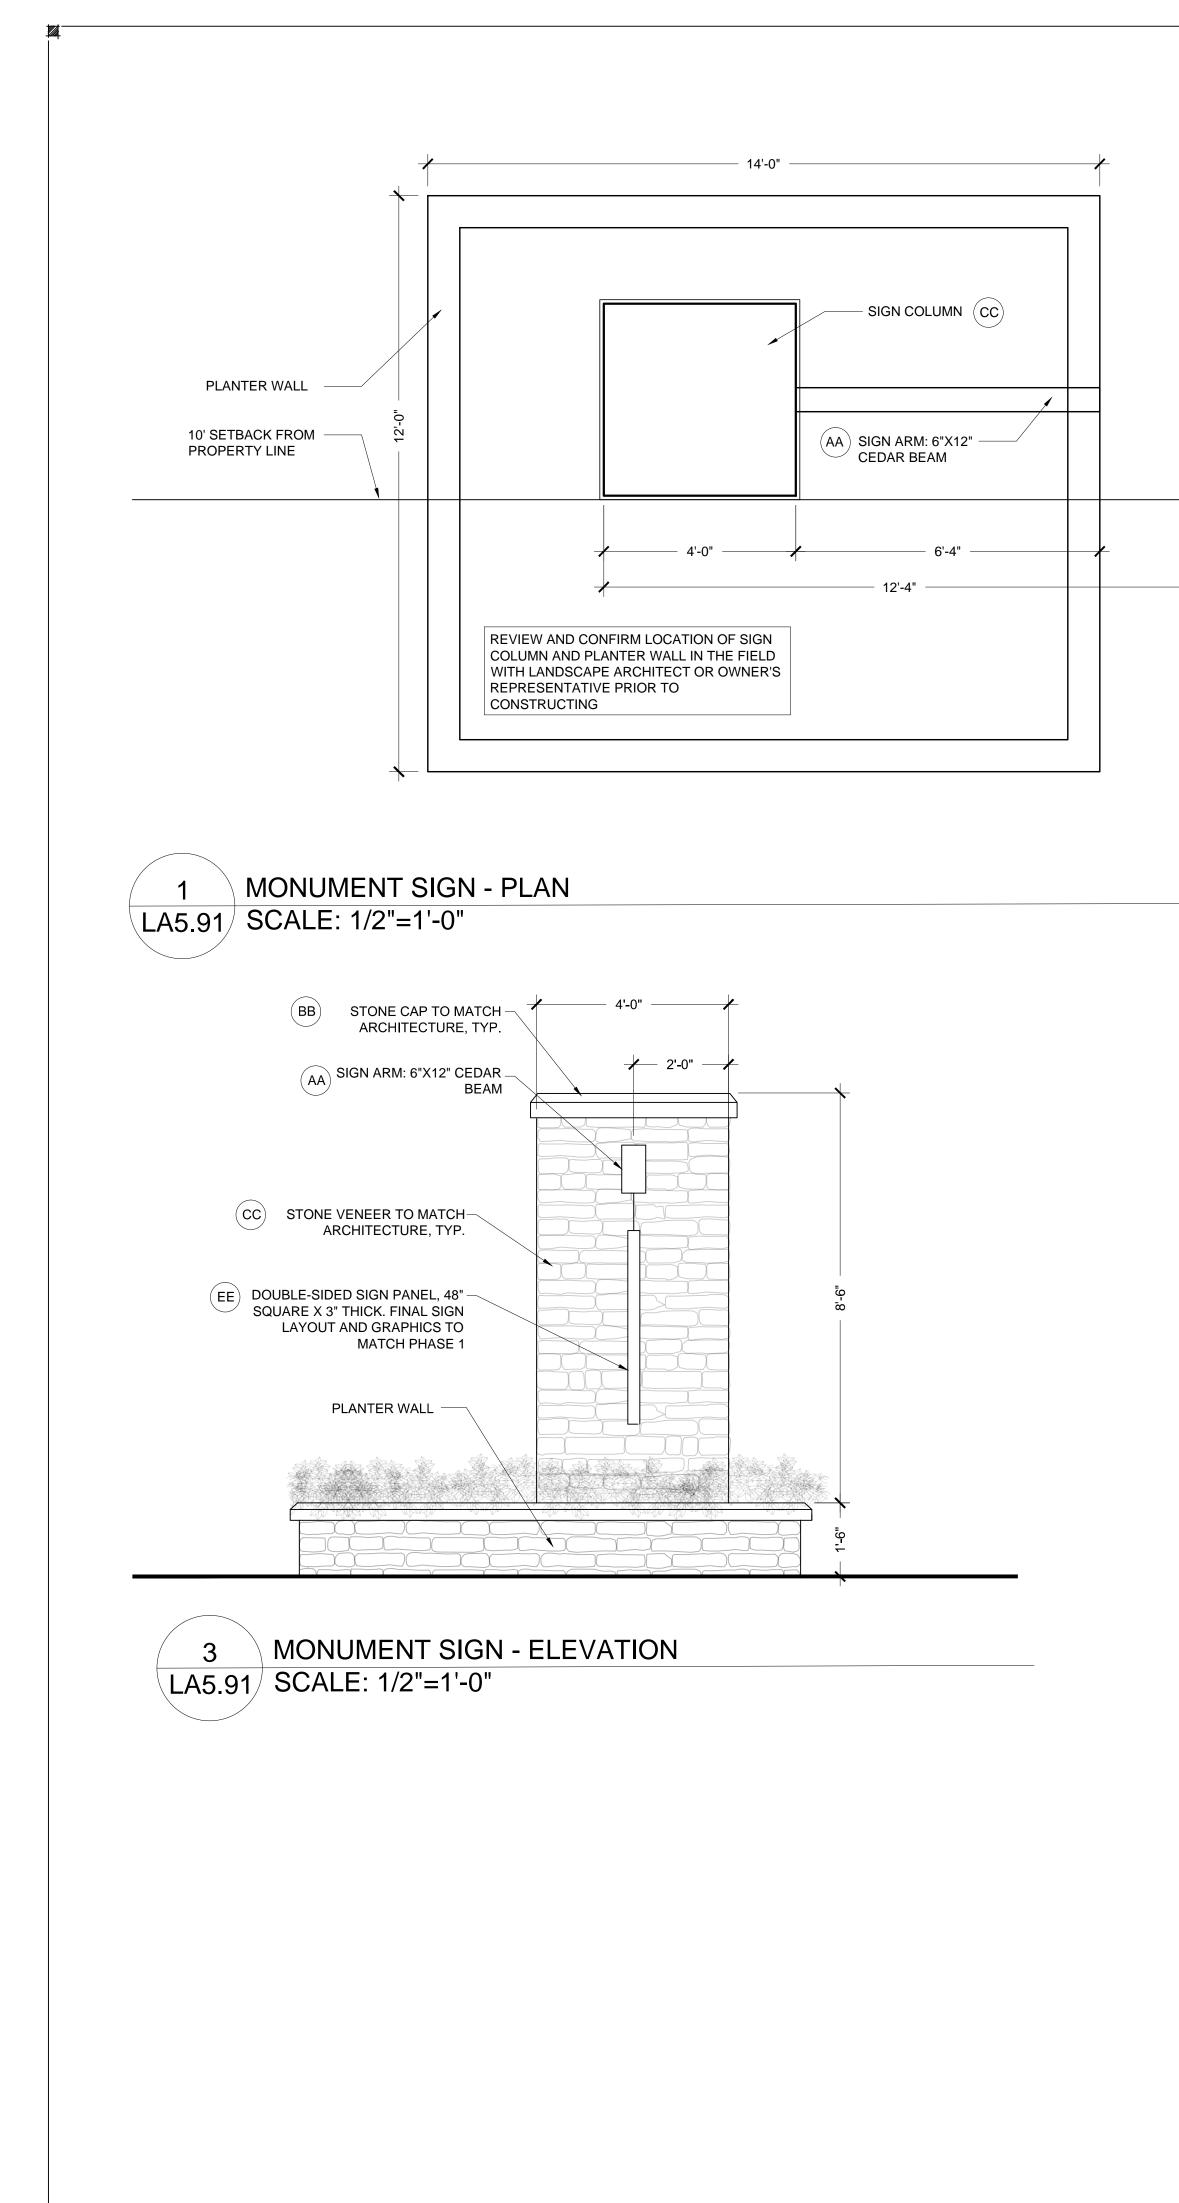

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CONTRACTOR TO SUBMIT INGS TO OWNER/ L.A. FOR HOWING MATERIALS, STRUCTURE I ARM: 6"X12" CEDAR BEAM (AA) BRACKETS: POWDER (FF) FED ALUMINUM ROD (FF) BLE-SIDED SIGN PANEL, 48" (EE) BLE-SIDED SIGN PANEL, 48" (EE) ARE X 3" THICK. FINAL SIGN OUT AND GRAPHICS TO CH PHASE 1		Date: Drawn by: Reviewed by: Job Number: Revision: 1	21532.5
PLANTER WALL		TAPESTRY TURKEY CREEK Knoxville, TN	
			ID IL X, IHI JT IE + P A R T N E R S 150 w. Jessup Avenue Longwood, florida Tel 407.667.1779
		UOR SUBMITTAL-LANDSCAPE PLAN	SIGN DETAILS
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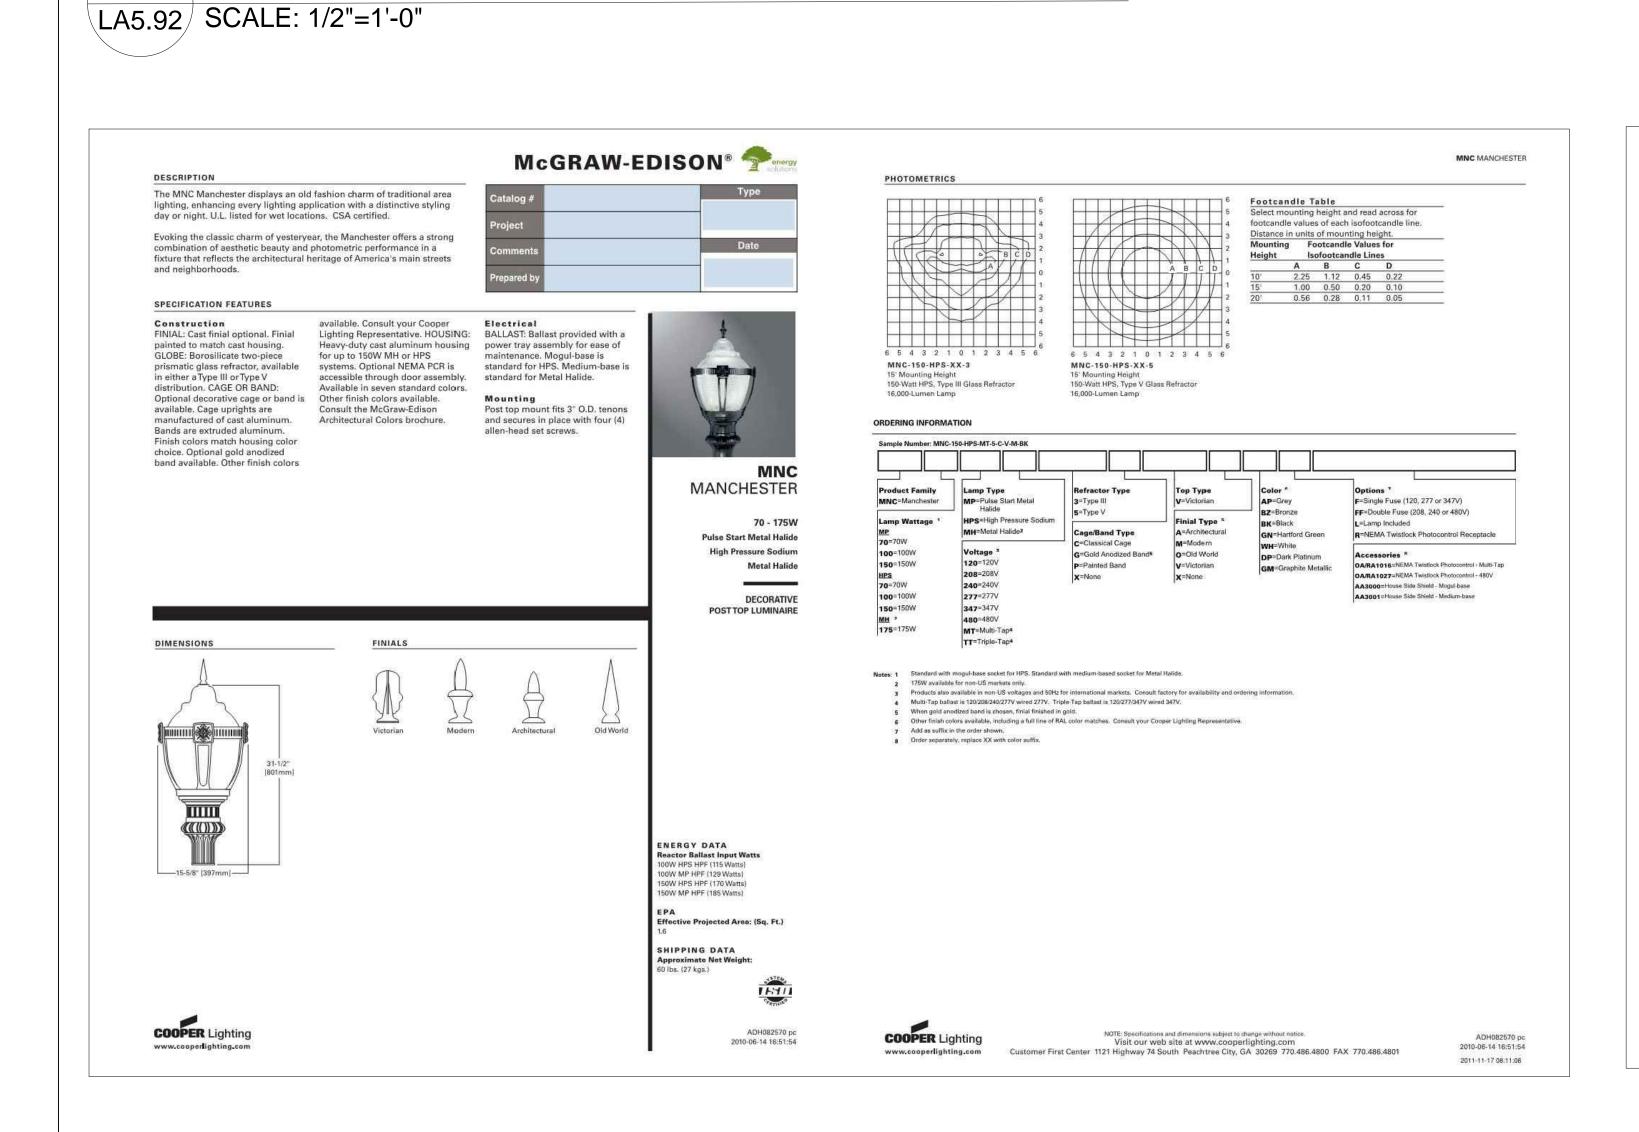
PEDESTRIAN LIGHT

1025/2016 5:05pm S:\Work\Clients\Arlington\Knoxville Snyder\AutoCAD\Sheet Files\Code\X-Code 20161025.dwg.LA5.92, mphillips

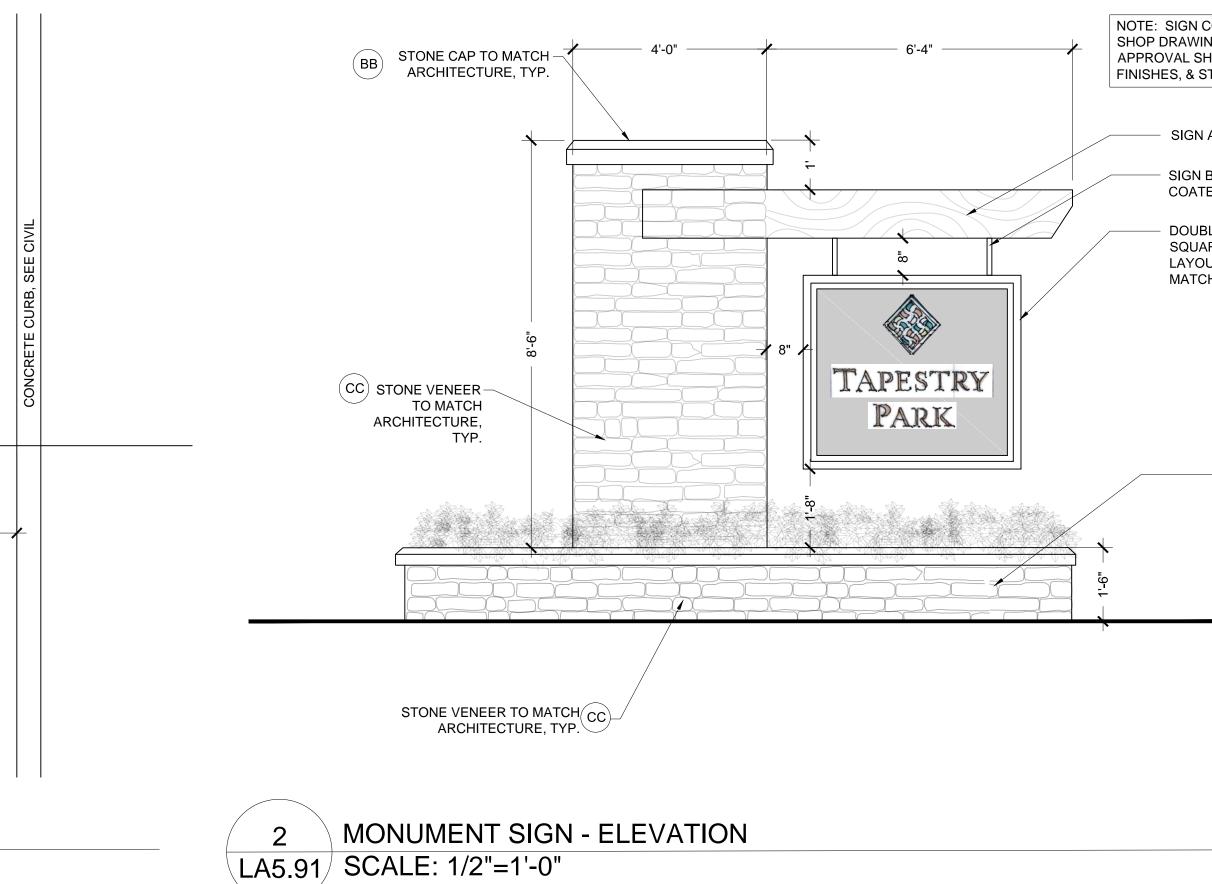PRODUCT: MNC MANCHESTER MANUFACTURER: COOPER LIGHTING, www.cooperlighting.com MODEL: MNC-150-MP-MT-xx-C-V-M-BK-L

MNC	MANCHESTER
150	150W LAMP WATTAGE
MP	PULSE START METAL HALIDE LAMP
MT	MULTI-TAP VOLTAGE
хх	REFRACTOR TYPE (TBD BY MEP)
С	CLASSICAL CAGE
V	VICTORIAN TOP
Μ	MODERN FINIAL
BK	BLACK FINISH
L	LAMP INCLUDED

MOUNTED @ 16' AFG ON A DIRECT BURY ALUMINUM POLE STANDARD DUTY POLE WITH BLACK FINISH BY ALLIANCE COMPOSITES, INC., www.alliancecompositesinc.com





2 PARKING LOT LIGHT

LA5.92 SCALE: 1/2"=1'-0"


PRODUCT: TRIBUTE MANUFACTURER: COOPER LIGHTING, www.cooperlighting.com MODEL: MP-TR-3F-250-MT-LL-BK/MA1017BK

MP	PULSE STAF
TR	TRIBUTE (AF
3F	TYPE III FOF
250	250W LAMP
MT	MULTI-TAP V
LL	LAMP INCLU
BK	BLACK FINIS
MA1017	SINGLE TEN

MOUNTED @ 18' AFG ON A DIRECT BURY ALUMINUM POLE STANDARD DUTY POLE WITH BLACK FINISH BY ALLIANCE COMPOSITES, INC., www.alliancecompositesinc.com

		2	Luma
The Lumark Tribute luminaire is the r universally adaptable outdoor lumina orings outstanding performance to w oading docks, building areas and an isted and CSA certified for wet locati	valkways, parking lots, roadways, y security lighting application. U.L.	Catalog # Project Comments Prepared by	Type Date
SPECIFICATION FEATURES			
Construction Rugged, one-piece, die-cast aluminum housing and door frame. One-piece silicone gasket protects the optical chamber from performance degrading contaminants. One stainless spring latch and two stainless hinges allow tool-less opening and removal of door frame. Electrical Ballast and related electrical componentry are hard mounted to die-cast housing for optimal heat transfer and operating efficiency. Optional swing-down galvanized steel power tray with integral handle and quick disconnects allows tray to be completely removed from housing providing ample room for fixture installation and maintenance.	Reflector Choice of nine high efficiency optical distributions, including five segmented optical systems constructed of premium 95% reflective anodized aluminum sheet. Optical segments are rigidly mounted inside a thick gauge aluminum housing for superior protection. All segment faces are clean of rivet heads, tabs or other means of attachment which may cause streaking in the light distribution. Optical modules are field rotatable in 90° increments and offered standard with mogul-base lampholders for High Pressure Sodium and 200- 400W Metal Halide assemblies or medium-base lampholders for Metal Halide 150W and below.	Mounting Extruded 8" aluminum arm features internal bolt guides for easy positioning of fixture during installation to pole or wall surface. Standard single carton packaging of housing, square pole arm and round pole adapter allow for consolidated product arrival to site. Optional internal mast arm mount accepts a 1-1/4" to 2-3/8" O.D. horizontal tenon, while a four- bolt clamping mechanism secures fixture. Cast-in leveling guides provide +/-5° vertical leveling adjustment. Finish Housing and arm finished in a five-stage premium TGIC bronze polyester powder coat paint. Optional colors include black, grey, white, dark platinum and graphite metallic. RAL and custom color matches available.	TR TRIBU 70 - 4 High Pressure Sc Metal H Pulse Start Metal H AREA/SITE LUMIN
0-1/2" [165mm]			TECHNICAL DATA UL Wet Locations Listed CSA Certified EISA Compliant ® ENERGY DATA
6-1/2			UL Wet Locations Listed CSA Certified EISA Compliant ®
6-1/2" [165mm]			UL Wet Locations Listed CSA Cortified EISA Compliant © ENERGY DATA Hi-Reactance Ballast Input Watts 70W HPS HPF (95 Watts) 100W HPS HPF (130 Watts) 150W HPS HPF (190 Watts)
6-1/2" [165mm] 15-1/2" [394mm] DRILLING PATTERNS	ALL MOUNT (MA1219-XX) TRUNN		UL Wet Locations Listed CSA Certifled EISA Compliant @ EISA Compliant @ EISA Compliant @ EISA Compliant @ Hi-Reactance Ballast Input Watts 70W HPS HPF (195 Watts) 150W HPS HPF (190 Watts) 150W HPS HPF (190 Watts) 150W HP HPF (195 Watts) CWA Ballast Input Watts 250W HPS HPF (200 Watts) 200W HP HPF (210 Watts) 200W MP HPF (210 Watts) 200W MP HPF (250 Watts) 250W MP HPF (250 Watts)
6-1/2" 6-1/2" [165mm] 15-1/2" 1	ALL MOUNT (MA1219-XX) TRUNN		UL Wet Locations Listed CSA Certified EISA Compliant @ EISA Compliant @ EISA Compliant @ ENERGY DATA Hi-Reactance Ballast Input Watts 70W HPS HPF (130 Watts) 150W HPS HPF (130 Watts) 150W HPS HPF (130 Watts) 150W MP HPF (136 Watts) CWI Ballast Input Watts 250W HPS HPF (210 Watts) 250W MP HPF (220 Watts) 200W MP HPF (220 Watts) 250W MP HPF (220 Watts) 250W MP HPF (238 Watts) @ 320W MP HPF (387 Watts) @ 320W MP HPF (387 Watts) @ 320W MP HPF (382 Watts) @ 350W MP HPF (382 Watts) @ 400W MP HPF (455 Watts) @

ART METAL HALIDE ARM INCLUDED) ORMED DISTRIBUTION OF WATTAGE WIRED 277V UDED ISH NON ADAPTER FOR 2³/₈" O.D. TENON

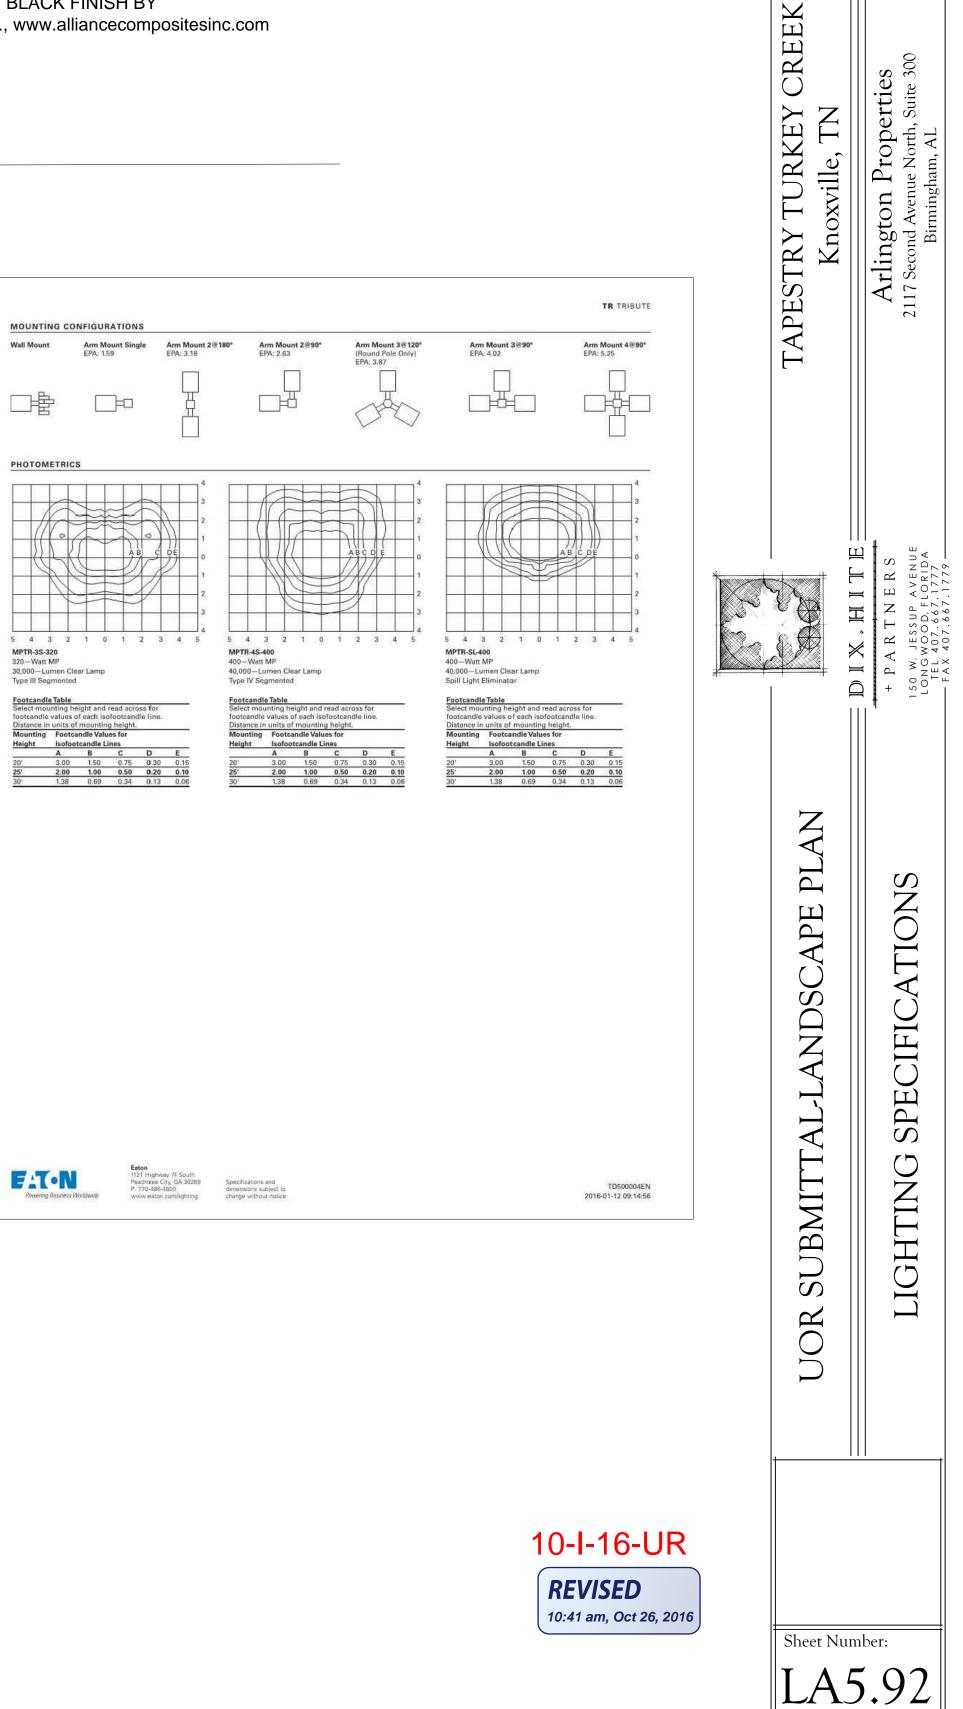

09/28/2016

RCC / MO

10/27/2016

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Date:

Drawn by: Reviewed by:

Job Number:

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Revision: Date:

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