

FOR BRADEN FAMILY HOMES LLC

ADDRESS 5305 JACKSBORO PIKE SIDISTRICT 7th COUNTY KNOX CITY KNOXVILLE STAT LOT NO. 2 BLOCK "52" RESUB. OF FOUNTAIN CITY S/D

WARD 36th CITY BLOCK 36990 DRAWN BY SWA

MAP CAB. 202506240068126

TAX MAP 058D GROUP K PARCEL 020.01 WARRANTY DEED BK. 202506300069317 MORTGAGE CO.

SCALE 1" = 30' CITY KNOXVILLE STATE TN ZIP 37917

JNTAIN CITY S/D


ABBOTT LAND SURVEYING LLC


STEVEN W. ABBOTT JR, RLS 1109 E. WOODSHIRE DRIVE KNOXVILLE, TN 37922 OFFICE: (865) 671-1149 EMAIL: survmap@tds.net



THIS IS TO CERTIFY THAT THIS SURVEY MEETS THE MINIMUM STANDARDS FOR THE STATE OF TENNE'S EE.I ITHIS IS TO CERTIFY THAT ON THE DATE SHOWN, I MADE AN ACCURATE SURVEY OF THE PREMISES SHOWN HEREON USING THE LATEST RECORDED DEED AND OTHER INFORMATION FURNISHED TO ME, THAT THERE ARE NO EASEMENTS, ENCROACHMENTS OR PROJECTIONS EVIDENT OTHER THAN THOSE SHOWN. THE SURVEY WAS DONE UNDER THE AUTHORITY OF TCA 62–18–126: AND THE SURVEY IS NOT A GENERAL PROPERTY SURVEY AS DEFINED UNDER RULE 0820–3–07. THIS IS TO CERTIFY THAT I HAVE EXAMINED THE FEDERAL INSURANCE ADMINISTRATION FLOOD HAZARD MAP AND FOUND THE DESCRIBED NOT TO BE LOCATED IN A SPECIAL FLOOD



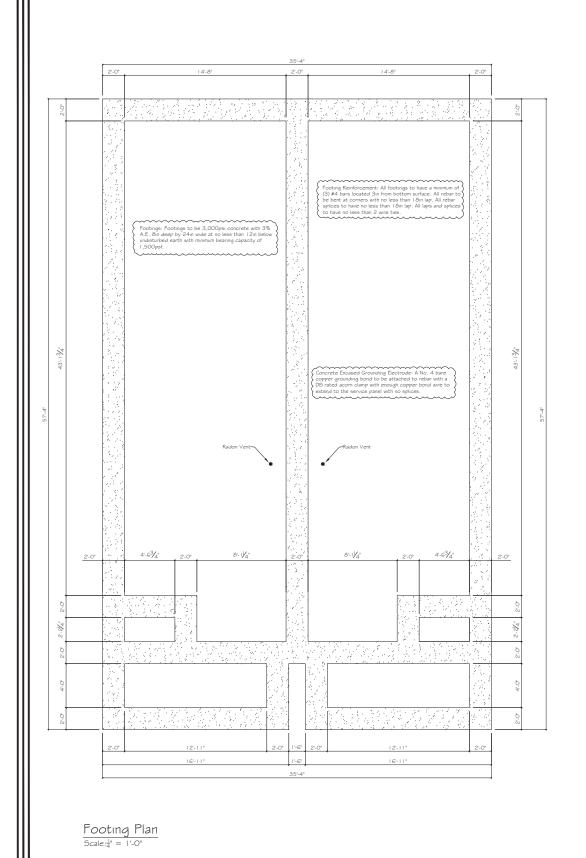

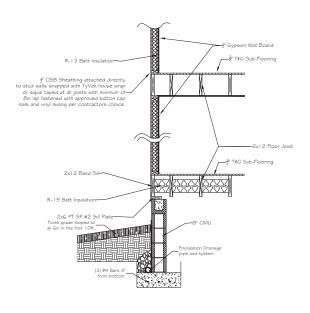

 $\frac{\text{Typical Exterior Wall Detail}}{\text{Scale:}_{\underline{J}^{\text{II}}}^{\underline{J}^{\text{II}}} = \text{I'-O''}}$

 $\frac{\text{Foundation Plan}}{\text{Scale:} \frac{1}{4}" = 1'-0"}$

32in x 32in Opening with door for crawlspace access.

Sill Plate to be anchored to CMU foundation wall with \$100 bolts embedded in to solid concrete or grouted solid CMU with minimum embedment of 7m. A washer and nut is to be tightened on each anchor bolt. Anchor bolts to be GH maximum or center and no more than 12m from all the contract of the solid plate of the contract of the solid plate.

Vapor Barner: A 6mil poly is to be placed over gravel base and extend up CMU foundation wall no less than 121 and taped. All penetrations are to be taped tight. Laps are to be no less than 12in and taped.

14'-77/32"


1'-10²⁵/32


4in Thick 3,000psi concrete with 3% A.A with Ex. Light Broom Finish. Concrete sloped 1/8in per foot away from structure for drainage.

14'-725/32"


Every attempt has been made to ensure these plans meet the ICC IRC 2024 Code and provide the required information and detail to allow code compliant construction of the proposed structure. However it is the contractor and MEP sub-trades responsibility to ensure that all construction methods, materials, installation and workmanship are performed to and meet the ICC codes, state requirements and adopted ordnances and zoning requirements of the local jurisdiction.



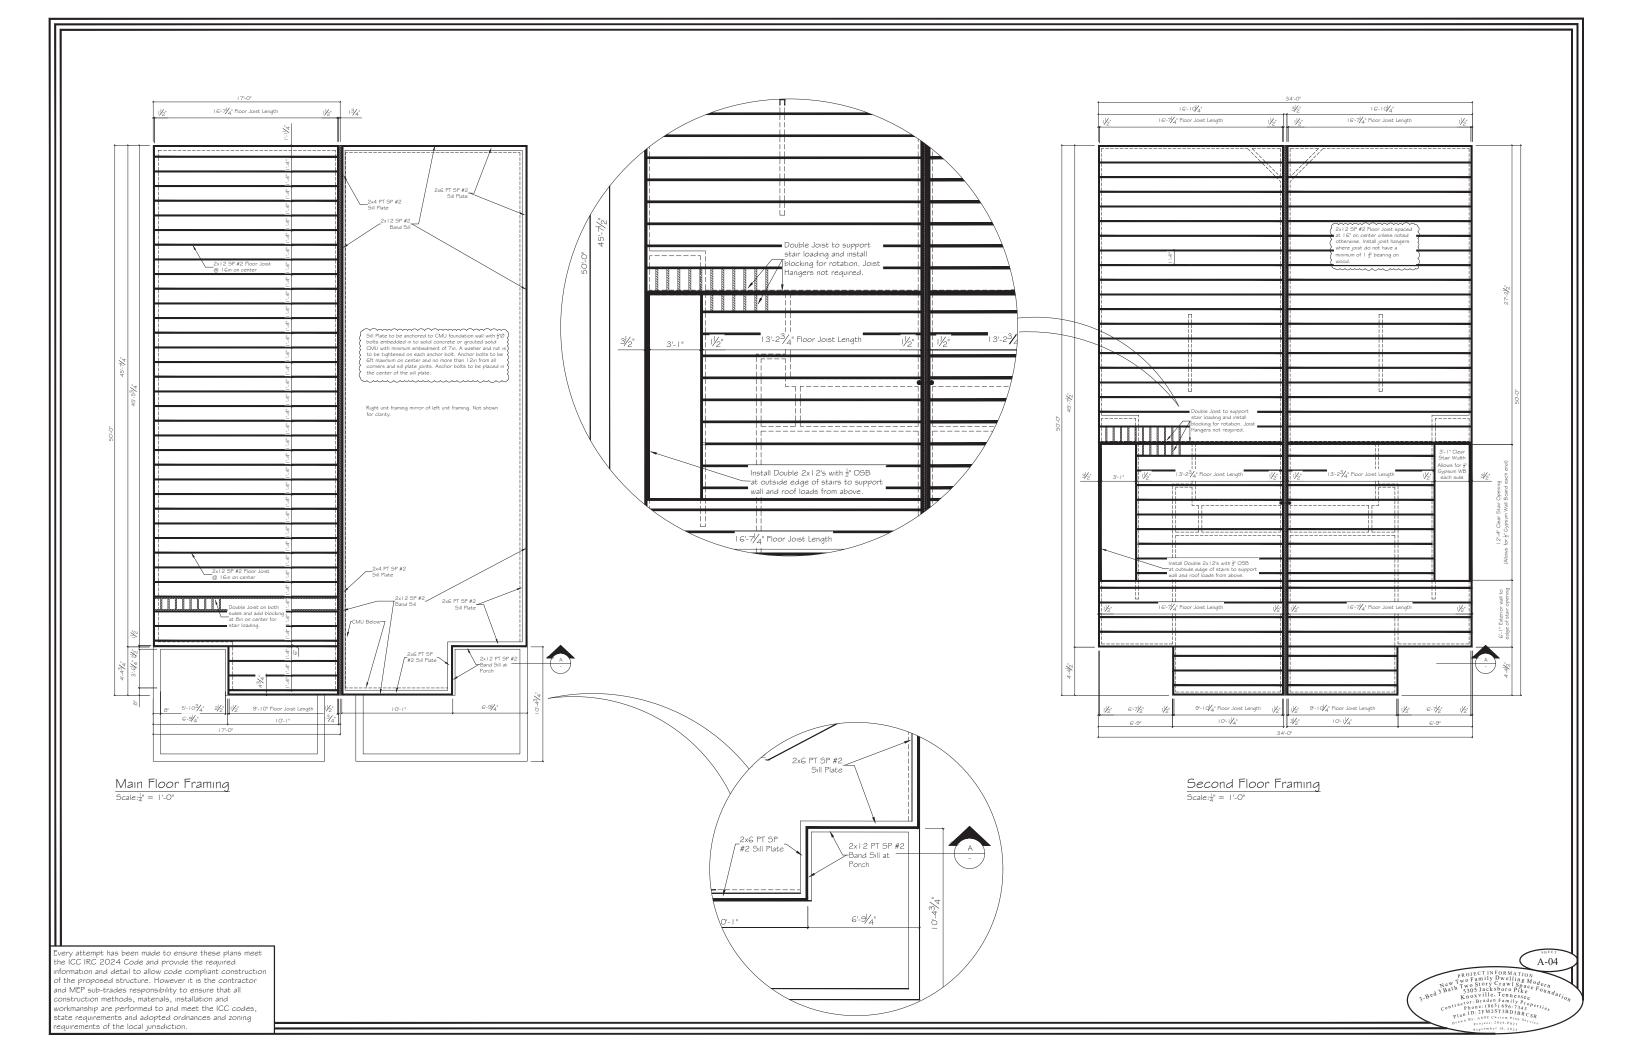


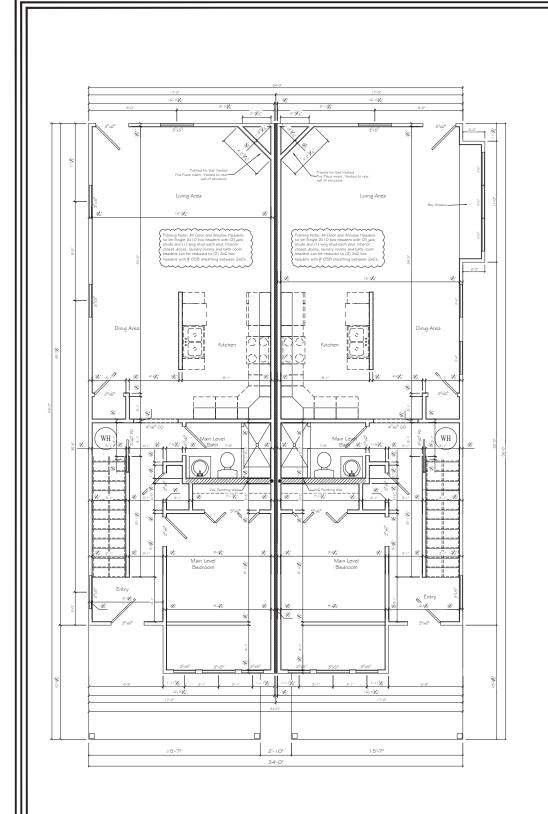




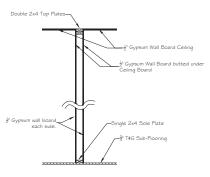

$\frac{\text{Typical Interior Wall Detail}}{\text{Scale}; \frac{1}{2}^{\text{II}} = \text{ I'-O''}}$

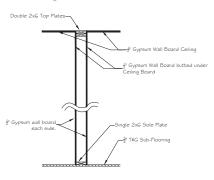

 $\frac{\text{Typical Plumbing Wall Detail}}{\text{Scale:}_{2}^{!*} = \text{1'-0''}}$

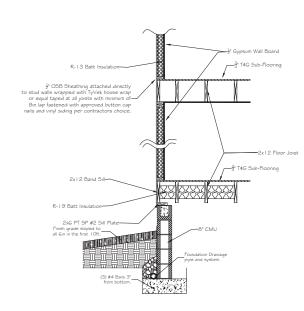

Typical Exterior Wall Detail Scale: ½" = 1'-0"


Second Floor Plan


Scale: 4" = 1'-0"


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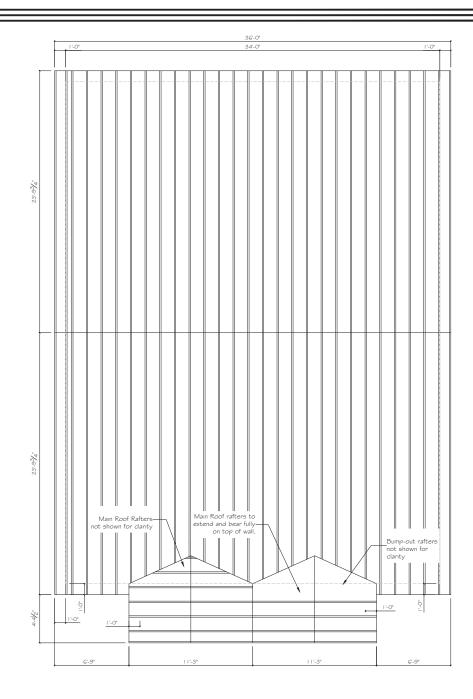
PROJECT INFORMATION
NEW Two Family Dwelling Modern
Stath Two State State Pike

3.Bed State State State State State
Knowles France Family Dresses
Contract State State State State State
Plan ID: EMBEST 380 JAB CSR
Plan ID: EMBES



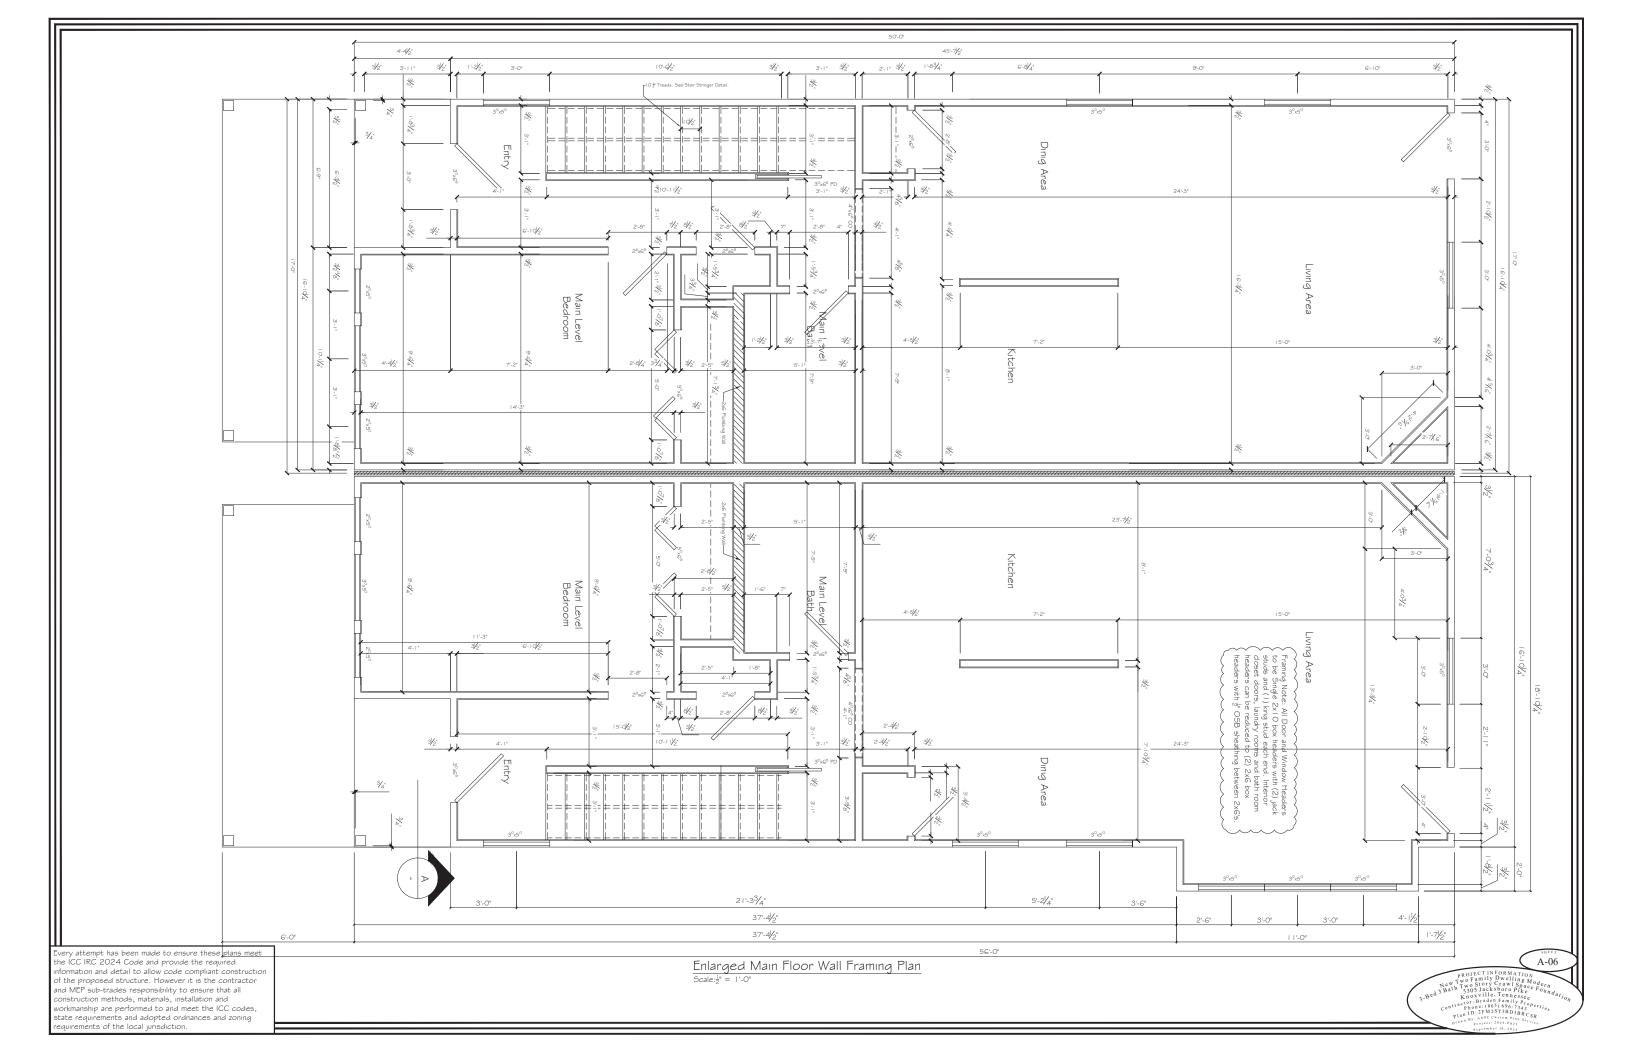

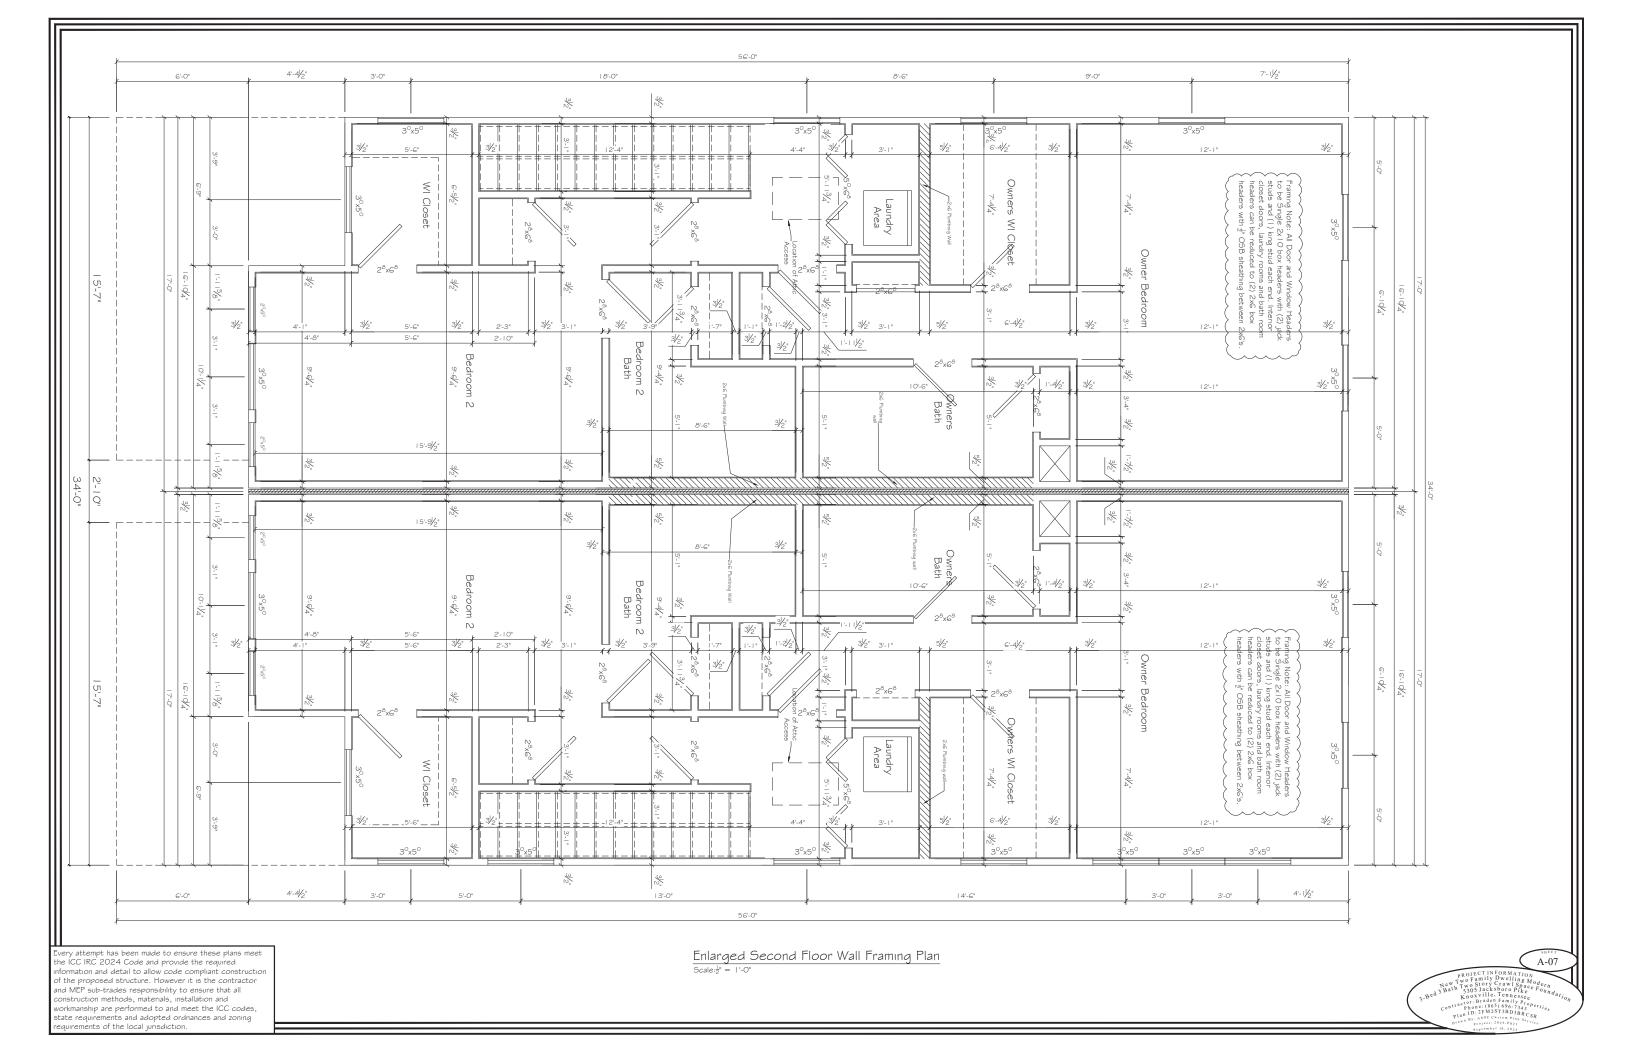

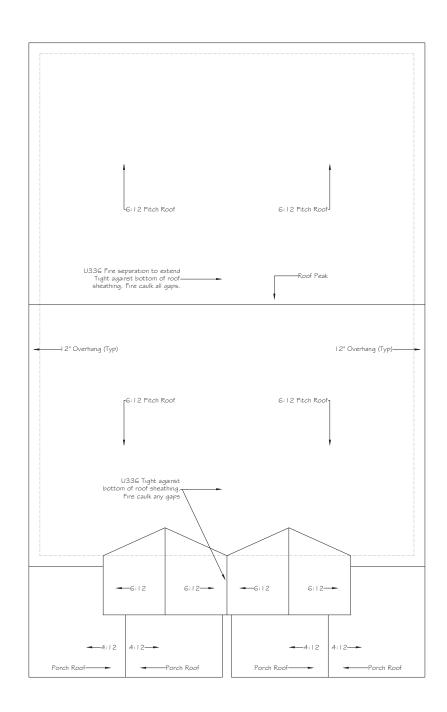

 $\frac{\text{Roof Slope Plan}}{\text{Scale: } \frac{1}{4}\text{"} = 1\text{'-0"}}$

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 $\frac{\text{Rafter Plan}}{\text{Scale: } \frac{1}{4}\text{"} = 1\text{'-O"}}$

A-08

APROJECT INFORMATION

PROJECT INFORMATION

New Trans Story Craw Space deem

Soury Craw Space deem

Soury Craw Space deem

Soury Craw Space deem


Knowlie, Fennessee


Knowlie, Fennessee

Contra Phonograded Smally Properties

Plan ID 27 M ST 3BD 3BR CSR

Plan ID 27 M ST 3BD

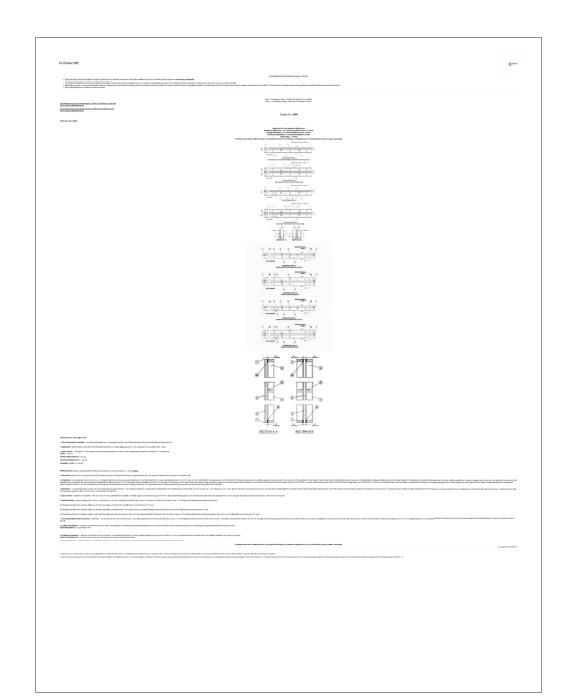

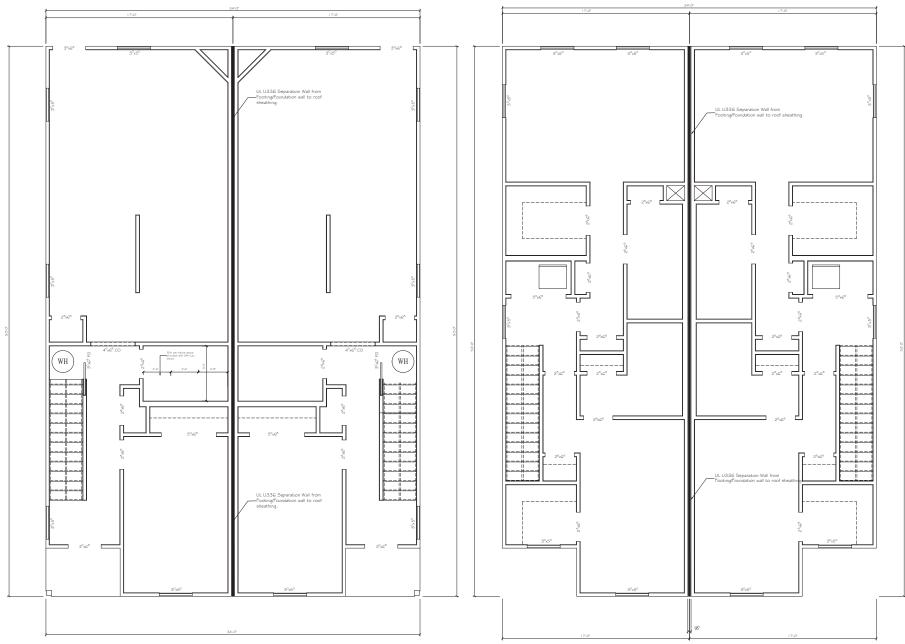


UL-U336 Scale: NTS $\frac{\text{Main Level Fire Separation Wall}}{\text{Scale: } \frac{1}{4}^{\text{u}} = \ \text{I'-0"}}$


 $\frac{Second\ Floor\ Fire\ Separation\ Wall}{Scale: \frac{1}{4}"=1'\cdot0"}$


Fire Assembly to extend into soffits and projections.


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PROJECTINFORMATION
No Two Family Dwelling Modern
New Two Family Dwelling Modern
Knowlile, Tennessee
Scott Self-Braden Family
Panes 1865, 686-7343 Perfection
Plane 11 FM 273100 BB CSR
Plane 12 FM 27310 BB CSR
Plane 12 F



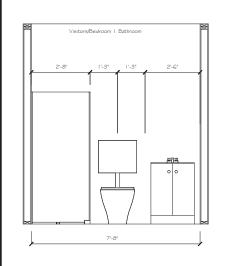

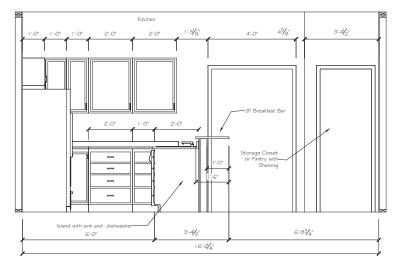

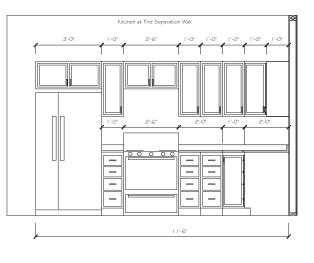


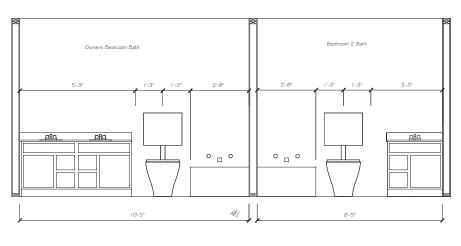
 $\frac{\text{Main Floor Bath Elevation}}{\text{Scale: } \frac{1}{2}" = 1" - 0"}$


 $\frac{\text{Kitchen Elevation I}}{\text{Scale: } \frac{1}{2}\text{"} = \text{ I'-O"}}$

 $\frac{\text{Kitchen Elevation 2}}{\text{Scale: } \frac{1}{2}\text{"} = \text{ 1'-0"}}$

 $\frac{Second\ Floor\ Bath\ Elevations}{Scale: \frac{1}{2}" = \ I'-O"}$

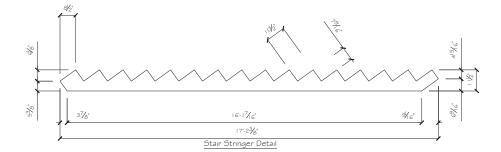

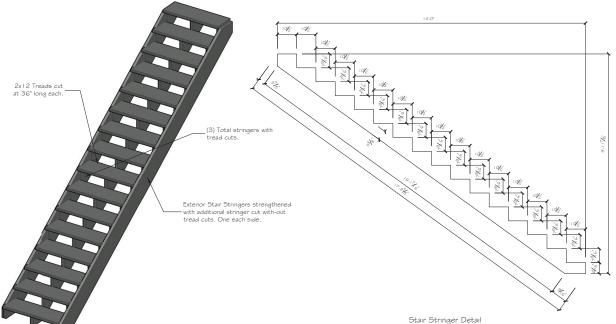


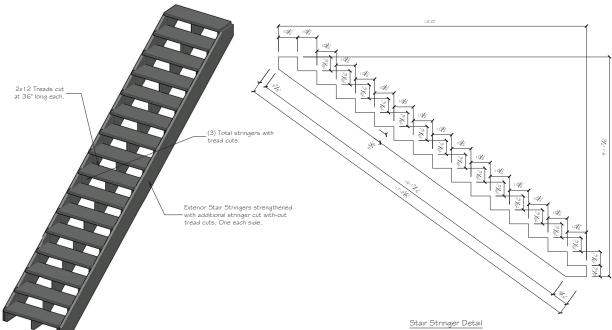

 $\frac{Stair\ Stringer\ Construction\ Notes.}{Scale: \frac{1}{2}"\ =\ |'-0"}$

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A-10

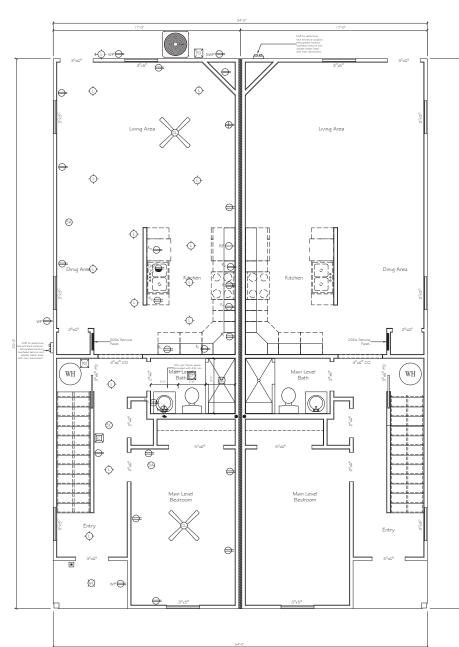

Electrical Main Floor $Scale: \frac{1}{4}" = 1'-0"$

1. Single Service: E3601.2 Number of services. One and two family dwellings shall be supplied by only one service. (230.2).
2. Individual Feedes: E3601.3 One building or other structure not to be supplied through another. Service conductors supplying a building or other structure (230.3).
3. Service Desconnect: E3601.6.1 Service disconnect required. Means shall be provided to disconnect all ungrounded conductors in a building or other structure. (230.3).
4. Noting of Service entrance conductors, (220.70).
4. Noting of Service (E3601.6.1 Marking of service equipment and disconnects, (230.70(g)).
5. Disconnect Location: E3601.6.2 Service disconnect location. The service disconnects conductors: Service disconnects, (230.70(g)).
6. Noting of Service shall be installed at a readily accessible location either outside of a building or inside nearest the point of entrance of the service disconnects mass shall be installed at a readily accessible location either outside of a building or inside nearest the point of entrance of the service conductors. Service disconnecting mass shall be installed at a readily accessible location either outside of a building or inside nearest the point of entrance of the service conductors. Service disconnecting mass shall be of prostalled in bathrooms. Each occupant shall have access to the disconnect serving the divelling unit in which they reside. (230.70(k)) (12), 230.72(c)).
6. Number of Disconnects E3601.7 As maint number of disconnects and the milliple service disconnecting mass in shall be divided of 17.1 in langle E301.7.3. In all cases, the maximum number of disconnecting mass shall be grouped.

mmedately adjacent thereto. Where fuses are used as the service over current device, the disconnecting means shall be located on the supply side of the fuses. (230,91).

Surge Protection: E3606.5 Surge protection. All services supplying one- and two-family dwelling units shall be provided with a surge-protective device (SFD) installed in accordance with Sections E3606.5.5.1 through E3606.5.3.


9. System Ground: 25607.1 System service ground. The premises wring system shall be gooded at the service with a synopriding electrode conductor Grounding electrode conductors shall be service and accordance with Table E3603.4.

[250.20(B)] in and 250.24(A)]


10. Location of Ground: E3607.2 Location of grounding electrode conductor connection. The grounding electrode conductor shall be seed in accordance with Table E3603.4.

[250.20(B)] in and 250.24(A)]

10. Location of Ground: E3607.2 Location of grounding electrode conductor connection. The grounding electrode conductor shall be connected to the grounded service conductors, service along undersyonal service and undersyonal service and undersyonal service and undersyonal service and undersyonal service conductors, service along undersyonal service conductors, service and services and service

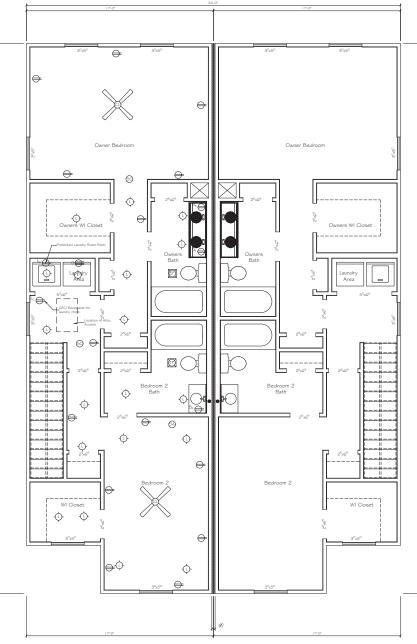

Electrical Upper Floor

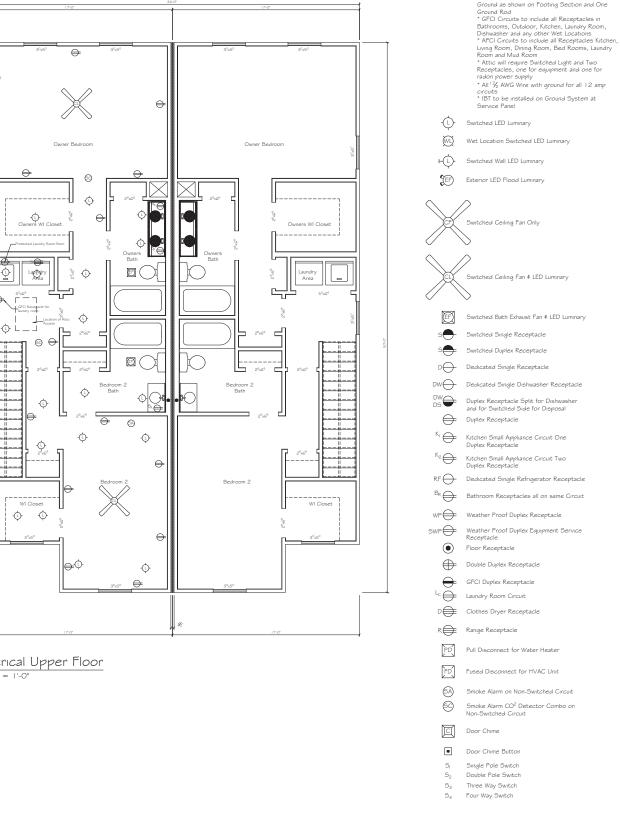

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A2-03

Electrical Notes:
* All Wiring to be Per IRC 2018 and Local and * Ground Sources used will be Concrete Encased Ground as shown on Footing Section and One

