

# LEGEND: PROPOSED GROUND CONTOUR ELEVATION

PROPERTY LINE

EASEMENT

SPOT ELEVATION STRUCTURE

Θ-----Θ

SURFACE FLOW

CATCH BASIN CONCRETE PAVEMENT

ASPHALT PAVEMENT

EDGE OF PAVEMENT OVERHEAD ELECTRICAL

REVISIONS:

WNR DRAWN: CHECKED: WNR DATE: 11/19/2024

FILE NAME: PROJECT NO:

CONCEPT LAYOUT PLAN DRAWING

PARCELS: 109IA006, 109IA00703, 109IA00702, AND 109IA00701 USE: AUTOMATIC CARWASH ZONING: C-G-2

BUILDING: TOTAL: 4,200 SF PARKING SUMMARY:


CALCULATION (CITY):
CARWASH: MIN 0.5ÆMPLOYEE MAX 1.0ÆMPLOYEE
8 EMPLOYEES
CALCULATION: MIN = 0.5 X 8 = 4 SPACES, MAX 1.0 X 8 = 8 SPACES


SETBACKS: FRONT: 0-20' BUILD TO LINE SIDE: 0' REAR: 0'


PARCEL AREA: 2.10 AC, 91,476 SF IMPERVIOUS AREA: 34,000 SF 0.78 AC FLOOR AREA RATIO: 4.6 % IMPERVIOUS AREA RATIO: 37.2 % GROSS AREA COVERAGE: 4.6 %

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PROJECT
LOCATION

PROJECT LOCATION MAP - NOT TO SCALE

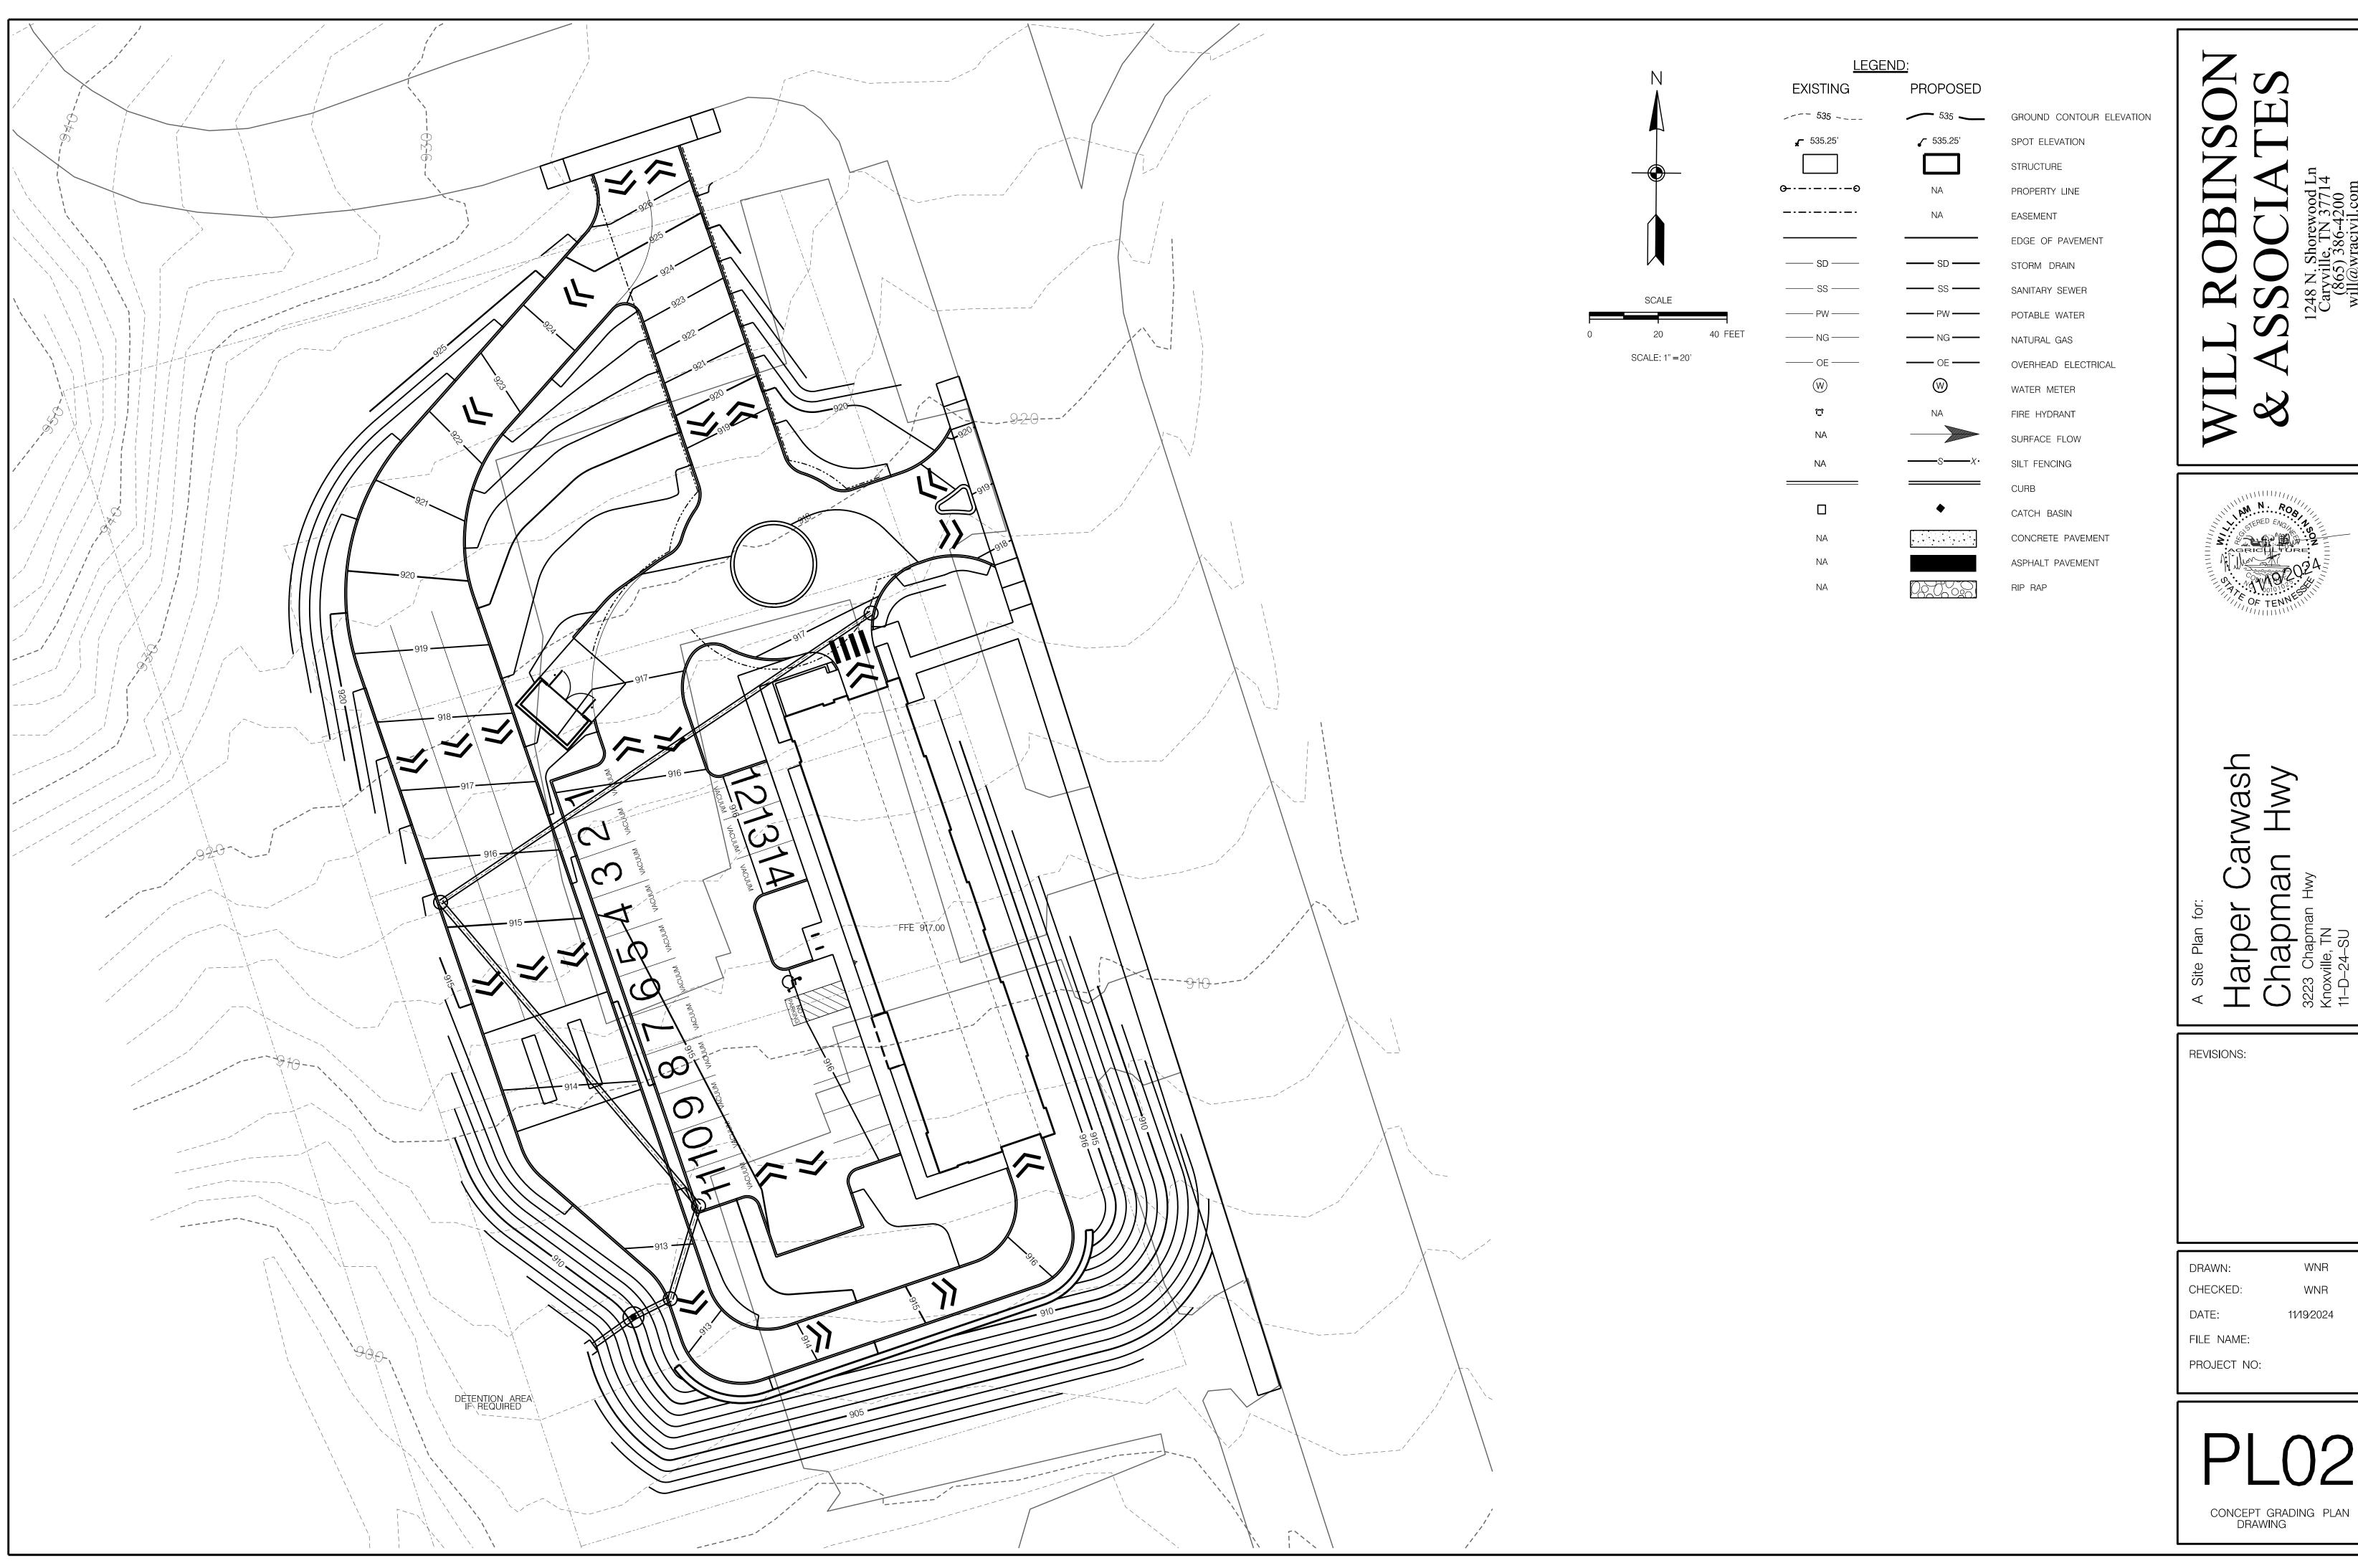


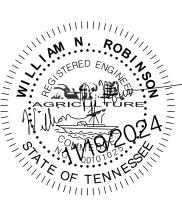

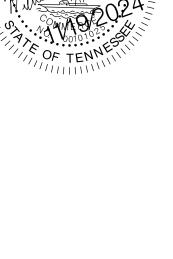

WNR 11/19/2024

WNR

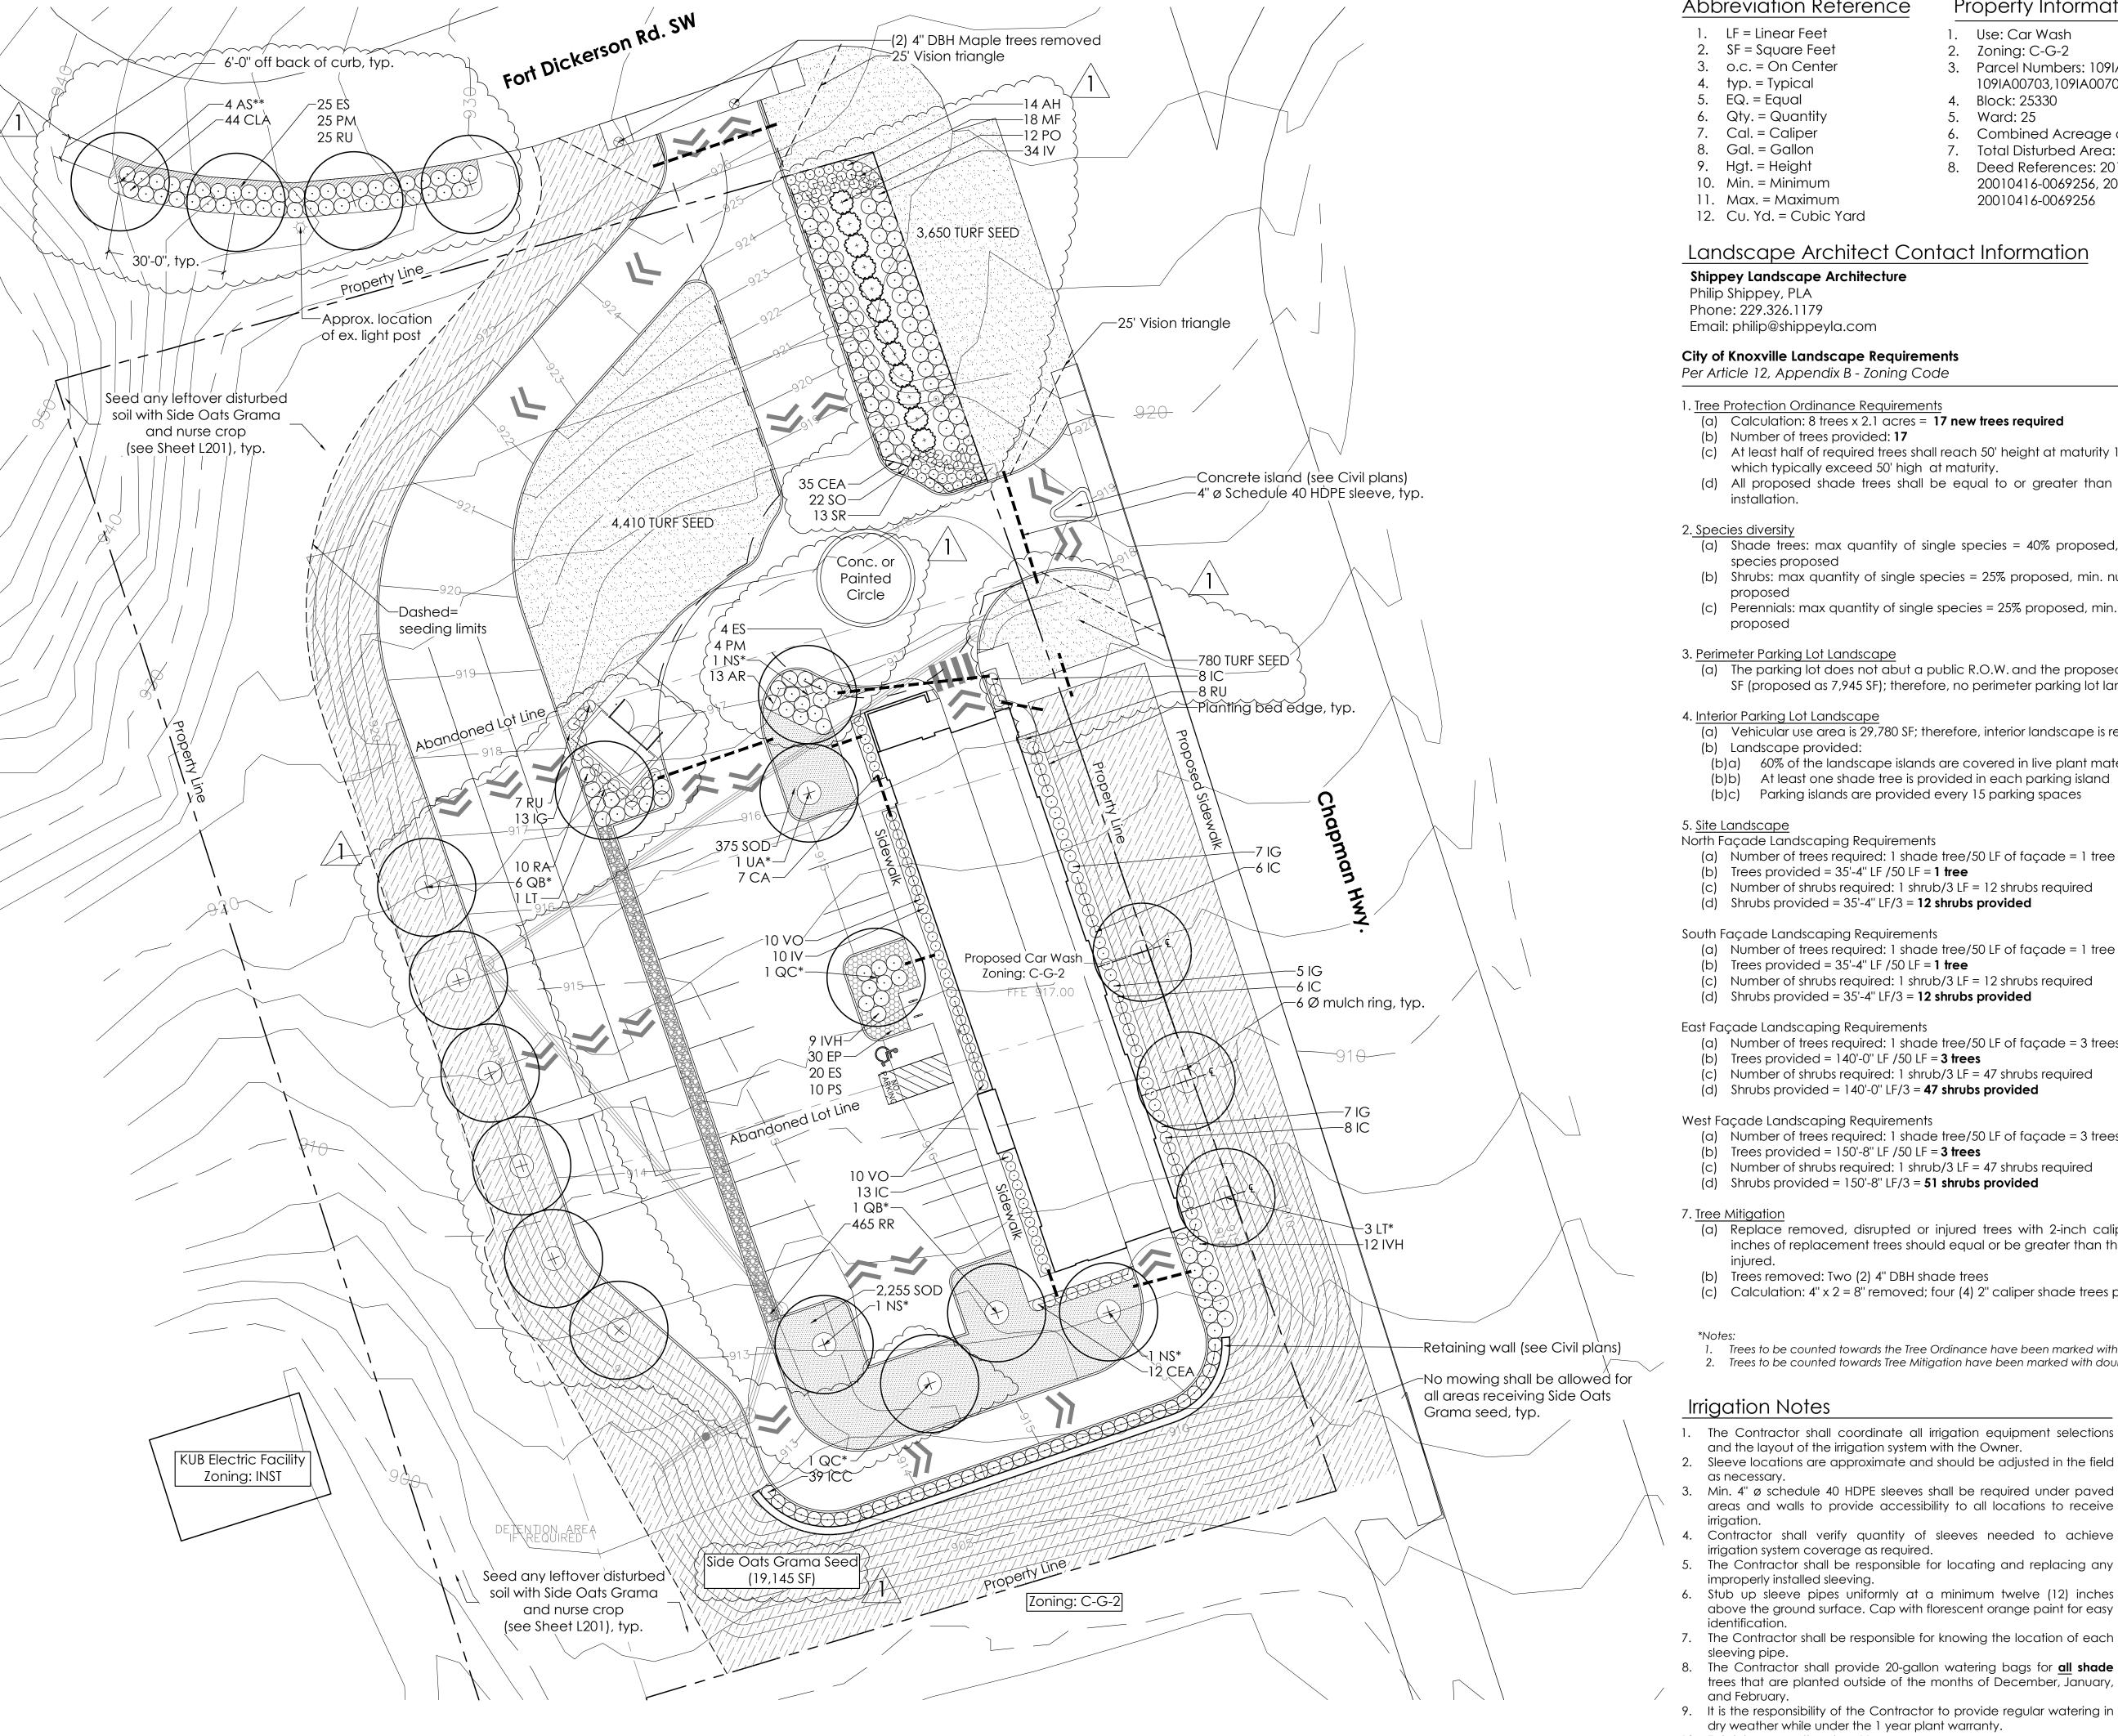

Abbreviation Reference

1. LF = Linear Feet

2. SF = Square Feet

3. o.c. = On Center 4. typ. = Typical

2. Zoning: C-G-2

3. Parcel Numbers: 109IA006, 109IA00703,109IA00702, 109IA00701

Property Information

4. Block: 25330

1. Use: Car Wash

Ward: 25

Combined Acreage of Parcels: 2.09 acres

7. Total Disturbed Area: 1.50 acres

Deed References: 20150309-0047902, 20010416-0069256, 20010416-0069256,

20010416-0069256

Landscape Architect Contact Information

**Shippey Landscape Architecture** Philip Shippey, PLA

Phone: 229.326.1179 Email: philip@shippeyla.com Sheet Index

L201

L100 Landscape Plan L200 Landscape Details Landscape Notes & Plant Schedule

Know what's below.

Call before you dig.

Per Article 12, Appendix B - Zoning Code

1. Tree Protection Ordinance Requirements

(a) Calculation: 8 trees x 2.1 acres = 17 new trees required

(b) Number of trees provided: 17

(c) At least half of required trees shall reach 50' height at maturity 17/2 = 9 of the proposed trees are species which typically exceed 50' high at maturity.

(d) All proposed shade trees shall be equal to or greater than the 2" caliper minimum size required at installation.

2. Species diversity

(a) Shade trees: max quantity of single species = 40% proposed, min. number of species for type = 5, 6 (b) Shrubs: max quantity of single species = 25% proposed, min. number of species for type = 8, 11 species

(c) Perennials: max quantity of single species = 25% proposed, min. number of species for type = 8, 8 species

3. Perimeter Parking Lot Landscape

(a) The parking lot does not abut a public R.O.W. and the proposed parking/vacuum area is less than 10,000 SF (proposed as 7,945 SF); therefore, no perimeter parking lot landscape is required.

4. Interior Parking Lot Landscape

(a) Vehicular use area is 29,780 SF; therefore, interior landscape is required.

(b) Landscape provided:

(b)a) 60% of the landscape islands are covered in live plant material

At least one shade tree is provided in each parking island

(b)c) Parking islands are provided every 15 parking spaces

5. <u>Site Landscape</u>

North Façade Landscaping Requirements

(a) Number of trees required: 1 shade tree/50 LF of façade = 1 tree required

(b) Trees provided = 35'-4" LF /50 LF = 1 tree

(c) Number of shrubs required: 1 shrub/3 LF = 12 shrubs required (d) Shrubs provided = 35'-4" LF/3 = **12 shrubs provided** 

South Façade Landscaping Requirements

(a) Number of trees required: 1 shade tree/50 LF of façade = 1 tree required

(b) Trees provided = 35'-4" LF /50 LF = 1 tree

(c) Number of shrubs required: 1 shrub/3 LF = 12 shrubs required

(d) Shrubs provided = 35'-4" LF/3 = 12 shrubs provided

East Façade Landscaping Requirements

(a) Number of trees required: 1 shade tree/50 LF of façade = 3 trees required

(b) Trees provided = 140'-0" LF /50 LF = **3 trees** 

(c) Number of shrubs required: 1 shrub/3 LF = 47 shrubs required (d) Shrubs provided = 140'-0" LF/3 = 47 shrubs provided

West Façade Landscaping Requirements (a) Number of trees required: 1 shade tree/50 LF of façade = 3 trees required

(b) Trees provided = 150'-8" LF /50 LF = **3 trees** 

(c) Number of shrubs required: 1 shrub/3 LF = 47 shrubs required

(d) Shrubs provided = 150'-8" LF/3 = **51 shrubs provided** 

(a) Replace removed, disrupted or injured trees with 2-inch caliper replacement trees. The total caliper inches of replacement trees should equal or be greater than the DBH of the trees removed, disrupted, or

(b) Trees removed: Two (2) 4" DBH shade trees

(c) Calculation: 4" x 2 = 8" removed; four (4) 2" caliper shade trees provided = 8" total replaced

1. Trees to be counted towards the Tree Ordinance have been marked with an asterisk (\*) on the plan.

2. Trees to be counted towards Tree Mitigation have been marked with double asterisks (\*\*) on the plan.

Irrigation Notes

1. The Contractor shall coordinate all irrigation equipment selections

2. Sleeve locations are approximate and should be adjusted in the field

3. Min. 4" ø schedule 40 HDPE sleeves shall be required under paved areas and walls to provide accessibility to all locations to receive

4. Contractor shall verify quantity of sleeves needed to achieve irrigation system coverage as required.

5. The Contractor shall be responsible for locating and replacing any improperly installed sleeving.

6. Stub up sleeve pipes uniformly at a minimum twelve (12) inches above the ground surface. Cap with florescent orange paint for easy

8. The Contractor shall provide 20-gallon watering bags for **all shade** trees that are planted outside of the months of December, January,

9. It is the responsibility of the Contractor to provide regular watering in dry weather while under the 1 year plant warranty.

10. Total sleeves on the plan: 11

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Landscape Plan

11-22-2024 Revision

Revision 1. City Comments 11-22-24

Sheet Name

Landscape Plan

Sheet Number


- Tree shall be plumb after settlement. Contractor shall stake tree. Straps for staking shall be tight enough to secure tree to stakes, but loose enough to prevent girdling of tree trunk/branches. Remove all stakes one (1) year after installation


- Trunk flare of each tree shall be exposed. Set tree so that no part of the trunk flare is buried. Do not cover trunk flare with mulch. -Remove and discard burlap (or container) except under the root-ball. Remove all synthetic soil wrap materials (burlap, twine, wire baskets, etc.) and discard - Mulch (no mulch to touch trunk of tree) - Excavate planting hole 3x (min.) wider than root-ball. Backfill hole with loosened existing soil. -Excavate topsoil as required to place root-ball at proper level. Place root-ball on undisturbed subgrade or compacted

existing backfill soil. Undisturbed or compacted subgrade must percolate.


Tree Planting & Staking

Scale: NTS

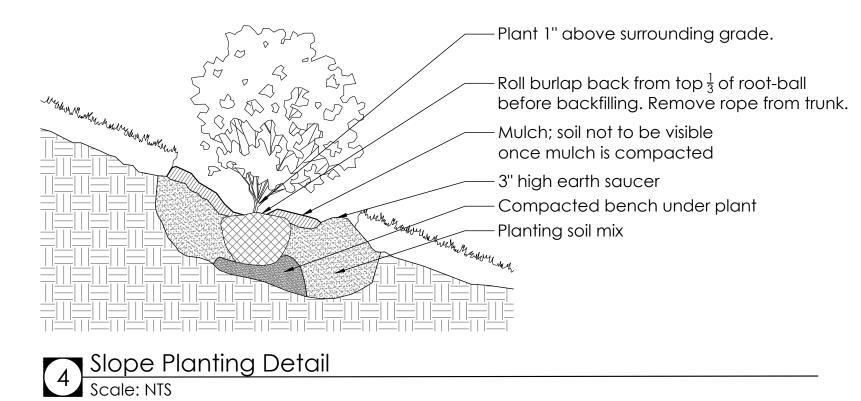


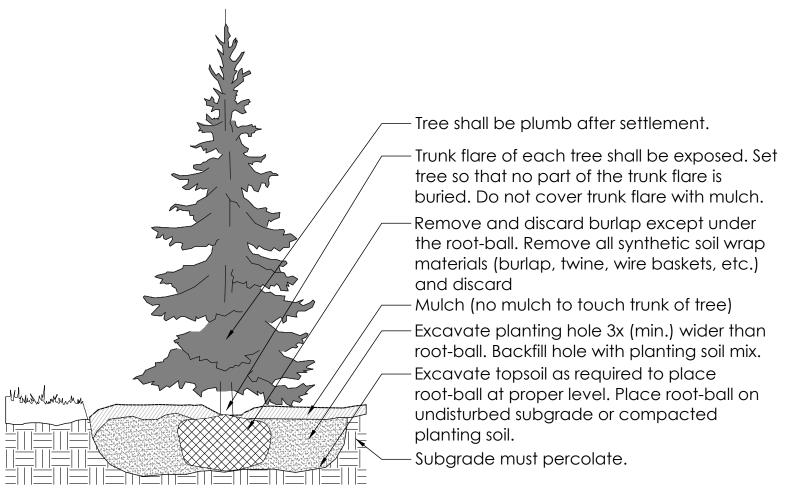




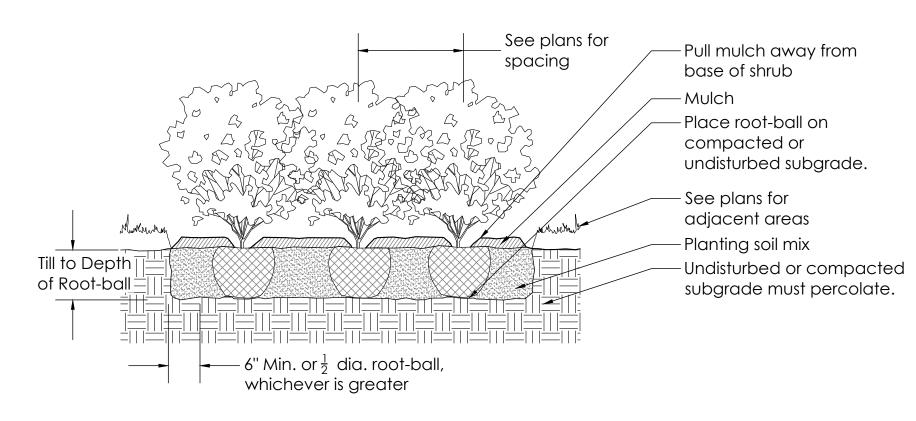



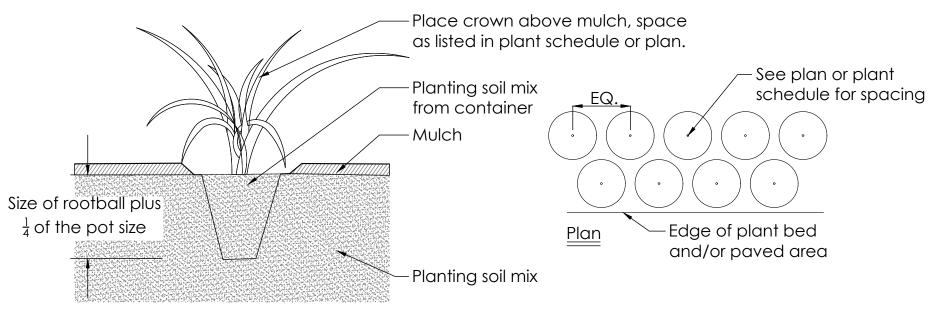



5 Perennial/Ornamental Grass Planting Detail Scale: NTS

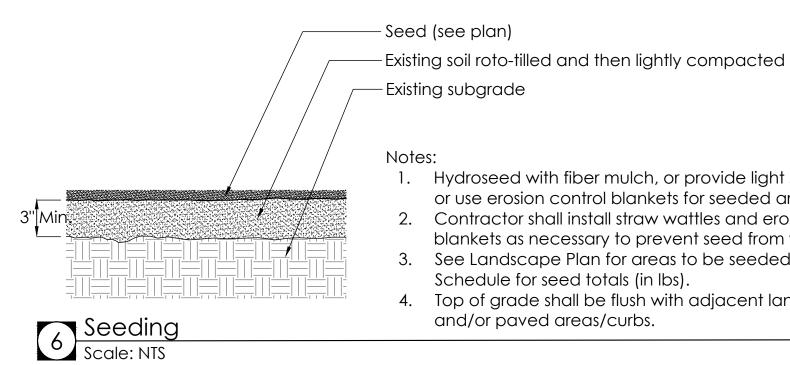



1. Hydroseed with fiber mulch, or provide light straw mulch, or use erosion control blankets for seeded areas.

- 2. Contractor shall install straw wattles and erosion control blankets as necessary to prevent seed from washing away
- See Landscape Plan for areas to be seeded and the Plant Schedule for seed totals (in lbs).
- 4. Top of grade shall be flush with adjacent landscape and/or paved areas/curbs.

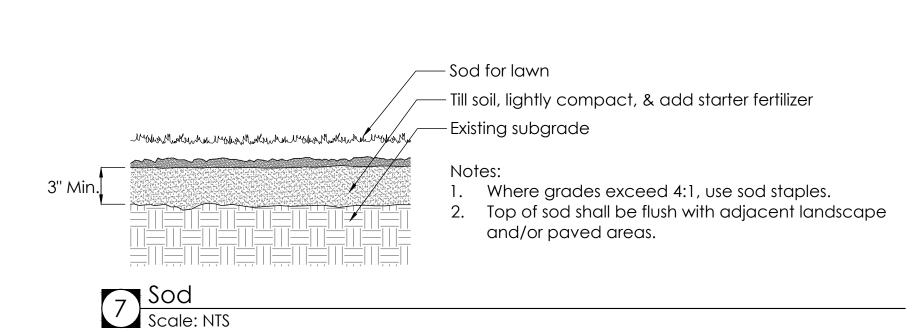

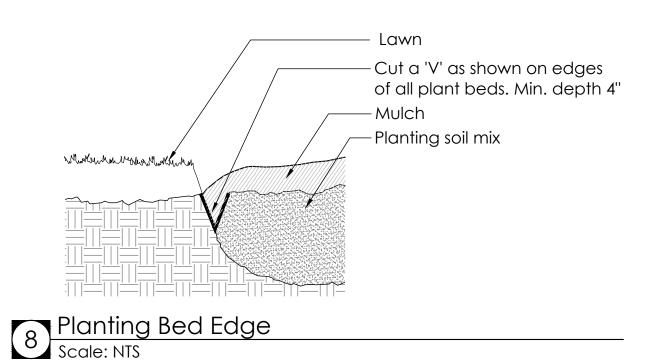

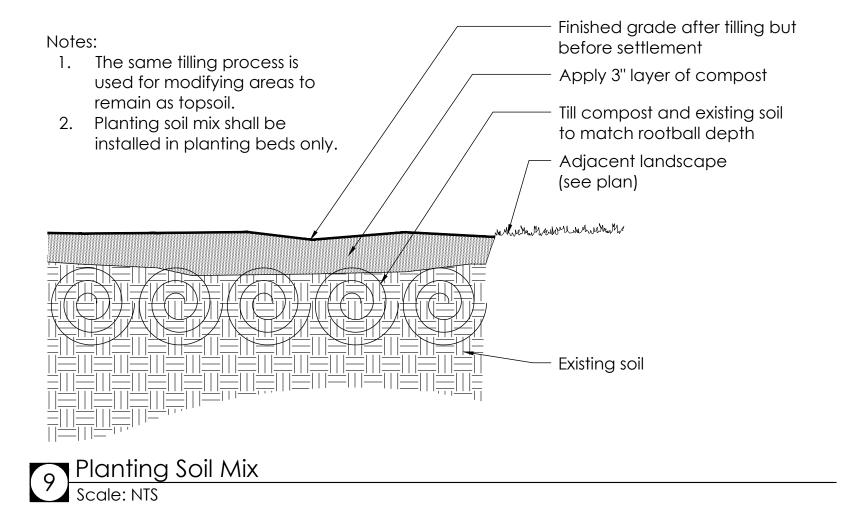

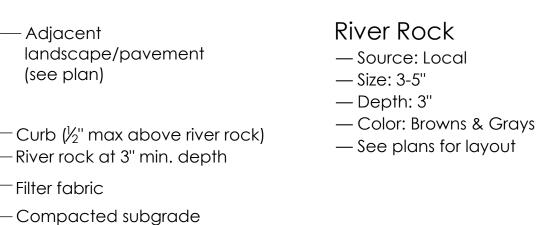

\*Notes: 1. All river rock shall be from the same local source and be washed prior to being brought to project site.

River Rock
Scale: 1"=1'-0"





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hapman 322X

Drawn By 11-22-2024 Revision Revision 1. City Comments 11-22-24

Sheet Name

Landscape

Sheet Number

### Planting Notes

- 1. The Contractor shall verify existing conditions in the field and report any discrepancies to the Landscape Architect prior to starting
- 2. No planting shall occur until soil test sample been amended per the soil test results. See this sheet for for soil testing instructions.
- 3. No planting shall occur until percolation testing has been completed and soils have be properly graded for positive drainage. procedures.
- 4. All new plant material shall to conform to the guidelines set for nursery stock published by Additionally, all new plant material for the project shall be of the highest specimen quality.
- 5. Do not assume that trunk flares will be exposed at the nursery. Contractor to expose trunk flares to check for girdling. Pull mulch away from the base of all plants.
- 6. All new plants shall be balled and burlapped 17. Plant material delivered to the site that does or container grown unless otherwise noted on the plant schedule.
- 7. The Contractor shall locate and verify all utility lines prior to soil preparation or planting. Any discrepancies shall be reported to the Landscape Architect. Call Tennessee 811 to schedule a utility locate.
- 8. Till all beds with planting soil mix to a 19. Application of pesticides must be approved minimum depth that matches the depth of the plant root-balls.
- 9. All plant beds and trees shall receive a double-shredded, hardwood mulch. See Seeding Notes on this sheet for mulching of seeded areas.
- 10. All trees in lawn and restoration planting areas shall have a minimum 6' diameter mulch ring to surround the base of the trunk 21. Mulch, compost, river rock, seed, and sod unless noted otherwise on the plan.
- 11. Do not pile mulch against the trunk of any tree. Leave a gap for the trunk flare. **Avoid** mulch volcanoes.

- 12. Thoroughly water **all** plants during the first 24 hours after planting. Wet the soil to a depth of 18-24". When water starts to run off, stop watering, let the water soak in and repeat until the proper depth is wet.
- results have been received and the soil has 13. Any proposed substitutions of plant species shall be made with plants of equivalent form, height, branching, habit, leaf color, fruit and environmental culture. All proposed substitutions must be approved by the Landscape Architect.
- See this sheet for percolation testing 14. The Contractor's base bid shall include all materials, labor, permits, equipment, tools, insurance, etc. to perform the work as described in the contract documents.
- the American Association of Nurserymen, 15. The Contractor shall complete work within schedule established by the Owner or Owner's representative.
  - 16. The Contractor shall provide a one (1) year warranty for all plant material starting after the issuance of the certificate of occupancy. See specifications for more information regarding the plant warranty.
  - not meet the requirements stated herein may be rejected by the Owner, Owner's Representative, or Landscape Architect.
- existing underground and aboveground 18. Contractor to provide interim maintenance (watering, pruning, fertilizing, trimming, adequate drainage of ponding areas, edging, weeding, mulching, and general landscape clean-up) until end of warranty.
  - by the Landscape Architect or Owner prior to use. All pesticide applications shall be carried out by a licensed spray technician.
- minimum of three inches (3") of 20. Planting plans are not layout plans. Plants may need to be shifted in the field to accommodate existing conditions. Coordinate with the Landscape Architect before making any changes to the planting
  - auantities are approximate. The Contractor shall verify the amounts needed before purchasing and installing.

# Seeding Notes

- 1. Field verify areas to receive seed and modify order auantity as necessary.
- 2. Site Preparation: Eradicate exotic invasive plant material by having a licensed spray technician apply an approved herbicide. Good pre-seeding weed control may require repeated spraying at least two weeks apart.
- 3. See Civil Engineer's plans for grading. Finer grading and shaping may be necessary to achieve a smoother, more regular surface for receiving seed.
- 4. The Contractor shall ensure that all grades will permit safe and efficient use of equipment during seedbed preparation, seeding, strawing, and maintenance of vegetation.
- 5. Loosely grade the topsoil in order to create a non-compacted growth medium prior to spreading the seed.
- 6. Mulch seeded areas with either straw mulch or use erosion control blankets to all seeded areas after sowing seed. Hydroseed fiber mulch is also an acceptable application method.
- 7. For areas with slope greater than 3:1, final tracking should be perpendicular to the slope to help reduce erosion, keep seeds in place, and to retain consistent soil moisture for seed germination.
- 8. Concentrations of water flows that could cause soil erosion should be diverted to a safe outlet. Diversions and other treatment practices must conform to the appropriate standards and specifications of the Tennessee Erosion and Sediment Control (TDEC) Handbook.
- 9. The Contractor shall comply with TDEC erosion control requirements throughout the establishment of the seeded areas.
- 10. Maintenance: The Contractor shall observe the growth of the seeded species and eliminate invasive exotic vegetation until final acceptance.
- 11. Protect and care for seeded areas, including watering when needed, until final acceptance. This includes repaired areas and any areas receiving supplemental applications of seed.
- 12. Seed all areas as shown on the plans.
- 13. Protect and care for seeded areas, including watering when needed, until final acceptance. This includes repaired areas as well as any area receiving supplemental applications of seed.
- 14. Seed any left over, disturbed areas following construction with turf seed. See table below for turf seed blend.
- 15. Source meadow seed mix as provided below.

**Meadow Seed Source:** Roundstone Native Seed, LLC Address: 99764 Raider Hollow Road, Upton, Ky. 42784 Phone: (888)531.2353

Item Name: **Side Oats Grama** 

Source seed as shown at the website listed under the following URL: https://roundstoneseed.com/native-grasses/97-side-oats-grama.html

# Seed nurse crop in addition to Meadow Seed Mix as follows:

- 1. If cool season (Sept-Nov or Feb-March): Red Clover, Oats, Hairy Vetch, Crimson Clover, Wheat, Austrian Winter Pea, Kale (or other available Brassica)
- 2. If warm season (April-July): Sudangrass, Millet, Buckwheat, Field Peas, Sunflower, Daikon, Red Clover

## Soil Test Notes

- 1. Using a shovel, dia a v-shaped hole to a depth of 6 inches: then cut a thin slice of soil from one side of the hole. Place the slice of soil into a plastic bucket (do not use a metal bucket as this can skew test results). Mix the slices together and fill a plastic sample bag with three (3) cups of soil. The sample bags can be ziploc bags that clearly labeled with the project name and sample number.
- 2. A well-mixed composite from 10 to 20 random locations from the areas to receive plants shall be sub-sampled to make the three (3) cup sample for each bag.
- 3. Mark the landscape plan to show sample locations.
- 4. Send the soil samples to either a private lab or the local extension service.
- 5. The results of the soil test shall be sent to the Landscape Architect for evaluation.

### Soil Percolation Test Notes

- Dig hole 18-24" deep and a minimum of 6" wide.
- 2. Fill hole with water to the top and let it drain for several hours. Ideally, let the hole pre-wet over night and perform the test the following day.
- 3. Refill hole to within a couple of inches of the top.
- 4. To aid in measurement, place a stick across the top of the hole and use a second stick to mark periodic drops in water level; mark side of hole; or mark on side of hole with nail or stick.
- 5. Measure drop in water level after 30 minutes and again at 1 hour. If possible, measure the drop in water level the next day.
- 6. Determine drop in water level per hour. If water level in the hole drops, more than 1 inch per hour, it is well drained and suitable for planting.

### Plant Schedule

Key	Qty.	Botanical Name	Common Name	Size	Notes
SHADE TREE	S				
AS	4	Acer saccharum 'Legacy'	Legacy Sugar Maple	2" Cal.	Well branched; single-trunk; Mature Hgt.: 50'
LT	4	Liriodendron tulipifera	Tulip Poplar	2" Cal.	Well branched; single-trunk; Mature Hgt.: 80'
NS	3	Nyssa sylvatica 'Wildfire'	Black Gum	2" Cal.	Well branched; single-trunk; Mature Hgt.: 50'
QB	7	Quercus bicolor	Swamp White Oak	2" Cal.	Well branched; single-trunk; Mature Hgt.: 60'
QC	2	Quercus coccinea	Scarlet Oak	2" Cal.	Well branched; single-trunk; Mature Hgt.: 70'
UA	1	Ulmus americana 'Valley Forge'	American Elm	2" Cal.	Well branched; single-trunk; Mature Hgt.: 70'
SHRUBS		-			
AR	13	Abelia 'Rose Creek'	Rose Creek Abelia	Min. 18" Hgt.	
CA	7	Callicarpa americana	American Beautyberry		Straight species only
CEA	47	Ceanothus americanus	New Jersey Tea	Min. 18" Hgt.	Straight species only; Alt. species: Abelia 'Rose Creek'
CLA	44	Clethra alnifolia 'Hummingbird'	Hummingbird Sweet Pepperbush		Alt. cultivar: 'Sixteen Candles'
ICC	39	llex cornuta 'Carissa'	Carissa Holly	Min. 18" Hgt.	
IC	41	llex crenata 'Hoogendorn'	Hoogendorn Holly	Min. 18" Hgt.	
IG	32	Ilex glabra 'Shamrock'	Dwarf Inkberry Holly	Min. 18" Hgt.	Alt. cultivar: 'Nigra'
IV	44	llex vomitoria 'Nana'	Dwarf Yaupon Holly	Min. 18" Hgt.	
IVH	21	Itea virginica 'Henry's Garnet'	Henry's Garnet Sweetspire	Min. 18" Hgt.	
РО	12	Physocarpus opulifolius	Ninebark	Min. 18" Hgt.	Straight species or 'Diabolo' or 'Coppertina'
VO	10	Viburnum obovatum 'Mrs. Schiller's Delight'	Dwarf Walter's Viburnum	Min. 18" Hgt.	
PERENNIALS	S/GROUND	COVER			
AH	14	Amsonia hubrichtii	Arkansa Bluestar	1 Gal.	30" o.c. spacing
EP	30	Echinacea purpurea	Purple Coneflower	1 Gal.	Straight species only; 18" o.c. spacing
ES	49	Eragrostis spectabilis	Purple Lovegrass	1 Gal./Quart	Straight species only; 18" o.c. spacing
MF	18	Monarda fistulosa	Wild Bergamot	1 Gal.	30" o.c. spacing; straight species or M. didyma 'Jacob Cline
PS	10	Phlox subulata	Moss Phlox	1 Gal.	24" o.c. spacing
PM	29	Pycnanthemum muticum	Clustered Mountain Mint	1 Gal./Quart	18" o.c. spacing
RA	10	Rhus aromatica 'Gro-Low'	Gro-Low Fragrant Sumac	1 Gal.	Dwarf variety
RU	40	Rudbeckia 'American Gold Rush'	American Gold Rush Black-Eyed Susan	1 Gal.	18" o.c. spacing
SR	13	Solidago rugosa 'Fireworks'	Fireworks Goldenrod	1 Gal.	30" o.c. spacing
SO	22	Symphyotrichum oblongifolium	Aromatic Aster	1 Gal./Quart	Straight species or 'Raydon's Favorite' or 'October Skies' only
URF/SEED					
SOD	2,630	Festuca spp.	Turf Type Tall Fescue	SF	See Sheet L201
TURF SEED	8,840	Festuca blend	Turf Seed Blend	SF	See Sheet L201
	19,145	Bouteloua curtipendula	Side Oats Grama	SF	See Sheet L201; 5 lbs. pure-live-seed (PLS)/acre
MULCH/SO	IL AMEND!	MENTS/ROCK			
RR	465	River Rock		SF	3" depth; see Sheet L200 for more information
	36	Compost		Cu. Yd.	Approx. 2" depth; install compost for planted beds only
	58	Double-Shredded Hardwood Mulch		Cu. Yd.	Approx. 3" depth; dark or natural color

<sup>\*</sup> All proposed plant substitutions must be approved by the Landscape Architect

### Turf Seed Blend Table Percentage in Mix **Botanical Name Common Name** 80% Festuca arundinacea Tall Fescue Creeping Red Fescue 10% Festuca rubra Kentucky Bluegrass 10% Poa pratensis





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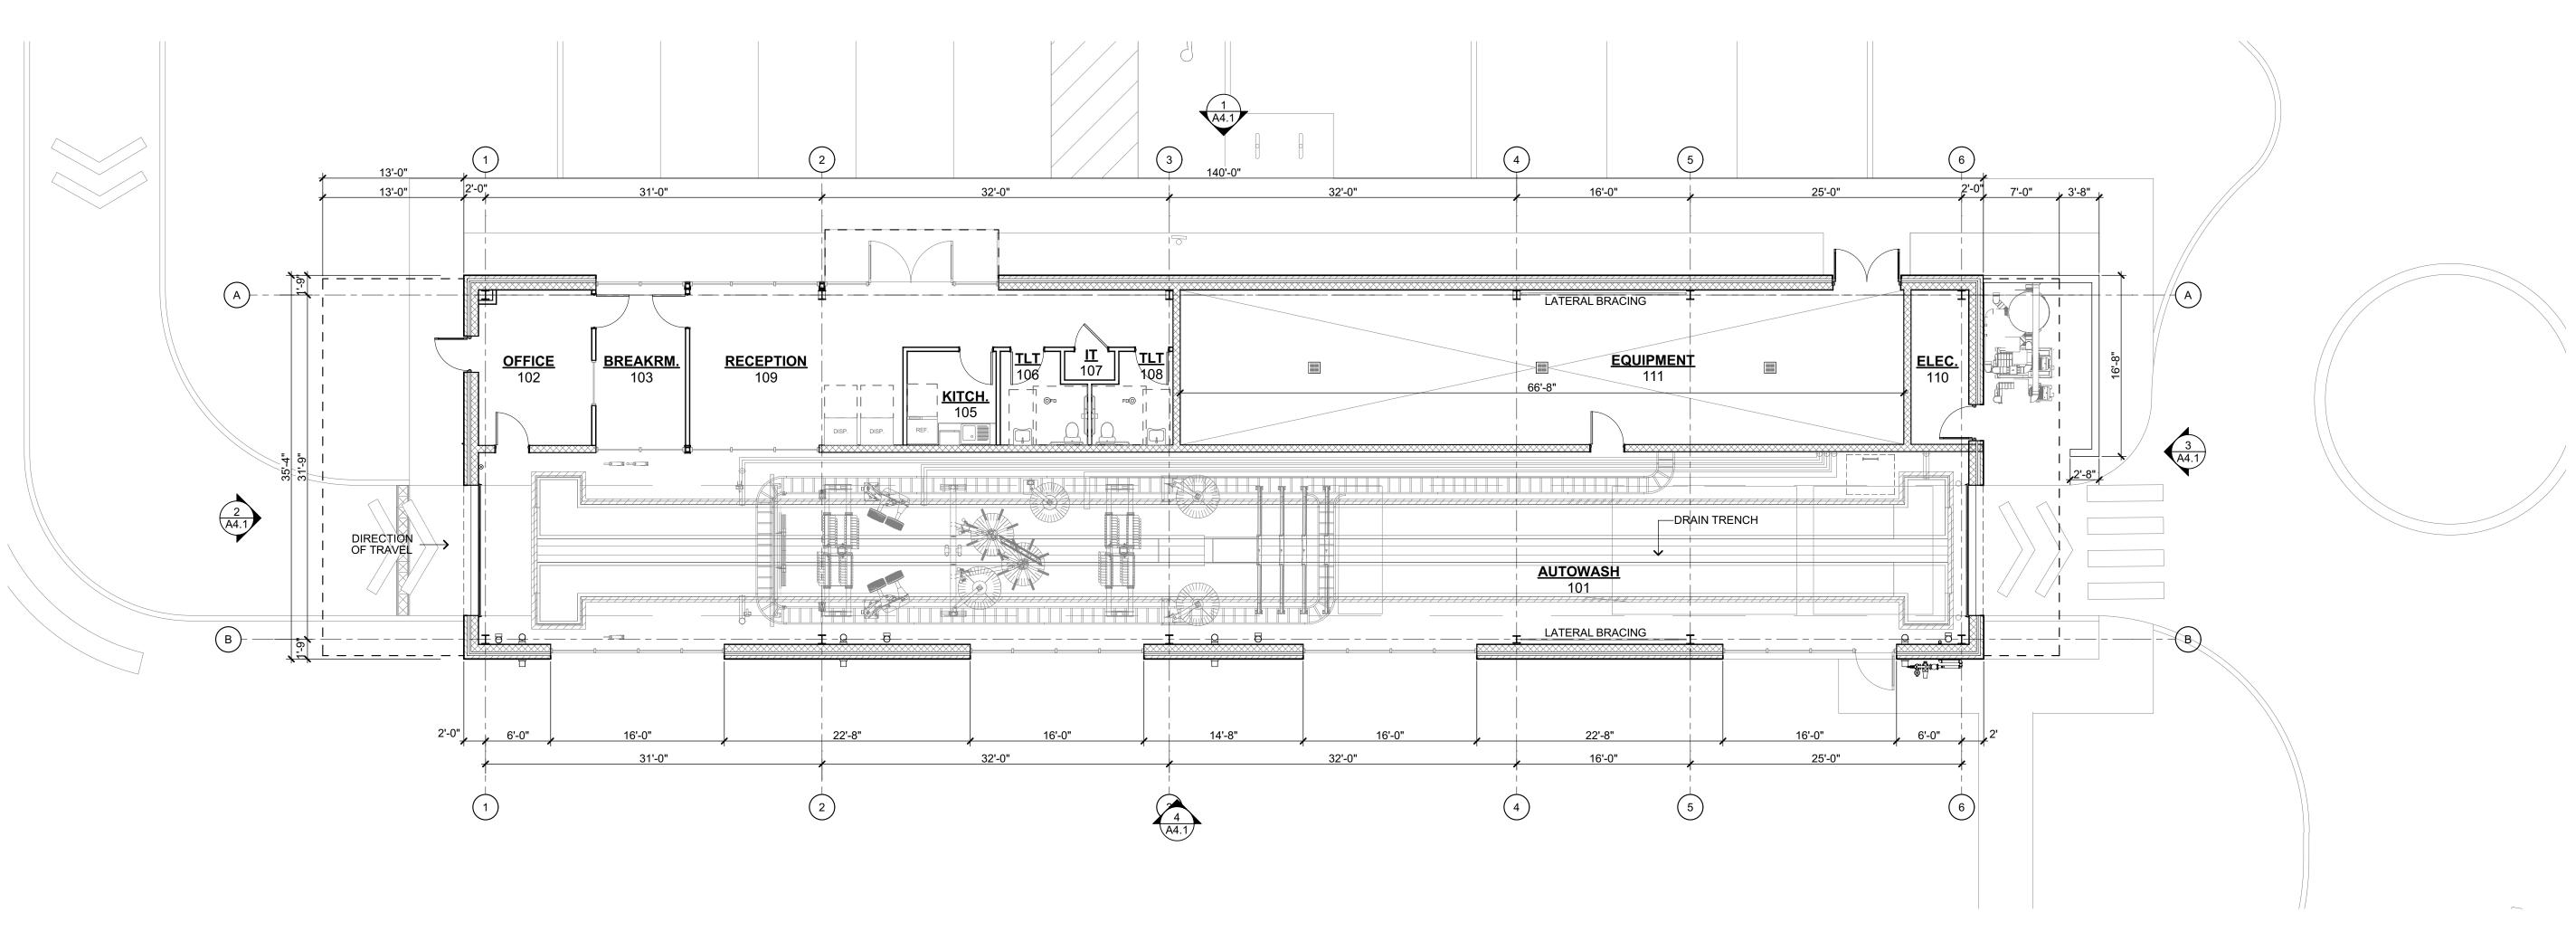
11-22-2024 Revision Revision 1. City Comments 11-22-24


Sheet Name

Landscape Notes & Plant Schedule

Sheet Number

<sup>\*\*</sup> Contractor/Owner shall confirm quantities for mulch, compost, river rock, seed, and sod.



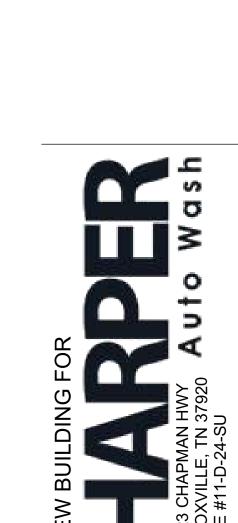

**GEORGE** 

**ARMOUR** 

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**ARCHITECT** 

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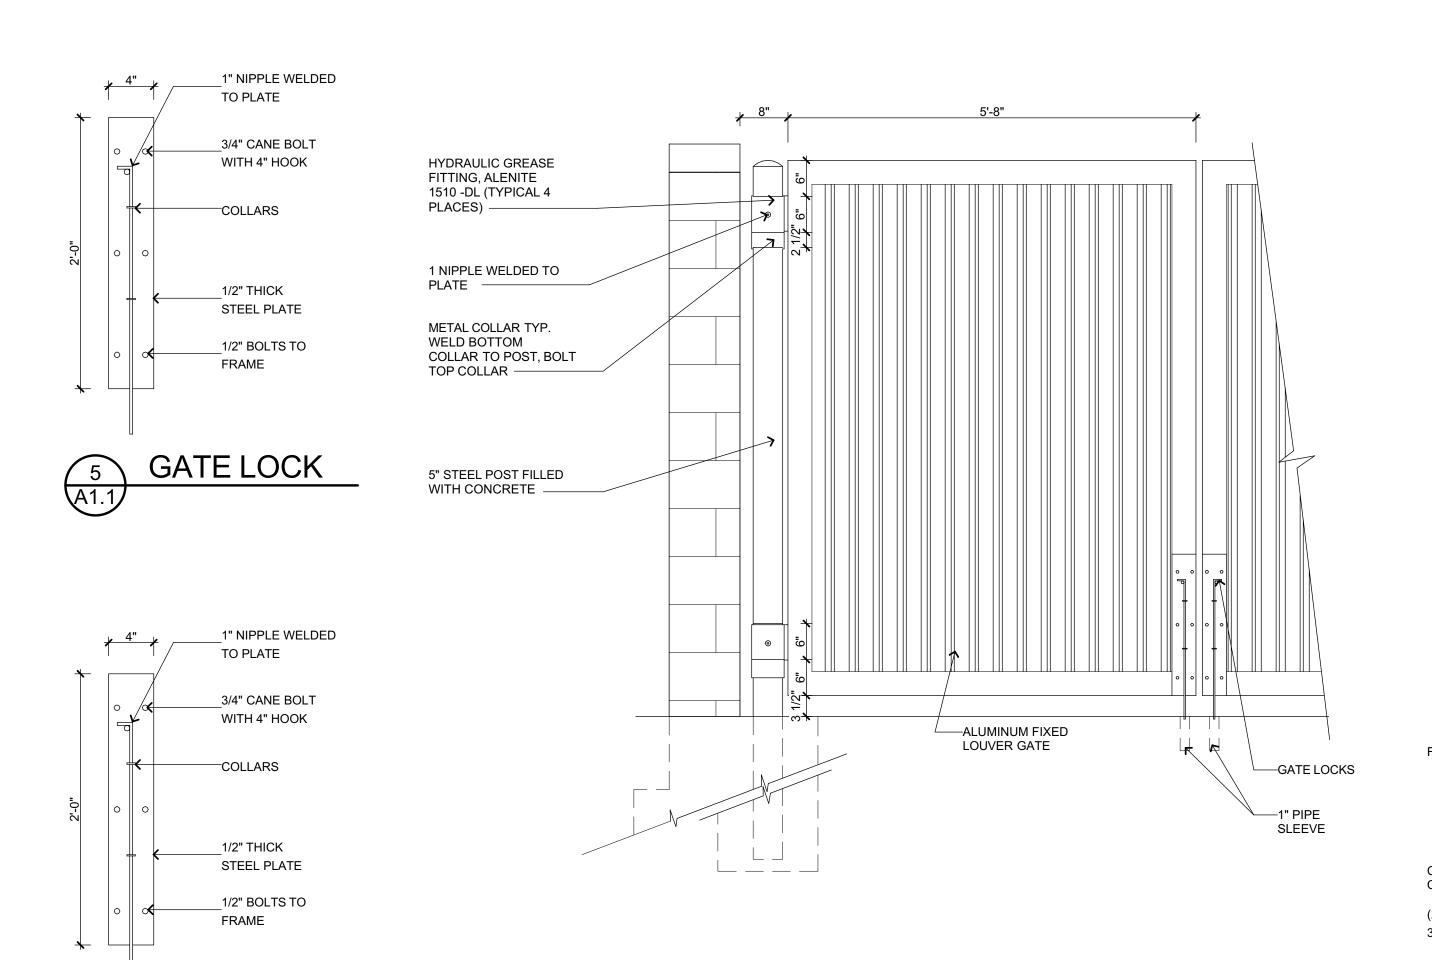


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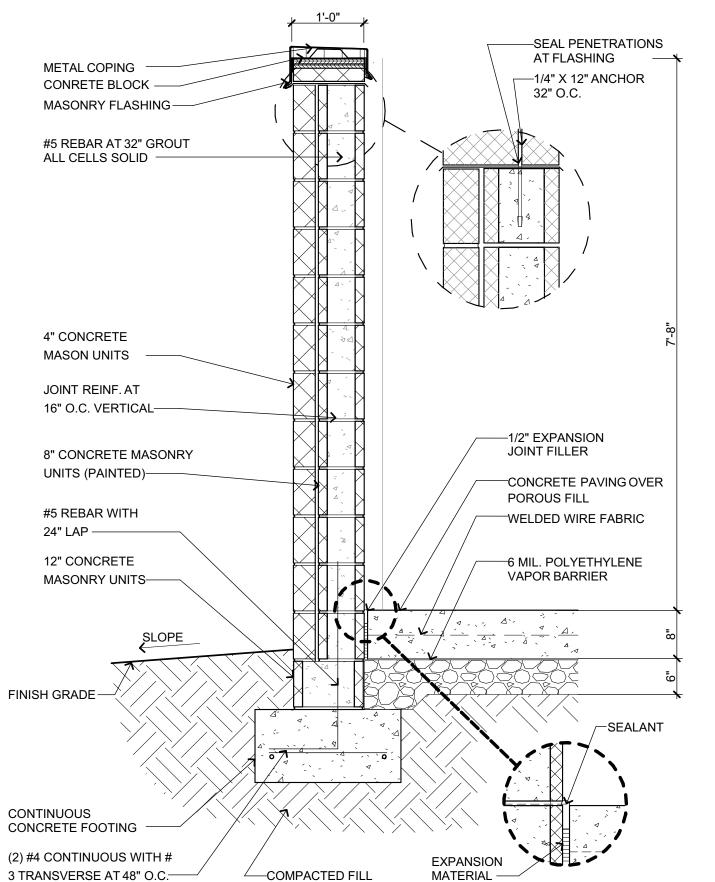
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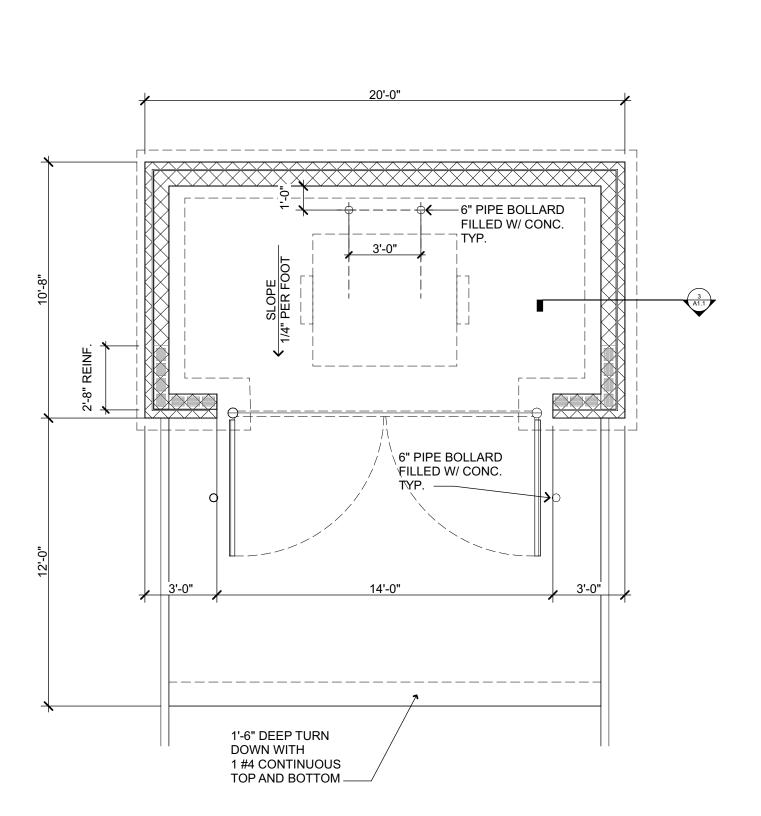
FLOOR PLAN SCALE: 1/8" = 1'-0"


GATE POST



DUMSPTER ELEVATION





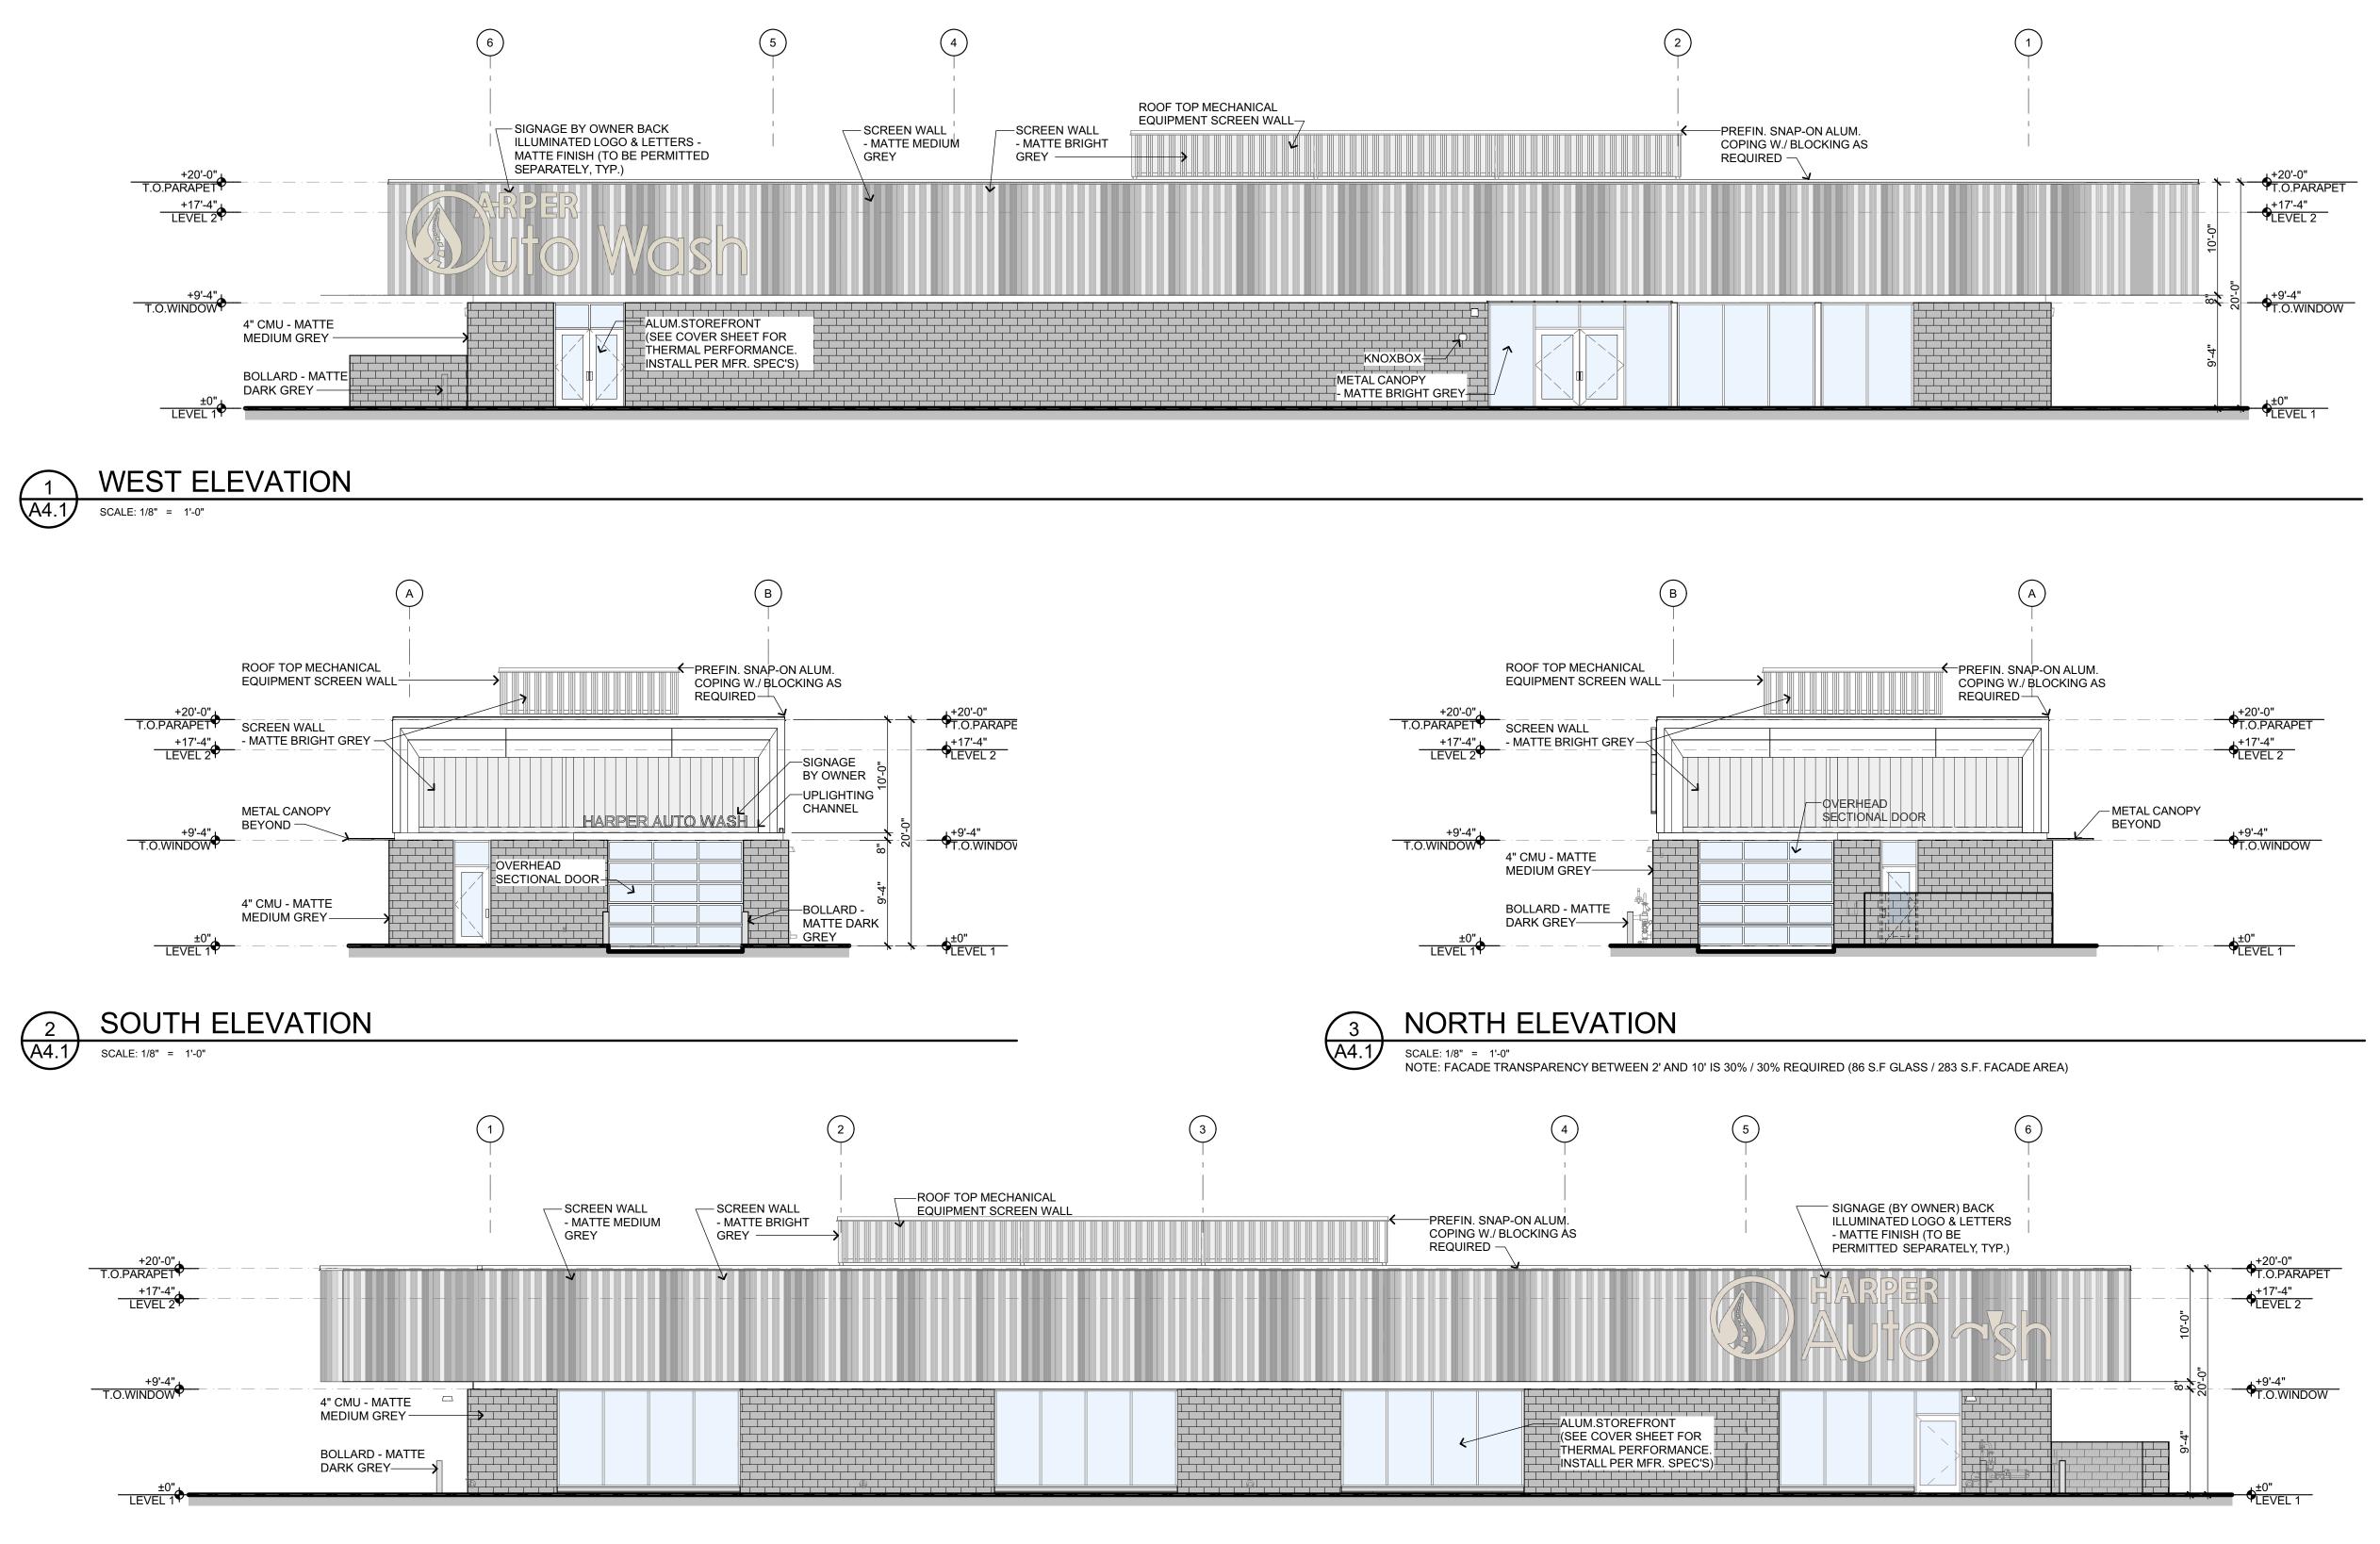

# 4 EAST ELEVATION

NOTE: FACADE TRANSPARENCY BETWEEN 2' AND 10' IS 39% / 30% REQUIRED (432 S.F GLASS / 1,120 S.F. FACADE AREA)