

STATION SOUTH

SITE ADDRESS: ISLAND HOME AVENUE, KNOXVILLE, TENNESSEE 37920 WARD NO. 26, CITY BLOCK NO. 26026 CLT MAP 95, PARCELS 1,2,3

PHILLIPS AVE PHILLIPS AVE ISLAND HOME AVE SITE SOUTHERN RAILWAY SEVER AVE SEVER AV

LOCATION MAP

OWNER:

TAILWATER SOUTH, LLC.

813 SOUTH NORTHSHORE DRIVE, SUITE 104 KNOXVILLE, TN 37919 (865) 588–8663



SITE ENGINEER:

URBAN ENGINEERING, INC.

CHRIS SHARP 11852 KINGSTON PIKE FARRAGUT, TENNESSEE 37934 (865) 966-1924

SPECIFICATIONS

EXCEPT WHERE DIRECTED OTHERWISE BY THE PLANS, WORKMANSHIP
AND MATERIAL (BUT NOT MEASUREMENT AND PAYMENT) FOR THIS
PROJECT SHALL BE IN ACCORDANCE WITH THE FOLLOWING SPECIFICATIONS
AND STANDARDS.

ELECTRICAL — AS DIRECTED BY KUB GAS — AS DIRECTED BY KUB

GAS - AS DIRECTED BY KUB
WATER - AS DIRECTED BY KUB
CABLE TV - AS DIRECTED BY COMCAST

TELEPHONE — AS DIRECTED BY AT&T


CITY OF KNOXVILLE — AS PER CITY OF KNOXVILLE

STANDARDS AND SPECIFICATIONS


SHEET INDEX


<u>TITLE</u>	<u>SHEET</u>
TITLE SHEET	C-1
SITE PLAN	C-2
GRADING PLAN	C-3
PAVER & DRAINAGE PLAN	C-4
TURNING TEMPLATES & LOT LAYOUT	C-5
ARCHITECTURAL RENDERINGS	A-1 THROUGH A-4

MPC FILE# 11-SB-21-C

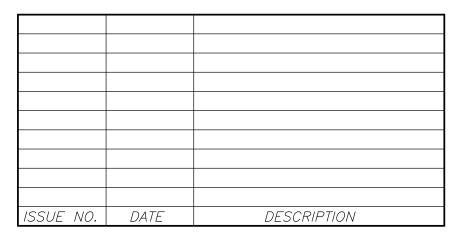


SHEET C-0 - 1 OF 9

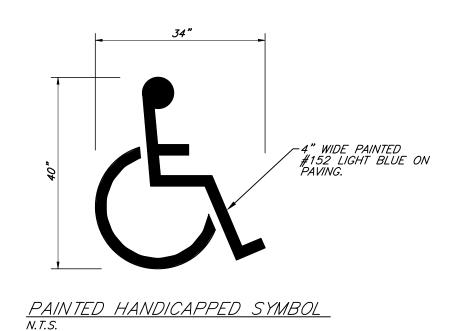

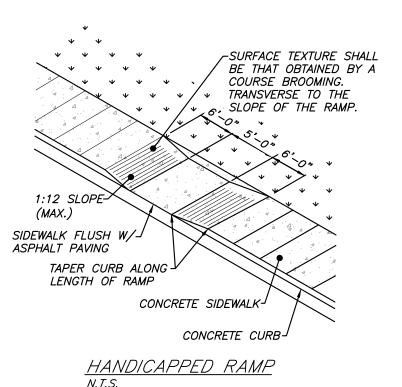


1) REDUCE THE MINIMUM LOT WIDTH FROM 20' TO 18'

SUBDIVISION VARIANCE REQUEST:

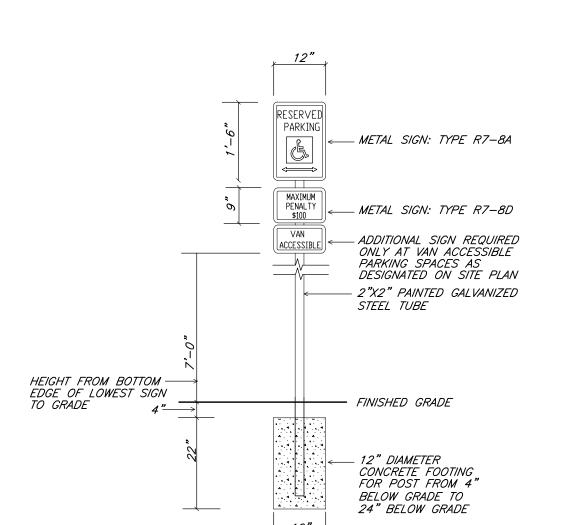

HANDICAPPED SIGN DETAIL N.T.S.

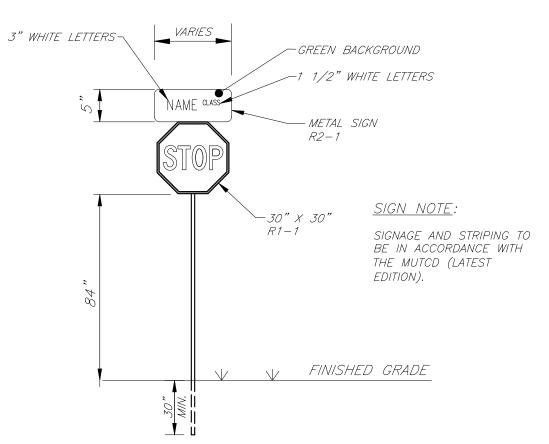


COMBINATION STOP SIGN / STREET NAME SIGN DETAIL


BIKE RACK NOTES:


1) 2-BIKE 'BOLLARD BIKE RACK', AS MANUFACTURED BY THE PARK AND FACILITIES CATALOG, OR APPROVED EQUAL.


2) REFER TO C.O.K. ZONING ORDINANCE (ARTICLE 11.9) FOR BIKE RACK SPECIFICATIONS. INSTALL PER MANUFACTURER'S RECOMMENDATIONS.

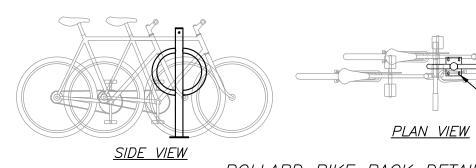



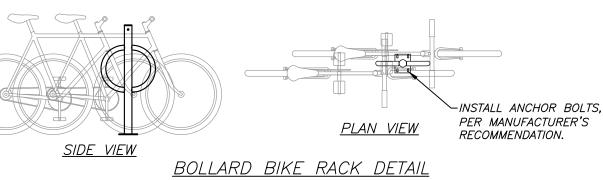

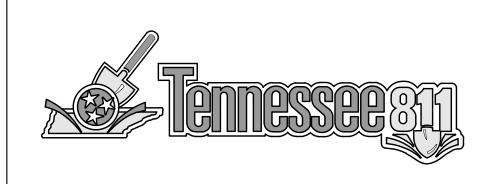

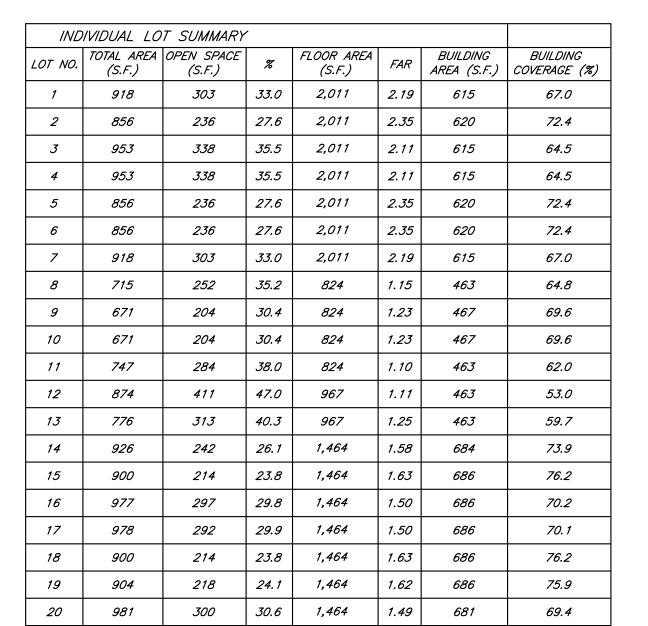

ORMICK E WIDTH PUBLIC

UNABLE TO FIEL PROPOSED 5' CONCRETE

verify upstrean*sidewalk (typ.)*

PROPOSED RIGHT O

EXISTING RIGHT OF WAY (TYP.)

(TYP.)

WAY AT BACK OF

SIDEWALK (TYP.)

LOT SUMMARY (OVERALL)		
TOTAL AREA	0.92-ACRE (40,075 S.F.)	
RIGHT OF WAY DEDICATION	0.09 ACRE (3,705 S.F.)	
TOTAL AREA AFTER DEDICATION	0.83 ACRE (36,370 S.F.)	
TOTAL FEE SIMPLE LOTS AREA	0.40 ACRE (17,330 S.F.)	
PRIVATE RIGHT OF WAY AREA	0.28 ACRE (12,195 S.F.)	
OPEN SPACE*	0.44 ACRE (19,040 S.F.)-52.4%	

YPROPOSED BIKE PARKING.

SEE DETAIL, THIS SHEET

PROPOSED EDGE RESTRAINT-

(TYP.). SEE DETAIL, SHEET

ISLAND HOME AVENUE

PROPOSED RIGHT OF-

WAY AT BACK OF

SIDEWALK (TYP.)

T(TYP.)

EXISTING RIGHT-

OF WAY (TYP.)

PROPOSED CONCRETE SIDEWALK (TYP.)

PARKING

└20'x11.3' PAD 6"-4000psi

CONCRETE OVER 6" STONE.

CENTERLINE OF RAILROAD TRACKS

STALLS (TYP.)

PROPOSED 8'(D) X-

9'(W) CONCRETE

DRIVEWAY (TYP.)


*OPEN SPACE AREA SHOWN IS THE AREA OUTSIDE OF THE PROPOSED LOTS.

PROPOSED DUMPSTER PAD-

& ENCLOSURE. SPECS BY

OTHERS.

SITE SUMMARY		
CURRENT USE	VACANT	
PROPOSED USE	RESIDENTIAL	
ZONING	SW-4	
TOTAL AREA	0.92-ACRE	
RIGHT OF WAY DEDICATION	0.09 ACRE	
TOTAL AREA AFTER DEDICATION	O.83 ACRE	
BUILDING COVERAGE	11,901 S.F.	
PERMEABLE PAVER AREA	10,650 S.F.	
TOTAL FLOOR AREA	29,555 S.F.	
FLOOR AREA RATIO	0.82	
FLATWORK / CONCRETE	4,633 S.F.	
GRASS AREA	8,946 S.F.	
TOTAL IMPERVIOUS AREA	16,534 S.F.	
PERCENT IMPERVIOUS	45.7%	
TOTAL NUMBER OF LOTS	20	
TOTAL BIKE PARKING SPOTS	7	

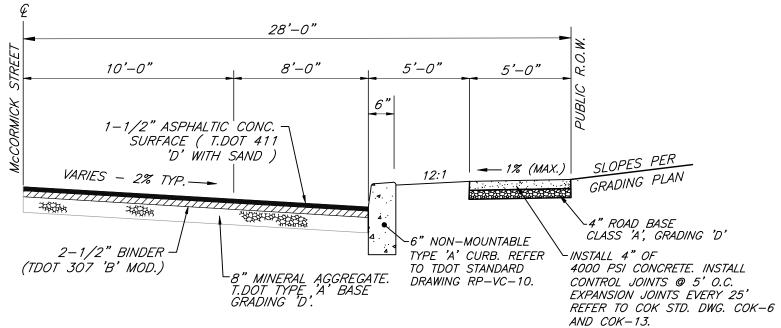

TYPICAL SECTION - McCORMICK STREET

*SEE NOTE

EXTÊND SIDEWALK

PROPOSED HANDICAPPED

SIGN (TYP.). SEE DETAIL,

THIS SHEET.

PAVERS (SEE SHEET

C-4 FOR DETAILS)

LINE (TYP.)

EXISTING PROPERTY-

LINE (TYP.)

THROUGH DRIVEWAY-

2.8' OVER

0.5' OVER-

PER TDOT STANDARD

0.9' OVER

*SEE NOTE

DOG PARK AREA

Γ3'R // 15'R

~PROPOSED CROSS

∽PROPOSED HANDICAPPED

RAMP. SEE DETAIL, THIS

ACCESS EASEMENT

-PROPOSED STOP/STREET SIGN

(TYP.). SEE DETAIL, THIS SHEET.

-PROPOSED POST CURB (TYP.).

SR SR 20

-ADJACENT STRUCTURE

OVERHANG (TYP.)

PROPOSED GRASS

 $\frac{1}{2}$ "IP(F)

PROPOSED VINYL COATED

CHAIN LINK FENCE (BLACK).

AREA (TYP.)

-A:15.73'

R:1020.00'


B:S85°03'21"W

CH:15.73

SEE DETAIL, SHEET C-4.

_EXISTING PROPERTY LINE (TYP.)

DWG. RP-D-15

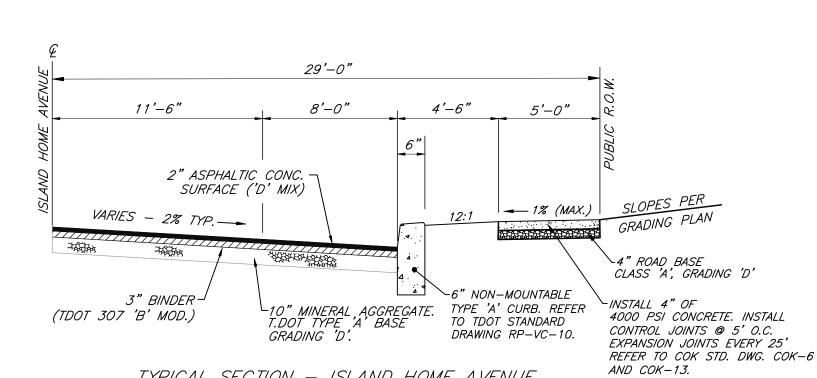


DATE

REVISION

TYPICAL SECTION - ISLAND HOME AVENUE N.T.S.

DESCRIPTION

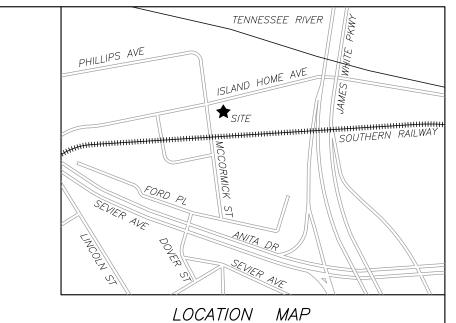

N.T.S.

SITE PLAN NOTES:

1) THE LOCATIONS OF ALL UNDERGROUND UTILITIES SHOWN HEREON ARE APPROXIMATE AND ARE BASED ON FIELD LOCATION OF VISIBLE STRUCTURES SUCH AS CATCH BASINS, MANHOLES, WATER VALVES, ETC., AND COMPILING INFORMATION FROM PLANS SUPPLIED BY VARIOUS UTILITY COMPANIES AND GOVERNMENT AGENCIES. THE CONTRACTORS SHALL NOTIFY IN WRITING ALL UTILITY COMPANIES AND GOVERNMENT AGENCIES AND ALSO CALL TENN ONE-CALL PRIOR TO ANY EXCAVATION WORK, TO VERIFY INFORMATION SHOWN AND DETERMINE THE LAYOUT OF THE IRRIGATION SYSTEM AND IF ADDITIONAL IMPROVEMENTS MAY EXIST.

2) SIGNAGE AND STRIPING TO BE IN ACCORDANCE WITH THE MUTCD (LATEST EDITION).

3) SETBACKS ARE PER CITY OF KNOXVILLE SW-4 ZONING AND ARE ÁS FOLLOWS:

FRONT (MAX) - 10'

FRONTAGE AT SETBACK (MIN.) - 50%

REAR (MIN.) - 3'

SIDE (MAX) - 25'

4) BOUNDARY INFORMATION PER SURVEY PREPARED BY MATTHEW DAWSON RLS NO. 3050, DATED AUGUST 30, 2019.

5) ALL CONCRETE WALKS SHALL BE BROOM FINISHED AND COMPLY WITH CURRENT ADA REQUIREMENTS.

6) IT IS THE RESPONSIBILITY OF THE DEVELOPER TO ATTAIN PERMISSION FOR OFFSITE WORK.

7) ANY NON ADA COMPLIANT RAMPS OR DAMAGED SIDEWALKS WILL BE REPLACED WITH COMPLIANT SIDEWALKS AS SHOWN. ALL NEW WALKS SHALL BE ADA COMPLIANT.

8) NO LANDSCAPING SHALL BE INSTALLED WITHIN PUBLIC RIGHT OF WAY UNTIL A PERMISSIVE USE AGREEMENT HAS BEEN DRAFTED AND APPROVED BY THE CITY OF KNOXVILLE. ALL LANDSCAPING SHALL COMPLY WITH ALL ASPECTS OF THE KNOXVILLE TREE PROTECTION ORDINANCE.

9) ALL PROPOSED SIDEWALKS WITHIN THE R.O.W. SHALL COMPLY WITH THE CITY OF KNOXVILLE'S SPECIFICATIONS. ALL WALKS ON PRIVATE PROPERTY SHALL BE PER PROJECT SPECIFICATIONS.

10) ALL ASPHALT DAMAGED WITHIN PUBLIC R.O.W. SHALL BE REPAIRED PER THE CITY'S SPECIFICATIONS.

11) A PLAT WILL BE RECORDED DURING THE PERMITTING PROCESS TO MOVE PROPERTY LINES AND TO DEDICATE THE PEDESTRIAN ACCESS

12) PARKING SUMMARY: RESERVED AND SHARED

EASEMENT SHOWN HEREON.

MAXIMUM OF 3 PARKING SPACES PER 1,000 SQUARE FEET AND MAXIMUM OF 2 PARKING SPACES PER RESIDENTIAL UNIT.

TOTAL UNITS = 20 TOTAL BUILDING AREA = 24,140 S.F.

REQUIRED BICYCLE PARKING SPACES = 3 TOTAL VEHICULAR SPACES PROVIDED (ONSITE) = 25 (INCLUDING

TOTAL VEHICULAR SPACES PROVIDED (STREET PARKING) = 11 13) LANDSCAPING SHALL COMPLY WITH THE CITY OF KNOXVILLE'S

TREE PROTECTION ORDINANCE.

14) REFER TO C.O.K. ZONING ORDINANCE (ARTICLE 11.9) FOR BIKE RACK SPECIFICATIONS. INSTALL PER MANUFACTURER'S RECOMMENDATIONS.

APPROVED VARIANCES:

THE FOLLOWING CASE NUMBERS WERE APPROVED AT THE MAY 18, 2021 CITY OF KNOXVILLE BZA MEETING:

BZ05K21VA, BZ05L21VA, BZ05M21VA, BZ05N21VA, BZ05021VA, BZ05P21VA, BZ05Q21VA, BZ05R21VA, BZ05S21VA

REDUCE THE MINIMUM REQUIRED PERCENTAGE OF TRANSPARENT GLASS AT THE GROUND LEVEL ON A PRINCIPAL FRONTAGE FROM 70% TO 31.8%.

<u>DESCRIPTION</u>:

BZ05U21VA, BZ05V21VA, BZ05W21VA

REDUCE THE MINIMUM REQUIRED PERCENTAGE OF TRANSPARENT GLASS AT THE GROUND LEVEL ON A PRINCIPAL FRONTAGE FROM 70% TO 22.8%.

MPC FILE# 11-SB-21-C

SHEET C-2

SITE PLAN

STATION SOUTH

SITE ADDRESS: ISLAND HOME AVENUE, KNOXVILLE, TN 37920 KNOX CO., TN. CITY OF KNOXVILLE

WARD NO. 26 CITY BLOCK NO. 26062

CLT MAP 95 INSERT O GROUP D PARCELS 1,2,3 AUGUST 19, 2021 SCALE: 1"=20"

OWNER/DEVELOPER

TAILWATER SOUTH, LLC. 813 SOUTH NORTHSHORE DRIVE, SUITE 104 KNOXVILLE, TN 37919 (865) 588-8663



DWN: CLM

11852 KINGSTON PIKE (865) 966-1924

DWG. NO. 2102003





1. THE LOCATIONS OF ALL UNDERGROUND UTILITIES SHOWN HEREON ARE APPROXIMATE AND ARE BASED ON FIELD LOCATION OF VISIBLE STRUCTURES SUCH AS CATCH BASINS, MANHOLES, WATER VALVES, ETC., AND COMPILING INFORMATION FROM PLANS SUPPLIED BY VARIOUS UTILITY COMPANIES AND GOVERNMENT AGENCIES. THE CONTRACTORS SHALL NOTIFY IN WRITING ALL UTILITY COMPANIES AND GOVERNMENT AGENCIES AND ALSO CALL TENN
ONE—CALL PRIOR TO ANY EXCAVATION WORK, TO VERIFY INFORMATION
SHOWN AND DETERMINE THE MAY EXCEPT.

TENNESSEE RIVER

LOCATION MAP N.T.S.

2. ALL WORK SHALL BE IN ACCORDANCE WITH THE CITY OF KNOXVILLE'S SPECIFICATIONS FOR SITE DEVELOPMENT.

3. ALL WORK SHALL BE SEQUENCED AND COMPLETED IN ACCORDANCE WITH RELATED PERMITS ISSUED BY THE CITY OF KNOXVILLE.

4. CLEAR AND GRUB PER SPECS. REMOVE TREES, BRUSH, DEBRIS, AND STUMPS FROM THE WORK AREA. REMOVE ALL BUILDINGS, DRIVES, CROSS FENCES, AND MISCELLANEOUS EQUIPMENT.

5. STRIP AND STOCKPILE TOPSOIL NEEDED FOR RESPREADING AND SEEDING. SURROUND TOPSOIL PILE WITH SILT FENCE, STRAW BALES, TEMPORARY SEEDING OR ADDITIONAL MEASURES AS NEEDED TO PREVENT

6. AFTER STRIPPING AND REMOVAL, PROOF ROLL ENTIRE DISTURBED AREA WITH TANDEM TRUCK FULLY LOADED WITH EARTH. REMOVE ANY AREAS WHICH ARE SOFT OR YIELDING UNDER LOAD AND REPLACE WITH NEW MATERIAL

7. IF UNSUITABLE SUBGRADE MATERIALS ARE ENCOUNTERED, THE CONTRACTOR IS RESPONSIBLE FOR REMOVAL AND REPLACEMENT WITH APPROVED MATERIAL FROM ONSITE OR APPROVED OFFSITE BORROW AREA. UNSUITABLE MATERIALS ARE THOSE CLASSIFIED AS MH, CH, OH, OL, AND PEAT IN ACCORDANCE WITH THE UNIFIED SOIL CLASSIFICATION SYSTEM.

8. COMPACTION REQUIREMENTS ARE SUMMARIZED AS FOLLOWS: (PLACE IN 8" LIFTS)

a. TOP 24 INCHES OF SUBGRADE UNDER PAVED AREAS 100 PERCENT STANDARD PROCTOR - LOWER THAN 24 INCHES BELOW PAVED AREA 95 PERCENT STANDARD PROCTOR. b. AREAS WITHIN THE BUILDING ENVELOPE TO BE PREPARED

IN ACCORDANCE WITH RECOMMENDATIONS IN REPORT OF GEOTECHNICAL INVESTIGATION AND/OR AS DIRECTED BY THE SOILS ENGINEER. 9. ALL FINISHED YARD AREAS SHALL HAVE A MINIMUM 4 INCHES OF TOPSOIL.

TOPSIL. ALL FINISHED YARD SURFACES SHALL BE SMOOTHLY AND UNIFORMLY GRADED, FREE FROM IRREGULARITIES AND SHALL BE FULLY FUNCTIONAL TO PROVIDE POSITIVE DRAINAGE AT ALL LOCATIONS. 10. THE TOTAL AREA DISTURBED AS PART OF THIS PROJECT (0.9± ACRES).

YARD FINISHED GRADES SHOWN ARE AFTER PLACEMENT OF 4 INCHES OF

11 PROPOSED SPOT FLEVATIONS AND PROPOSED CONTOURS ARE AFTER THE INSTALLATION OF TOPSOIL IN GRASSED AREAS, PAVING WITHIN DRIVES AND

12. A FINAL PLAT SHALL BE RECORDED TO CREATE STORM WATER DETENTION AND WATER QUALITY EASEMENTS.

13. IT IS THE RESPONSIBILITY OF THE OWNER TO ATTAIN PERMISSION FROM THE NEIGHBOR TO WORK ON HIS OR HER PROPERTY.

14. THE VERTICAL DATUM IS NAVD88. THE BASIS FOR HORIZONTAL INFORMATION IS NAD83.

15. TOP AND BOTTOM OF WALL ELEVATIONS ARE AT EXISTING AND FINISHED GRADES AND EXCLUDE BURIED BLOCK OR CAP BLOCKS.

SHEET C-3

GRADING PLAN

STATION SOUTH

SITE ADDRESS: ISLAND HOME AVENUE, KNOXVILLE, TN 37920

CITY OF KNOXVILLE WARD NO. 26

CITY BLOCK NO. 26062 CLT MAP 95 INSERT O GROUP D PARCELS 1,2,3

KNOX CO., TN.

AUGUST 19, 2021

SCALE: 1"=20'

OWNER/DEVELOPER: TAILWATER SOUTH, LLC. 813 SOUTH NORTHSHORE DRIVE, SUITE 104 KNOXVILLE, TN 37919 (865) 588-8663



DWN: CLM

URBAN ENGINEERING, INC. 11852 KINGSTON PIKE FARRAGUT, TENNESSEE 37922 (865) 966-1924 DWG. NO. 2102003



_EXISTING PROPERTY

-A:15.73

R:1020.00' B:S85°03'21"W CH:15.73

LINE (TYP.)

REVISION DATE DESCRIPTION

MPC FILE# 11-SB-21-C

FFE=833.75

PROPOSED LOT

FFE=833.75

PROPOSED RETAINING WALL

FFE=833.75

*SEE NOTE 7

ISLAND HOME AVENUE

FFE=833.65

PROPOSED STORM—) SEWER (TYP.)

FFE=833.65

PROPOSED RIGHT OF-

-WAY AT BACK OF

SIDEWALK (TYP.)

FFE=833.65

EXISTING RIGHT-OF WAY (TYP.)

FFE=833.65

FFE=833.65

FFE=833.75

FFE=834.40

FFE=835.70

FFE=836.40

1/2"IP(SPROPOSED RETAINING WALL)

PROPOSED RIGHT OF

EXISTING RIGHT

OF WAY (TYP.)

SIDEWALK (TYP.)

−835− −

- 837

WAY AT BACK OF SIDEWALK (TYP.)

R.O.T

VERIFY UPSTREAM ENDPROPOSED CONCRETE-

UNABLE TO FIELD

PROPOSED CONCRETE SIDEWALK (TYP.)

833.20

 $_{\it C}$ PAVERS (SEE SHEET $^{\it J}$

C-4 FOR DETAILS)

832.80

S85°28'23"W 234.77' EXISTING PROPERTY LINE (TYP.)

FFE=835.10

2.8' OVER

2.2' OVER

FFE=833.65

FFE=833.65

FFE=833.65

832.75

FFE=833.75

FFE=833.75

FFE=833.65

PROPOSED SPOT


ELEVATION (TYP.)


FFE=833.75

BUILDING 0.5' OVER-

FENCE



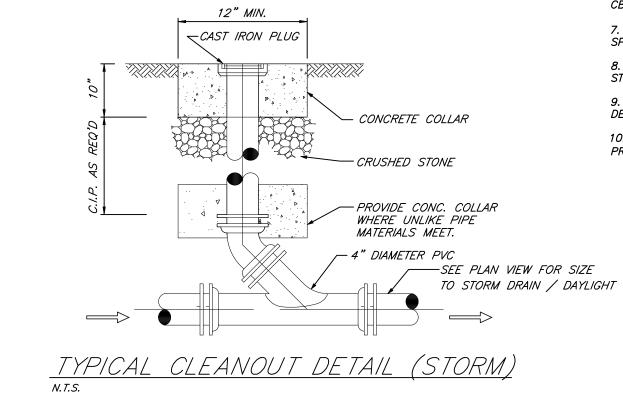

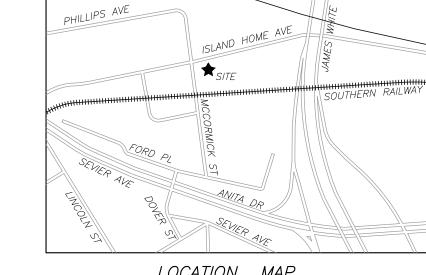

TENNESSEE RIVER

LOCATION MAP N.T.S.

PERMEABLE PAVER NOTES:

1) THE LOCATIONS OF ALL UNDERGROUND UTILITIES SHOWN HEREON ARE APPROXIMATE AND ARE BASED ON FIELD LOCATION OF VISIBLE STRUCTURES SUCH AS CATCH BASINS, MANHOLES, WATER VALVES, ETC., AND COMPILING INFORMATION FROM PLANS SUPPLIED BY VARIOUS UTILITY COMPANIES AND GOVERNMENT AGENCIES. THE CONTRACTORS SHALL NOTIFY IN WRITING ALL UTILITY COMPANIES AND GOVERNMENT AGENCIES AND ALSO CALL TENN ONE-CALL PRIOR TO ANY EXCAVATION WORK, TO VERIFY INFORMATION SHOWN AND DETERMINE THE LAYOUT OF THE IRRIGATION SYSTEM AND IF ADDITIONAL IMPROVEMENTS MAY EXIST.

2) PERMEABLE PAVERS SHALL BE AQUABRIK OR EQUIVALENT AND SHALL BE INSTALLED PER MANUFACTURER'S RECOMMENDATIONS.

3) PVC AGGREGATE DRAINS SHALL BE 6" PERFORATED HDPE (SDR 17) ÚNLESS OTHERWISE NOTED.

4) INSTALL POST CURB / EDGE RESTRAINT FULL DEPTH (TO SUBGRADE). 5) ALL PIPING UNDER OR WITHIN 3' OF PROPOSED ASPHALT OR CONCRETE SHALL BE BACKFILLED WITH STONE.

6) PAVERS SHALL BE LIGHT COLORED/HIGH ALBEDO PAVER WITH A SOLAR REFLECTANCE OF AT LEAST 30%.

DRAINAGE NOTES:

1. CORRUGATED POLYETHYLENE PIPE (HDPE) SHALL BE AASHTO M-252/M-294 TYPE S WITH SOIL-TIGHT JOINTS WITH RUBBER GASKET CONFORMING TO ASTM F477 (HANCOR HI-Q OR ADS N-12 ARE ACCEPTABLE PRODUCTS). REFER TO TDOT STANDARD DWG D-PB-2 FOR ADDITIONAL INSTALLATION REQUIREMENTS.

2. ALL CONCRETE PIPE SHALL BE CLASS III.

3. ALL WORK SHALL BE SEQUENCED AND COMPLETED IN ACCORDANCE WITH THE TENNESSEE DEPARTMENT OF ENVIRONMENT AND CONSERVATION EROSION CONTROL HANDBOOK AND THE RULES AND REGULATIONS OF THE CITY OF

4. ALL PIPING UNDER OR WITHIN 3' OF ASPHALT DRIVES SHALL BE BACKFILLED WITH STONE.

5. ALL CATCH BASINS, AREA DRAIN GRATES AND MANHOLE COVERS REQUIRE PERMANENTLY CAST ENVIRONMENTAL MESSAGE, I.E. "NO DUMPING, DRAINS TO


6. CASTINGS FOR THE PROPOSED STRUCTURES ARE AS FOLLOWS: STRUCTURE MH1: V-1045 FRAME, 1040 COVER

STRUCTURE OS1: WELDED BAR GRATE CB1-CB11: V-4074-2

7. ALL MATERIALS AND INSTALLATION METHODS SHALL BE PER TDOT'S SPECIFICATIONS FOR ROAD AND BRIDGE CONSTRUCTION, CURRENT EDITION. 8. POURED CONCRETE INVERTS SHALL BE INSTALLED IN ALL DRAINAGE STRUCTURES.

9. SEE SHEET C-XX FOR PRECAST CONCRETE CATCH BASIN AND GRATE DETAILS.

10. CONNECT DOWNSPOUTS FROM THE REARS OF LOTS 6 AND 15 TO PROPOSED 4" HDPE.

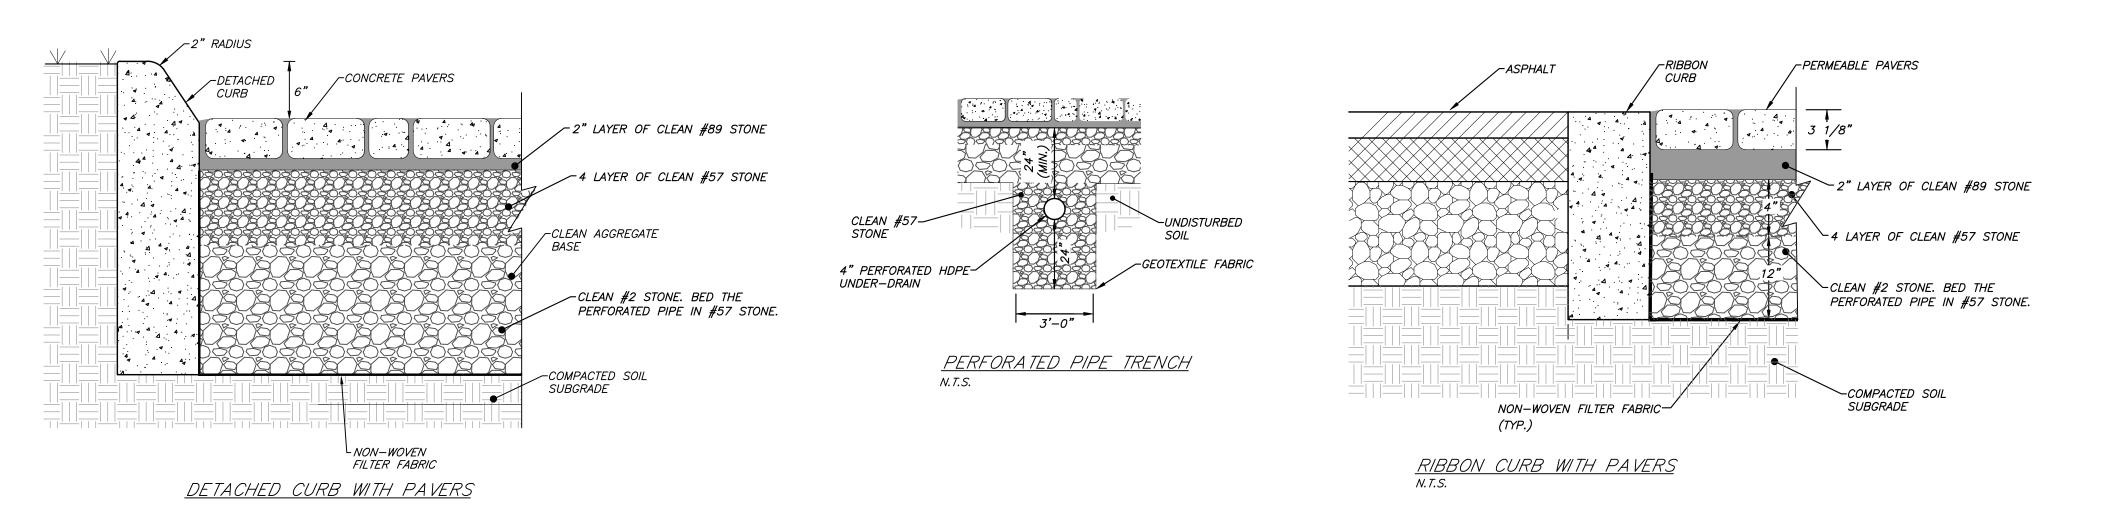

MPC FILE# 11-SB-21-C

REVISION DATE DESCRIPTION

TAILWATER SOUTH, LLC. 813 SOUTH NORTHSHORE DRIVE, SUITE 104 KNOXVILLE, TN 37919 (865) 588-8663

SHEET C-4

PAVER & DRAINAGE PLAN

STATION SOUTH

SITE ADDRESS: ISLAND HOME AVENUE, KNOXVILLE, TN 37920

CLT MAP 95 INSERT O GROUP D PARCELS 1,2,3



CITY OF KNOXVILLE

WARD NO. 26

SCALE: 1"=20'

OWNER/DEVELOPER:

DWN: CLM

URBAN ENGINEERING, INC. 11852 KINGSTON PIKE FARRAGUT, TENNESSEE 37922 (865) 966-1924

KNOX CO., TN.

AUGUST 19, 2021

DWG. NO. 2102003

CITY BLOCK NO. 26062



