


- NTS

SHEET 2 OF 2

Drawn by: REL,jr


DRAWING NO .:

6215

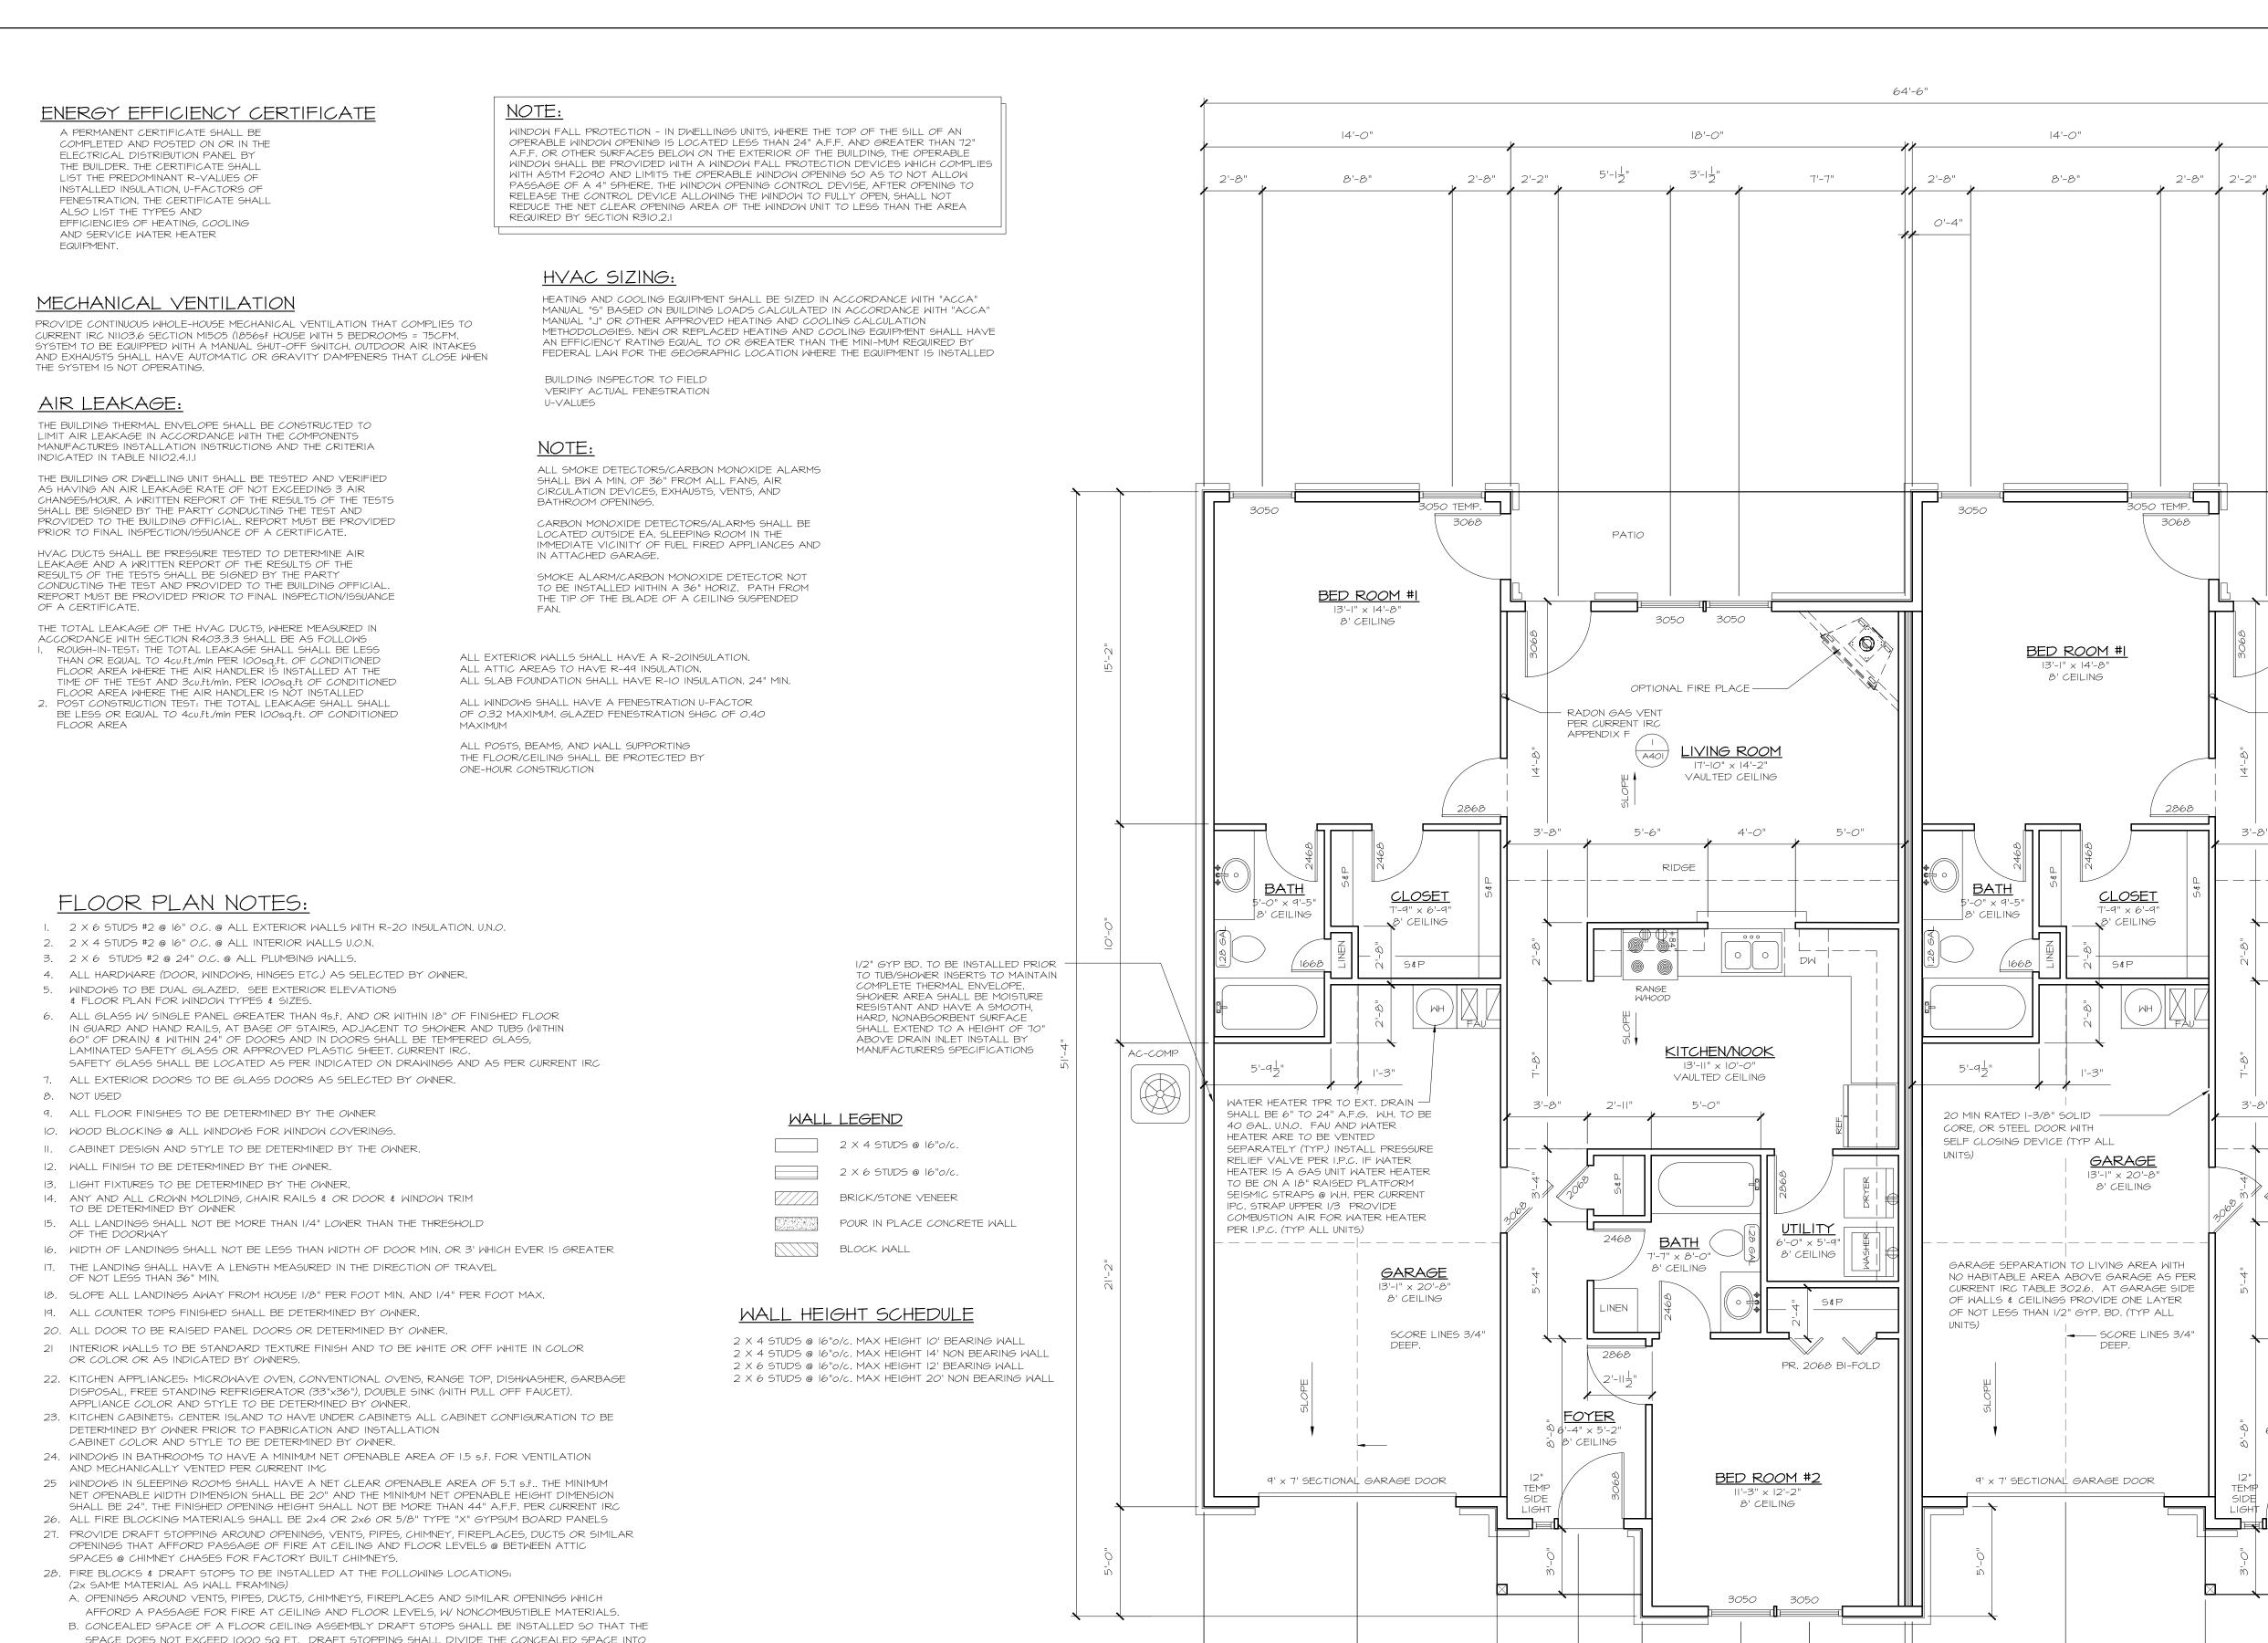

7'-0"

FLOOR PLAN

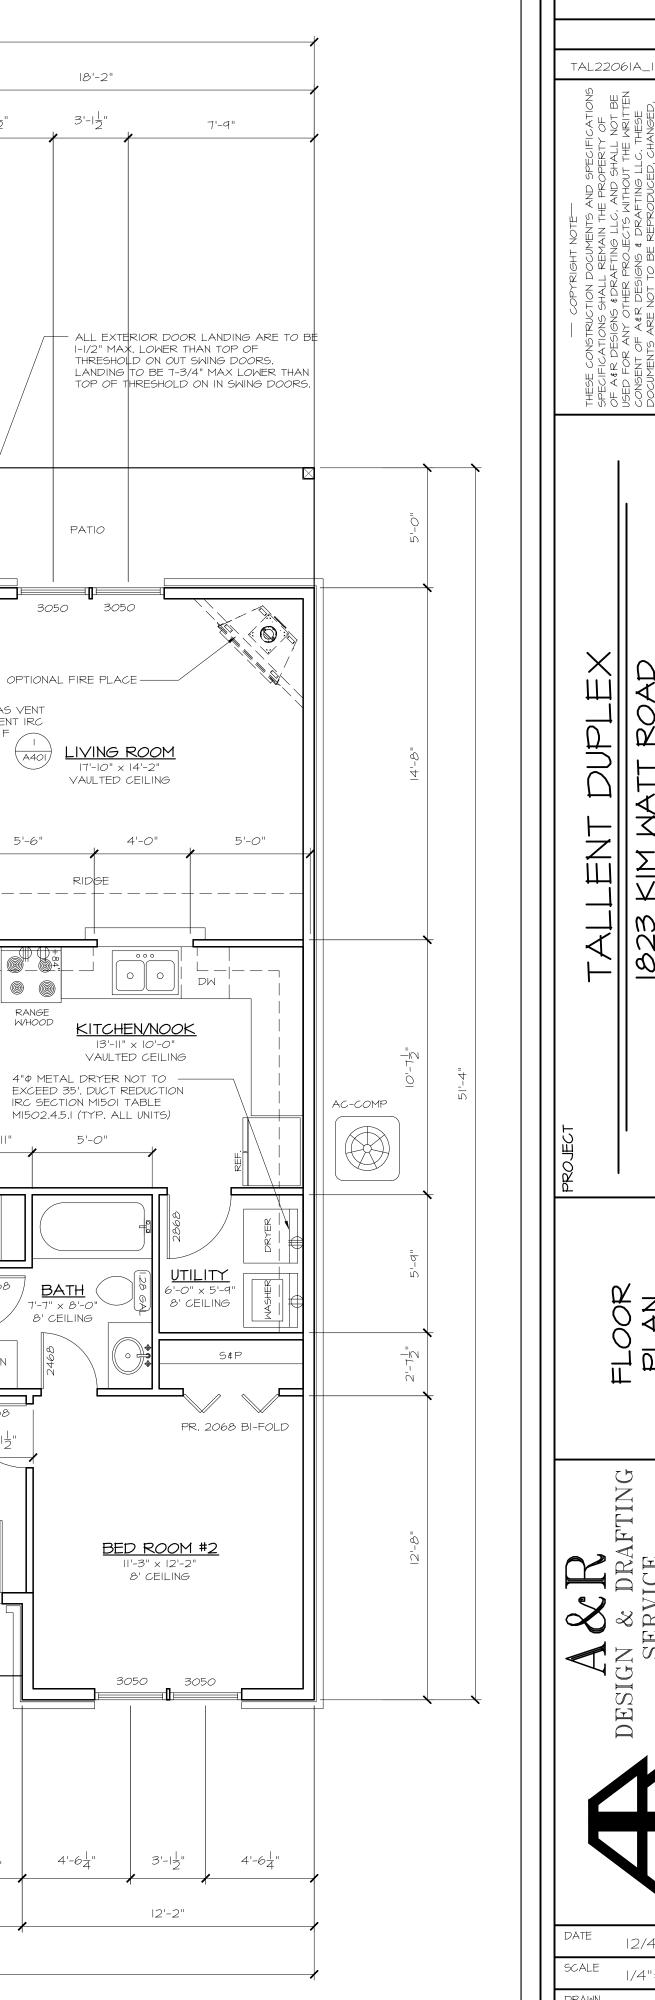

5'-1날"

3*0*50

RADON GAS VENT

PER CURRENT IRC

5'-6"

APPENDIX F

<u>FOYER</u>

 $6'-4'' \times 5'-2$

3'-85"

6'-72"

0'-4"

64'-6"

7'-0"

4'-64"

2'-11"

3'-12"

12'-0"

4'-44"

8' CEILING

12/4/2023

1/4"=1'-0"

TAL22061


SHEET

12-A-23-PD 12.06.23

- SPACE DOES NOT EXCEED 1000 SQ FT. DRAFT STOPPING SHALL DIVIDE THE CONCEALED SPACE INTO APPROX. STOPPING SHALL DIVIDE THE CONCEALED SPACE INTO APROX. EQUAL AREAS. DRAFT STOPPING MATL'S SHOULD NOT BE LESS THEN I/2" GYP BD, 3/8" PLYWD, 3/8" TYPE 2-M PARTICLE BD., OR OTHER MATL'S APPROVED BY THE BUILDING DEPT. AND CURRENT IRC
- C. AT SOFFITS AND IO' MAX VERTICAL IN WALLS D. SEAL ALL DUCT AND PIPE PENETRATIONS THROUGH THE GARAGE FIRE WALL WITH AN
- 29. ALL PENETRATION OF THE FIRE RATED WALLS MUST COMPLY WITH IRC SECTION 714 IF THE PENETRATION CANNOT COMPLY WITH THE EXCEPTIONS THAN SUBMIT A LISTED PENETRATION FIRE STOP SYSTEM AS SPECIFIED IN IC SECTIONS 714 TO THE GOVERNING MUNICIPALITY FOR APPROVAL PRIOR TO INSTALLATION.
- 30. TYPICAL ANGLE IS 45° UNLESS NOTED OTHERWISE.

APPROVED NON-COMBUSTIBLE MATERIAL

- 31. WINDOW FRAMES TO BE NON-METALLIC
- 32. CONTRACTOR TO VERIFY ALL DIMENSIONS PRIOR TO CONSTRUCTION. 33. SPECIAL INSPECTION AS PER IRC 1705 IS REQUIRED FOR THE FOLLOWING.
- A. BOLTS INSTALLED IN CONCRETE WITH ASSUMED STRESS INCREASES. B. SHOP AND FIELD STRUCTURAL WELDING.
- C. INSTALLATION OF EPOXY INSTALLED ANCHOR BOLTS. D. INSTALLATION OF HIGH-STRENGTH BOLTS.
- 34. GLASS BLOCK IS PROVIDED W/ EXPANSION JOINTS ACROSS TOP AND SIDES, FREE OF MORTAR AND FILLED W/ RESILIENT MATERIAL SIZE OF EXPANSION JOINTS SHALL BE WHATEVER IS NECESSARY TO ACCOMMODATE SUPPORTING MEMBER
- MEMBER DISPLACEMENTS BUT SHALL BE A MINIMUM OF 3/8". GLASS BLOCK PANELS ARE REINFORCED PER IRC SECTION 2110

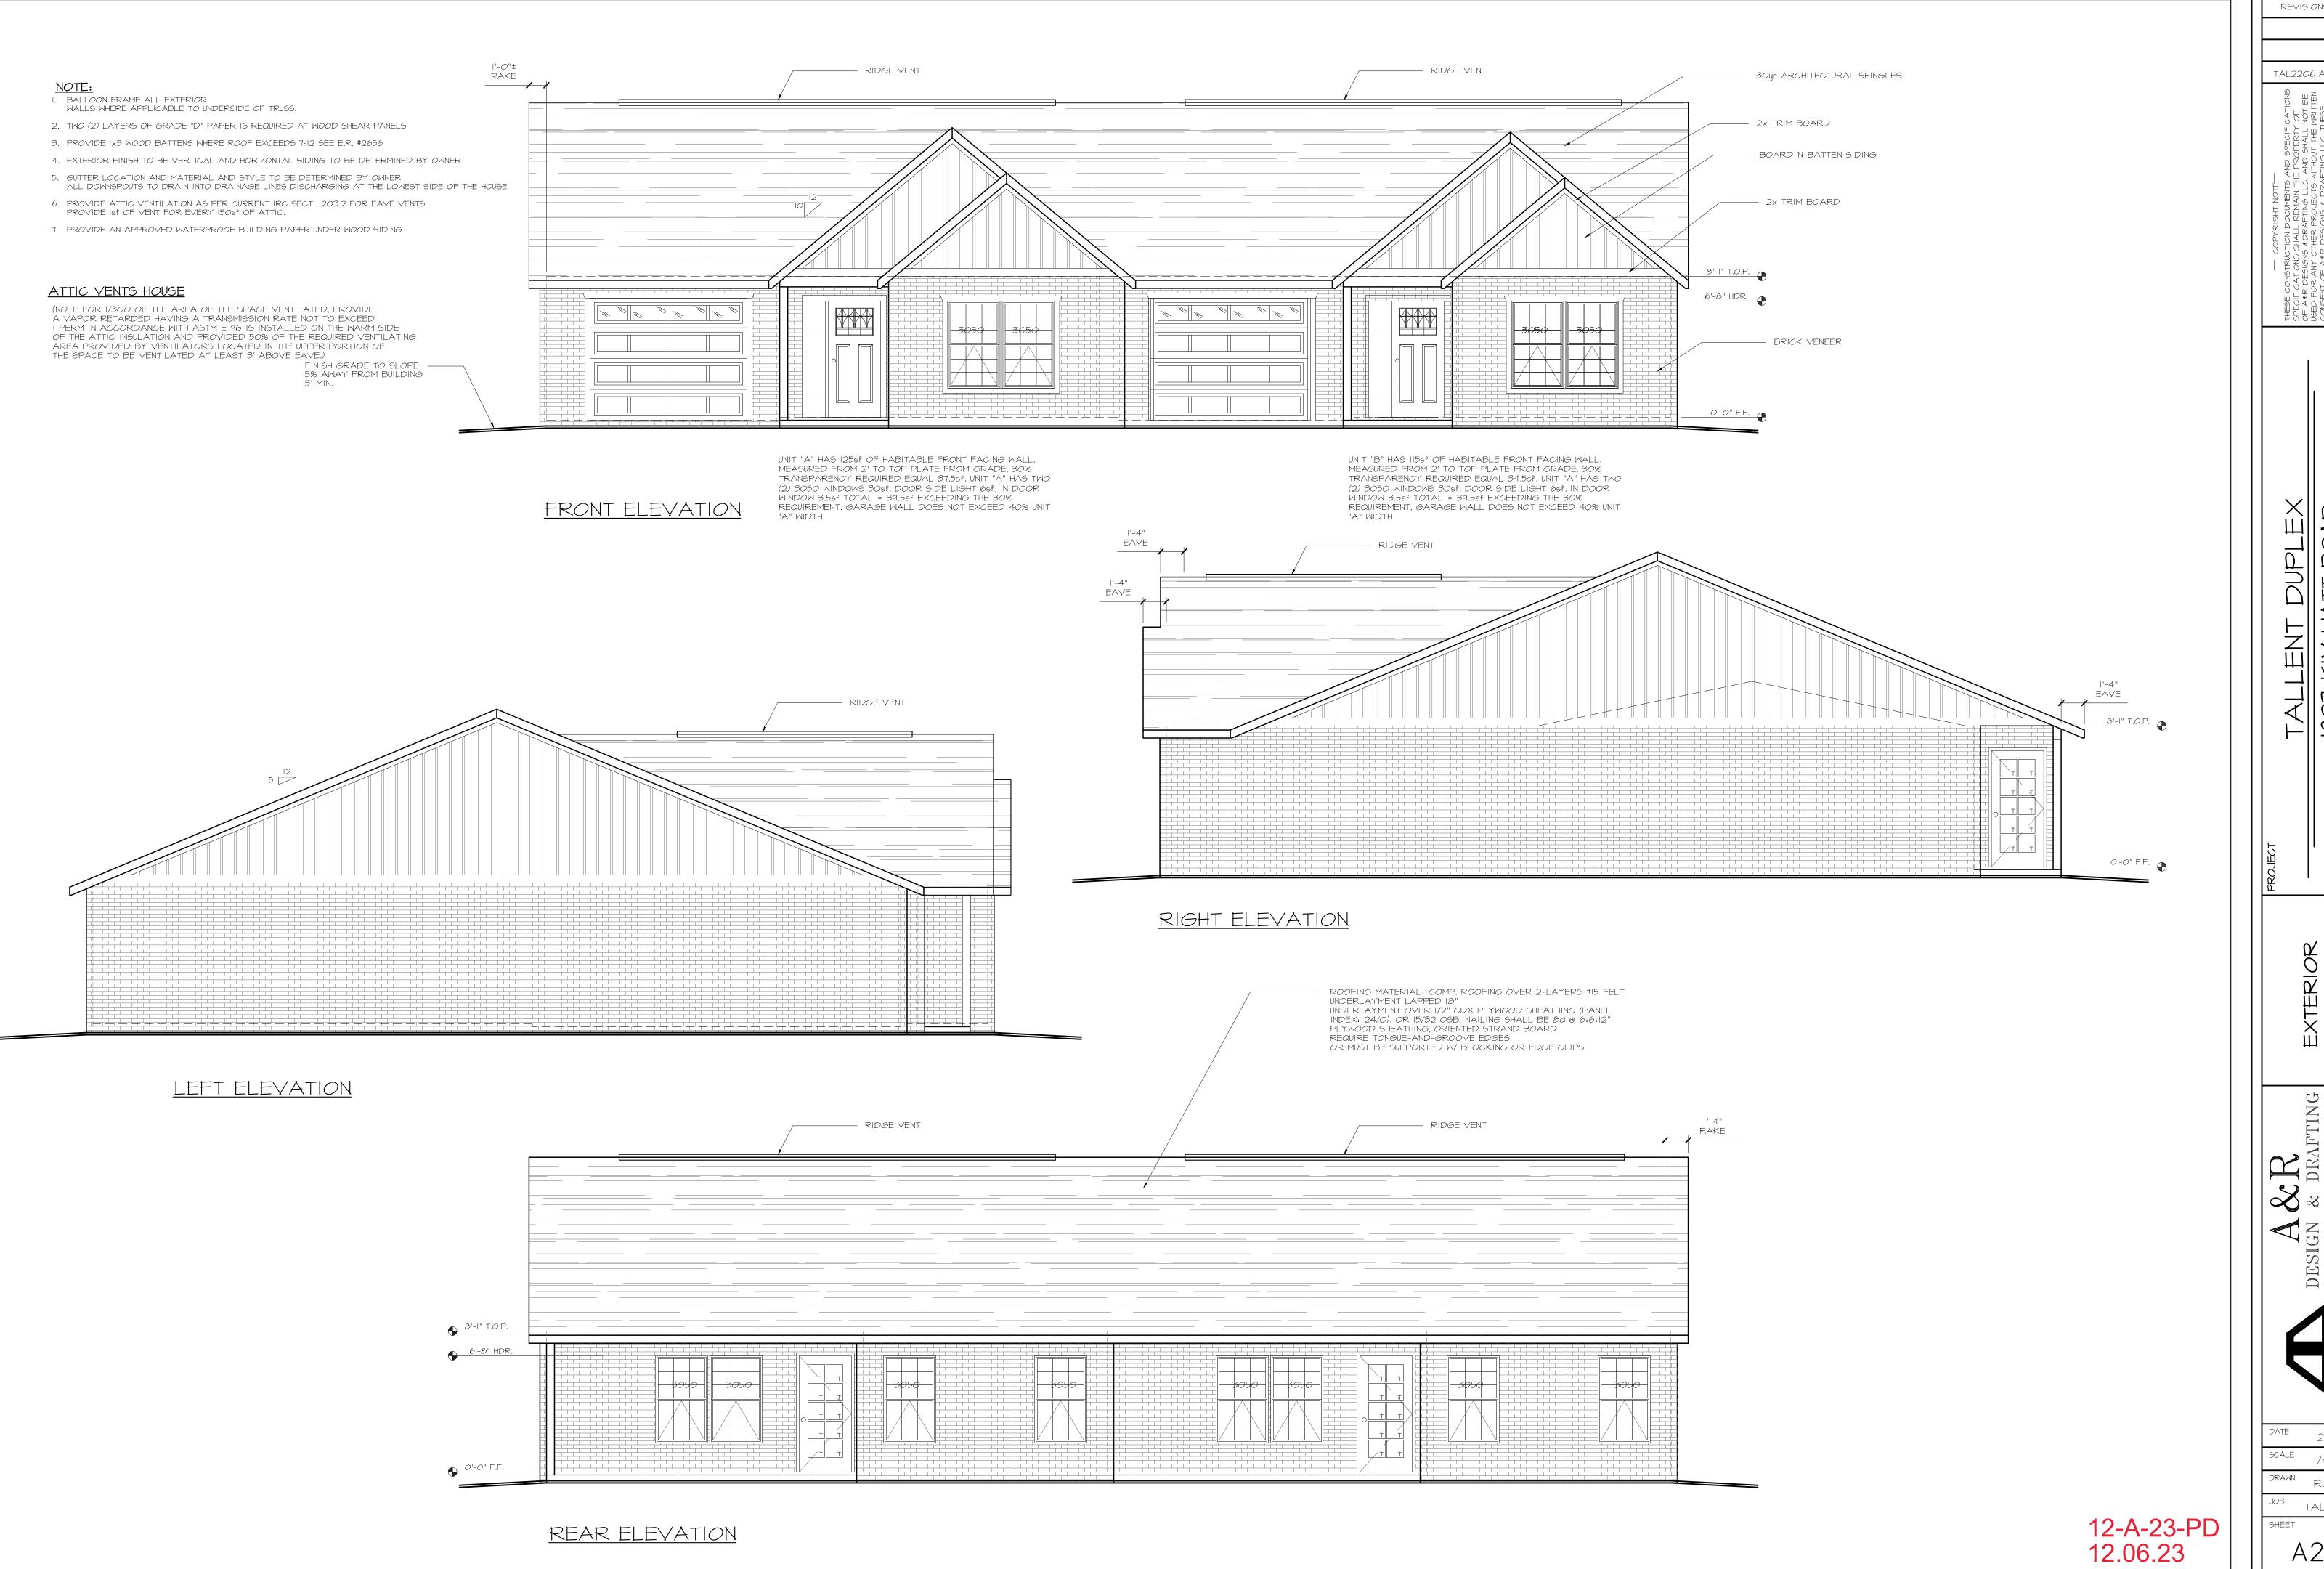

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12/4/2023 |/4"=|'-0"

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