




REVISED 11/13/2015

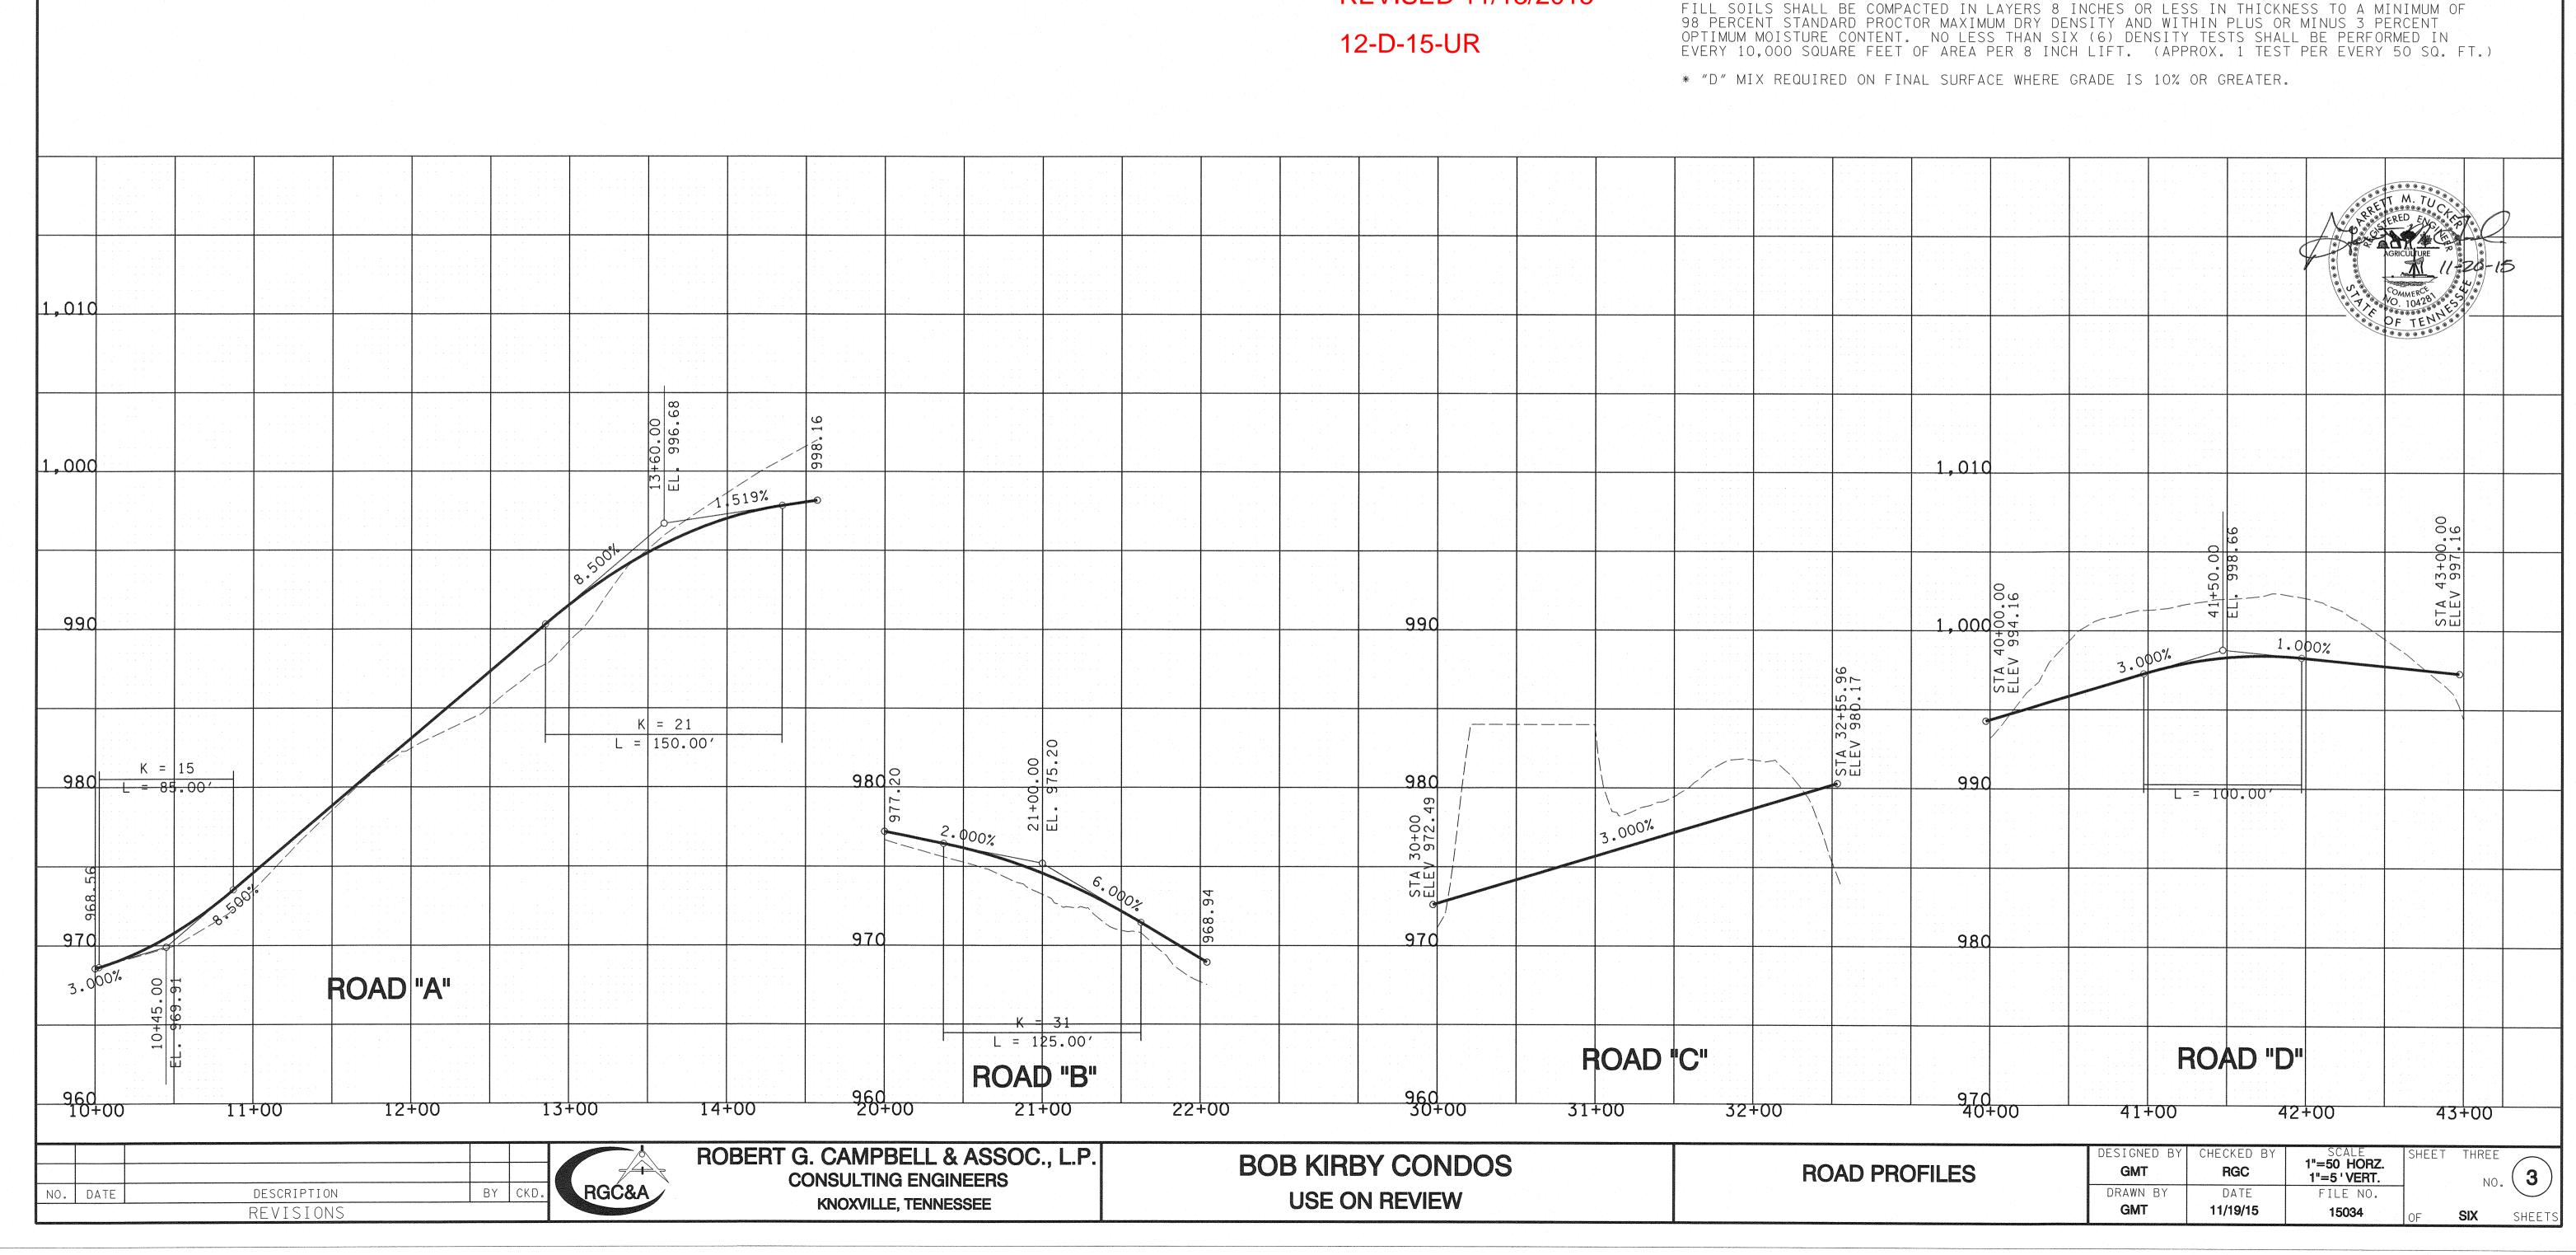

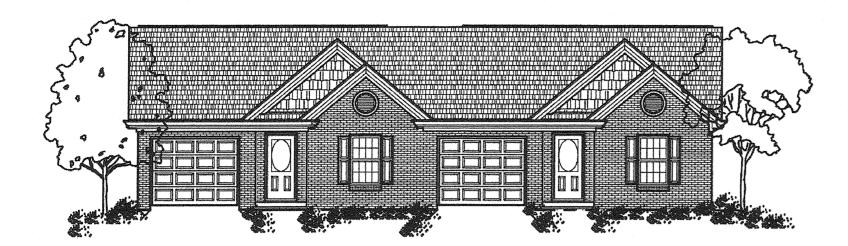

Front Elevation

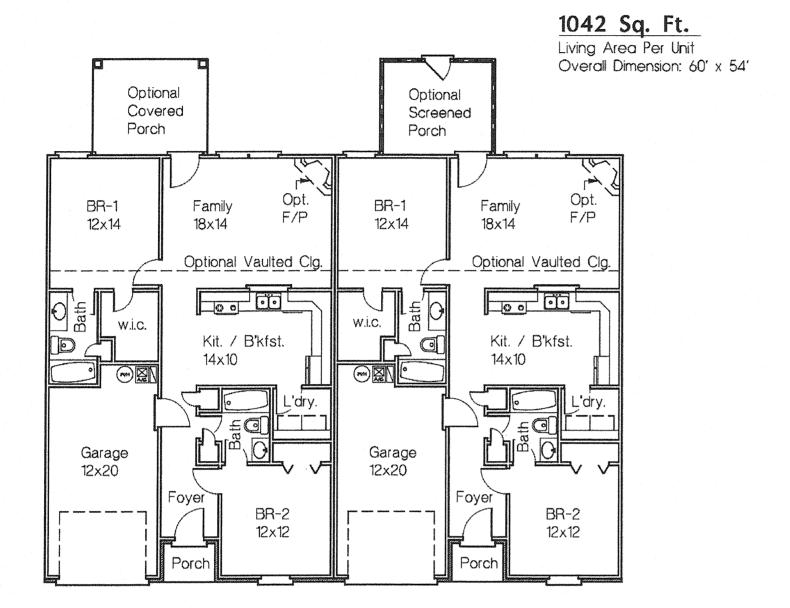


Unit Floor Plan 1042 Sq. Ft. Living Area Per Unit


Plan No. 07-0101

Sam R. Ensor Residential Drafting Service

FLOOR PLAN AND FRONT ELEVATION 1 ST BR/FR 2 BEDROOM 2 BATH 30' X 54' 1042 SQ FT PER UNIT NOT TO SCALE

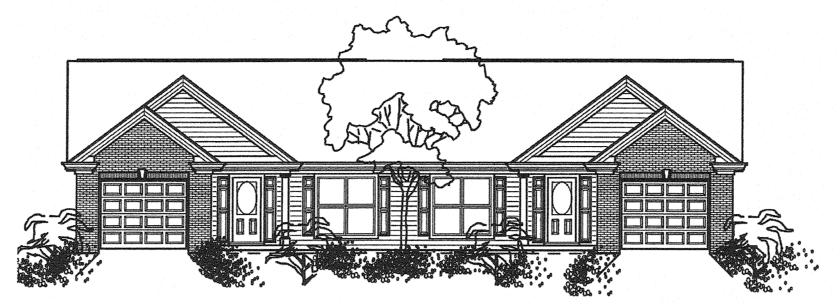

Front Elevation

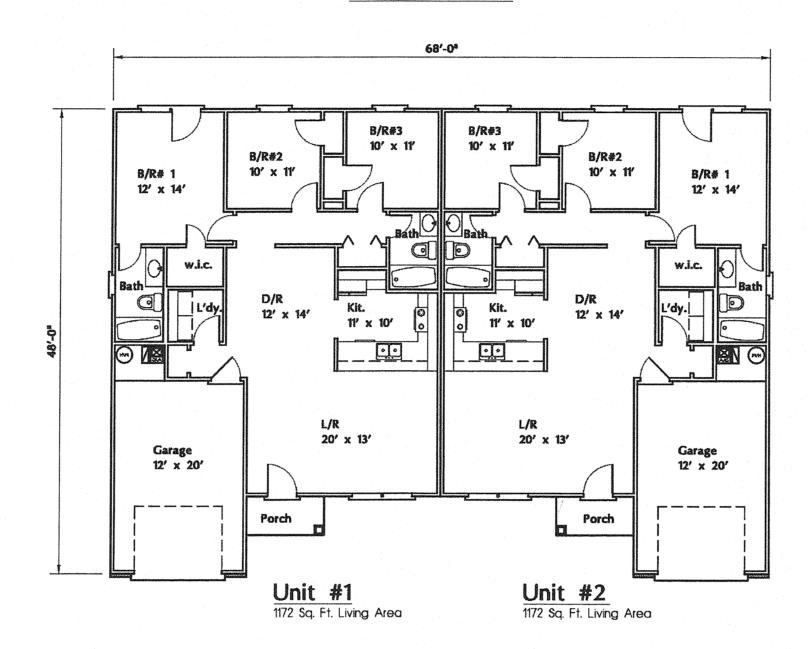


Sam R. Ensor 1311 Greenwell Drive, Knoxville, TN 37938

Dh/Eau OLE OLT OOE1 Email companie frontier com

Plan No. 20-0304 Copyright 2000 All Diahta Dararuad

FLOOR PLAN AND FRONT ELEVATION 1 ST BR/FR 3 BEDROOM 2 BATH 34' X 48' 1172 SQ FT PER UNIT NOT TO SCALE

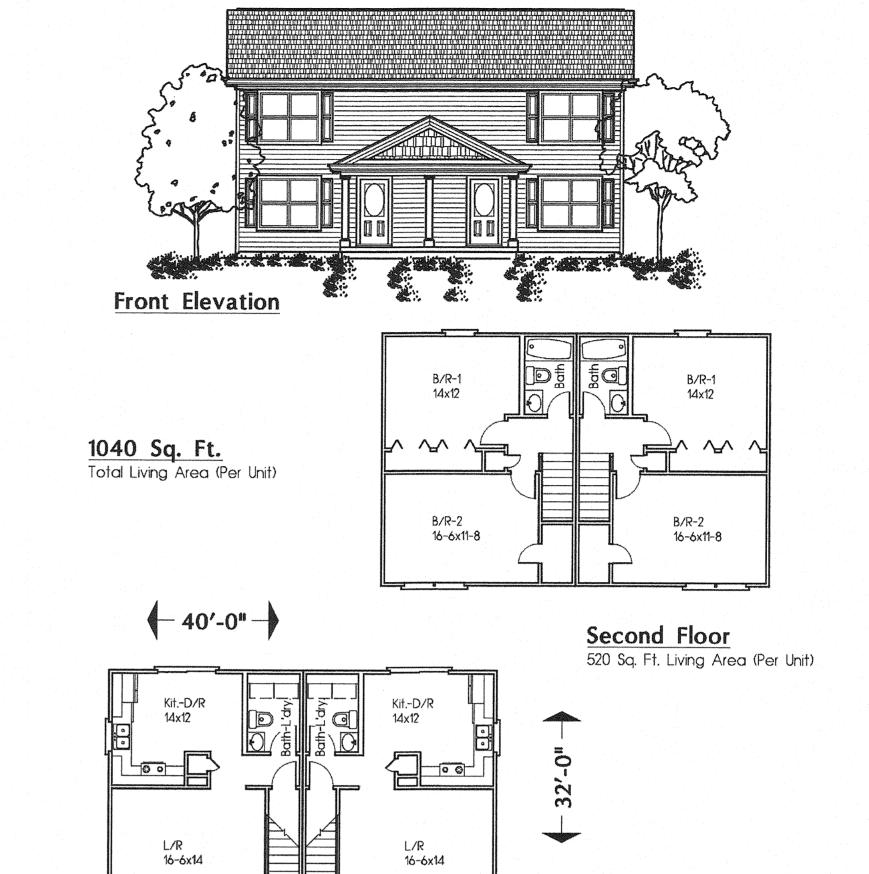


Plan No. 97-1104

Sam R. Ensor, Designer
P. O. Box 284, Powell, Tennessee 37849-0284 Ph/Fax 865-947-8951 Email: samensor@icx.net

Main Floor
520 Sq. Ft. Living Area (Per Unit)

FLOOR PLAN AND FRONT ELEVATION 2 ST FR 2 BEDROOM 1 1/2 BATH 20' X 32' 1040 SQ FT PER UNIT NOT TO SCALE

> REVISED 11/13/2015 12-D-15-UR

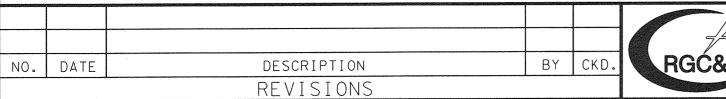





ROBERT G. CAMPBELL & ASSOC., L.P. **CONSULTING ENGINEERS** KNOXVILLE, TENNESSEE


BOB KIRBY CONDOS

FLOOR PLANS AND **ELEVATIONS**

DESIGNED BY GMT	CHECKED BY	SCALE 1" = 40'	SHEETFOUR	
DRAWN BY	DATE	FILE NO.	NO. (4
DED	11/19/15	15034	OF SIX SHE	ETC

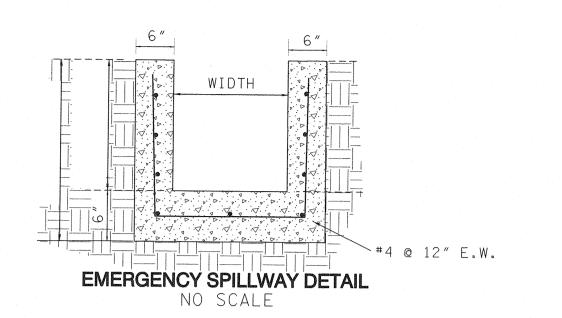

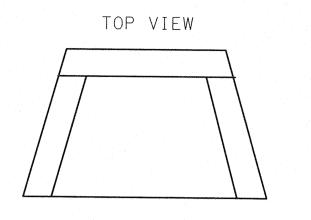


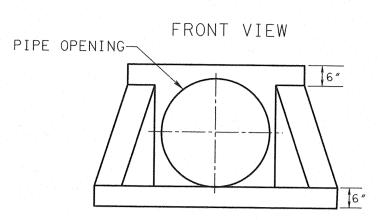


NOTES:

- 1. MINIMUM REINFORCING WIRE REINFORCEMENT 4 imes 4 imes 4 imes 7
- 2. SHERMAN DIXIE PRECAST HEADWALL, DRAWING ET-001 OR EQUAL


ENDWALL DETAIL

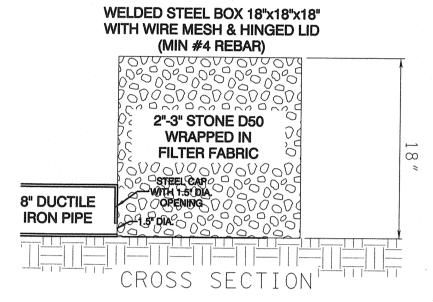



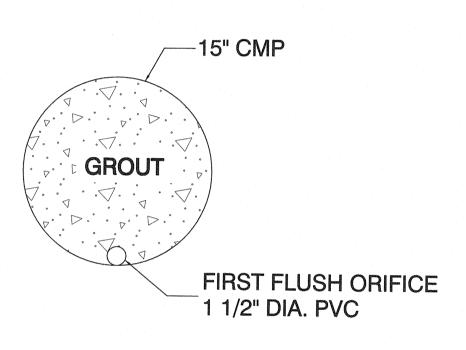

FIRST FLUSH ORIFICE DETAILS

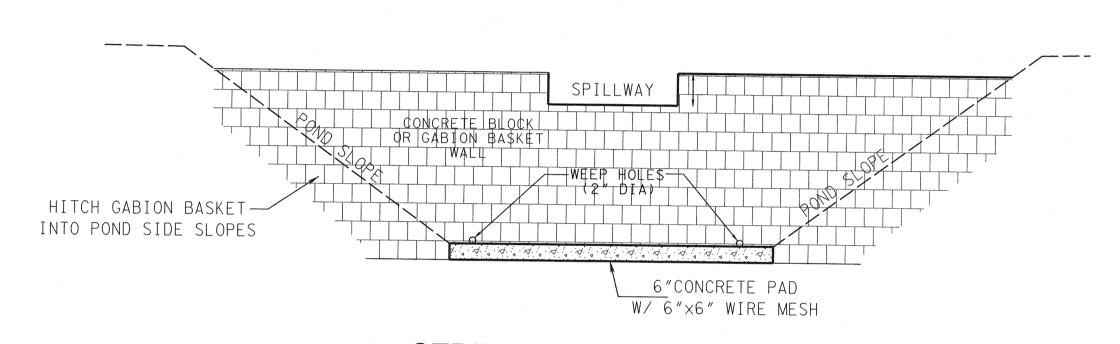

SEDIMENT FOREBAY DETAIL PROFILE VIEW NO SCALE

GENERAL NOTES:

OF GRADING.

1) INSTALL POND AS FIRST ITEM OF CONSTRUCTION.

UPSTREAM AREAS ARE STABILIZED.

ARE PERMANENTLY STABILIZED.

STORM WATER DETENTION.

CONSTRUCTION NOTES:

3) SCARIFY FILL AREAS.

PROVIDE 95% COMPACTION.

5) POND WILL REMAIN FOR PERMANENT

4) UNPLUG FIRST FLUSH ORIFICE, AND INSTALL

FIRST FLUSH FILTER WHEN ALL UPSTREAM AREAS

1) CLEAR BASIN AREA OF ALL ORGANIC MATERIALS.

POND DETAILS


2) EXCAVATE CUTOFF TRENCH ALONG THE CENTERLINE OF THE DAM. TRENCH TO BE AT LEAST 2 FEET DEEP WITH BOTTOM WIDTH

OF 4 FT & SIDE SLOPES LESS THAN 1:1.


4) PLACE FILL IN 6" LAYERS USING MATERIAL WITH HIGH SILT/CLAY MATERIAL AND

SEED & STABILIZE IMMEDIATELY UPON COMPLETION

Knox County Tennessee Stormwater Management Manual

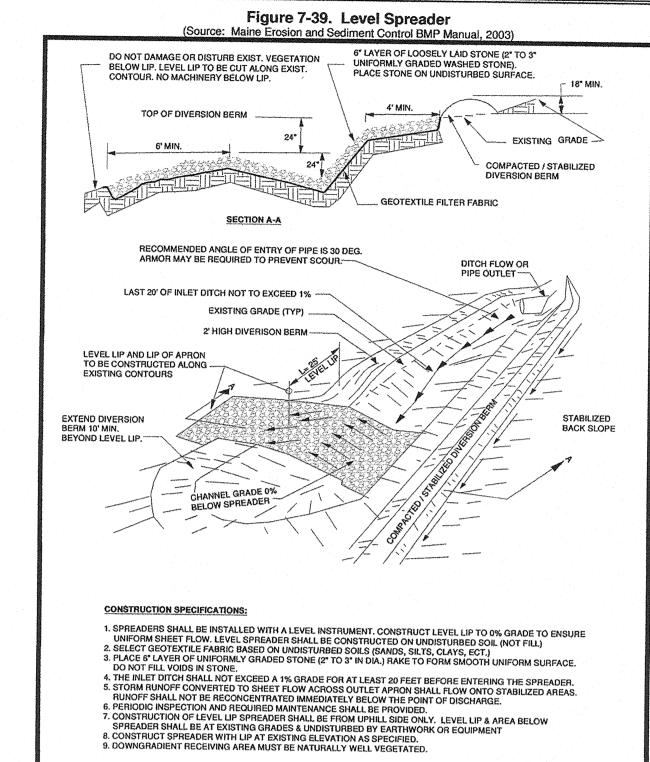

LEVEL SPREADER TYPICAL DETAIL

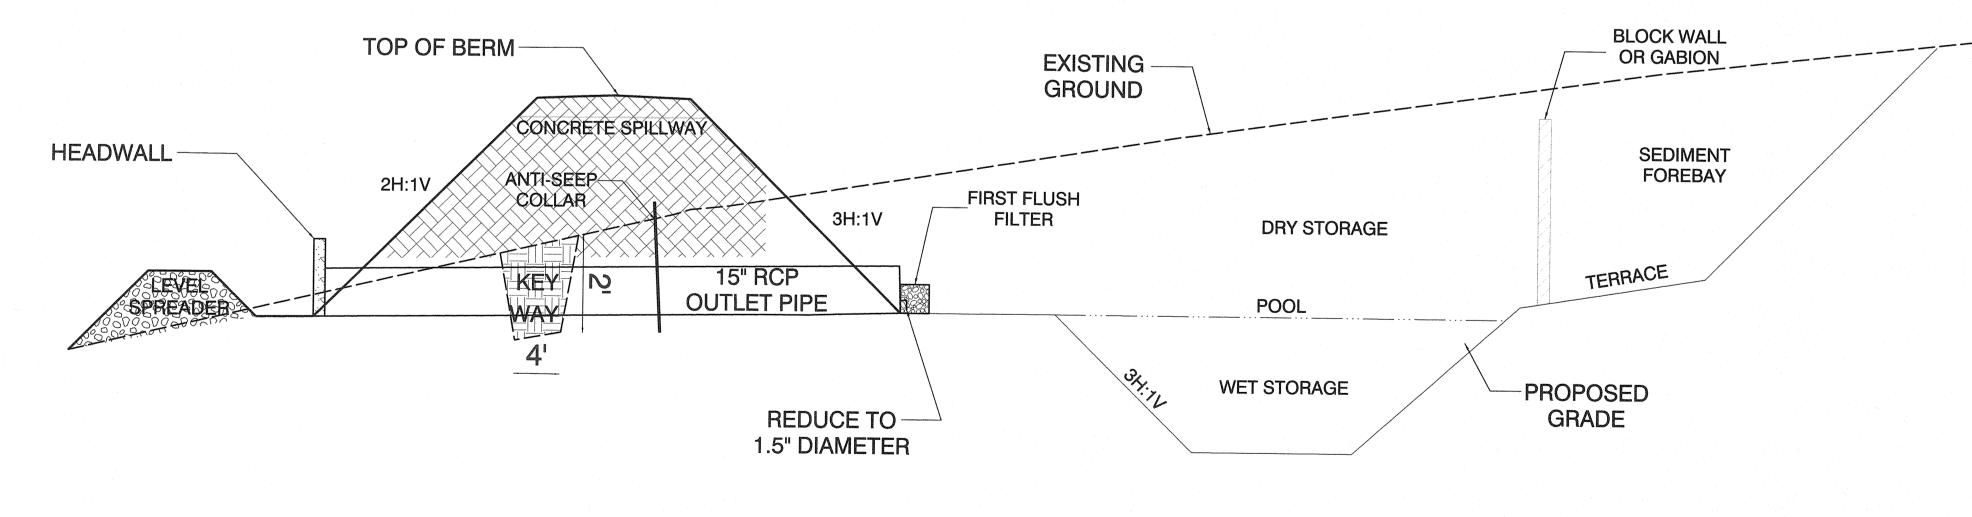

WET DETENTION BASIN TYPICAL CROSS-SECTION


NO SCALE NO. DATE DESCRIPTION REVISIONS



ROBERT G. CAMPBELL & ASSOC., L.P. **CONSULTING ENGINEERS** KNOXVILLE, TENNESSEE

BOB KIRBY CONDOS DESIGN PLAN

2) INSTALL OUTLET STRUCTURE AND OUTLET PIPE. REVISED 11/13/2015 PLUG FIRST FLUSH ORIFICE DURING CONSTRUCTION FOR USE AS TEMPORARY SEDIMENT TRAP. 3) REMOVE ACCUMULATED SEDIMENT WHEN ALL 12-D-15-UR

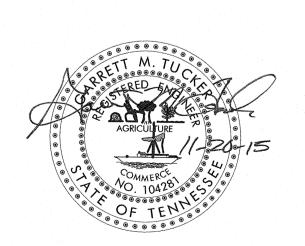

DESIGNED BY GMT	CHECKED BY RGC	SCALE NO SCALE	SHEET FIVE NO. (5)
DRAWN BY	DATE	FILE NO.	No.
GMT/DED	11/19/15	15034	OF SIX SHEETS

