
## DIANAS VIEW


# 1316 LOVELL ROAD DISTRICT 6\* KNOX COUNTY\* TENNESSEE

SHEET(S)	
S-1	SITE PLAN
S-2	SITE DETAILS
<b>C-1</b>	INITIAL GRADING PLAN
C-2	DURING CONSTRUCTION GRADING PLAN
C-3	POST CONSTRUCTION GRADING PLAN
C-4	SWPPP DETAILS

LeMAY AND ASSOCIATES CONSULTING ENGINEERS

PH: (865) 671-0183 FAX: (865) 671-0213 EMAIL: rlemay@lemayassociates.com 10816 KINGSTON PIKE KNOXVILLE, TENNESSEE 37934

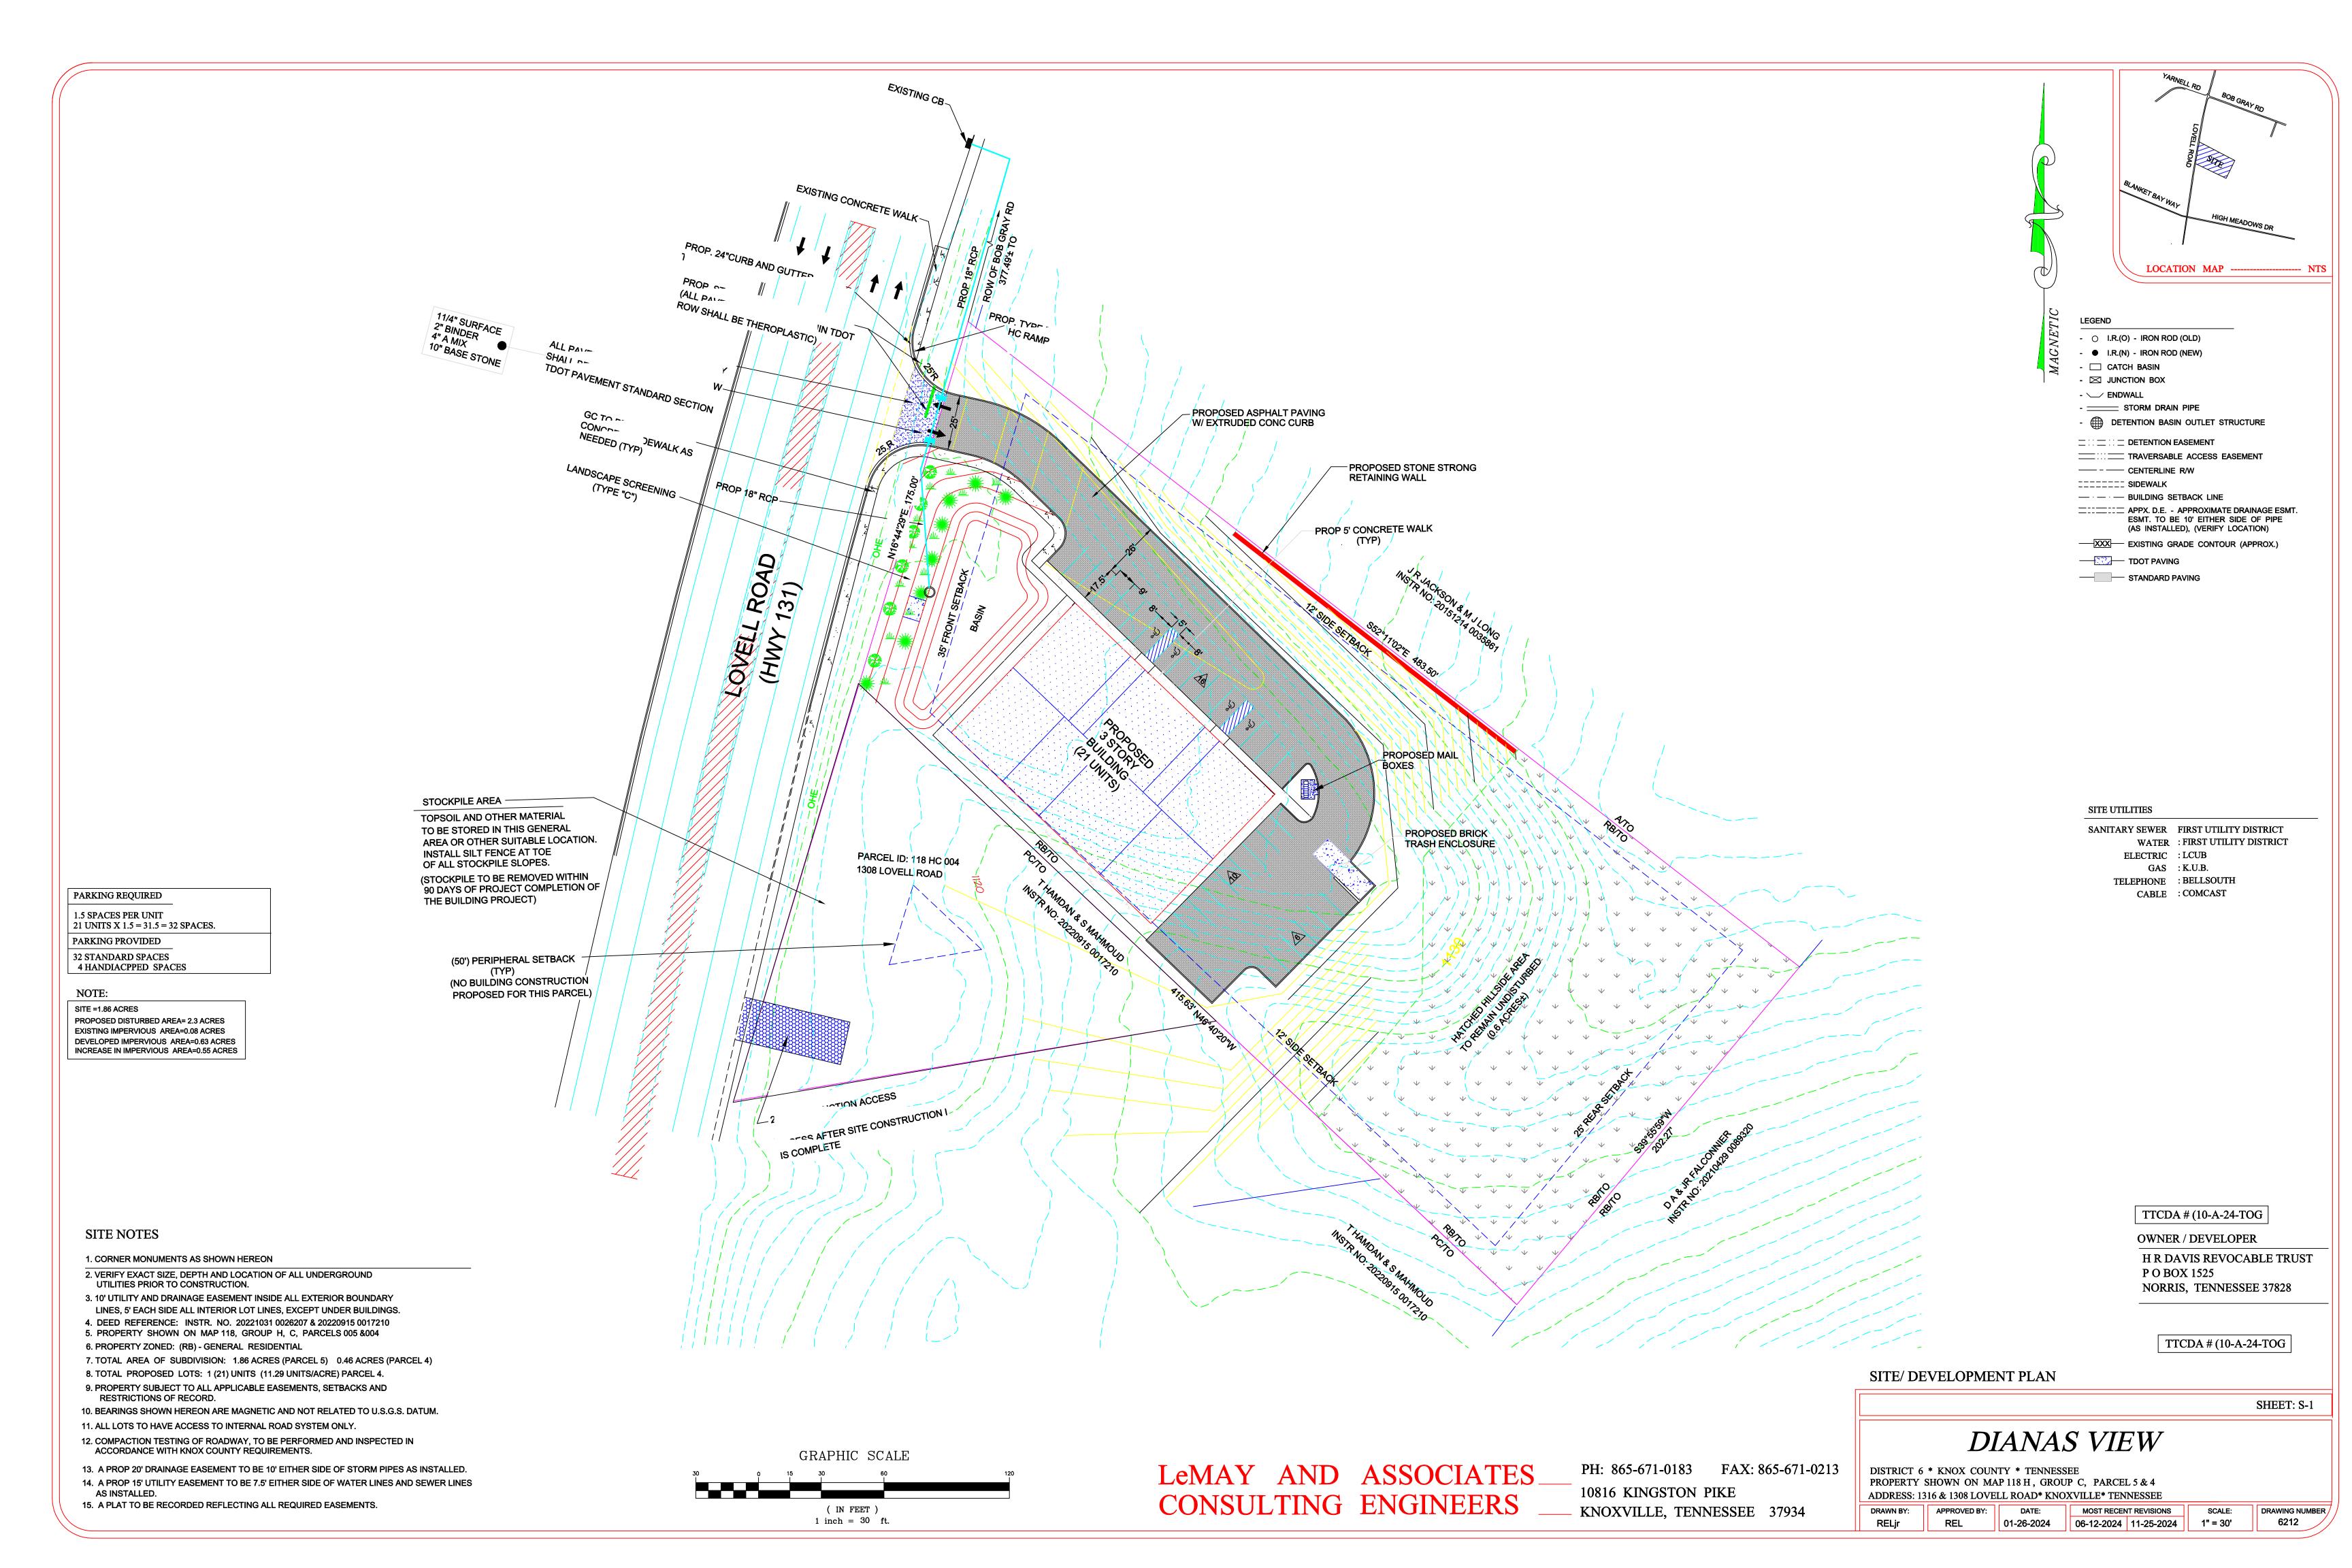

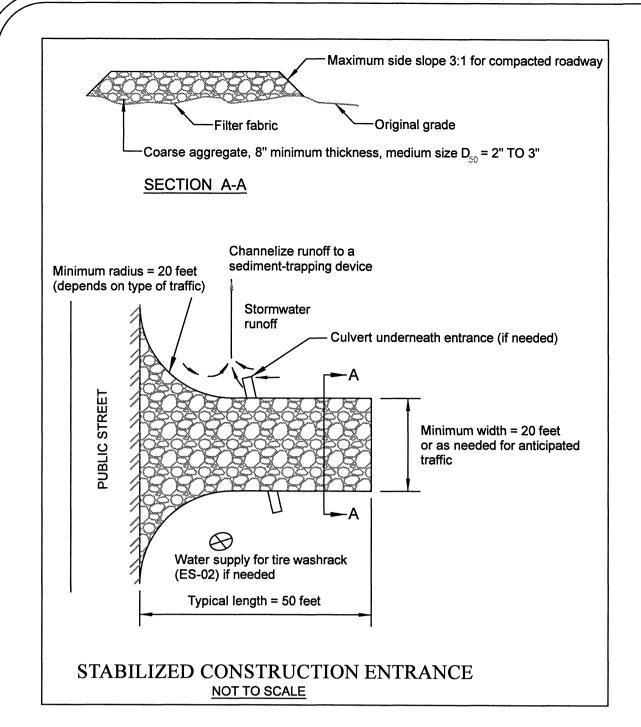

-FLOWABLE FILL, CLASS B CONCRETE

FLOWABLE FILL, CLASS B CONCRETE

COLLAR TO BE KEYED INTO

UNDISTURBED SOIL

OR EQUAL


OR EQUAL


SECTION


\_TRENCH\_ WIDTH


PLAN


CONCRETE ANTI SEEP COLLAR
DETAIL -- NTS

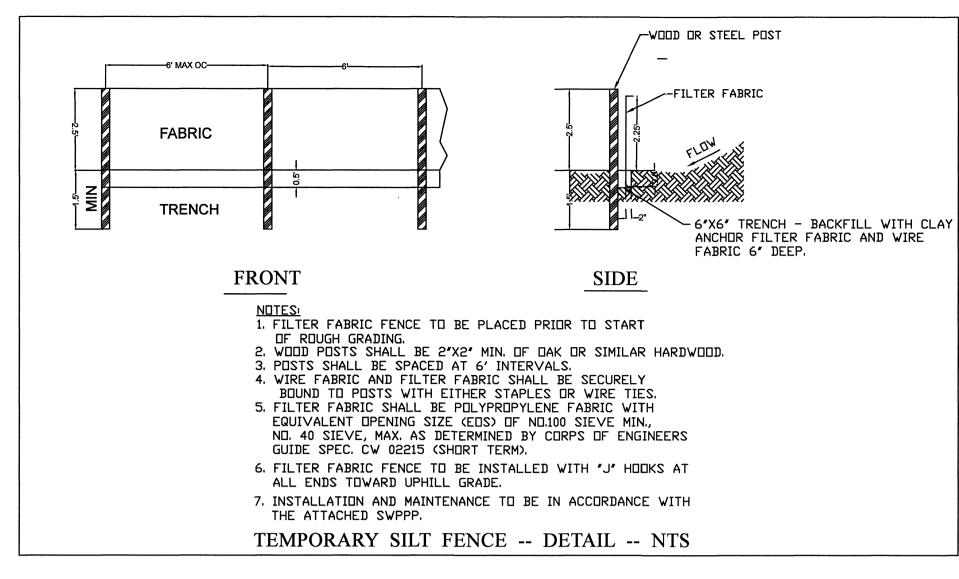


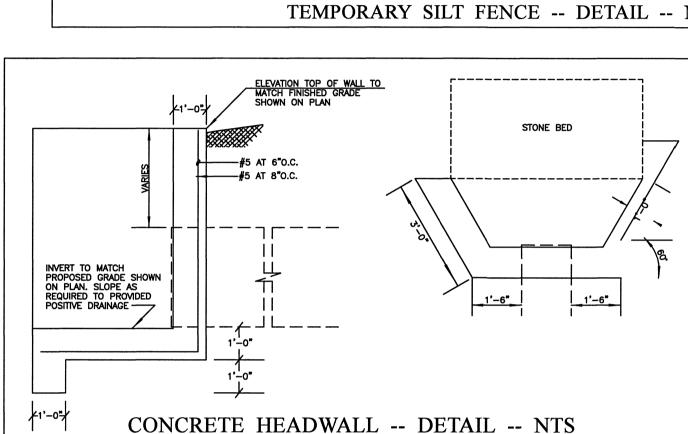


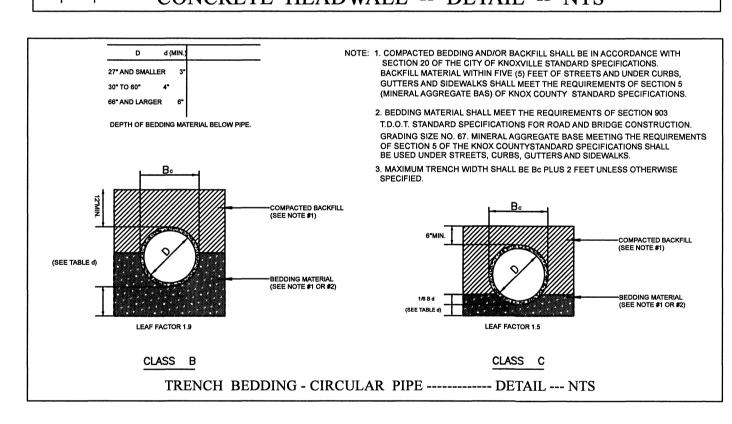


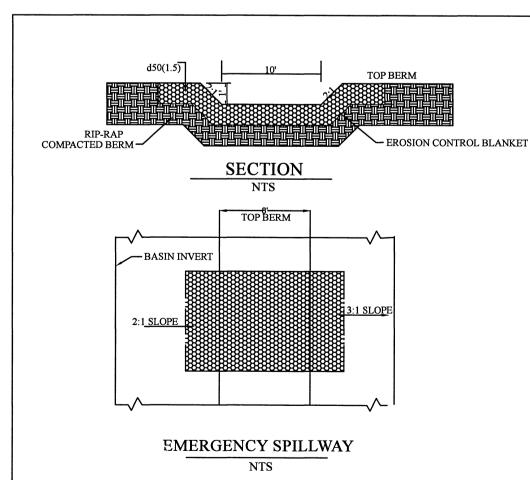


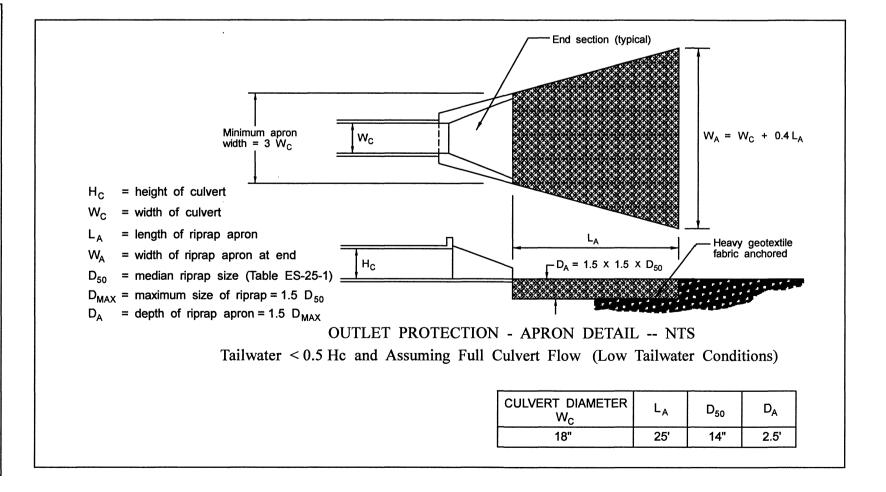


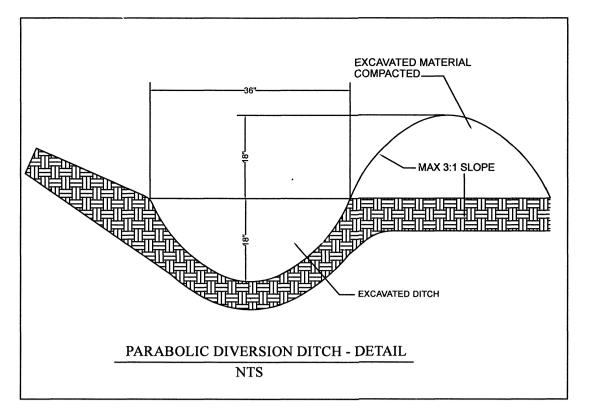


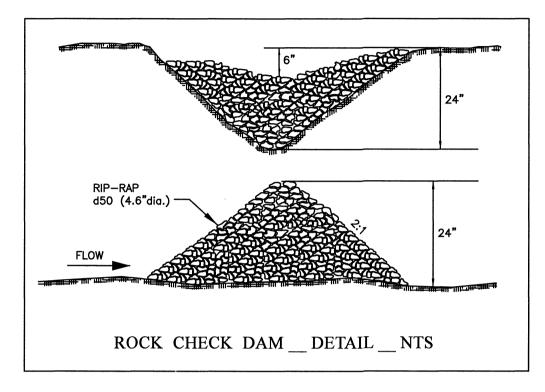


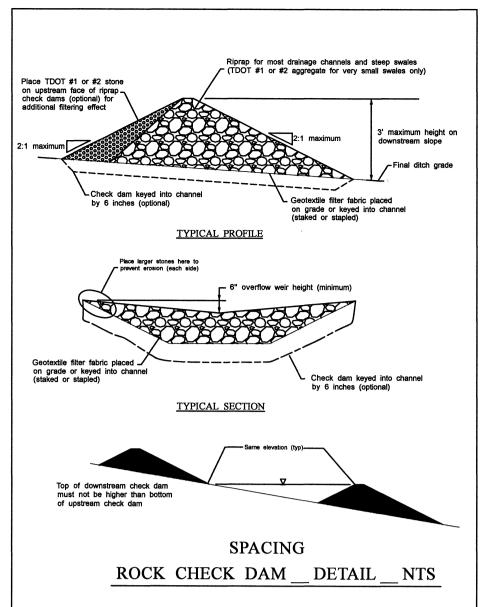

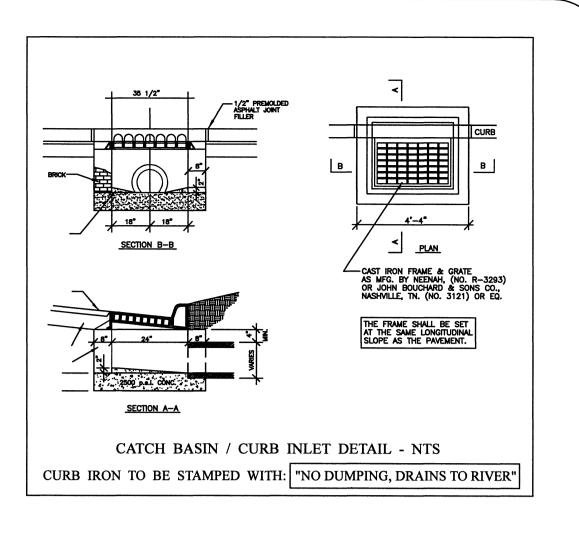

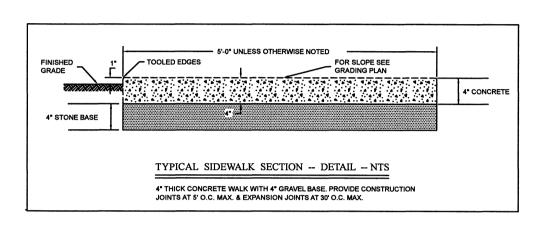

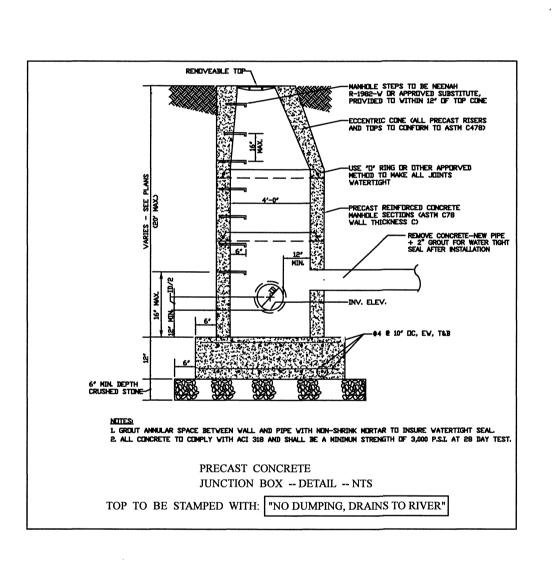

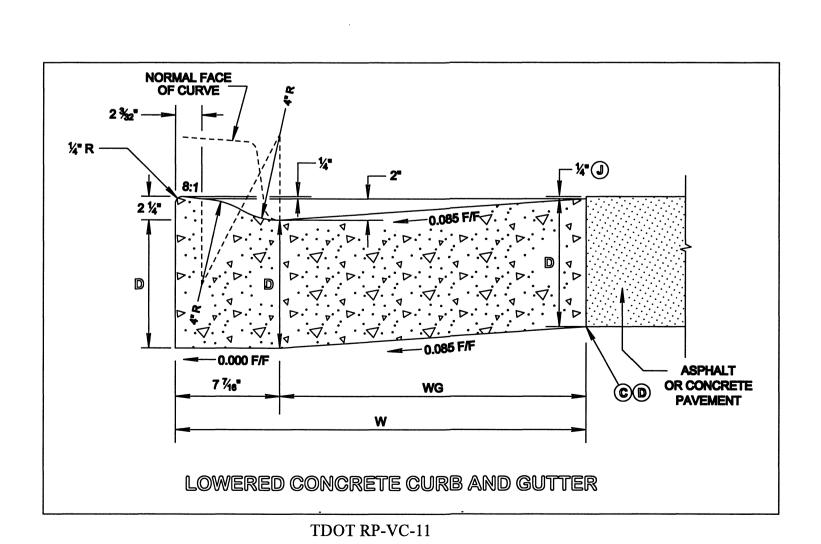


LeMAY AND ASSOCIATES\_ CONSULTING ENGINEERS \_

PH: 865-671-0183 FAX: 865-671-0213

10816 KINGSTON PIKE

KNOXVILLE, TENNESSEE 37934

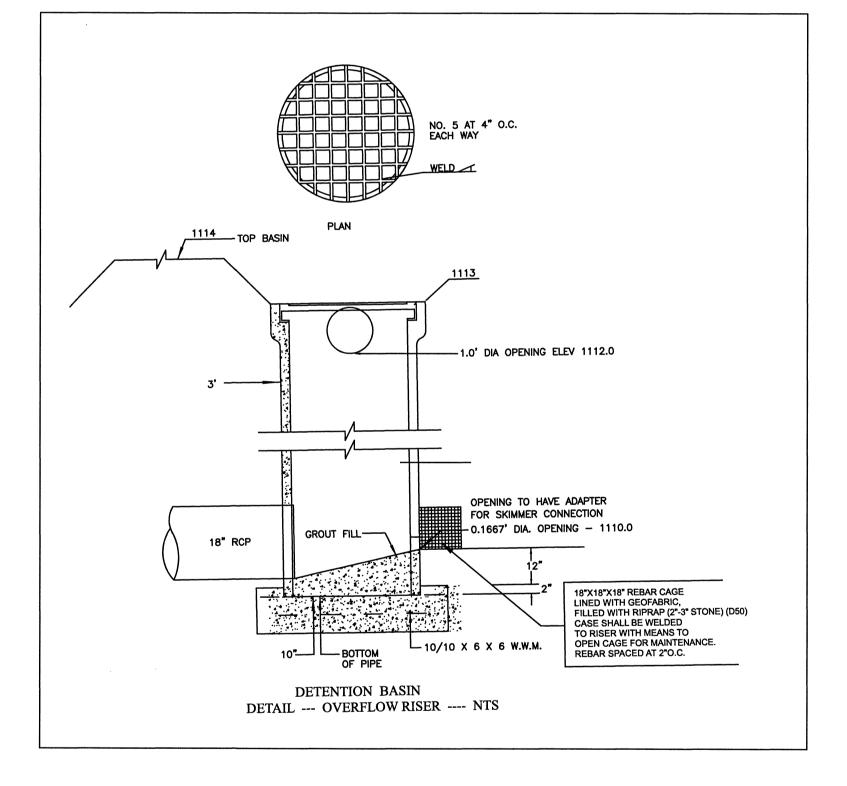

OWNER / DEVELOPER

H R DAVIS REVOCABLE TRUST
P O BOX 1525
NORRIS, TENNESSEE 37828

DIANAS VIEW

DISTRICT 6 \* KNOX COUNTY \* TENNESSEE
PROPERTY SHOWN ON MAP 118 H , GROUP C, PARCEL 5
ADDRESS: 1316 LOVELL ROAD\* KNOXVILLE\* TENNESSEE

DRAWN BY: APPROVED BY: DATE: MOST RECENT REVISIONS SCALE: DRAWING NUMBER 6212

GRADING AND EROSION CONTROL NOTES

1. CONTRACTOR TO VERIFY LOCATIONS OF ALL UTILITIES PRIOR TO CONSTRUCTION, CONTRACROT TO CALL TENNESSEE ONE-CALL AT 1-800-351-111 AT LEAST 72 HOURS PRIOR TO CONSTRUCTION ACTIVITIES FOR UTILITIES LOCATION. 2. CONTRACTOR RESPONSIBLE FOR COMPLACE OSHA REQUIREMENTS FOR SLOPE STABILITY, SHORING, AND SLOPE CONTROL DURING CONSTRUCTION.

3. CONTRACTOR IS RESPONSIBLE FOR VERIFYING GRADES AND ALIGNMENTS PRIOR TO CONSTRUCTION. REPORT ANY DISCREPANCIES OR INCONSISTENCIES TO LEMAY & ASSOCIATES AT (865) 671-0183. 4. TRAFFIC CONTROL DEVICES SHALL BE IN ACCORDANCE WITH THE MANUAL ON UNIFORM, TRAFFIC CONTROL DEVICES, LATEST EDITION AND KNOX COUNTY REQUIREMENTS.

5, THE REQUIREMENTS LISTED BELOW ARE INTENDED TO SERVE AS AN OUTLINE OF GENERAL REQUIREMENTS. ADDITIONAL REQUIREMENTS MAY BE SET FORTH IN THESE DRAWINGS.

PERMITS
CONTRACTOR SHALL PAY GRADING PERMIT FEE AND POST GRADING BOND, AS REQUIRED.

EROSION CONTROL
INSTALL ALL CONSTRUCTION ENTRANCE, SILT FENCE AND EROSION CONTROL BERMS AND SEDIMENT RETENTION FACILITIES PRIOR TO THE START OF GRADING.

CLEARING AND GRUBBING
COMPLY WITH LOCAL AND STATE ORDINANCES REGARDING DISPOSAL OF DEBRIS. DO NOT BURN
DEBRIS ON SITE WITHOUT APPROVAL OF LOCAL AUTHORITY, CLEAR AND GRUB FOR NEW

EXCAVATION PREPARATION

VERIFY LOCATION OF EXISTING ON-SITE UTILITIES. PROTECT AND MAINTAIN EXISTING UTILITIES AS REQUIRED, ESTABLISH AND VERIFY EXISTING LINES, GRADE, AND DIMENSIONS AS SHOWN ON THE DRAWING. REPORT ANY ERRORS OR INCONSISTENCIES
TO LEMAY & ASSOCIATES AT (865) 671-0183 BEFORE COMMENCEMENT OF WORK.

BARRIERS
SAFETY BARRIERS HAVING A MAXIMUM OPENING OF 4' SHALL BE PROVIDED FOR ANY PIPE, OPENING OR EXCAVATION TO PREVENT CHILDREN OR LARGE ANIMALS FROM CRAWLING INTO THE STRUCTURES. SCREENS SHALL BE WELDED 3/8' BARS 2 4' D.C. BOTH WAYS.

TEMPORARY DIVERSION SWALES
TEMPORARY DIVERSION SWALES SHALL BE CONSTRUCTED PRIOR TO STRIPPING OR ANY OTHER
GRADING ACTIVITY, IF SHOWN THIS DRAWING, ALSO TEMPORARY SEDIMENT TRAPS AND/OR
PERMANENT DETENTION BASINS SHALL BE CONSTRUCTED PRIOR TO STRIPPING OR OTHER GRADING

EXISTING TOPO ACCURACY
EXISTING CONTOURS SHOWN ARE BASED ON KGIS AND ON GROUND SURVEYING DATA. ELEVATIONS. TOPOGRAPHIC INFORMATION SHOWN HEREIN SHALL BE VERIFIED BY THE
CONTRACTOR AND ANY ERRORS OR VARIATIONS SHOULD BE REPORTED TO LEMAY AND ASSOCIATES PRIOR TO COMMENCEMENT OF WORK. ANY ERROR NOT REPORTED CANNOT BE CONSIDERED FOR ADJUSTMENT IN CONTRACT PRICE.

STRIPPING AND SPREADING TOPSOIL
TOPSOIL SHALL BE STRIPPED AND TEMPORARILY STOCK PILED FOR LATER REUSE IN AREA SHOWN ON PLAN OR OTHER AGREED TO LOCATION ON SITE.

PLACEMENT OF FILL

ALL AREAS TO RECEIVE NEW STRUCTURAL FILL SAHLL BE PROOF ROLLED OR TESTED BY A SDIL TESTING ENGINEER OR LEMAY & ASSOCIATES. THE CONTRACTOR'S REPRESENTATIVE SHALL NOTIFY LEMAY & ASSOCIATES THAT ALL AREAS HAVE PASSED PROOF ROLL INSPECTION PRIOR TO COMMENCEMENT OF STRUCTURAL OR GENERAL BACKFILL, DO NOT COMMENCE FILL PRIOR TO SUCH NOTIFICATION.

STRUCTURAL OR ROADWAY

STRUCTURAL FILL SHALL BE COMPACTED TO A MINIMUM OF STANDARD PROCTOR DENSITY WITH
MOISTURE CONTENT ± 1.0% OF OPTIMUM. UNSUITABLE OR QUESTIONABLE SOILS SHALL BE REMOVED
FROM AREAS RECEIVING STRUCTURAL BACKFILL. BACKFILL TO BE PLACED IN 6° TO 8° LIFTS, NO ORGANIC, OR ROCK LARGER THAN 6" DIA SHALL BE USED IN FILL AREAS.

GRADING TOLERANCE
GRADING CONTRACTOR SHALL BRING SUBGRADE TO WITHIN AN AVERAGE OF 1/10 OF ONE FOOT OF REQUIRED ELEVATION TO OBTAIN FINISHED GRADE INDICATED ON DRAWINGS OR AS APPROVED BY

TESTING
CONTRACTOR SHALL INCLUDE PRICE FOR ONE PROCTOR DENSITY ANALYSIS FROM SAMPLES
COLLECTED AT LOCATIONS SPECIFIED BY THE INDEPENDENT QUALIFIED GEOTECHNICAL TESTING
AGENT SUITABLE TO LEMAY & ASSOCIATES. ALL TESTS SHALL SPECIFICALLY STATE THAT THE TEST EITHER PASSES OR FAILS TO MEET SPECIFICATIONS. CONTRACTOR SHALL INCLUDE IN HIS BASE BID 10 SOIL DENSITY DETERMINATION TESTS AFTER COMPLETION OF GRADING IF REQUIRED.

STORMWATER RUNDFF
THE CONTRACTOR SHALL FURNISH ALL LABOR, MATERIALS AND EQUIPMENT NECESSARY TO PREVENT STORMWATER RUNDFF FROM EXITING THE SITE OR ENTERING ADJACENT WATER QUALITY BUFFERS OR STREAMS, ALL KNOX COUNTY AND TDEC REGULATIONS TO BE COMPLIED WITH THROUGHOUT THE CONSTRUCTION PROCESS

GRADING AND EROSION CONTROL NOTES

Prior to grading, contractor shall strip site of all vegetation and topsoil in areas of grading operation. Areas of soft or unsuitable materials shall be removed at the direction of the soils engineer.

The contractor shall maintain positive drainage throughout the site and use all means necessary to prevent sediment from

Silt fence shall be placed preceding all culvert inlets or other drains and ditches before the runoff exits the project or enters a swale and at other locations designated by the engineer.

Silt fences and other erosion control devices shall be cleaned of accumulated sediment when approximately 50% filled with such

All dimensions and locations of temporary soil erosion and water pollution control devices shall be subject to adjustments as designated by the engineer.

The contractor shall notify the engineer of any changes in existing topographic features, spot elevations, or utilities

The contractor shall notify the engineer prior to culvert installations to verify inverts.

All graded areas including slopes are to be mulched and

seeded as soon as possible after grading is completed. All grading and drainage ordinances of Knox County Tennesssee shall be followed.

A. APPLY TEMPORARY SEEDING WHENEVER GRADING OPERATIONS ARE TEMPORARILY HALTED FOR OVER 14 DAYS AND FINAL GRADING OF EXPOSED SURFACES IS TO BE COMPLETED WITHIN ONE YEAR. APPLY TEMPORARY SEEDING TO SOIL STOCKPILES.

B. APPLY PERMANENT SEEDING WHENEVER GRADING OPERATIONS ARE COMPLETED AND ALL CONSTRUCTION OPERATIONS WILL NOT IMPACT THE DISTURBED AREA. APPLY PERMANENT SEEDING TO ALL NON-CONSTRUCTION AREAS WHICH SHOW SIGNS OF EXCESSIVE EROSION.


SEQUENCE OF PRE-CONSTRUCTION ACTIVITIES

THE CONSTRUCTION SEQUENCE FOR THIS PROJECT IS AS FOLLOWS:

1. INSTALL SILT FENCE
2. INSTALL STORMWATER PERMIT STAND
3. INSTALL CONSTRUCTION ENTRANCE
4. INSTALL RIPRAP SEDIMENT TRAPS, DIVERSION DITCHES,

AND THE REMAINDER OF EROSION CONTROL DEVICES.

5. COMMENCE REQUIRED INSPECTIONS AND MAINTENANCE OF

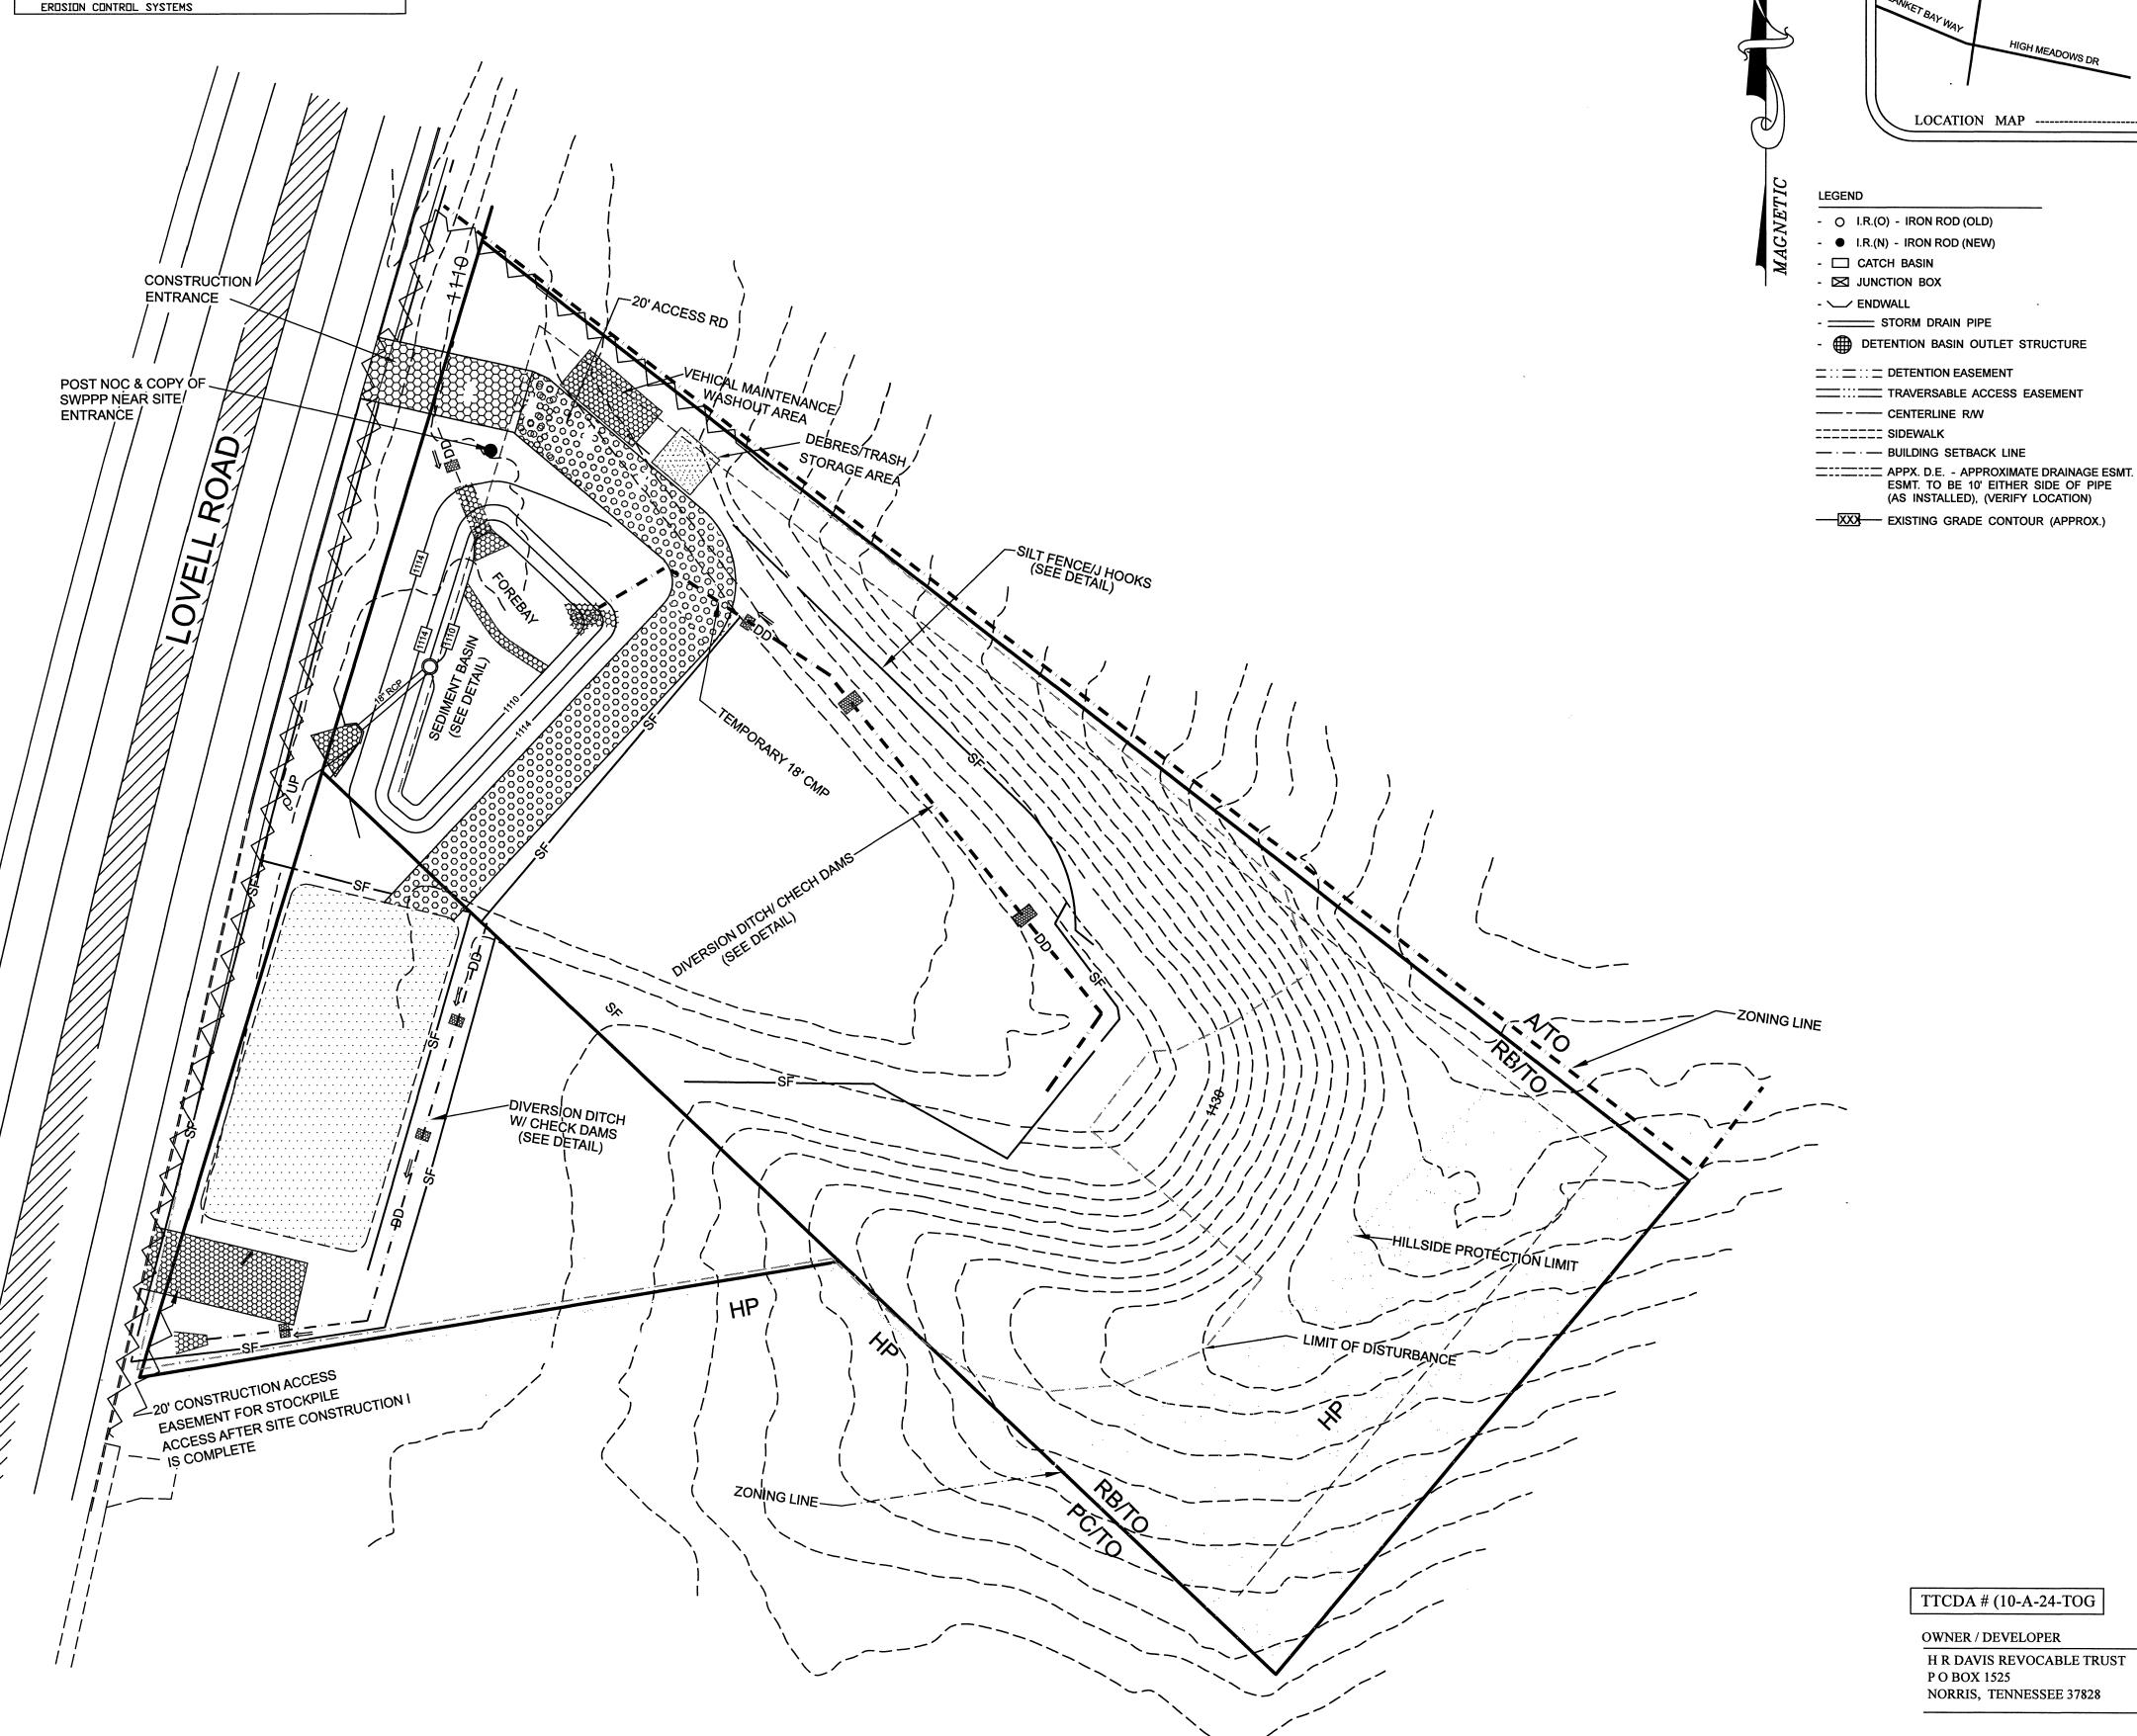

SITE UTILITIES

PROPOSED DISTURBED 2.31 ACRES EXISTING IMPERVIOUS AREA=0.08 ACRES DEVELOPED IMPERVIOUS AREA=0.63 ACRES INCREASE IN IMPERVIOUS AREA=0.63 ACRES

SANITARY SEWER FIRST UTILITY DISTRICT

ELECTRIC : LCUB GAS: K.U.B. TELEPHONE : BELLSOUTH CABLE : COMCAST

WATER : FIRST UTILITY DISTRICT

## SITE NOTES

1. CORNER MONUMENTS AS SHOWN HEREON

2. VERIFY EXACT SIZE, DEPTH AND LOCATION OF ALL UNDERGROUND UTILITIES PRIOR TO CONSTRUCTION.

3. 10' UTILITY AND DRAINAGE EASEMENT INSIDE ALL EXTERIOR BOUNDARY LINES, 5' EACH SIDE ALL INTERIOR LOT LINES, EXCEPT UNDER BUILDINGS.

4. DEED REFERENCE: INSTR. NO. 20221031 0026207 5. PROPERTY SHOWN ON MAP 118, GROUP H, C, PARCEL 545

6. PROPERTY ZONED: (RB) - GENERAL RESIDENTIAL

7. TOTAL AREA OF SUBDIVISION: 1.86 ACRES

8. TOTAL PROPOSED LOTS: 1

9. PROPERTY SUBJECT TO ALL APPLICABLE EASEMENTS, SETBACKS AND

RESTRICTIONS OF RECORD. 10. BEARINGS SHOWN HEREON ARE MAGNETIC AND NOT RELATED TO U.S.G.S. DATUM.

11. ALL LOTS TO HAVE ACCESS TO INTERNAL ROAD SYSTEM ONLY.

12. COMPACTION TESTING OF ROADWAY, TO BE PERFORMED AND INSPECTED IN ACCORDANCE WITH KNOX COUNTY REQUIREMENTS.

13. A PROP 20' DRAINAGE EASEMENT TO BE 10' EITHER SIDE OF STORM PIPES AS INSTALLED. 14. A PROP 15' UTILITY EASEMENT TO BE 7.5' EITHER SIDE OF WATER LINES AND SEWER LINES AS INSTALLED.

GRAPHIC SCALE

1 inch = 30 ft.

LeMAY AND ASSOCIATES\_\_\_ CONSULTING ENGINEERS

PH: 865-671-0183 FAX: 865-671-0213 10816 KINGSTON PIKE

- KNOXVILLE, TENNESSEE 37934

DIANAS VIEW


DISTRICT 6 \* KNOX COUNTY \* TENNESSEE PROPERTY SHOWN ON MAP 118 H, GROUP C, PARCEL 5 ADDRESS: 1316 LOVELL ROAD\* KNOXVILLE\* TENNESSEE

> 01-26-2024 | 04-22-2024 | 10-25-2024 |

INITIAL CONSTRUCTION GRADING PLAN

SCALE: 1" = 30'

DRAWING NUMBER

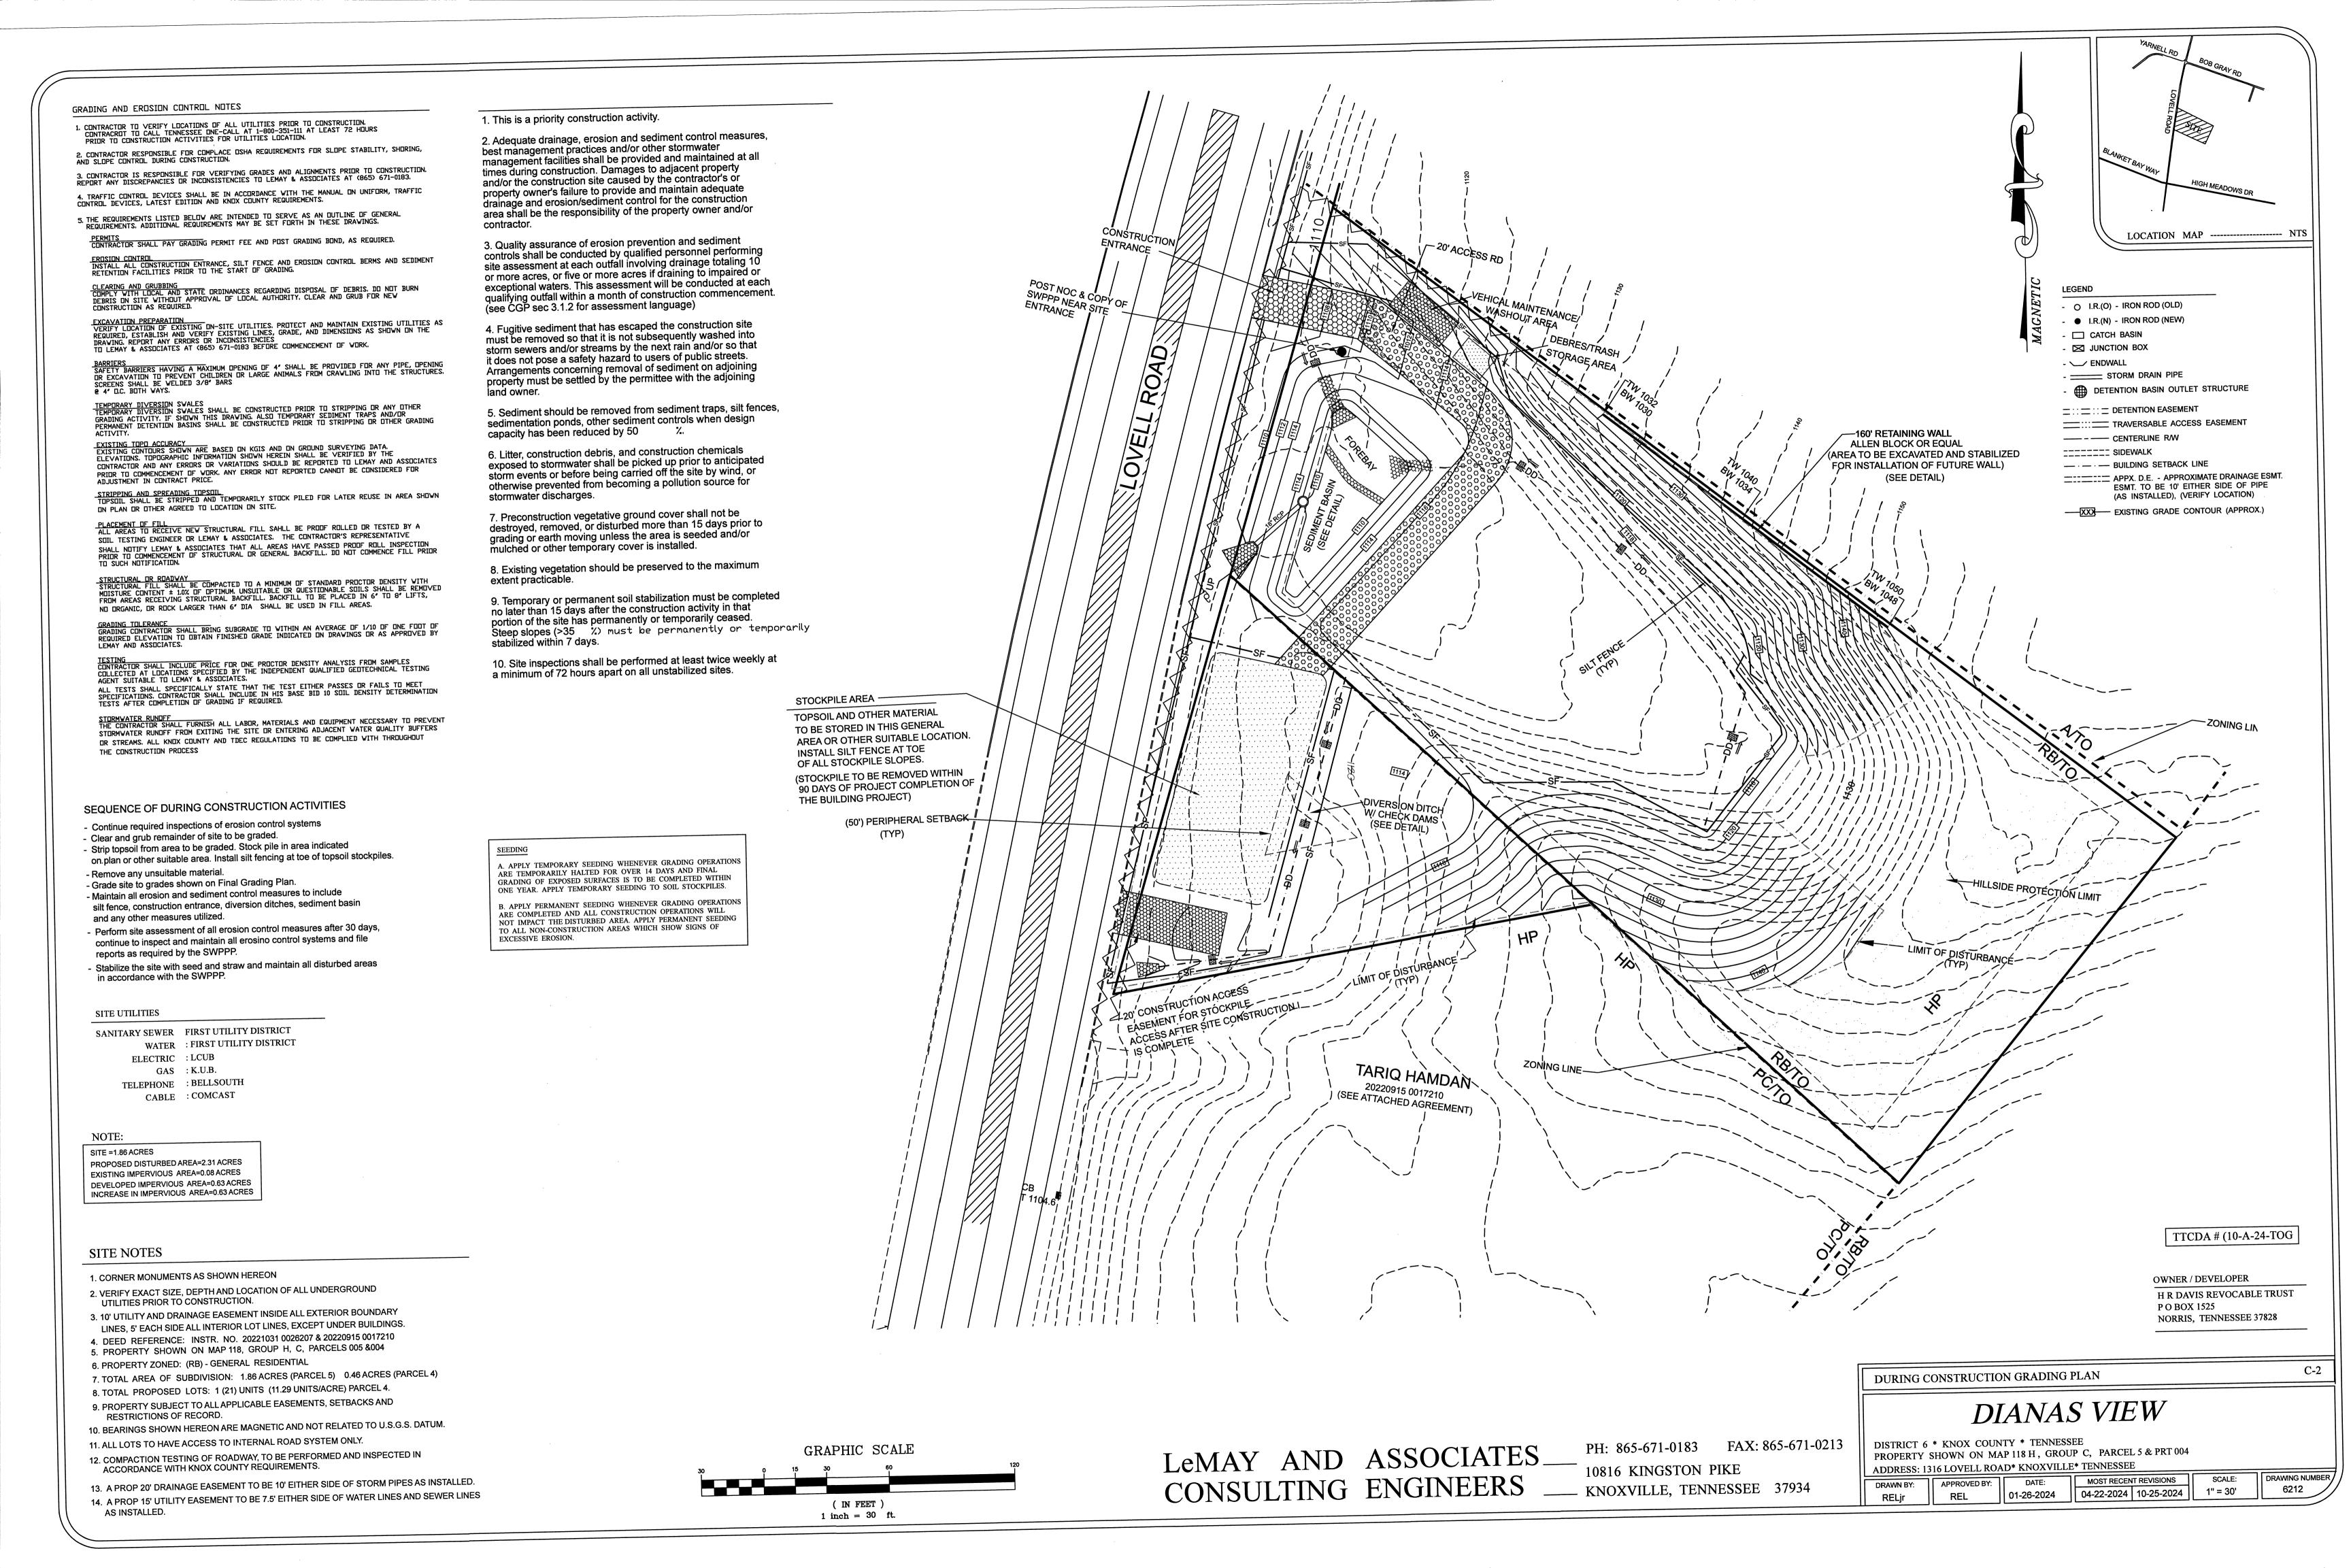

### Standard Notes:

- 1. This is a priority construction activity.
- 2. Adequate drainage, erosion and sediment control measures, best management practices and/or other stormwater management facilities shall be provided and maintained at all times during construction. Damages to adjacent property and/or the construction site caused by the contractor's or property owner's failure to provide and maintain adequate drainage and erosion/sediment control for the construction area shall be the responsibility of the property owner and/or
- 3. Quality assurance of erosion prevention and sediment controls shall be conducted by qualified personnel performing site assessment at each outfall involving drainage totaling 10 or more acres, or five or more acres if draining to impaired or exceptional waters. This assessment will be conducted at each qualifying outfall within a month of construction commencement. (see CGP sec 3.1.2 for assessment language)
- 4. Fugitive sediment that has escaped the construction site must be removed so that it is not subsequently washed into storm sewers and/or streams by the next rain and/or so that it does not pose a safety hazard to users of public streets. Arrangements concerning removal of sediment on adjoining property must be settled by the permittee with the adjoining
- 5. Sediment should be removed from sediment traps, silt fences, sedimentation ponds, other sediment controls when design capacity has been reduced by 50 %.
- 6. Litter, construction debris, and construction chemicals exposed to stormwater shall be picked up prior to anticipated storm events or before being carried off the site by wind, or otherwise prevented from becoming a pollution source for stormwater discharges.
- 7. Preconstruction vegetative ground cover shall not be destroyed, removed, or disturbed more than 15 days prior to grading or earth moving unless the area is seeded and/or mulched or other temporary cover is installed.
- 8. Existing vegetation should be preserved to the maximum extent practicable.
- 9. Temporary or permanent soil stabilization must be completed no later than 15 days after the construction activity in that portion of the site has permanently or temporarily ceased. Steep slopes (>35%) must be permanently or temporarily stabilized within 7 days.
- 10. Site inspections shall be performed at least twice weekly at a minimum of 72 hours apart on all unstabilized sites.

- A. APPLY TEMPORARY SEEDING WHENEVER GRADING OPERATIONS ARE TEMPORARILY HALTED FOR OVER 14 DAYS AND FINAL GRADING OF EXPOSED SURFACES IS TO BE COMPLETED WITHIN ONE YEAR. APPLY TEMPORARY SEEDING TO SOIL STOCKPILES.
- B. APPLY PERMANENT SEEDING WHENEVER GRADING OPERATIONS ARE COMPLETED AND ALL CONSTRUCTION OPERATIONS WILL NOT IMPACT THE DISTURBED AREA. APPLY PERMANENT SEEDING TO ALL NON-CONSTRUCTION AREAS WHICH SHOW SIGNS OF EXCESSIVE EROSION.

## SITE UTILITIES

SANITARY SEWER FIRST UTILITY DISTRICT WATER : FIRST UTILITY DISTRICT

ELECTRIC : LCUB GAS : K.U.B. TELEPHONE : BELLSOUTH CABLE : COMCAST

## SITE NOTES


- 1. CORNER MONUMENTS AS SHOWN HEREON
- 2. VERIFY EXACT SIZE, DEPTH AND LOCATION OF ALL UNDERGROUND UTILITIES PRIOR TO CONSTRUCTION.
- 3. 10' UTILITY AND DRAINAGE EASEMENT INSIDE ALL EXTERIOR BOUNDARY LINES, 5' EACH SIDE ALL INTERIOR LOT LINES, EXCEPT UNDER BUILDINGS.
- 4. DEED REFERENCE: INSTR. NO. 20221031 0026207 & 20220915 0017210 5. PROPERTY SHOWN ON MAP 118, GROUP H, C, PARCELS 005 &004
- 6. PROPERTY ZONED: (RB) GENERAL RESIDENTIAL
- 7. TOTAL AREA OF SUBDIVISION: 1.86 ACRES (PARCEL 5) 0.46 ACRES (PARCEL 4)
- 8. TOTAL PROPOSED LOTS: 1 (21) UNITS (11.29 UNITS/ACRE) PARCEL 4. 9. PROPERTY SUBJECT TO ALL APPLICABLE EASEMENTS, SETBACKS AND
- RESTRICTIONS OF RECORD. 10. BEARINGS SHOWN HEREON ARE MAGNETIC AND NOT RELATED TO U.S.G.S. DATUM.
- 11. ALL LOTS TO HAVE ACCESS TO INTERNAL ROAD SYSTEM ONLY.
- 12. COMPACTION TESTING OF ROADWAY, TO BE PERFORMED AND INSPECTED IN

ACCORDANCE WITH KNOX COUNTY REQUIREMENTS.

- 13. A PROP 20' DRAINAGE EASEMENT TO BE 10' EITHER SIDE OF STORM PIPES AS INSTALLED. 14. A PROP 15' UTILITY EASEMENT TO BE 7.5' EITHER SIDE OF WATER LINES AND SEWER LINES AS INSTALLED.
- 15. A PLAT TO BE RECORDED REFLECTING ALL REQUIRED EASEMENTS.

SEQUENCE OF DURING CONSTRUCTION ACTIVITIES

- Continue required inspections of erosion control systems - Stabilize with seed and straw and continue maintenance
- of disturbed areas. - File Notice of Termination once site is stabilized.

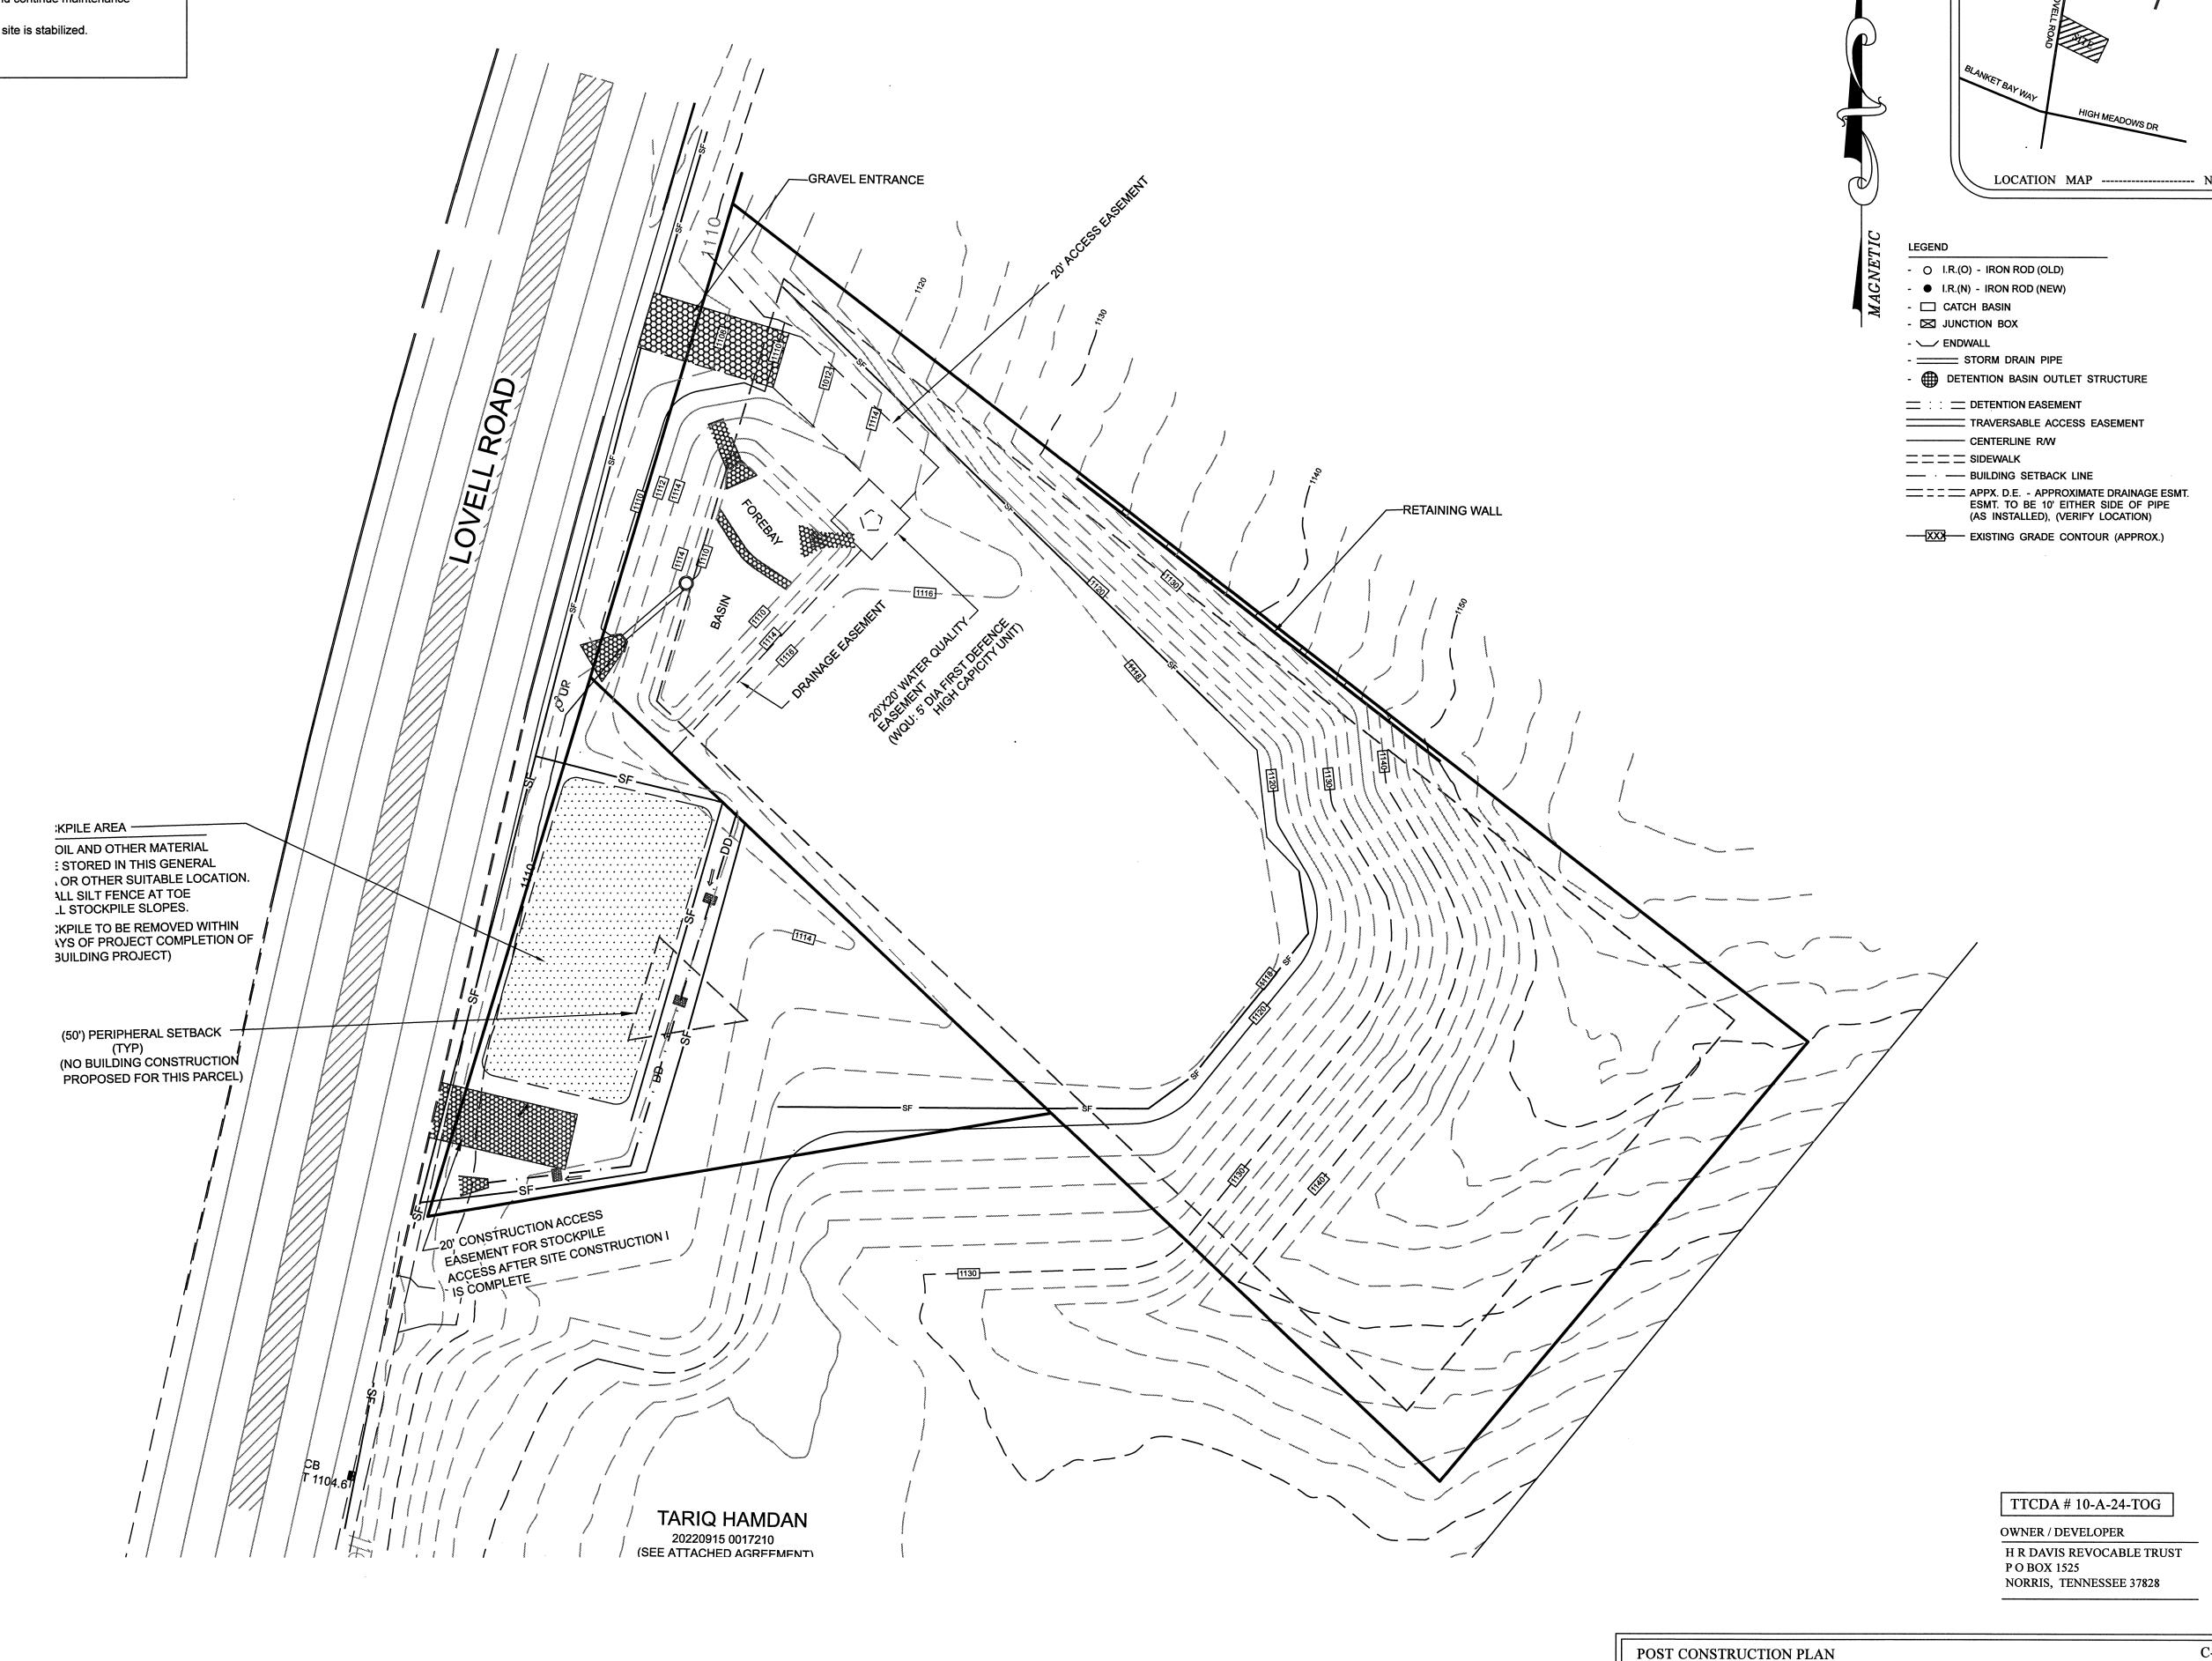

LeMAY AND ASSOCIATES\_

1 inch = 30 ft.

CONSULTING ENGINEERS \_\_\_\_ KNOXVILLE, TENNESSEE 37934

DIANAS VIEW

MOST RECENT REVISIONS

07-14-2024 10-25-2024

DRAWING NUMBER

1" = 30'

DISTRICT 6 \* KNOX COUNTY \* TENNESSEE

APPROVED BY:


PROPERTY SHOWN ON MAP 118 H, GROUP C, PARCEL 5 & 4


ADDRESS: 1316 & 1308 LOVELL ROAD\* KNOXVILLE\* TENNESSEE


02-26-2024


PH: 865-671-0183 FAX: 865-671-0213


10816 KINGSTON PIKE

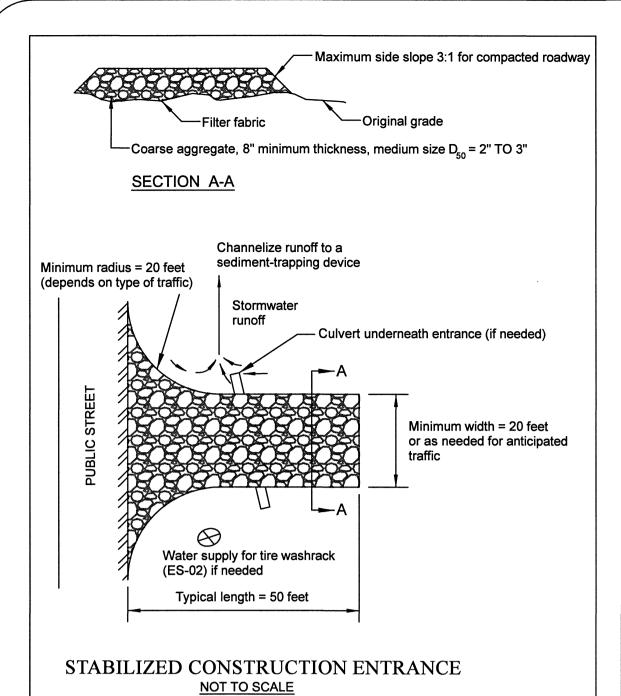


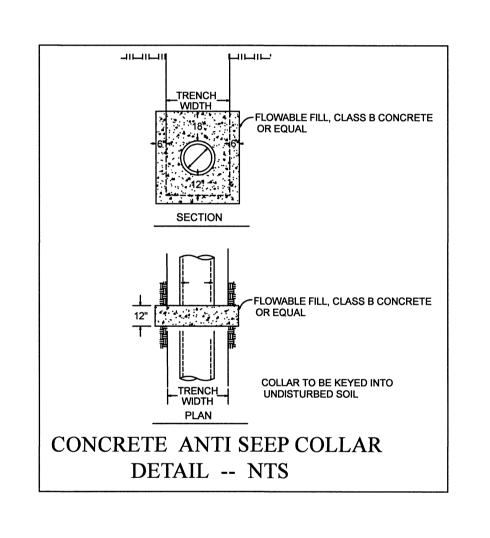


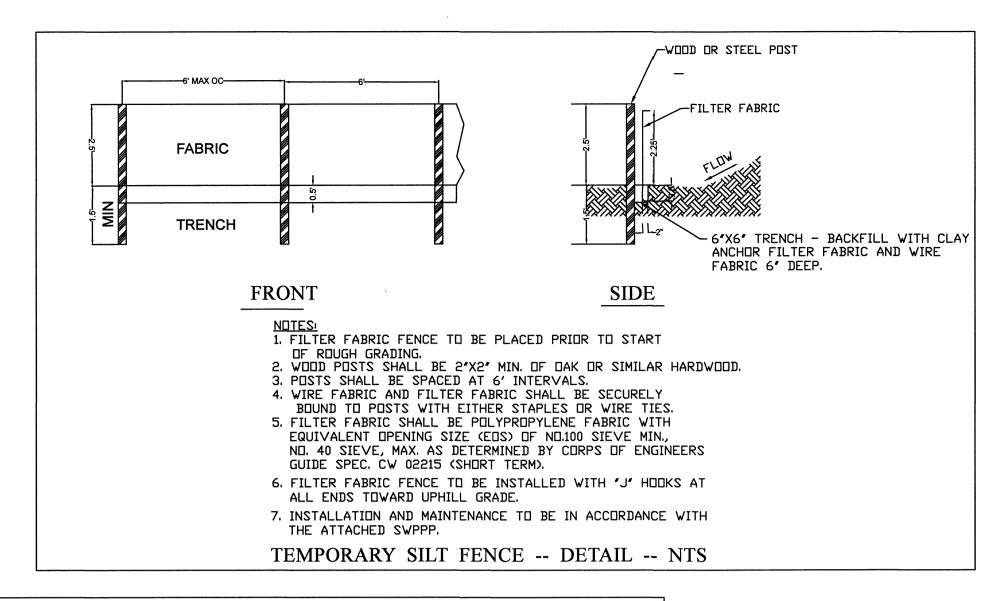


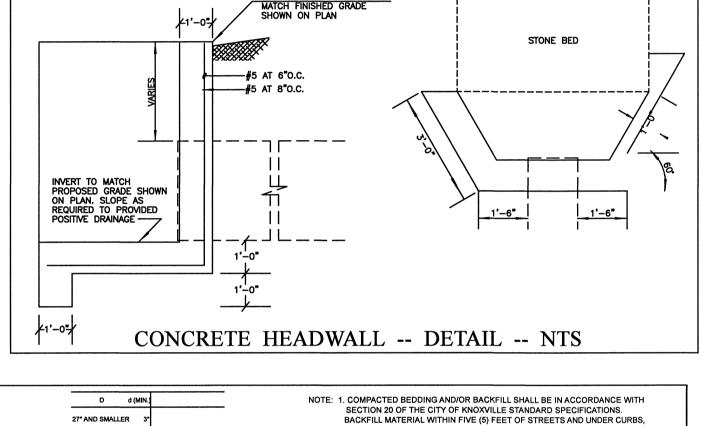


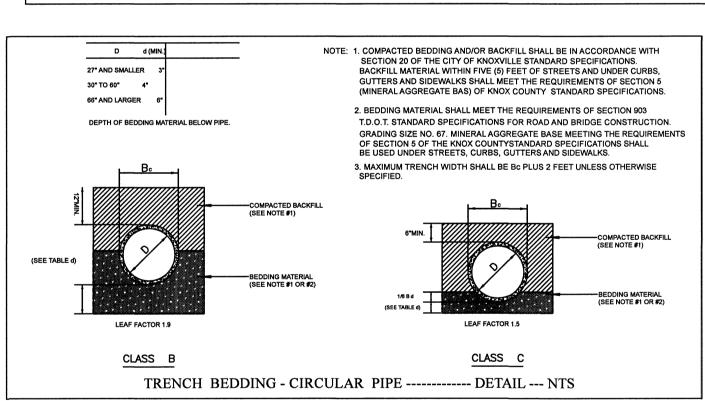


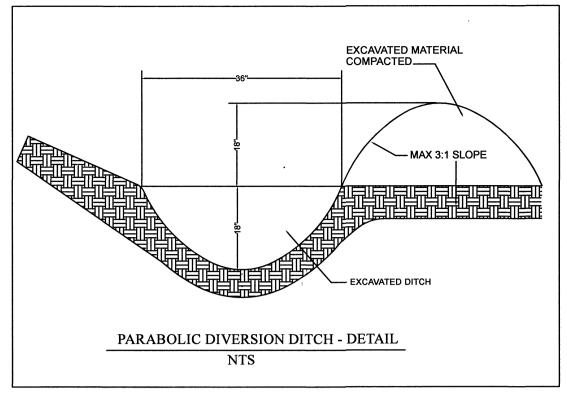


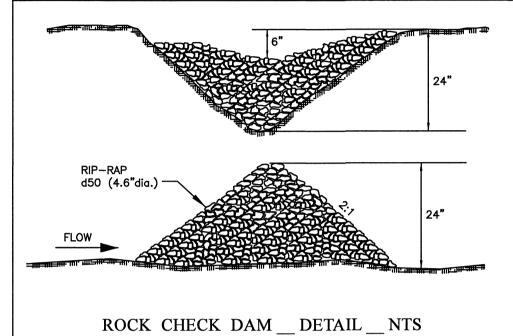


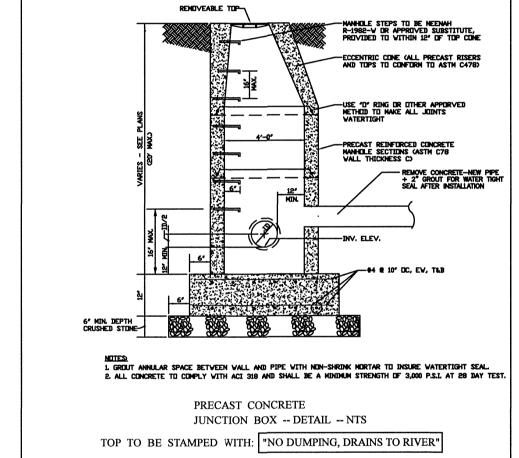


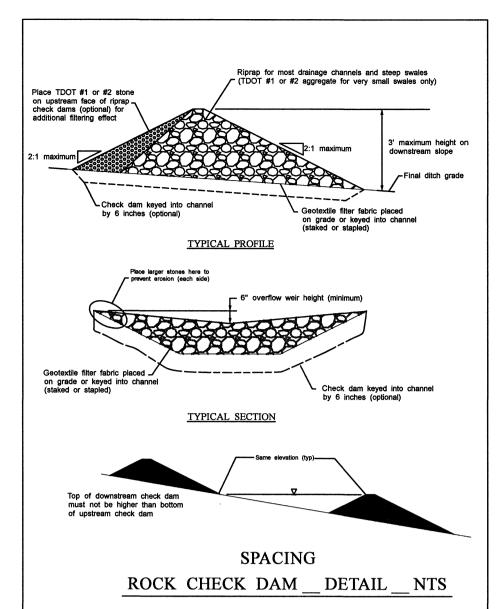


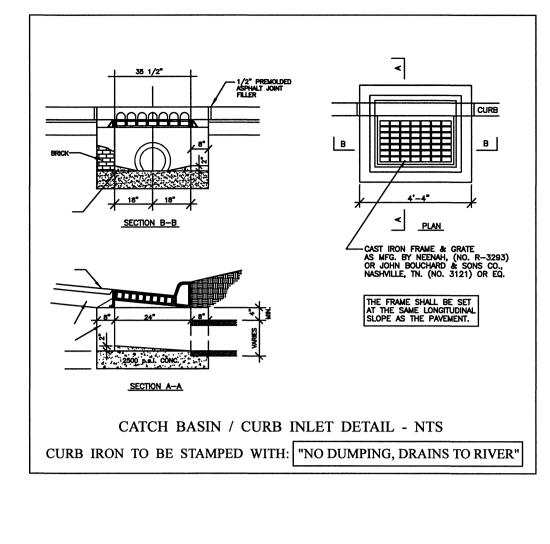

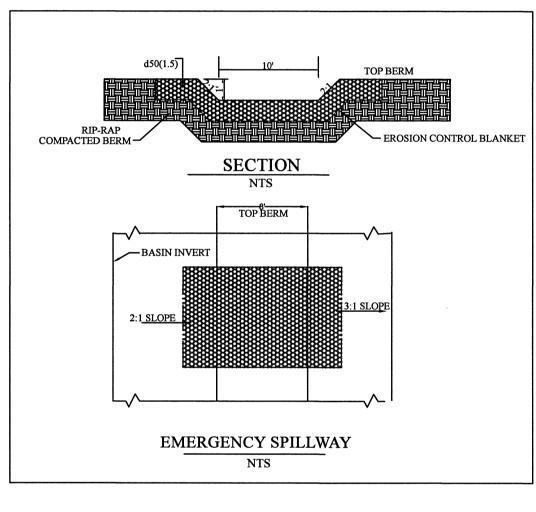

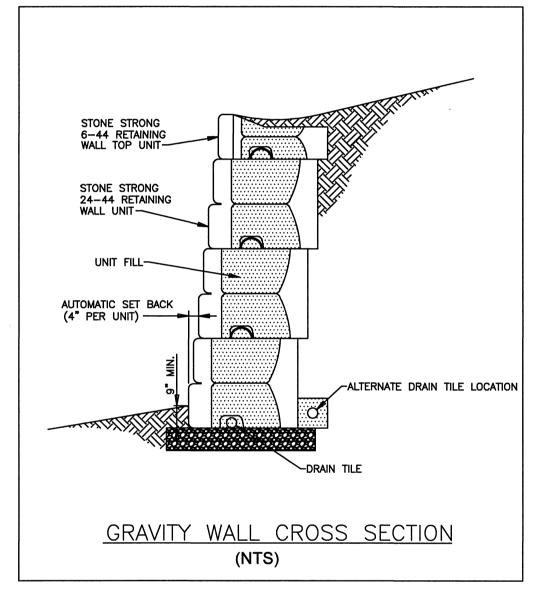


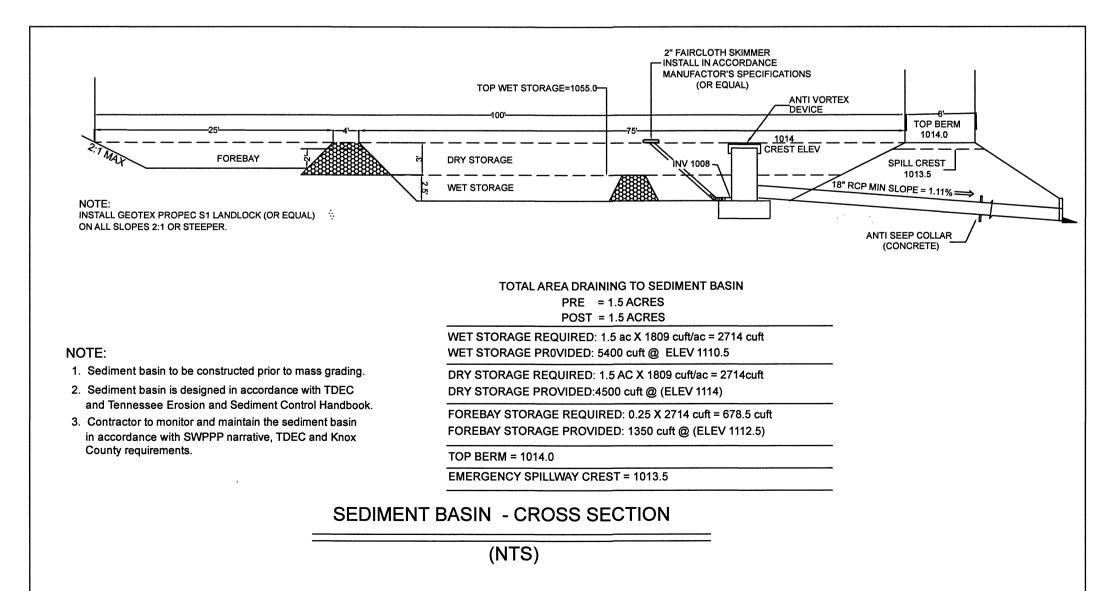

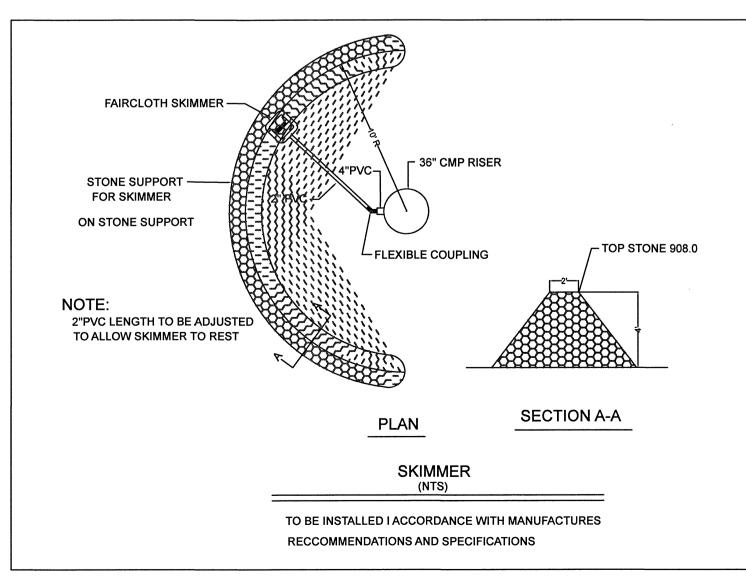

BASIN RISER W/ANTI-VORTEX DEVICE

(VERIFY ELEVATIONS PRIOR TO CONSTRUCTION OF RISER)

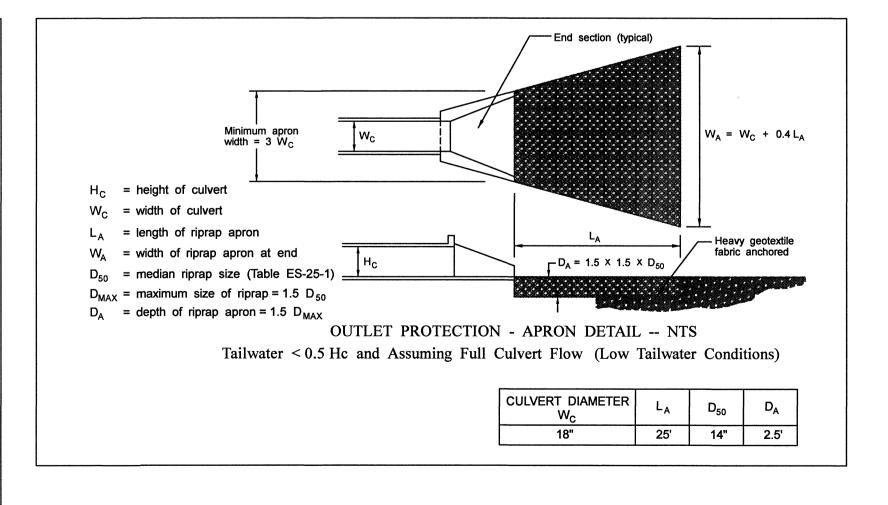

OWNER / DEVELOPER H R DAVIS REVOCABLE TRUST P O BOX 1525 NORRIS, TENNESSEE 37828

LeMAY AND ASSOCIATES\_ CONSULTING ENGINEERS

PH: 865-671-0183 FAX: 865-671-0213 10816 KINGSTON PIKE — KNOXVILLE, TENNESSEE 37934

**SWPPP DETAILS** DIANAS VIEW DISTRICT 6 \* KNOX COUNTY \* TENNESSEE PROPERTY SHOWN ON MAP 118 H, GROUP C, PARCEL 5 ADDRESS: 1316 LOVELL ROAD\* KNOXVILLE\* TENNESSEE MOST RECENT REVISIONS

SCALE: 02-26-2024 6212 07-24-2024

DRAWING NUMBER /