



. The contractor is specifically cautioned that the location and/or elevation of existing utilities as shown on these plans is based on records and where possible measurements taken in the field. This information is not to be relied upon as being exact or complete. The contractor must call Tennessee One Call and any utility that does not subscribe to One Call at least 72 hours before any excavation, to request exact field location of the utilities. It shall be the responsibility of the contractor to relocate all existing utilities which conflict with the proposed improvements shown on

Knoxville, Tennessee 37931

- Land Development Solutions 310 Simmons Road, Suite K
- 4. Property is located in Knox County and is zoned BP & TO.
- 6. TTCDA approved church parking, meeting date12/06/2010, 1247 total spaces Operations Building Parking - 108 Spaces (including 2 accessible)
- 7. Ground Area Coverage (GAC) = 80,119 sf / 2,613,600 sf = 3.1% < 25%
- 8. Floor Area Ratio (FAR) = 124,702 sf / 2,613,600 sf = 4.8% < 30%
- 9. Impervious Area Ratio (IAR) = 725,836 sf / 2,616,600 sf = 27.7% < 70%




Review						
Drawn By	CDE					
Checked	EJE					
Ammunical						

218131

Use

on

Site

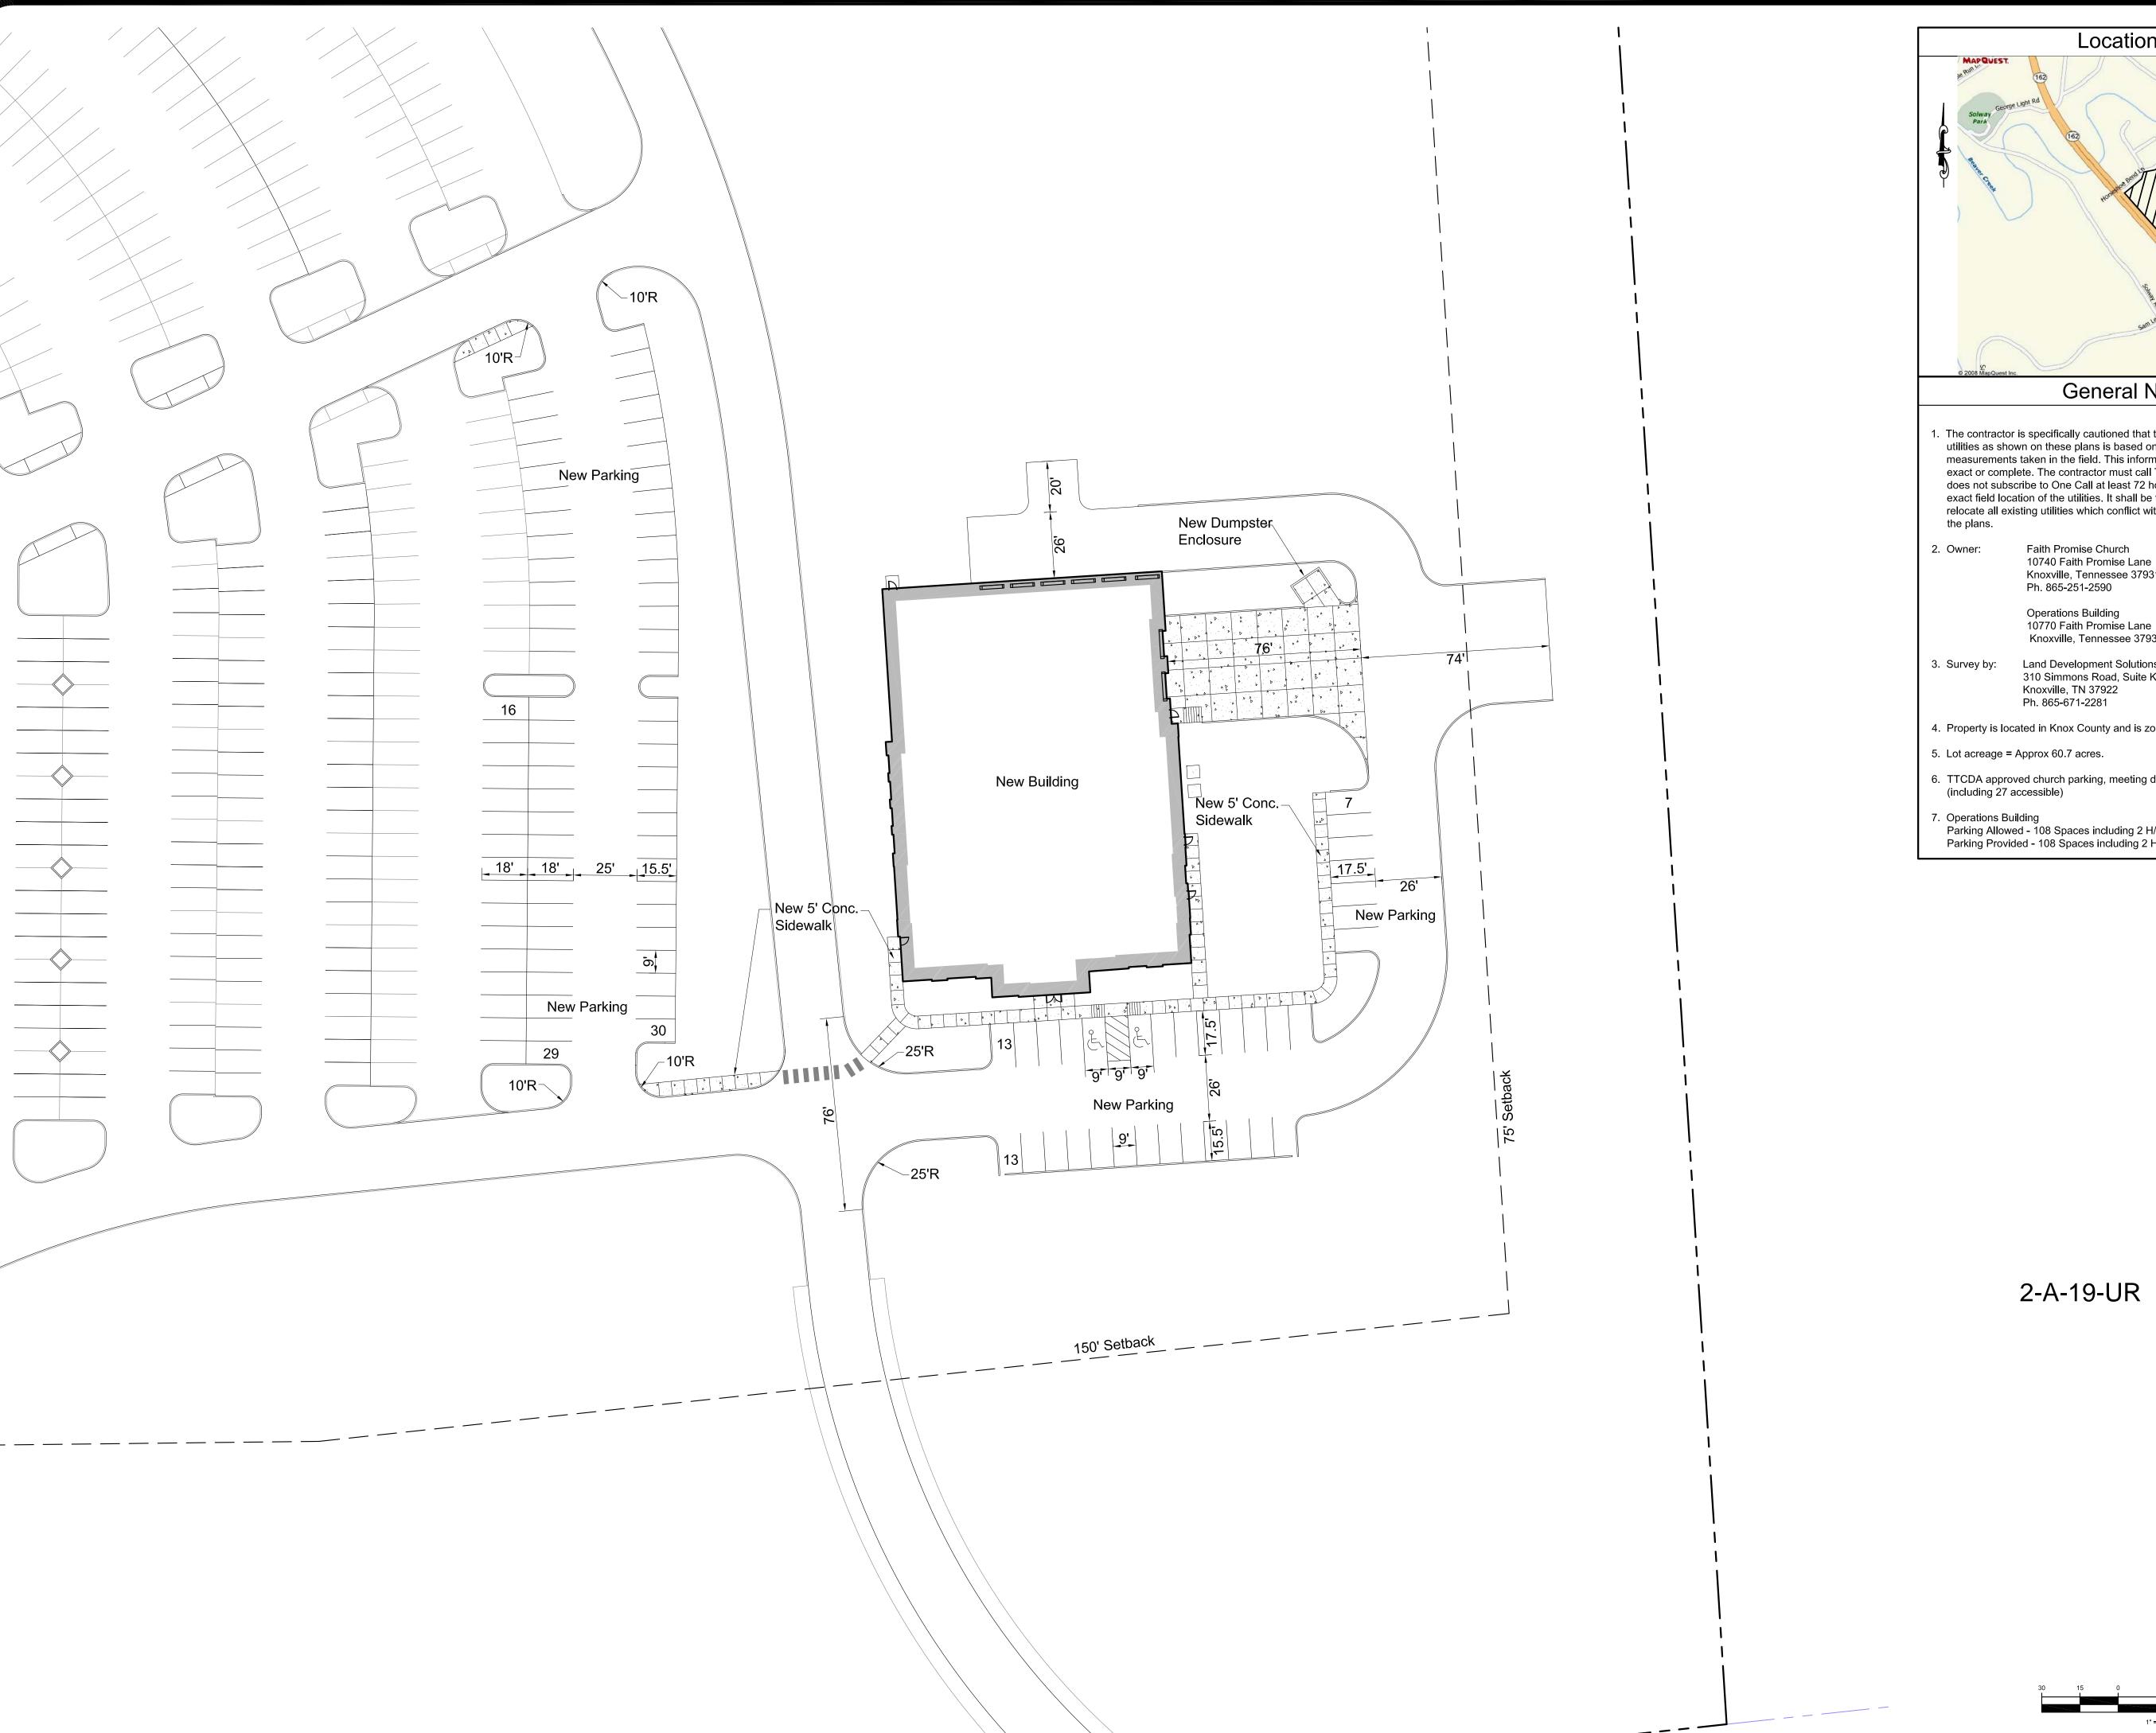



## **General Notes**

- 1. The contractor is specifically cautioned that the location and/or elevation of existing utilities as shown on these plans is based on records and where possible measurements taken in the field. This information is not to be relied upon as being exact or complete. The contractor must call Tennessee One Call and any utility that does not subscribe to One Call at least 72 hours before any excavation, to request exact field location of the utilities. It shall be the responsibility of the contractor to relocate all existing utilities which conflict with the proposed improvements shown on
- Faith Promise Church 10740 Faith Promise Lane
  - Knoxville, Tennessee 37931 Ph. 865-251-2590 Operations Building
  - Knoxville, Tennessee 37931 Land Development Solutions 310 Simmons Road, Suite K
- 4. Property is located in Knox County and is zoned BP & TO.
- 5. Lot acreage = Approx 60.7 acres.
- TTCDA approved church parking, meeting date12/06/2010, 1247 total spaces (including 27 accessible)
- Parking Allowed 108 Spaces including 2 H/C spaces Parking Provided - 108 Spaces including 2 H/C spaces

2-A-19-UR




Use on Review

Building yout

Operations E Site Lay

Drawn By	CDB
Checked	EJB
Approved	EJB
Job No.	218131
1"=30' Scale	11-29-18 Date

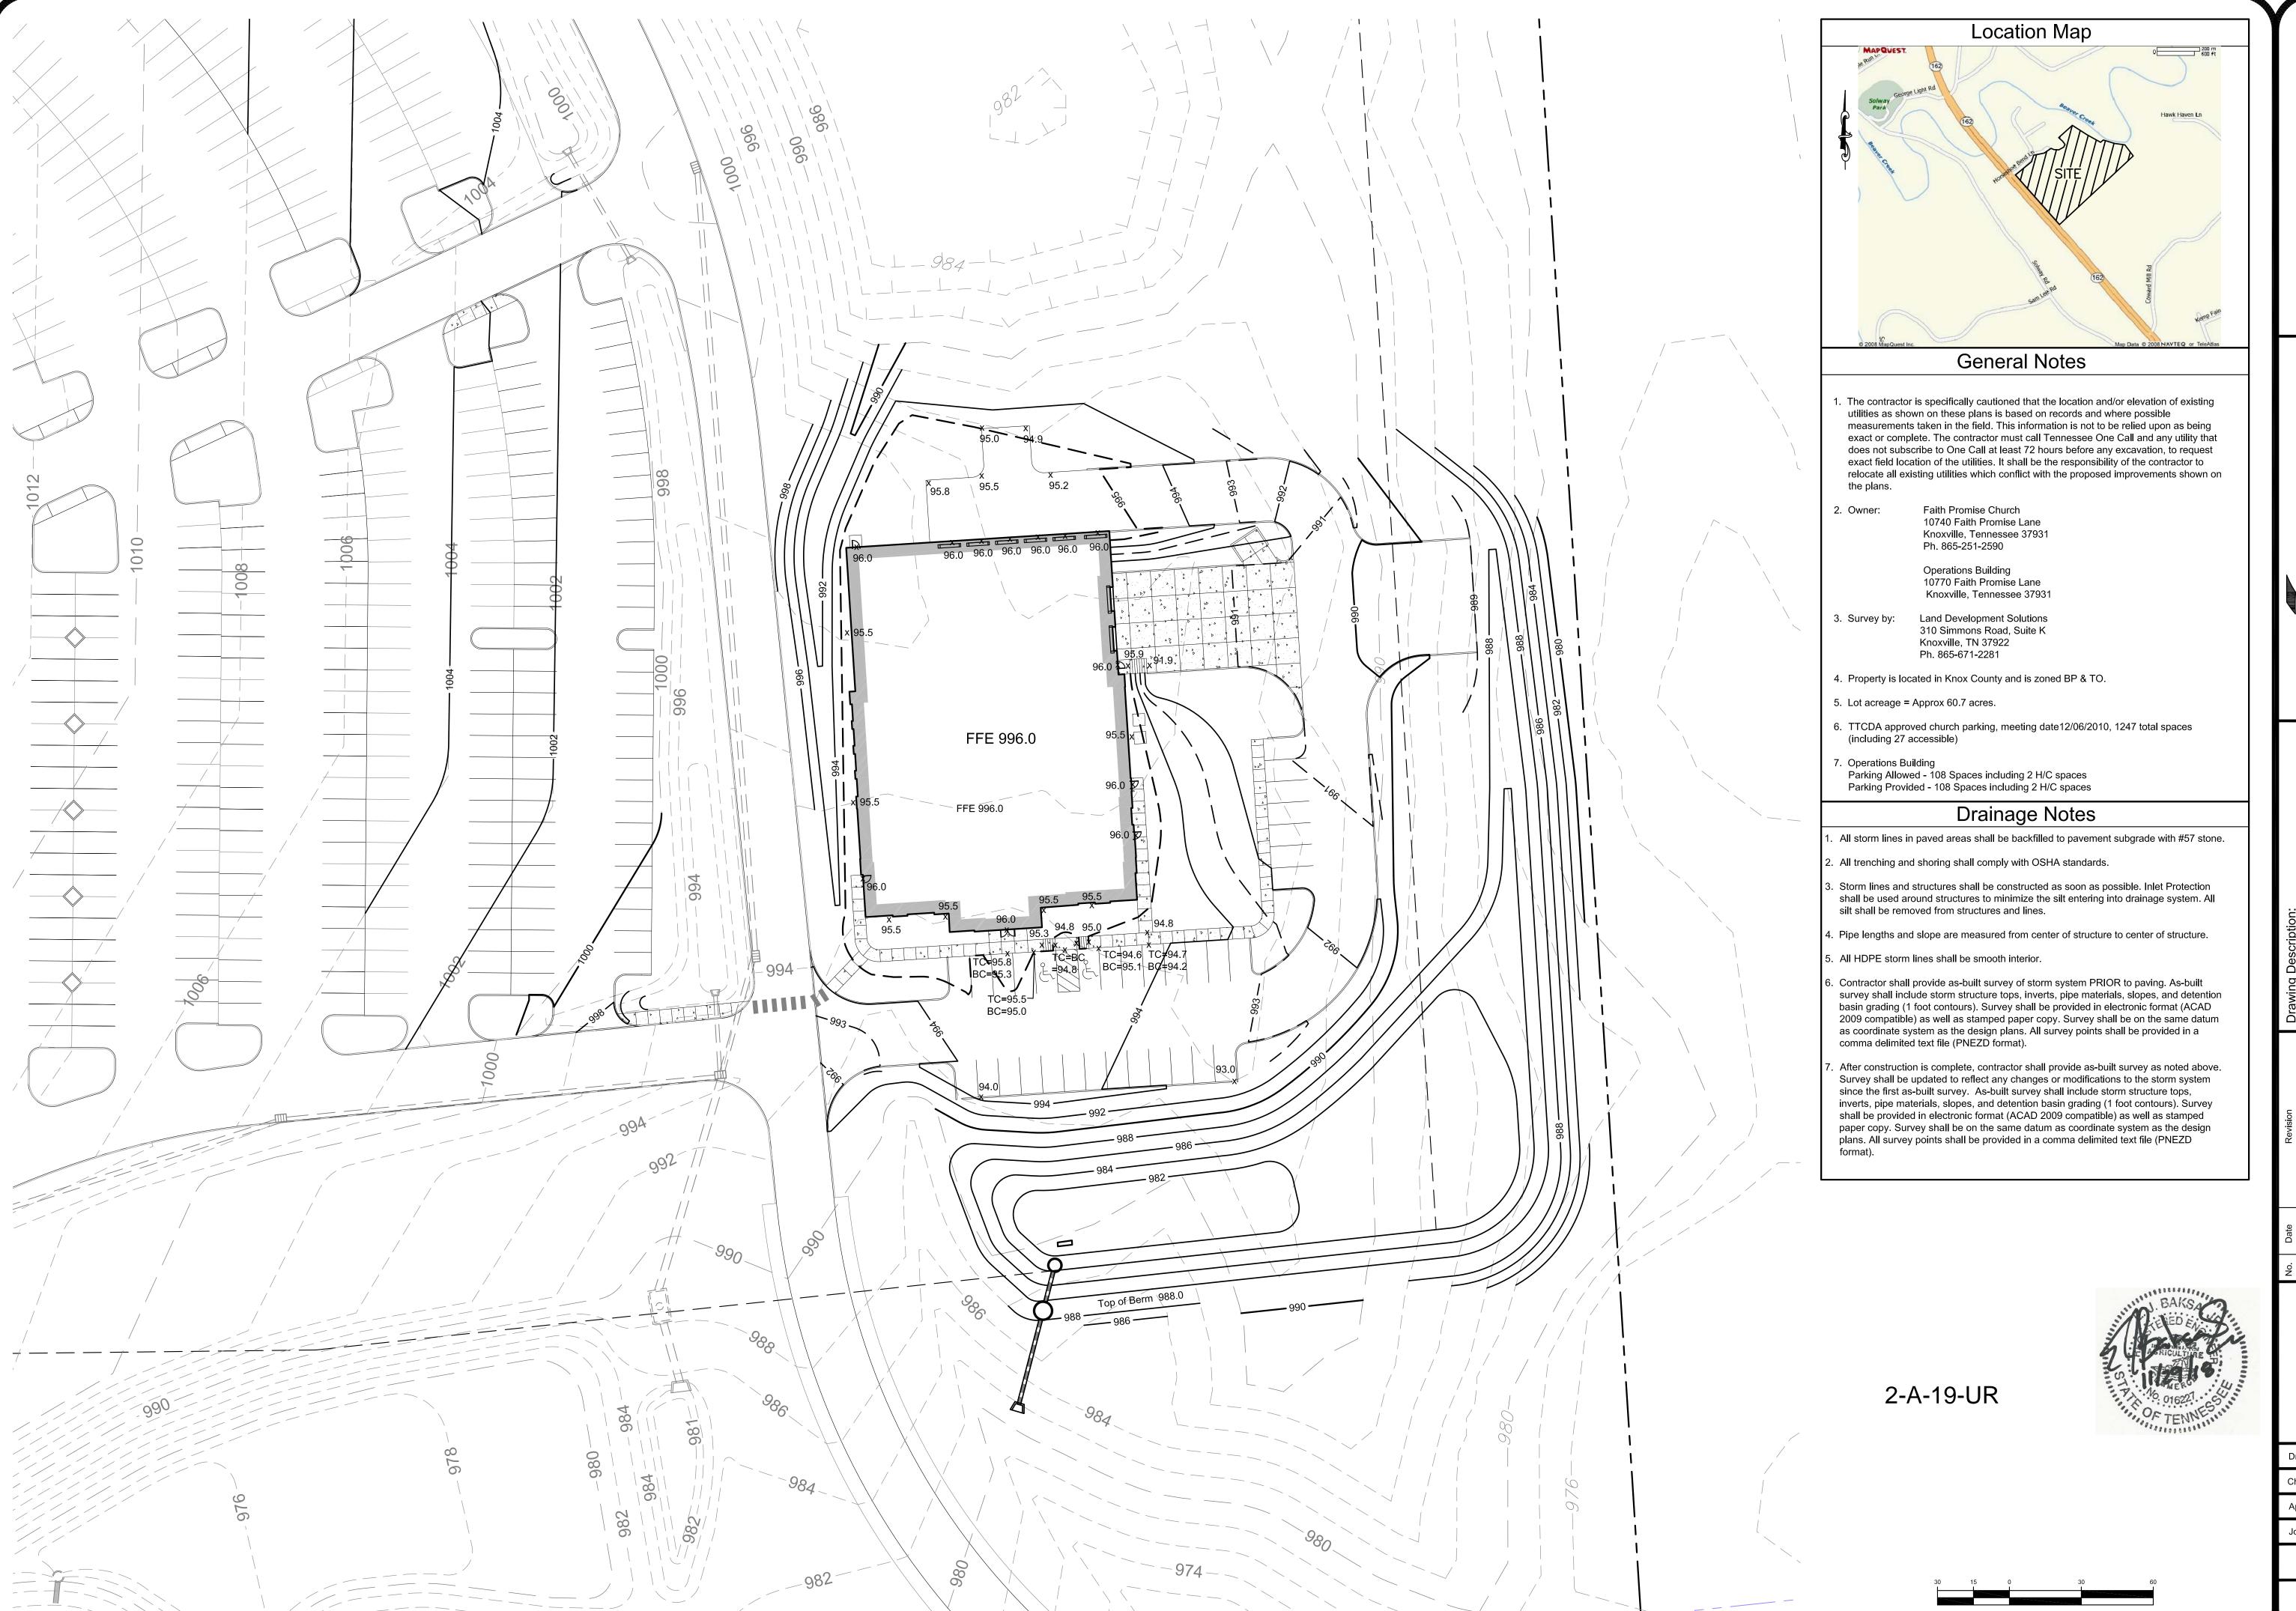

) faith promise

DEVELOPM. SOLUTIONS

Operations Building Site Grading

Revision Dr.

No. Date

Use on Review

Drawn By

CDB

Checked

EJB

Approved

EJB

Job No.

218131

1"=30'

Scale

Date

C201

## **Planting Requirement Notes**

- This plan meets and exceeds the requirements as described under the TTCDA, section 3, 'Landscaping' requirements.
  - 3.1.4 requires 25% newly planted trees to be evergreen. This plan provides (14) trees of which (4) are evergreen, achieving 29% evergreen trees.
  - 3.1.5 requires 10 large maturing trees per 1 acre of yard. There is approximately 56,049 square feet (1.29 acres) of yard. 10 x .56 = 12.9 required large trees. This plan proposes (14) large trees (5 Willow Oak, 1 Lacebardk Elm, 4 London Plane Tree, and 4 Magnolia).
  - 3.1.6, no invasive exotic species have been proposed
  - 3.3.6 requires landscaping to screen mechanical units. Sufficicient landscape screening has been proposed and labeled.
  - 3.4.1, no parking areas are adjacent to public right of ways
  - 3.4.3 requires (1) tree per (10) parking spaces. There are 108 proposed parking spaces.  $\frac{108}{10}$  = 10.8 trees required. This plan provides (14) trees, only 11 required.
  - 3.4.4 requires no less than 5% of the surface area devoted to parking to be landscaped. The proposed parking are is approximately 29,155 square feet. 5% of 29,155 = 1457 square feet. This plan provides approximately 3,463 square feet of shrubbery and bedding plants, and approximately 52,586 square feet of lawn adjacent to the parking area and building.
  - 3.4.5, all proposed tree species are included in the recommended tree list (Appendix B)
- 3.3.7 requires that no parking space be located more than 60 feet from the trunk of a larger canopy tree. See note on plan. All proposed parking spaces are within 60' of a large tree.
- There are no existing trees on site.

2-A-19-UR



**STUDIO FOUR DESIGN**<sup>§</sup>

414 Clinch Ave. Knoxville, TN 37902

**ARCHITECTURE & INTERIORS** 

Faith Promise
Operations Building
10740 Faith Promise Ln
Knoxville, TN 37931

Project Phase: TTCDA Issue Date: 12/03/18 No. Descripton add screening for MU 12/21/18 and dumpster areas

18107.00 Job Number: **Landscape Plan** 

L1.0

(36) Itea virginica 'Sprich', LIttle Henry Itea (4) Lagerstroemia indica x fauriei 'Natchez', Natchez Crape Myrtle (4) Platanus x acerifolia, London Plane Tree (2) Cercis canadensis 'JN2', The Rising Sun Redbud (14) Rosa 'Meigalpio', Drift Rose, pink - 2" caliper - 3 gallon (8) Ilex x Nellie R. Stevens, Nellie R. Stevens Holly (1) Ulmus parvifolia, Lacebark Elm (10) Ilex glabra 'Shamrock', Inkberry Holly

(24) Jasminum nudiflorum, Winter Jasmine

- 3 gallon

- 3 gallon

(55) Liriope muscari 'Royale Purple', Royal Purple Lily Turf

Planting Legend


(4) Pinus strobus, White Pine

TREE PLANTING

N.T.S.

ARBORTIE TAPE MULCH -CROWN OF ROOTBALL (ABOVE FINISHED GRADE) WOODEN STAKE ----FINISHED GRADE LOOSENED TOPSOIL COMPACTED — EARTH SAUCER

PINE OR SMALL N.T.S. TREE PLANTING

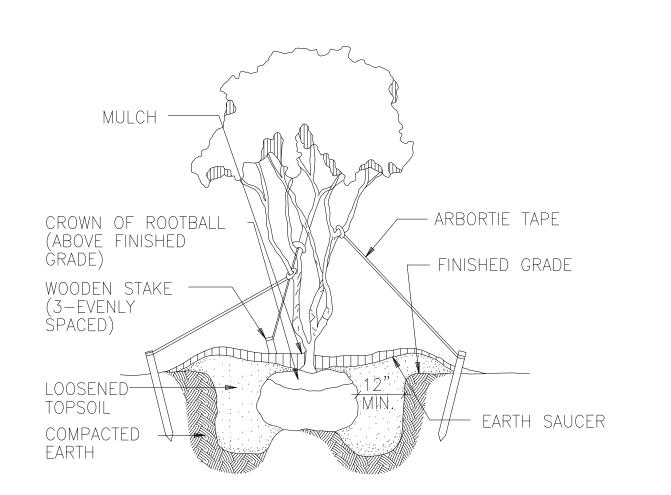

**MULTI-TRUNK** TREE PLANTING

N.T.S.

SUBGRADE LOOSENED TOPSOIL 1 PLAN FOR SPACING. (STAGGERED ROWS)

SHRUB PLANTING N.T.S.

TRENCH EDGER

SET CROWN OF SHRUB ABOVE

FINSHED GRADE

FINISHED

COMPACTED

GRADE

MULCH -

# PLANTING NOTES

### SECTION I : GENERAL

CONTRACTOR SHALL BE RESPONSIBLE FOR THE SITE INSPECTION PRIOR TO LANDSCAPE CONSTRUCTION AND INSTALLATION IN ORDER TO ACQUAINT HIMSELF WITH EXISTING CONDITIONS. CONTRACTOR SHALL BE RESPONSIBLE FOR LOCATING ALL EXISTING UNDERGROUND UTILITIES BEFORE BEGINNING CONSTRUCTION. PRIOR TO SUBMITTING A BID, VERIFY ANY DISCREPANCIES BETWEEN THE NOTES, SPECIFICATIONS, DRAWINGS, OR SITE CONDITIONS WITH THE LANDSCAPE ARCHITECT.

CONTRACTOR SHALL COMPLETE SOIL TEST IN ALL PLANTING AREAS TO DETERMINE SOIL AMENDMENT REQUIREMENTS AND SUBMIT TEST RESULTS TO LANDSCAPE ARCHITECT FOR APPROVAL. CONTRACTOR SHALL ADJUST PH AND FERTILITY BASED UPON THESE RESULTS. NO ADDITION TO OR PLACEMENT OF SOIL IS TO BE DONE PRIOR TO INITIAL SOIL TEST REPORT APPROVAL. TESTING SHALL BE DONE BY SUITABLE LABORATORY. NO PLANTING SHALL BEGIN UNTIL RESULTS AND PROPER ADJUSTMENT HAVE BEEN

SOME TREES AND SPECIMEN PLANT MATERIAL MAY BE SUPPLIED BY OWNER. VERIFY WITH OWNER.

CONTRACTOR SHALL LAYOUT TREES AND BED LINES FOR PLANTS FOR REVIEW BY LANDSCAPE ARCHITECT PRIOR TO PLANTING. A MINIMUM 24 HOURS NOTICE SHOULD BE GIVEN AND ANTICIPATED BY THE CONTRACTOR FOR THIS REVIEW.

DUE TO EXISTING VEGETATION AND OTHER SITE CONDITIONS, THE CONTRACTOR SHOULD ANTICIPATE FIELD ADJUSTMENTS BY THE LANDSCAPE ARCHITECT.

CONTRACTOR SHALL GUARANTEE ALL PLANT MATERIAL FOR ONE FULL YEAR (SOD 60 DAYS) FROM DATE OF FINAL ACCEPTANCE.

LANDSCAPE CONTRACTOR RESPONSIBLE FOR VERIFYING PLANT QUANTITY TAKE OFFS.

## SECTION II : MATERIALS

PLANTS SHALL BE WELL FORMED, VIGOROUS, GROWING SPECIMENS WITH GROWTH TYPICAL OR VARIETIES SPECIFIED AND SHALL BE FREE FROM INJURY, INSECTS AND DISEASEES. PLANTS SHALL EQUAL OR SURPASS #1 QUALITY AS DEFINED IN THE CURRENT ISSUE OF "AMERICAN STANDARDS FOR NURSERY STOCK" AS PUBLISHED BY THE AMERICAN NURSERYMEN, INC.

ALL PLANT MATERIALS ARE SUBJECT TO APPROVAL OR REFUSAL BY THE LANDSCAPE ARCHITECT AT THE JOB SITE. ALL MATERIAL REJECTED SHALL BE REMOVED FROM THE PROJECT SITE AT NO ADDITIONAL COST TO THE OWNER.

ALL PLANT MATERIAL IS TO BE CAREFULLY HANDLED BY THE ROOT BALL, NOT THE TRUNK, BRANCHES, AND/OR FOILAGE OF THE PLANT. MISHANDLED PLANT MATERIAL MAY BE REJECTED.

ALL PLANT MATERIAL IS TO BE WELL ROOTED, NOT ROOT BOUND, SUCH THAT THE ROOT BALL REMAINS INTACT THROUGHOUT THE PLANTING PROCESS. REJECT ALL CRACKED ROOTBALLS.

## SECTION III : EXECUTION

ALL TREES SHALL BE STAKED AND GUYED ON THREE SIDES. SEE DETAIL. BACK ROW OF SHRUBS SHALL BE PLANTED AT 36" FROM FACE OF BUILDING WALL, GROUNDCOVERS SHALL BE 12" OUT FROM BUILDING AS REQUIRED BY


FRONT ROW OF SHRUBS SHALL BE PLANTED A MINIMUM OF 24" BEHIND (12" FOR GROUND COVER) BED LINE @ LAWNS OR WALKS AND MINIMUM 36" BACK FROM DRIVEWAY AND PARKING AREAS.

CONTRACTOR SHALL BE RESPONSIBLE FOR PROVIDING 2% MINIMUM POSITIVE DRAINAGE IN ALL PLANT AREAS. ALL PLANTING BEDS AND TREE PITS SHALL BE MULCHED WITH A 3" (AFTER SETTLEMENT) LAYER OF PINE STRAW.

EXCAVATE EDGE OF ALL PLANTING BEDS TO 2" DEPTH TO FORM A NEAT CRISP DEFINITION. SEE DETAIL.


CONTRACTOR SHALL REMOVE ALL DEBRIS AND FINE GRADE ALL AREAS FOR APPROVAL BY LANDSCAPE ARCHITECT. REMOVE ALL GUY WIRES AND STAKES AT END OF GUARANTEE PERIOD. ADDITIONAL NOTES

ALL PROPOSED LANDSCAPE WILL BE MAINTAINED BY A PROFESSIONAL LANDSCAPE MAINTENANCE COMPANY TO BE SELECTED BY OWNER.

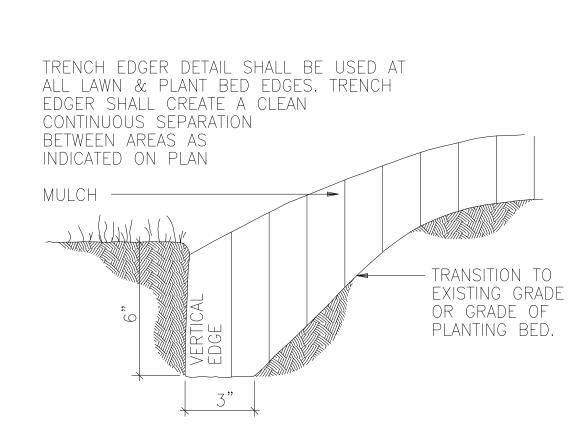


TRENCH EDGER DETAIL

N.T.S.

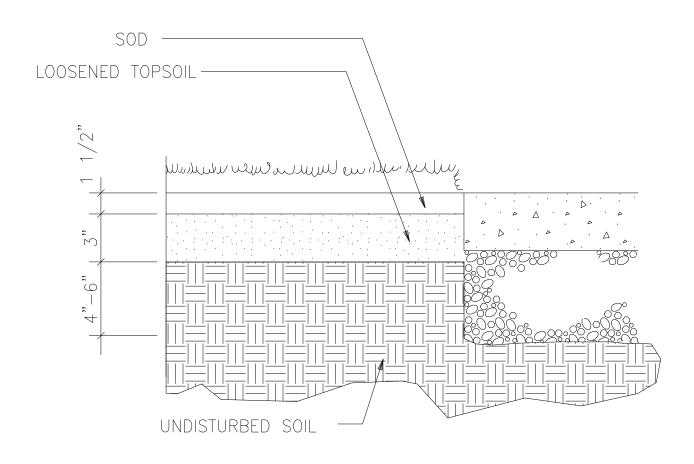


SOD INSTALLATION DETAIL N.T.S.

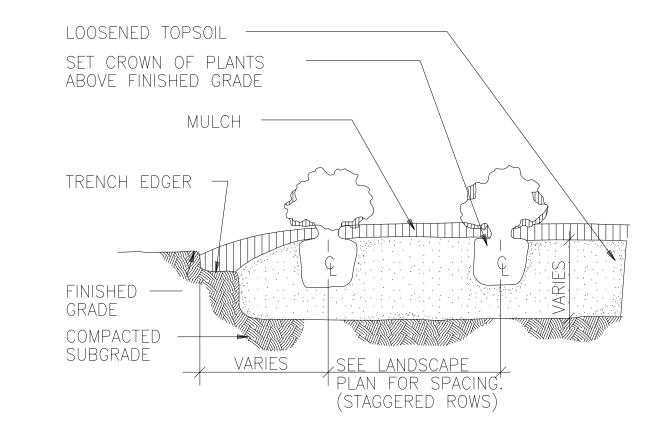

SHRUB/GROUND COVER MASS PLANTING

N.T.S.

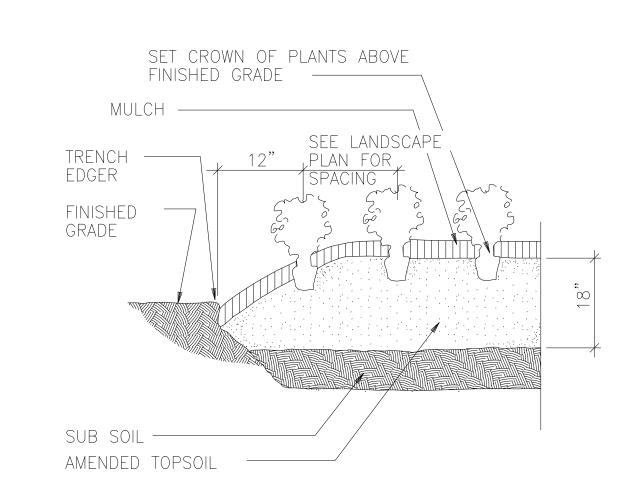

PERENNIAL AND ANNUAL COLOR BEDS

N.T.S.

2-A-19-UR



**STUDIO FOUR DESIGN**<sup>2</sup>

414 Clinch Ave. Knoxville, TN 37902 p 865 523-5001 f 865 523-5003

studiofourdesign.com

**ARCHITECTURE & INTERIORS** 

Building rations



Project Phase: TTCDA

Issue Date: 12/03/18 No. Descripton

18107.00 Job Number: Landscape Plan

9

aith

LIGHTING DESIGN SERVICES

LightingDesign@Lithonia.com
ONE LITHONIA WAY

CONYERS, GA 30012 1-800-279-8043

**Security** Brands.

### Introdu

The new RSX LED Area family delivers maximum value by providing significant energy savings, long life and outstanding photometric performance at an affordable price. The RSX1 delivers 7,000 to 17,000 lumens allowing it to replace 70W to 400W HID luminaires.

The RSX features an integral universal mounting mechanism that allows the luminaire to be mounted on most existing drill hole patterns. This "no-drill" solution provides significant labor savings. An easy-access door on the bottom of mounting arm allows for wiring without opening the electrical compartment. A mast arm adaptor and an adjustable integral slip-fitter are also available.

RSX1 LED						
Series	Performance Package	Color Temperature	Distribution	Voltage	Mounting	
RSX1 LED	P1 P2 P3 P4	30K 3000K 40K 4000K 50K 5000K	R3 Type 3 Wide R4 Type 4 Wide R5 Type 5 Wide R5S Type 5 Short AFR Automotive Front Row	MVOLT (120V-277V) <sup>1</sup> HVOLT (347V-480V) <sup>2</sup> (use specific voltage for options as noted) 120 <sup>2</sup> 277 <sup>2</sup> 208 <sup>1</sup> 347 <sup>3</sup> 240 <sup>3</sup> 480 <sup>1</sup>	SPA RPA MA IS WBA	Square pole mounting (Min. at 90°, Min. 3.5° 50 for 2, 3, Round pole mounting (3.2° min pole dia. for 1,2,3 of Mast arm adaptor (fits 2-3/8° CD horizontal ten Adjustable slipfitter (fits 2-3/Wall bracket
Options					Finish	
Shipped Ins HS PE PEX PER7 CE34 SF DF SPD20KV FAO DMG	House-side shield  Photocontrol, button style ** Photocontrol external thread Seven-wire twist-lock recept Conduit entry 3/4* NPT (Oty Single fuse (120, 277, 347) * Double fuse (208, 240, 480) 20KV Surge pack (10KV stan Reld adjustable output 0-10V lead wires extended (n	ed, adjustable <sup>6,7</sup> Lacle only (no controls) <sup>7,8,9</sup> 2) 1 dard)	PIRS Motion/ambient sensor for a PIRHS Motion/ambient sensor for a *Networked Sensors/Controls NL TAIR2 nLight AIR generation 2 National Sensors (Controls)	ory default settings, see table page 5) 3-20'mounting heights <sup>214,16</sup> 20-40'mounting heights <sup>214,16</sup> /ambient sensor (for use with NLTAIR2) <sup>2,21,44,18</sup>	DDBXD DBLXD DNAXD DWHXD DBTXD DBLBXD DNATXD DWHGXD	Dark Bronze Black Natural Aluminum White Textured Dark Bronze Textured Black Textured Natural Alumin Textured White
Shipped Sep EGS	parately (requires some field External glare shield External glare full visor (360)	•	*Note: Sensor coverage pattern is affer	ted when luminaire is tilted.		

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#### Safet

Please note this analysis does not comply with minimal IESNA levels for parking and pedestrian safety. Acuity Brands will not be liable for any safety issues that may arise from the installation of this design.

#### Not

Readings shown are based on a total LLF of as shown at grade. Data references the extrapolated performance projections in a 25c ambient based on 10,000 hrs of LED testing (per IESNA LM-80-08 and projected per IESNA TM-21-11).
 Please refer to the "Plan View" for mounting heights.
 Product information can be obtained at www.Lithonia.com or through your local agency.

Luminaire Locations										
No.	Label	X	Υ	Z	МН	Orientatio				
1	Α	99.75	-111.44	25.00	25.00	46.68				
2	Α	234.61	-111.12	25.00	25.00	314.48				
3	Α	298.35	-81.54	25.00	25.00	11.55				
4	Α	38.00	-39.31	25.00	25.00	46.68				
5	Α	241.56	-16.02	25.00	25.00	49.78				
6	Α	338.76	3.18	25.00	25.00	261.41				
7	Α	274.95	86.15	25.00	25.00	226.69				
8	Α	25.50	107.56	25.00	25.00	318.28				
9	Α	106.75	169.31	25.00	25.00	321.41				

10 A 187.00 234.44 25.00 25.00 316.59

## 2-A-19-UR

Specifications

13.3" (33.8 cm)

3.0" (7.6 cm) Main Body 7.2" (18.4 cm) Arm

(ft2@0°):

Statistics									
Description	Symbol	Avg	Max	Min	Max/Min	Avg/Min			
20' Away from Adjacent Parking	+	0.2 fc	0.4 fc	0.1 fc	4.0:1	2.0:1			
Across Street Parking		0.8 fc	2.3 fc	0.3 fc	7.7:1	2.7:1			
Adjacent Parking Lot	$\Diamond$	0.9 fc	2.3 fc	0.3 fc	7.7:1	3.0:1			
Building Entrance	$\Diamond$	0.3 fc	0.3 fc	0.3 fc	1.0:1	1.0:1			
Driveway/Dock Summary		1.2 fc	2.4 fc	0.3 fc	8.0:1	4.0:1			
Sidewalk		0.2 fc	0.4 fc	0.0 fc	N/A	N/A			
Spill Light Summary	+	0.2 fc	2.4 fc	0.0 fc	N/A	N/A			

Schedule	=										
Symbol	Label	Quantity	Manufacturer	Catalog Number	Description	Lamp	Number Lamps	Filename	Lumens Per Lamp	Light Loss Factor	Wattage
	A	10	Lithonia Lighting	RSX1 LED P1 40K R4	RSX Area Fixture Size 1 P1 Lumen Package 4000K CCT Type R4 Distribution		1	RSX1_LED_P1 _40K_R4.ies	7189	0.97	51.34
	В	0	Lithonia Lighting	RSX1 LED P1 40K R5	RSX Area Fixture Size 1 P1 Lumen Package 4000K CCT Type R5 Distribution		1	RSX1_LED_P1 _40K_R5.ies	7285	0.97	51.34

**/** 1.1 0.4 0,1 0.1 0.0 0.0 0.0 0.0 0.0 0.0 0.0 2/ A-110 @025' 0.2 0.1 0.1 0.0 0.0 0.0 0.0 0.0 0.0 1.1 0.5 0.4 0.3 0.1 0.1 0.0 0.0 0.0 0.0 0.0 0.0 0.0 0.0 0.1 0.1 0.1 0.2 0.3 0.4 0.5 0.5 0.6 0.7 0.8 0.9 1.1 **8**.9 0.8 0.4 0.3 0.3 0.2 0.1 0.1 0.0 0.0 0.0 0.0  $0.2 \setminus 0.2 \setminus 6.3 \setminus 0.4 \setminus 0.5 \setminus 0.6 \setminus 0.7 \setminus 0.7 \setminus 0.8 \setminus 0.8 \setminus 0.9 \setminus 0.8 \setminus 0.7 \setminus 0.5 \setminus 0.3 \setminus 0.1 \setminus 0.1$ 0.9 0.7 0.4 0.2 0.1 0.1 0.1 0.1 0.1 0.0 0.0 0.0 0.4 0.5 0.6 0.7 0.9 1.1 1.2 1.1 0.2 0.3 0.3 0.4 0.4 0.5 0.5 0.6 0.9 1.4 1.9 1.8 0.3 0.4 0.4 0.5 0.6 0.6 0.7 1.0 1.7 0.0 0.0 0.0 0.0 0.0 0.1 0.2 0.3 0.4 0.4 0.5 0.6 0.7 0.7 0.9 1.1 1.5 1.6 0.5 0.4 0.2 0.1 0.1 0.0 0.0 0.0 0.0 0.0 0.0 0.0 0.5 0.4 0.5 0.5 0.6 0.7 0.7 0.8 0.9 10 1.0 0.6 0.4 0.4 0.3 0.1 0.1 0.0 0.0 0.0 0.0 3 0.2 0.1 0.1 0.1 0.1 0.1 0.1 0.0 0.0 0.0 0.0 0.0 0.0 0.0 0.0 0.0 0.1 0.1 0.2 0.3 0.4 0.5 0.7 10 0.5 0.3 0.1 0.2 0.2 0.1 0.1 0.1 0.0 0.0 0.0 0.0 0.0 0.0 0.0 0.0 0.1 0.1 0.2 0.3 0.4 0.5 0.7 1.1 1.6 0.5 0.7 0.9 0.9 0.4 0.3 0.3 0.2 0.1 0.1 0.0 0.0 0.0 0.7 1.0 1.5 1.3 0.4 0.4 0.2 0.1 0.1 0.1 0.0 0.0 0.0 0.0 0.0 0.0 0.0 0.0 0.0 0.1 0.1 0.2 0.4 5 0.7 1.0 1.2 0.7 0.4 0.4 0.2 0.1 0.1 0.0 0.0 0.0 0.0 0.0 0.0 1.1 1.8 1.8 1.4 0.5 0.2 0.2 0.1 0.1 0.0 0.0  $\sqrt{0.0}$  0.0 0.0 0.0 0.0 0.0 0.0 0.1 0.1 0.2 0.3 0.3 0.2 0.1 0.1 0.1 0.1 0.2 0.1 0.1  $\sqrt{0.0}$  0.0 0.0 0.0 0.0 1.0 0.3 0.2 0.2 0.1 0.1 0.0 0.0 0.7 0.4 0.3 0.2 0.1 0.0 0.0 0.6 0.4 0.3 0.2 0.0 0.0 0.0 0.4 1.0 1.0 1.0 0.9 0.8 0.7 0.6 0.3 0.1 0.1 0.0 **8**.6 1.0 1.8 1.0 0.9 0.9 0.9 0.9 0.5 0.1 0.1 0.1  $0.0 \quad 0.0 \quad 0.1 \quad 0.1 \quad 0.1 \quad 0.2 \quad 0.2 \quad 0.3 \quad 0.3 \quad 0.3 \quad 0.3$ 0.9 0.9 0.9 1.1 1.3 0.8 0.2 0.2 0.1 0.1 0.9 0.9 0.9 1.1 1.1 1.0 0.9 1.1 1.5 1.0 1.2 0.4 0.3 0.2 0.1 0.0 0.0 0.0 0.0 0.0 0.0 0.0 0.0 0.1 0.0 0.1 0.5 0.5 0.5 0.5 1.4 1.5 1.4 1.2 1.1 1.1 1.1 1.2 1.8 24 1.6 0.3 0.4 0.2 0.1 0.1 0.1 0.3 1.1 2.0 2.3 1.8 1.3 1.1 1. 1.2 1.2 1.7 2.2 1.7 0.6 0.3 0.2 0.1 0.1 0.0 0.0 0.0 0.0 0.0 0.0 0.0 0.0 0.1 0.2 0.5 0.7 0.8 0.8 0.7 0.7 0.6 0.4 0.1 0.2 0.3 0.6 1.6 4.5 @ 125' 1.4 1.2 1.2 1.2 1.2 1.4 1.6 1.5 0.6 0.3 0.2 0.1 0.1 0.0 0.0 0.0 0.0 0.0 0.0 0.0 0.0 0.1 0.4 0.9 1.1 1.2 1.1 0.8 0.7 0.6 8.4 0.0 0.0 0.0 0.0 0.0 0.0 0.0 0.0 0.1 0.2 0.7 1.5 1.9 1.8 1.2 0.8 0.6 0.5 0.1 0.1 0.3 0.4 0.6 0.9 1.6 1.7 1.4 1.3 1.3 1.2 1.1 1.2 1.3 1.2 0.7 0.3 0.2 0.1 0.1 0.0 0.0 0.0 0.0 0.0 0.0 0.0 0.0 0.1 0.1 0.3 1.0 1.4 0.9 0.7 0.6 0.5 0.4 0.3 98 1.0 1.1 1.3 1.6 1.9 2.2 1.8 1.2 0.9 0.8 0.5 0.3 0.2 0.1 0.0 0.0 0.0 0.7 0.9 1.0 0.8 0.7 0.7 0.6 0.4 0.3 0.3 0.3 0.4 0.5 0.7 0.7 0.8 0.9 1.0 1.1 1.8 1.8 1.2 0.8 0.7 0.6 0 0.5 0.6 0.6 0.7 1.0 1.5 1.8 1.6 1.1 0.5 0.2 0.3 0.4 0.4 0.3 0.3 0.3 0.3 0.3 0.2 0.1 0.1 0.0 0.9 0.7 0.6 0.5 0.5 0.6 0.7 0.8 1.1 1.7 0.9 0.7 0.5 0.5 0.5 0.6 0.8 1.6  $0.0 \quad 0.0 \quad 0.0$ 

Plan View


### Disclaimer

This architectural lighting submittal is provided only for informational purposes and to the help the customer or end-user (as applicable) understand how various sections of linear fixtures connect to each other and how they mount to the ceiling. This lighting submittal is strictly based on the information provided to Acuity Brands, and is provided without warranty as to accuracy, completeness, reliability or otherwise. If the information (including but not limited to floor-plans, reflected ceiling plans, electrical plans and specifications) provided to Acuity Brands is incomplete or not current (i.e., newer versions exist), the accuracy of proposed design may be adversely affected. Once this lighting submittal is received by the customer or end-user (as applicable), it is the obligation of the customer or end-user (as applicable) to consult with a professional engineering advisor to determine whether the proposed design meets the applicable project requirements for lighting system performance, code compliance, safety, suitability and effectiveness for use in a particular application. In no event will Acuity Brands be responsible for any loss resulting from any use of any information contained in this lighting submittal.

Date
11/28/2018
Scale
As Shown
Drawing No.
87668-0
Summary

**Designer**R.Cunningham

1 of 1

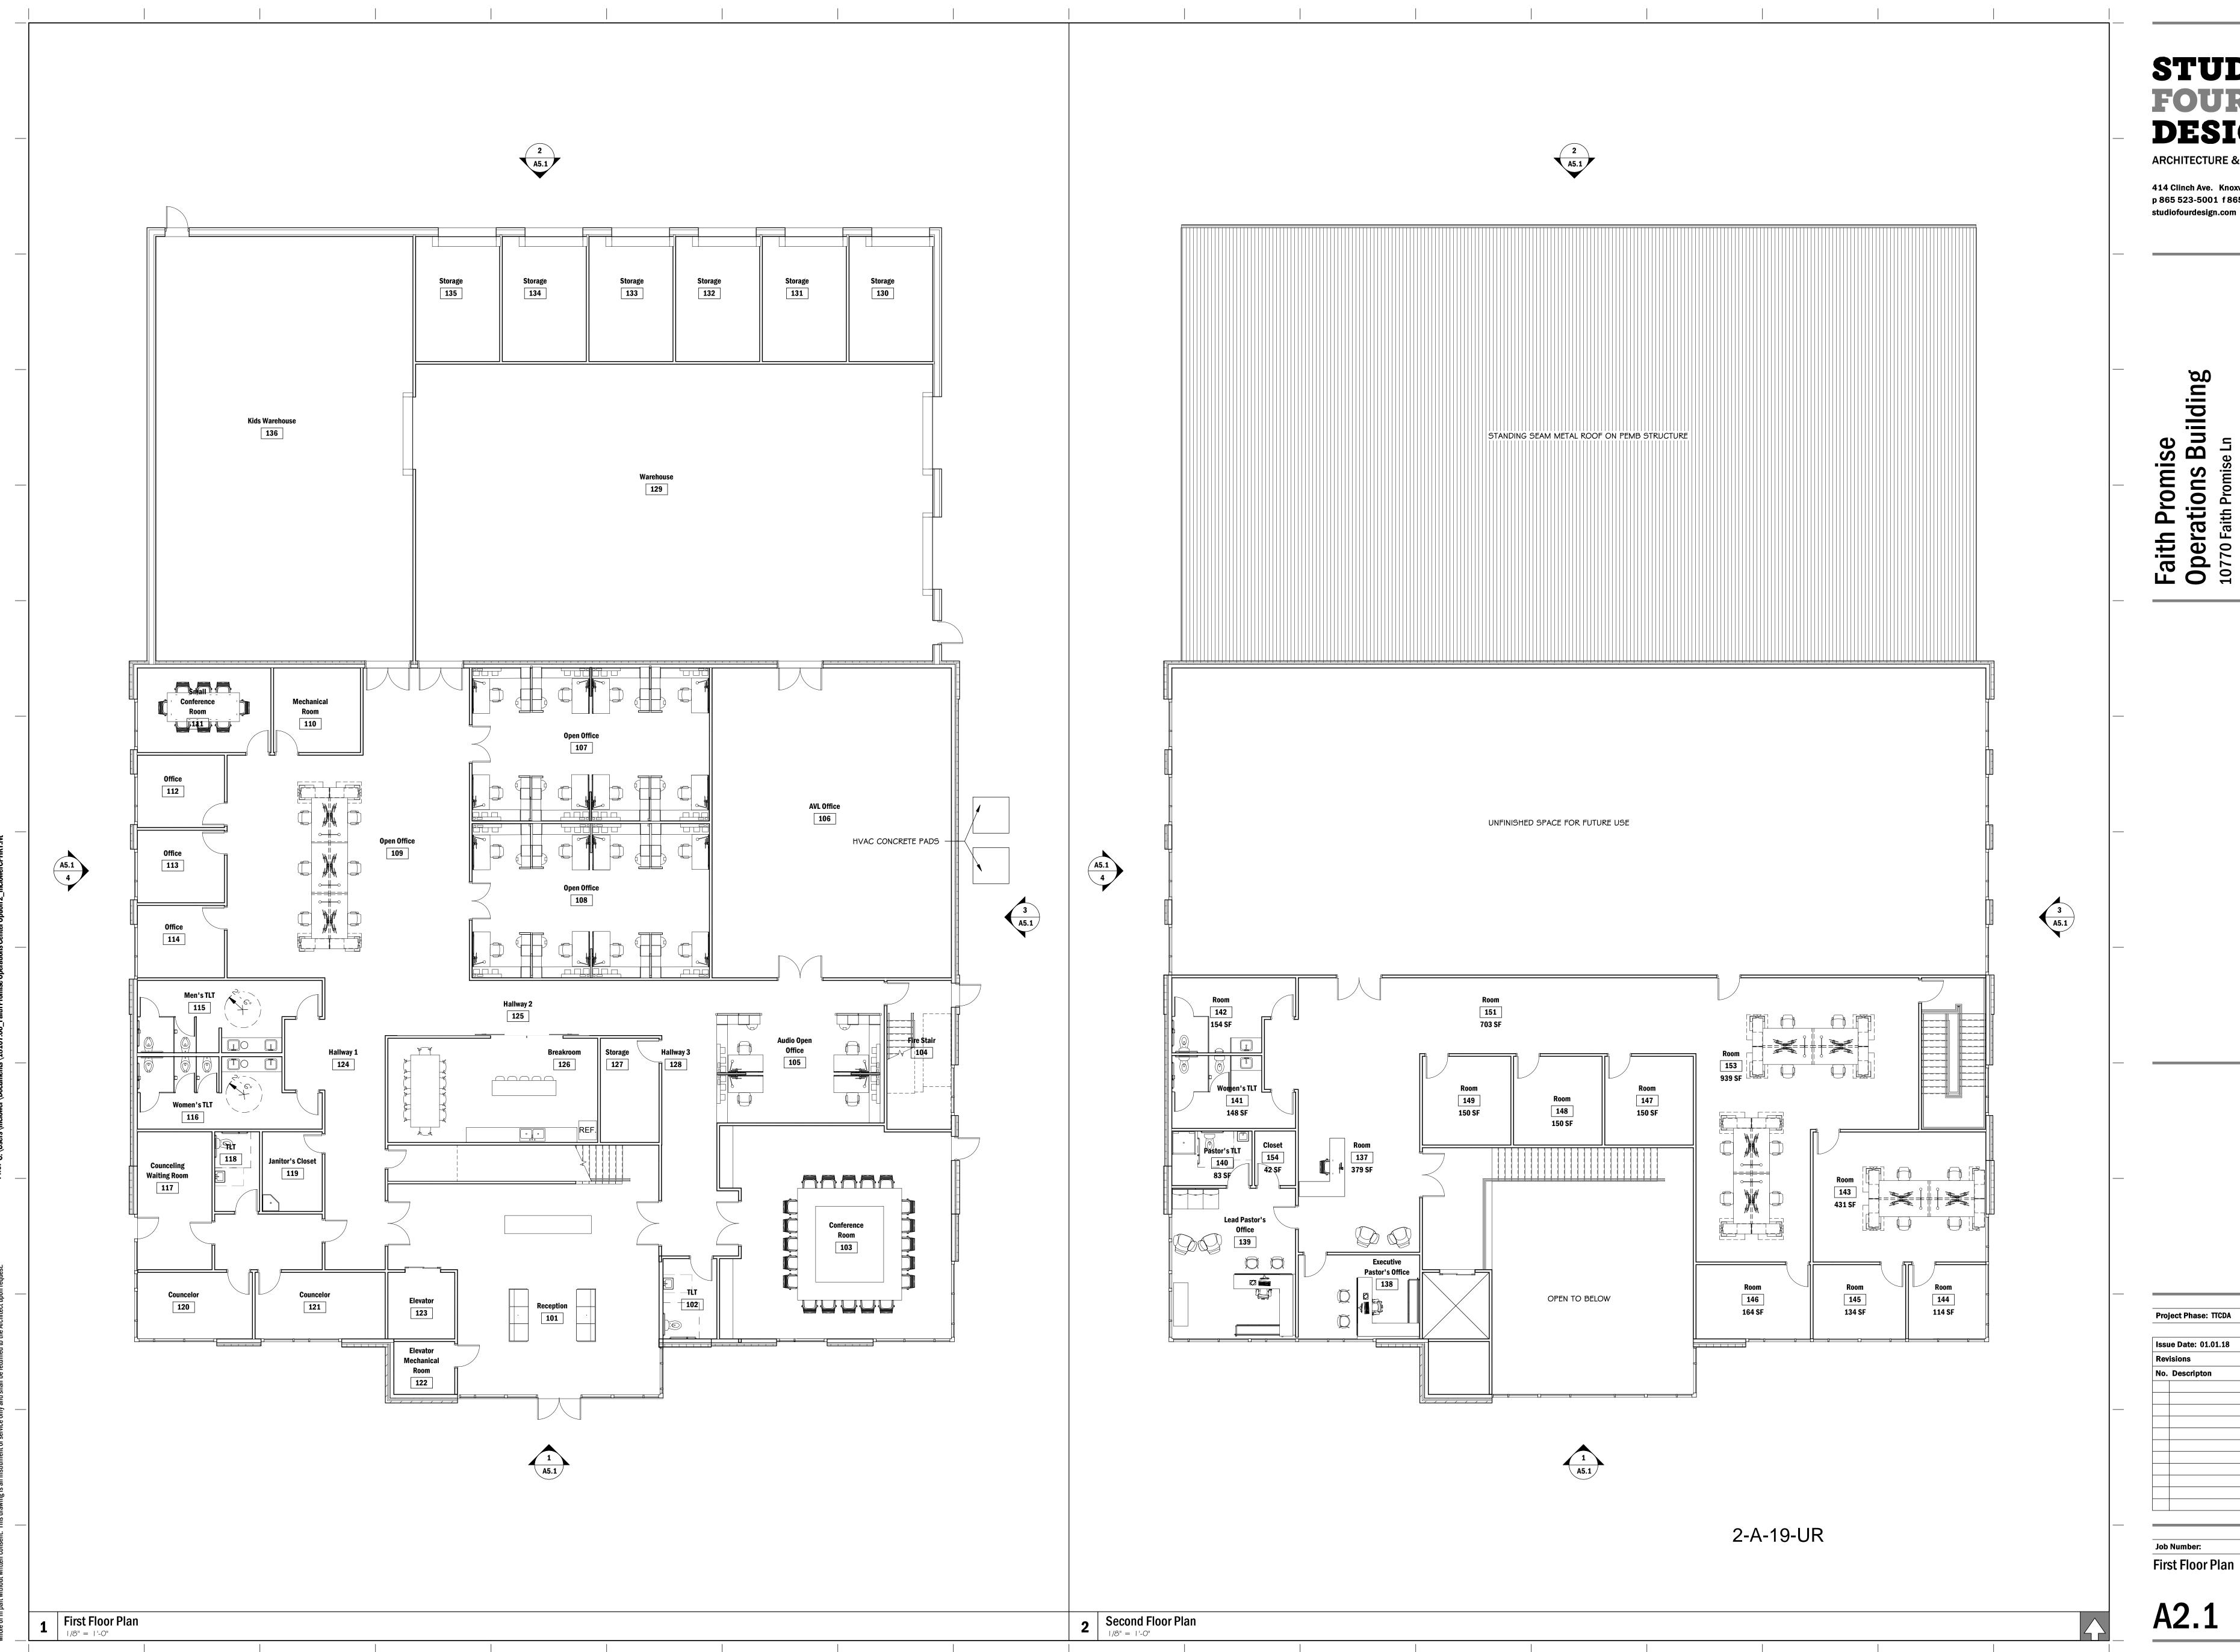

**STUDIO FOUR DESIGN**<sup>½</sup>

**ARCHITECTURE & INTERIORS** 

414 Clinch Ave. Knoxville, TN 37902 p 865 523-5001 f 865 523-5003

Faith Promise
Operations Building
10770 Faith Promise Ln
Knoxville, TN 37931

Project Phase: TTCDA

Issue Date: 01.01.18

18107.00 First Floor Plan

