

(NOT

- 1. THE BOUNDARY AND TOPOGRAPHIC DATA SHOWN WAS PROVIDED BY CANNON AND CANNON, INC. DATED NOVEMBER 2, 2018.
- 2. THE DISTURBED AREA IS APPROXIMATELY 4.66± ACRES. THE TOTAL SITE AREA IS APPROXIMATELY 6.11± ACRES.

 3. STORM WATER DETENTION AND WATER QUALITY TO BE
- EVALUATED AS PART OF FINAL DRAINAGE DESIGN.
 A DETAILED LANDSCAPING PLAN SHALL BE SUBMITTED FOR
 MPC STAFF APPROVAL PRIOR TO OBTAINING BUILDING PERMIT
- UNLESS NOTED OTHERWISE, THE PROPOSED GRADES SHOWN
 ON THESE DRAWINGS ARE FINISH GRADE. EXISTING AND
 PROPOSED CONTOURS ARE SHOWN AT 2 FT. INTERVALS.
- EROSION CONTROL DEVICES SHALL BE INSTALLED AND MAINTAINED IN ACCORDANCE WITH THE TENNESSEE EROSION AND SEDIMENT CONTROL HANDBOOK. THE DEVICES SHOWN ON THE DRAWINGS ARE THE MINIMUM REQUIRED. THE CONTRACTOR SHALL PROVIDE ADDITIONAL EROSION CONTROL DEVICES AS NEEDED.
- 7. THE SITE SHALL BE CLEARED AND GRUBBED WITHIN THE LIMITS OF EXCAVATION. COMPLETELY DISPOSE OF ALL MATERIALS RESULTING FROM CLEARING AND GRUBBING OFF—SITE OR ON—SITE AT A LOCATION DETERMINED BY THE OWNER.
- ALL TREE STUMPS, BOULDERS, AND OTHER OBSTRUCTIONS SHALL BE REMOVED TO A DEPTH OF 2 FT BELOW THE SUBGRADE. ROCK SHALL BE SCARIFIED TO A DEPTH OF 1 FT BELOW SUBGRADE.
- STRIP TOPSOIL TO A MINIMUM DEPTH OF 8—IN. AND TEMPORARILY STOCKPILE EXCAVATED MATERIALS. INSTALL SILT FENCE OR OTHER APPROPRIATE EROSION CONTROL STRUCTURES ON THE DOWN HILL SIDE OF THE STOCKPILE.
- 10. A 4 IN. (MIN) LAYER OF TOPSOIL SHALL BE PLACED OVER
 THE AREAS TO BE SEEDED AND TO THE FINISH GRADE
 ELEVATIONS AS SHOWN ON THE DRAWINGS.

 11. ALL NEW Y CRADED FARTHEN AREAS THAT ARE NOT TO RE
- ALL NEWLY GRADED EARTHEN AREAS THAT ARE NOT TO BE PAVED, STABILIZED, OR SODDED SHALL BE SEEDED, FERTILIZED, AND MULCHED WITHIN 30 DAYS OF ATTAINMENT OF FINAL GRADE.

12. TEMPORARY SEEDING MIXTURES SHALL BE AS FOLLOWS: SEEDING DATES | GRASS SEED | PERCENTAGES

1/1 TO 5/1	ITALIAN RYE	33%
	KOREAN LESPEDEZA	33%
	SUMMER OATS	34%
5/1 TO 7/15	SUDAN — SORGHUM	100%
5/1 TO 7/15	STAR MILLET	100%
7/15 TO 1/1	BALBOA RYE	67%

ITALIAN RYE

33%

13. PERMANENT SEEDING MIXTURES SHALL BE AS FOLLOWS: SEEDING DATES | GRASS SEED | PERCENTAGES

2/1 TO 7/1	KENTUCKY 31 FESCUE	80%
	KOREAN LESPEDEZA	15%
	ENGLISH RYE	<i>5%</i>
6/1 TO 8/15	KENTUCKY 31 FESCUE	55%
	ENGLISH RYE	20%
	KOREAN LESPEDEZA	15%
	GERMAN MILLET	10%
4/15 TO 8/15	BERMUDAGRASS (HULLED)	70%
	ANNUAL LESPEDEZA	30%
8/1 TO 12/1	KENTUCKY 31 FESCUE	70%
	ENGLISH RYE	20%
	WHITE CLOVER	10%
2/1 TO 12/1	KENTUCKY 31 FESCUE	70%
	CROWN VETCH	25%
	ENGLISH RYE	<i>5%</i>

- 14. MULCH WITH STRAW AT A RATE OF 100 LBS./1000 S.F.
- OVER THE SEEDED AREAS.

 15. DO NOT ALLOW WATER TO ACCUMULATE IN EXCAVATIONS OR POND ON—SITE. PROVIDE NECESSARY MEASURES TO KEEP THE SITE FREE—DRAINING.
- 16. NO SLOPE SHALL EXCEED 2:1 (H: V). ALL SLOPES STEEPER THAN 3:1 TO RECEIVE EXTENDED TERM EROSION CONTROL BLANKET.
- 17. TO PREVENT EROSION, ALL SLOPES 2:1 OR GREATER ARE TO BE TRACKED WITH A DOZER TO FORM CLEAT MARKS
- BE TRACKED WITH A DOZER TO FORM CLEAT MARKS
 PARALLEL TO THE CONTOUR.

 18. APPLY TEMPORARY SEEDING WHENEVER GRADING OPERATIONS
 ARE HALTED FOR OVER 14 DAYS AND FINAL GRADING OF
- EXPOSED SURFACE IS TO BE COMPLETED WITHIN ONE YEAR.

 APPLY TEMPORARY SEEDING TO ALL SOIL STOCKPILES.

 19. APPLY PERMANENT SEEDING WHENEVER GRADING OPERATIONS

 ARE COMPLETED AND ALL CONSTRUCTION OPERATIONS WILL

 NOT IMPACT THE DISTURBED AREA. APPLY PERMANENT

 SEEDING TO ALL NON—CONSTRUCTION AREAS WHICH SHOW

1\(\) REVISED PER MPC COMMENTS	1/28/2019

SIGNS OF EXCESSIVE EROSION.



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Knoxville, TN 37919

ENT:

STERLING DEVELOPMENT
3900 EDISON LAKES PARKWAY, SUITE 201
MISHAWAKA, IN 46545

PROJECT:

MINI STORAGE DEPOT ON MAYNARDVILLE PIKE 6940 MAYNARDVILLE PIKE


KNOXVILLE, TN 37918

SITE GRADING AND DRAINAGE PLAN



CCI PROJECT NO.			01000-000	5
DRAWING DATE		D	ECEMBER 28	3, 2018
PM	AWG		PIC	-
DRAWN	CIO		CHECKED	-

UOR2.01

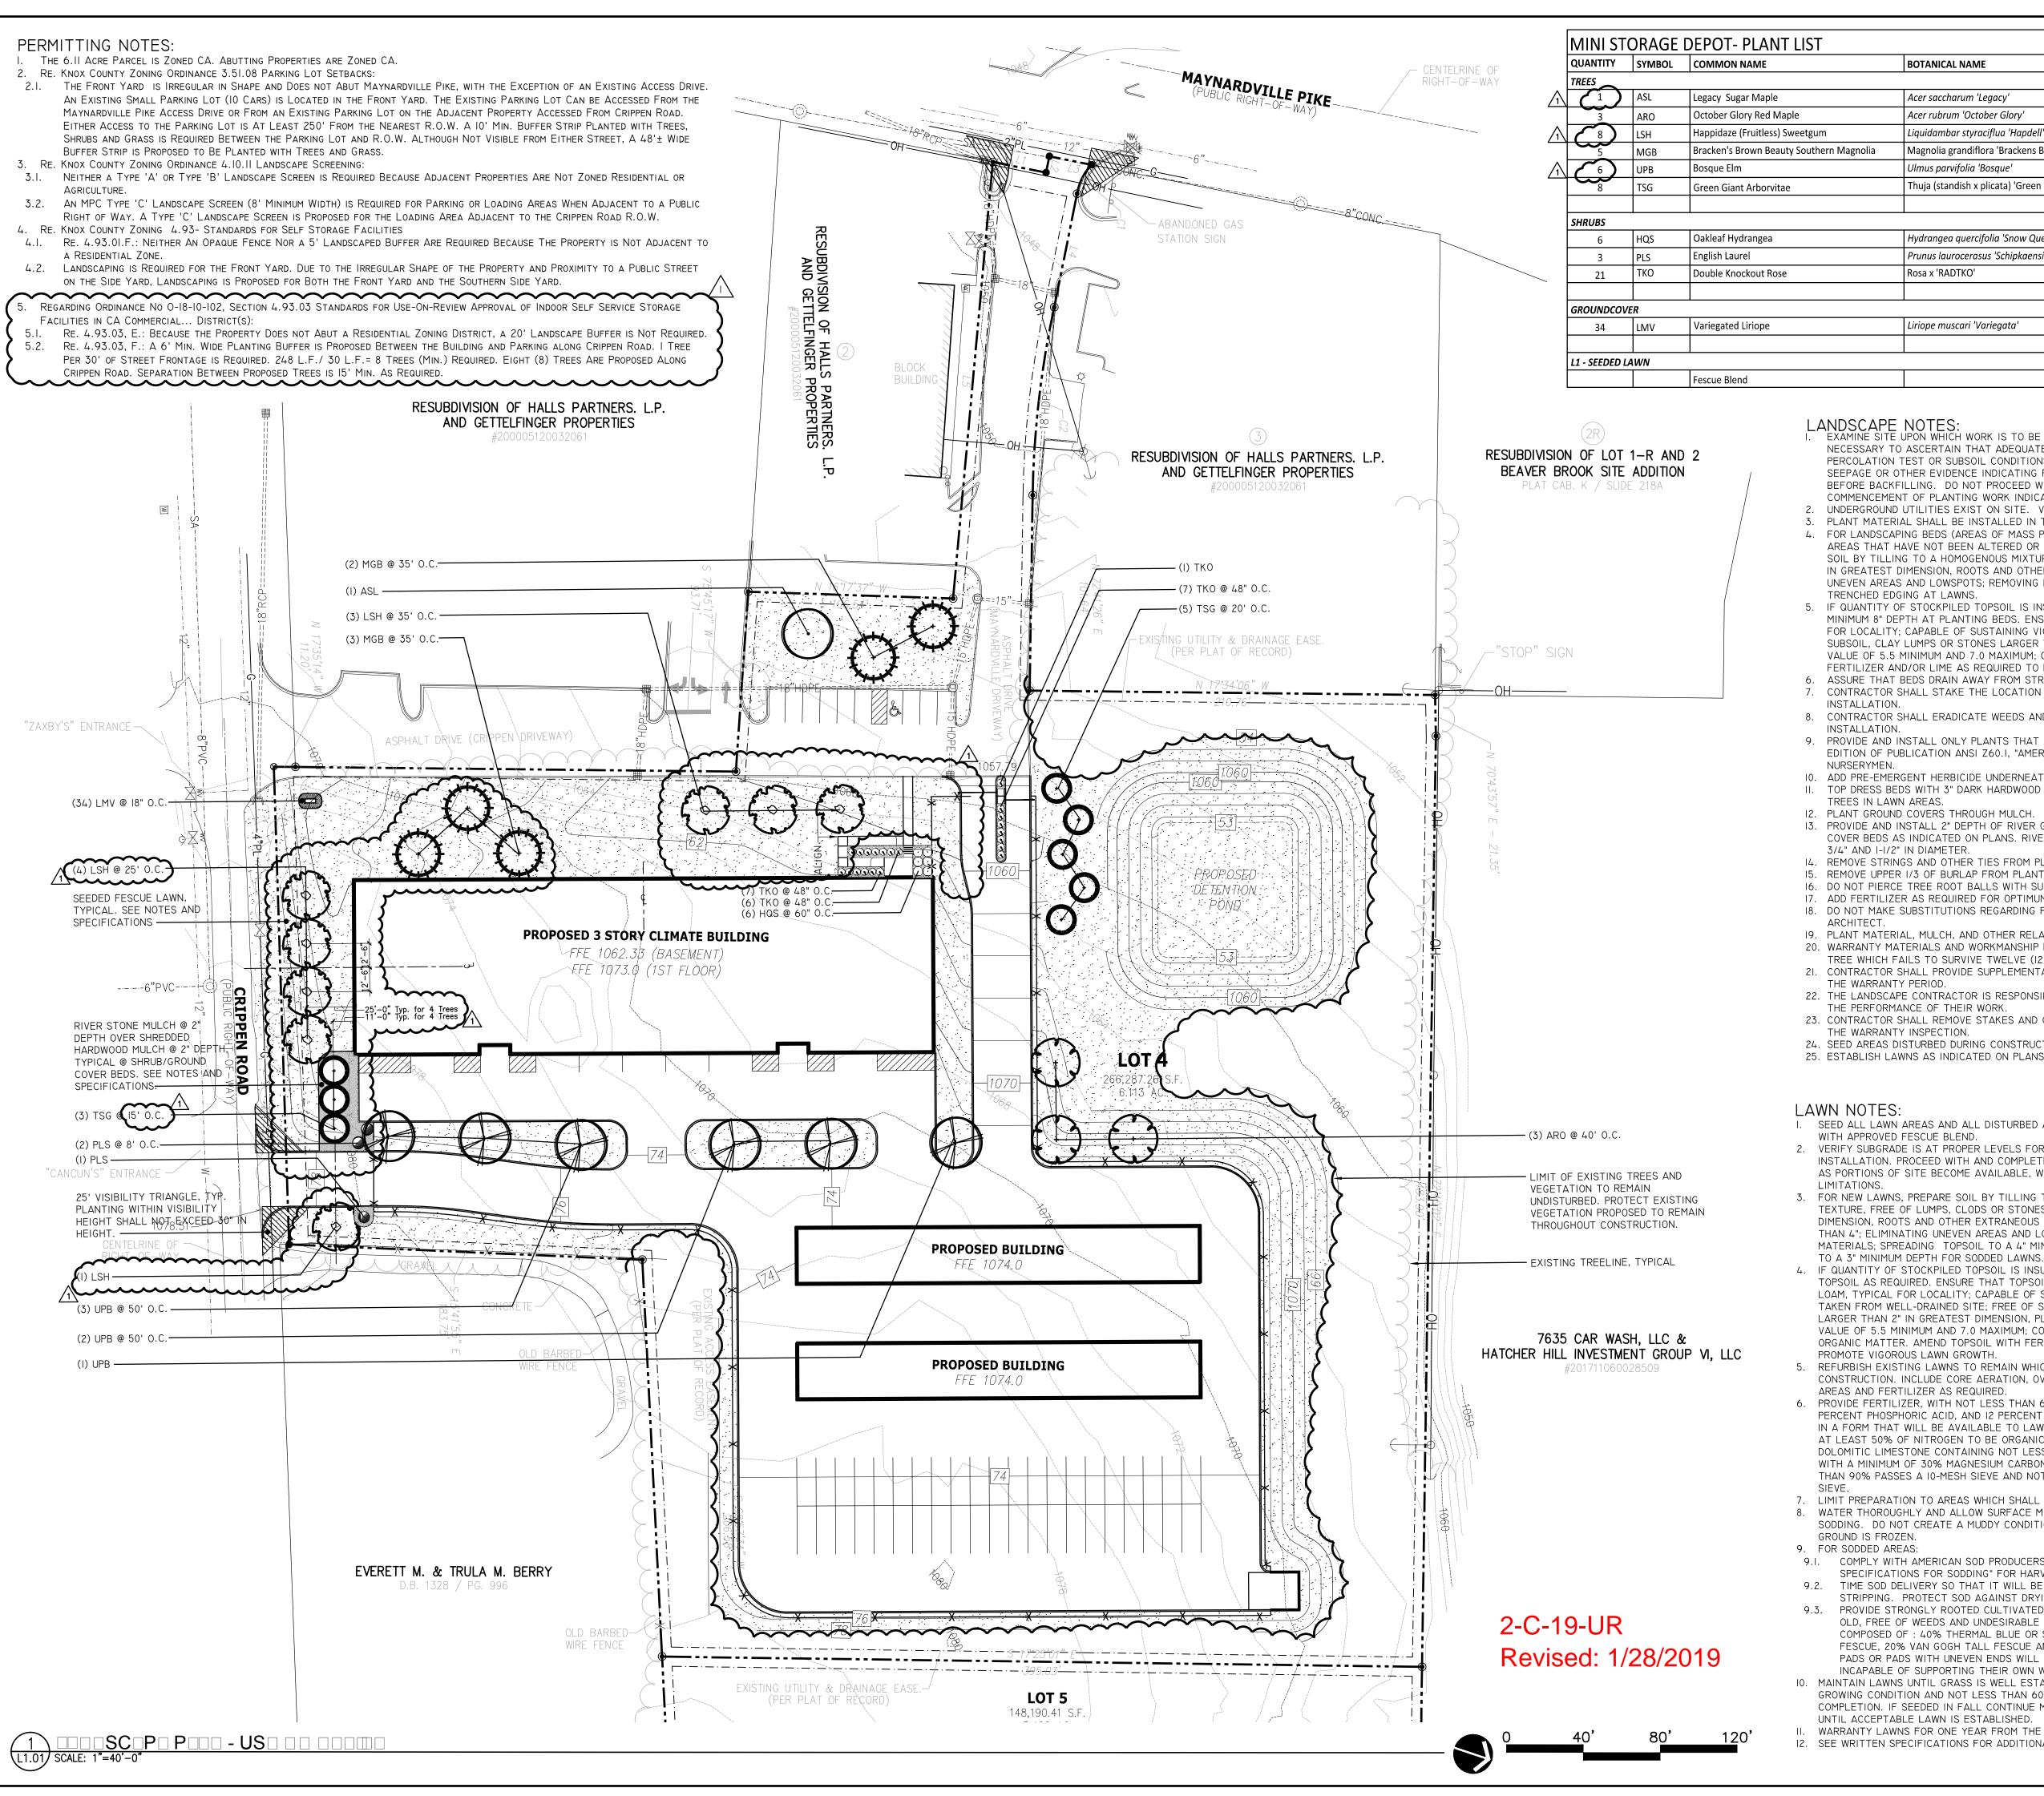

LANDSCAPE NOTES

BOTANICAL NAME

Acer saccharum 'Leaacv'

Ulmus parvifolia 'Bosque'

Rosa x 'RADTKO'

Acer rubrum 'October Glory'

Liquidambar styraciflua 'Hapdell'

Magnolia grandiflora 'Brackens Brown Beauty'

Thuja (standish x plicata) 'Green Giant'

Hydrangea quercifolia 'Snow Queen'

Prunus laurocerasus 'Schipkaensis'

Liriope muscari 'Variegata'

EXAMINE SITE UPON WHICH WORK IS TO BE PERFORMED. PROVIDE PERCOLATION TESTS, PH TESTS AND OTHER TESTS NECESSARY TO ASCERTAIN THAT ADEQUATE GROWING CONDITIONS WILL BE PROVIDED FOR THE PLANTS. IF PERCOLATION TEST OR SUBSOIL CONDITIONS INDICATE RETENTION OF WATER IN PLANTING AREAS, AS SHOWN BY SEEPAGE OR OTHER EVIDENCE INDICATING PRESENCE OF UNDERGROUND WATER, RECTIFY UNSATISFACTORY CONDITIONS BEFORE BACKFILLING. DO NOT PROCEED WITH WORK UNTIL UNSATISFACTORY CONDITIONS HAVE BEEN CORRECTED. COMMENCEMENT OF PLANTING WORK INDICATES SITE CONDITIONS HAVE BEEN ACCEPTED BY CONTRACTOR.

MINIMUM SIZE

2" Cal.

2" Cal.

2" Cal.

2" Cal.

4' Ht.

3 Gal.

1 Gal.

3 Gal., 24" Ht.

REMARKS

Full Crowns

Full Crowns @ 40' O.C

Full Crown @ 25'-35' O.C

Full to Ground @ 15'-20' O.C.

Full to Ground @ 35' O.0

Full Crowns @ 50' O.C.

Full Plants @ 5' O.C.

Full Plants @ 5' O.C.

Full Plants @ 48" O.C.

Full Plants @ 18" O.C.

ROOTS

B&B

B&B

B&B

B&B

Cont

B&B

Cont.

Cont.

2. UNDERGROUND UTILITIES EXIST ON SITE. VERIFY LOCATIONS AND DEPTHS BEFORE COMMENCING WITH PLANTING WORK. PLANT MATERIAL SHALL BE INSTALLED IN THE DORMANT SEASON UNLESS SPECIFIED OTHERWISE.

4. FOR LANDSCAPING BEDS (AREAS OF MASS PLANTING OF SHRUBS AND/OR GROUNDCOVERS) TO BE ESTABLISHED IN AREAS THAT HAVE NOT BEEN ALTERED OR DISTURBED BY EXCAVATION, GRADING, OR STRIPPING OPERATIONS, PREPARE SOIL BY TILLING TO A HOMOGENOUS MIXTURE OF FINE TEXTURE, FREE OF LUMPS, CLODS OR STONES LARGER THAN 2" IN GREATEST DIMENSION, ROOTS AND OTHER EXTRANEOUS MATERIAL TO A DEPTH OF NOT LESS THAN 4"; ELIMINATING UNEVEN AREAS AND LOWSPOTS; REMOVING FOREIGN MATERIALS; SPREADING 8" MINIMUM TOPSOIL. DEFINE BEDS WITH

5. IF QUANTITY OF STOCKPILED TOPSOIL IS INSUFFICIENT, PROVIDE ADDITIONAL TOPSOIL AS REQUIRED TO ACHIEVE A MINIMUM 8" DEPTH AT PLANTING BEDS. ENSURE THAT TOPSOIL IS STERILE, FERTILE, FRIABLE, NATURAL LOAM, TYPICAL FOR LOCALITY; CAPABLE OF SUSTAINING VIGOROUS PLANT GROWTH; TAKEN FROM WELL-DRAINED SITE; FREE OF SUBSOIL, CLAY LUMPS OR STONES LARGER THAN 2" IN GREATEST DIMENSION, PLANTS, WEEDS, AND ROOTS; HAVING PH VALUE OF 5.5 MINIMUM AND 7.0 MAXIMUM; CONTAINING 4 PERCENT MINIMUM ORGANIC MATTER. AMEND TOPSOIL WITH FERTILIZER AND/OR LIME AS REQUIRED TO PROMOTE VIGOROUS PLANT GROWTH.

6. ASSURE THAT BEDS DRAIN AWAY FROM STRUCTURES. 7. CONTRACTOR SHALL STAKE THE LOCATION OF ALL GROUND COVER BEDS, SHRUBS AND TREES FOR APPROVAL PRIOR TO

8. CONTRACTOR SHALL ERADICATE WEEDS AND NON-SPECIFIED PLANT MATERIAL THREE (3) WEEKS PRIOR TO PLANT/SEED

9. PROVIDE AND INSTALL ONLY PLANTS THAT ARE FREE FROM DISEASE AND PESTS, AND THAT COMPLY WITH THE LATEST EDITION OF PUBLICATION ANSI Z60.I, "AMERICAN STANDARDS FOR NURSERY STOCK," BY THE AMERICAN ASSOCIATION OF

10. ADD PRE-EMERGENT HERBICIDE UNDERNEATH AND ON TOP OF MULCH IN LANDSCAPE BEDS.

II. TOP DRESS BEDS WITH 3" DARK HARDWOOD MULCH. PROVIDE 3" DEEP LAYER IN A FOUR FOOT DIAMETER RING AROUND TREES IN LAWN AREAS.

12. PLANT GROUND COVERS THROUGH MULCH. 13. PROVIDE AND INSTALL 2" DEPTH OF RIVER GRAVEL MULCH OVER SHREDDED HARDWOOD MULCH AT SHRUB/ GROUND

COVER BEDS AS INDICATED ON PLANS. RIVER GRAVEL SHALL BE TAN-GRAY IN COLOR WITH GRAVEL SIZES BETWEEN

3/4" AND I-I/2" IN DIAMETER. 14. REMOVE STRINGS AND OTHER TIES FROM PLANT MATERIAL

15. REMOVE UPPER 1/3 OF BURLAP FROM PLANT ROOT BALLS. 16. DO NOT PIERCE TREE ROOT BALLS WITH SUPPORT STAKES.

17. ADD FERTILIZER AS REQUIRED FOR OPTIMUM PLANT PERFORMANCE AND PRE-EMERGENT HERBICIDE.

18. DO NOT MAKE SUBSTITUTIONS REGARDING PLANT SIZES OR SPECIES WITHOUT WRITTEN PERMISSION OF THE LANDSCAPE ARCHITECT.

19. PLANT MATERIAL, MULCH, AND OTHER RELATED LANDSCAPE PRODUCTS MUST BE PRE-TREATED FOR FIRE ANTS. 20. WARRANTY MATERIALS AND WORKMANSHIP FOR TWELVE MONTHS FROM THE DATE OF SUBSTANTIAL COMPLETION. ANY

TREE WHICH FAILS TO SURVIVE TWELVE (12) MONTHS SHALL BE REPLACED WITHIN SIX (6) MONTHS OF LOSS 21. CONTRACTOR SHALL PROVIDE SUPPLEMENTAL WATERING TO NEWLY INSTALLED PLANT MATERIAL AS REQUIRED DURING

THE WARRANTY PERIOD

22. THE LANDSCAPE CONTRACTOR IS RESPONSIBLE FOR MAKING REPAIRS NECESSITATED BY DAMAGE OCCURRING DURING

THE PERFORMANCE OF THEIR WORK. 23. CONTRACTOR SHALL REMOVE STAKES AND GUY WIRES FOR TREES APPROVED BY THE LANDSCAPE ARCHITECT DURING

THE WARRANTY INSPECTION. 24. SEED AREAS DISTURBED DURING CONSTRUCTION WITH APPROVED FESCUE BLEND.

25. ESTABLISH LAWNS AS INDICATED ON PLANS. SEE LAWN NOTES FOR ADDITIONAL REQUIREMENTS.

LAWN NOTES:

SEED ALL LAWN AREAS AND ALL DISTURBED AREAS WITHIN THE PROJECT LIMITS WITH APPROVED FESCUE BLEND.

2. VERIFY SUBGRADE IS AT PROPER LEVELS FOR TOPSOIL AND SOD OR SEED INSTALLATION. PROCEED WITH AND COMPLETE LAWNS AND GRASSES AS RAPIDLY AS PORTIONS OF SITE BECOME AVAILABLE, WORKING WITHIN SEASONAL

FOR NEW LAWNS, PREPARE SOIL BY TILLING TO A HOMOGENOUS MIXTURE OF FINE TEXTURE, FREE OF LUMPS, CLODS OR STONES LARGER THAN 2" IN GREATEST DIMENSION, ROOTS AND OTHER EXTRANEOUS MATERIAL TO A DEPTH OF NOT LESS THAN 4"; ELIMINATING UNEVEN AREAS AND LOW SPOTS; REMOVING FOREIGN MATERIALS; SPREADING TOPSOIL TO A 4" MINIMUM DEPTH FOR SEEDED LAWNS OR

4. IF QUANTITY OF STOCKPILED TOPSOIL IS INSUFFICIENT, PROVIDE ADDITIONAL TOPSOIL AS REQUIRED. ENSURE THAT TOPSOIL IS FERTILE, FRIABLE, NATURAL LOAM, TYPICAL FOR LOCALITY; CAPABLE OF SUSTAINING VIGOROUS PLANT GROWTH; TAKEN FROM WELL-DRAINED SITE; FREE OF SUBSOIL, CLAY LUMPS OR STONES LARGER THAN 2" IN GREATEST DIMENSION, PLANTS, WEEDS, AND ROOTS; HAVING PH VALUE OF 5.5 MINIMUM AND 7.0 MAXIMUM; CONTAINING 6 PERCENT MINIMUM ORGANIC MATTER. AMEND TOPSOIL WITH FERTILIZER AND/OR LIME AS REQUIRED TO PROMOTE VIGOROUS LAWN GROWTH.

REFURBISH EXISTING LAWNS TO REMAIN WHICH HAVE NOT BEEN DISTURBED BY CONSTRUCTION. INCLUDE CORE AERATION, OVERSEEDING, STRAW AT THIN OR BARE AREAS AND FERTILIZER AS REQUIRED.

PROVIDE FERTILIZER, WITH NOT LESS THAN 6 PERCENT TOTAL NITROGEN, 12 PERCENT PHOSPHORIC ACID, AND 12 PERCENT SOLUBLE POTASH. PROVIDE NITROGEN IN A FORM THAT WILL BE AVAILABLE TO LAWN DURING INITIAL PERIOD OF GROWTH; AT LEAST 50% OF NITROGEN TO BE ORGANIC FORM. PROVIDE LIME FROM NATURAL DOLOMITIC LIMESTONE CONTAINING NOT LESS THAN 85% OF TOTAL CARBONATES WITH A MINIMUM OF 30% MAGNESIUM CARBONATES, GROUND SO THAT NOT LESS THAN 90% PASSES A 10-MESH SIEVE AND NOT LESS THAN 50% PASSES A 100-MESH

LIMIT PREPARATION TO AREAS WHICH SHALL BE SEEDED OR SODDED IMMEDIATELY. WATER THOROUGHLY AND ALLOW SURFACE MOISTURE TO DRY BEFORE SEEDING OR SODDING. DO NOT CREATE A MUDDY CONDITION. DO NOT SEED OR SOD WHEN THE

GROUND IS FROZEN. 9. FOR SODDED AREAS: 9.1. COMPLY WITH AMERICAN SOD PRODUCERS ASSOCIATION (ASPA) "GUIDELINE

SPECIFICATIONS FOR SODDING" FOR HARVESTING AND INSTALLING SOD.

9.2. TIME SOD DELIVERY SO THAT IT WILL BE PLACED WITHIN 24 HOURS AFTER STRIPPING. PROTECT SOD AGAINST DRYING AND BREAKING. 9.3. PROVIDE STRONGLY ROOTED CULTIVATED GRASS SOD, NOT LESS THAN I YEAR OLD, FREE OF WEEDS AND UNDESIRABLE NATIVE GRASSES PRINCIPALLY

COMPOSED OF: 40% THERMAL BLUE OR SPF-30 BLUE GRASS, 20% MONET TALL FESCUE, 20% VAN GOGH TALL FESCUE AND 20% PADRE TALL FESCUE. BROKEN PADS OR PADS WITH UNEVEN ENDS WILL NOT BE ACCEPTABLE. SOD PADS INCAPABLE OF SUPPORTING THEIR OWN WEIGHT. MAINTAIN LAWNS UNTIL GRASS IS WELL ESTABLISHED AND EXHIBITS A VIGOROUS

GROWING CONDITION AND NOT LESS THAN 60 DAYS FROM DATE OF SUBSTANTIAL COMPLETION. IF SEEDED IN FALL CONTINUE MAINTENANCE THE FOLLOWING SPRING UNTIL ACCEPTABLE LAWN IS ESTABLISHED.

WARRANTY LAWNS FOR ONE YEAR FROM THE DATE OF SUBSTANTIAL COMPLETION. 12. SEE WRITTEN SPECIFICATIONS FOR ADDITIONAL REQUIREMENTS.

THE PENLAND STUDIO LANDSCAPE ARCHITECTURE

516 Union Avenue KNOXVILLE, TENNESSEE 37902 TEL: 865.335.3584

↑ MPC COMMENTS	1/28/2019		
REVISIONS	DATE		
CANNON & CANNON INC			

TEL 865.670.8555 8550 Kingston Pike www.cannon-cannon.com | Knoxville, TN 37919

STERLING DEVELOPMENT **3900 EDISON LAKES PARKWAY, SUITE 201** MISHAWAKA, IN 46545

MINI STORAGE DEPOT ON MAYNARDVILLE PIKE 6940 MAYNARDVILLE PIKE KNOXVILLE, TN 37918


LANDSCAPE PLAN



PROJECT:

CCI PROJECT NO. 01000-0006 **DRAWING DATE** DECEMBER 28, 2018 PM AWG PIC DRAWN TPS | CHECKED TPS

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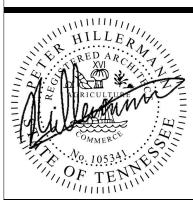

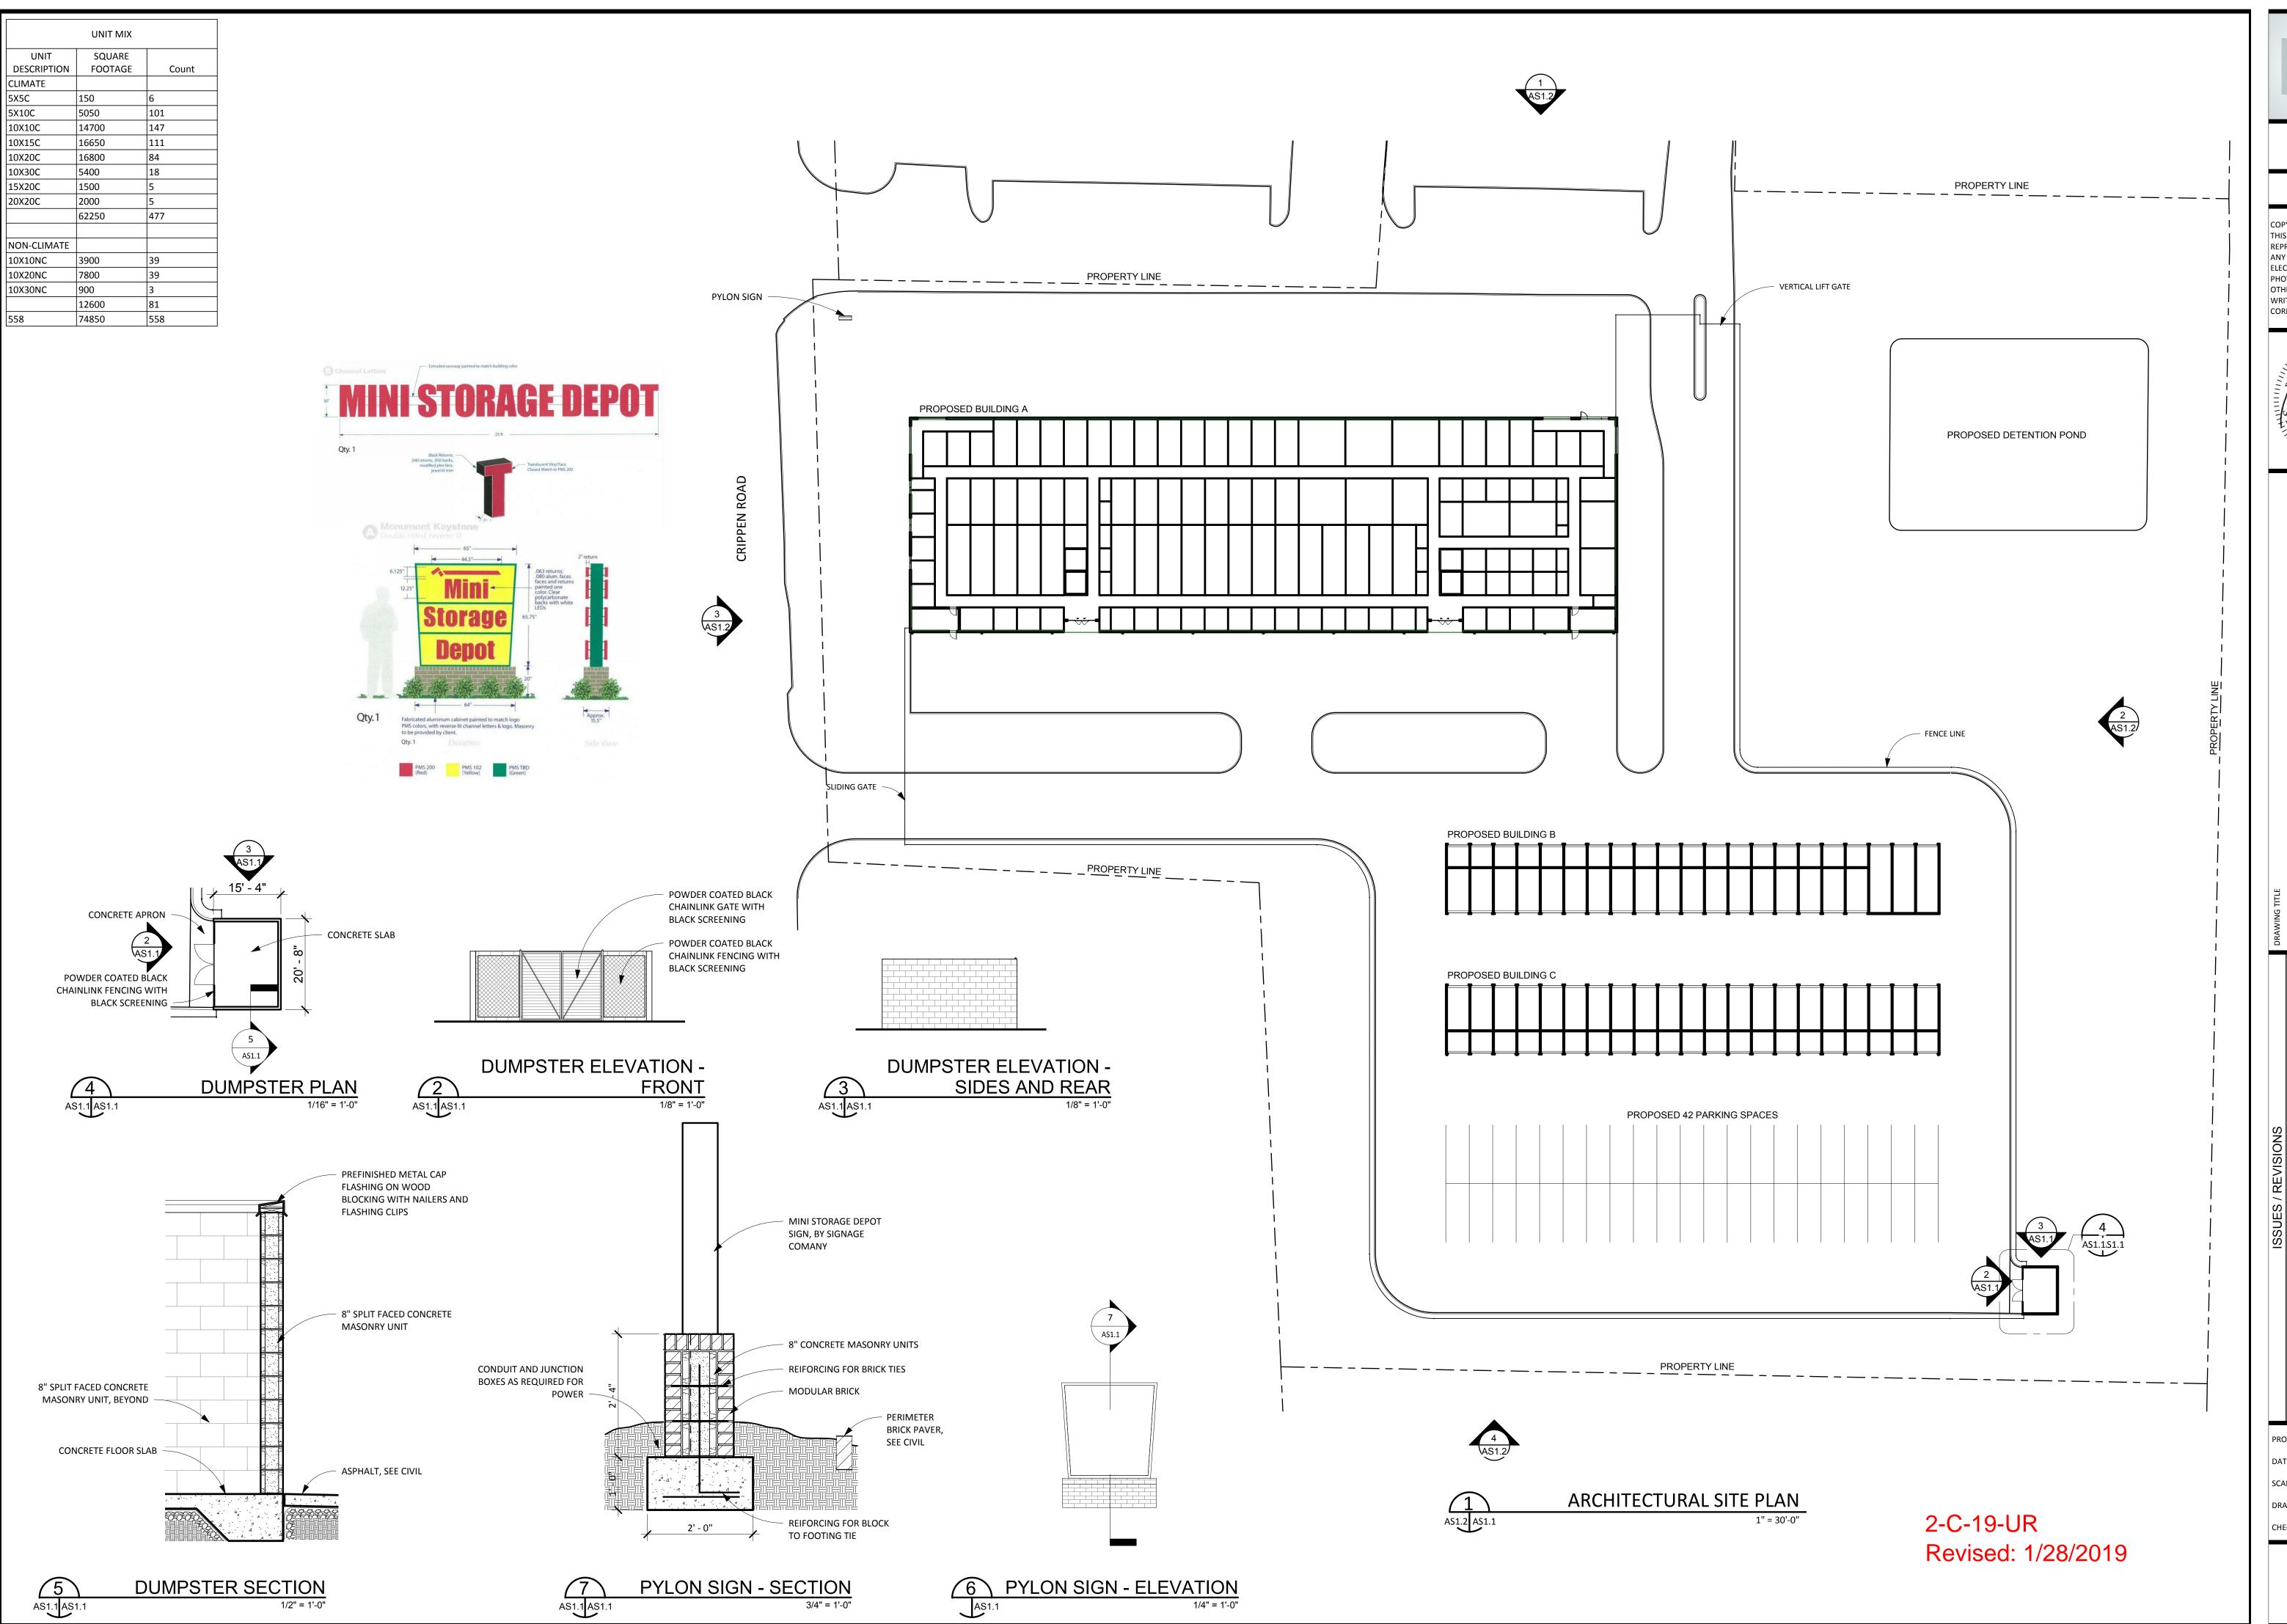
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ARCHII ECI UKAL SII E PLAN NI STORAGE DEPOT ON MAYNARDVILLE

ISSUES / REVISIONS
DESCRIPTION
01-28-2018 CITY REVIEW

PROJECT NO: 2018-0030


DATE: 12-21-2018


SCALE: As indicated

DRAWN BY: PH

CHECKED BY: PH

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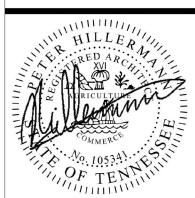


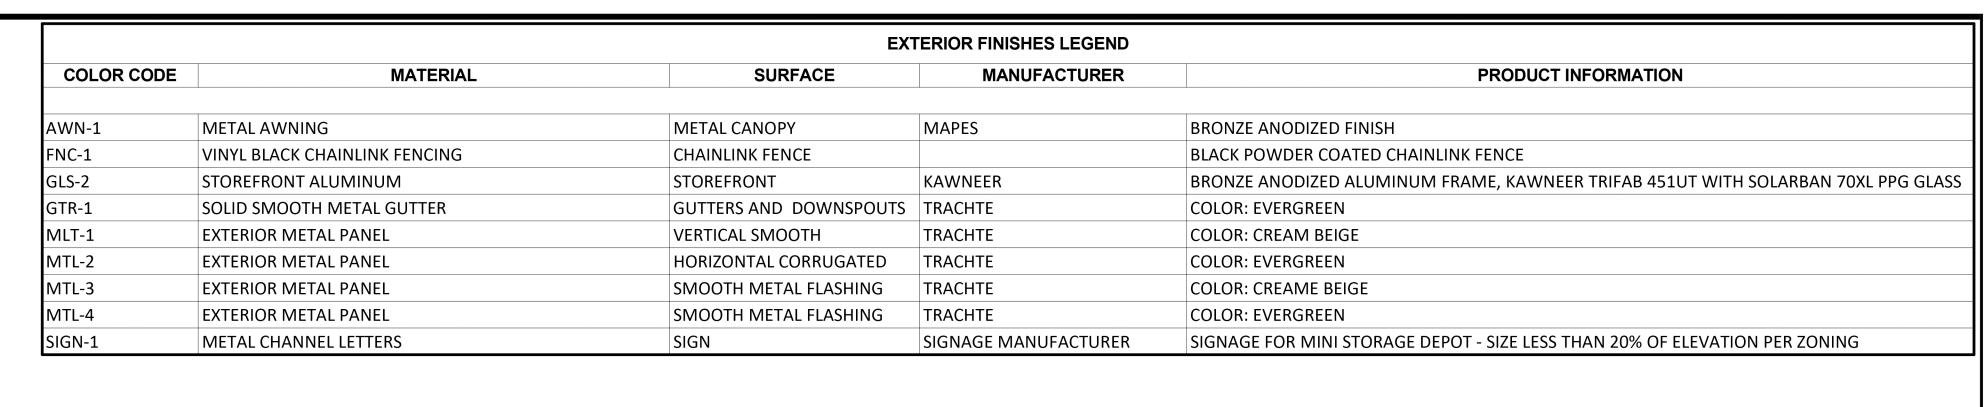
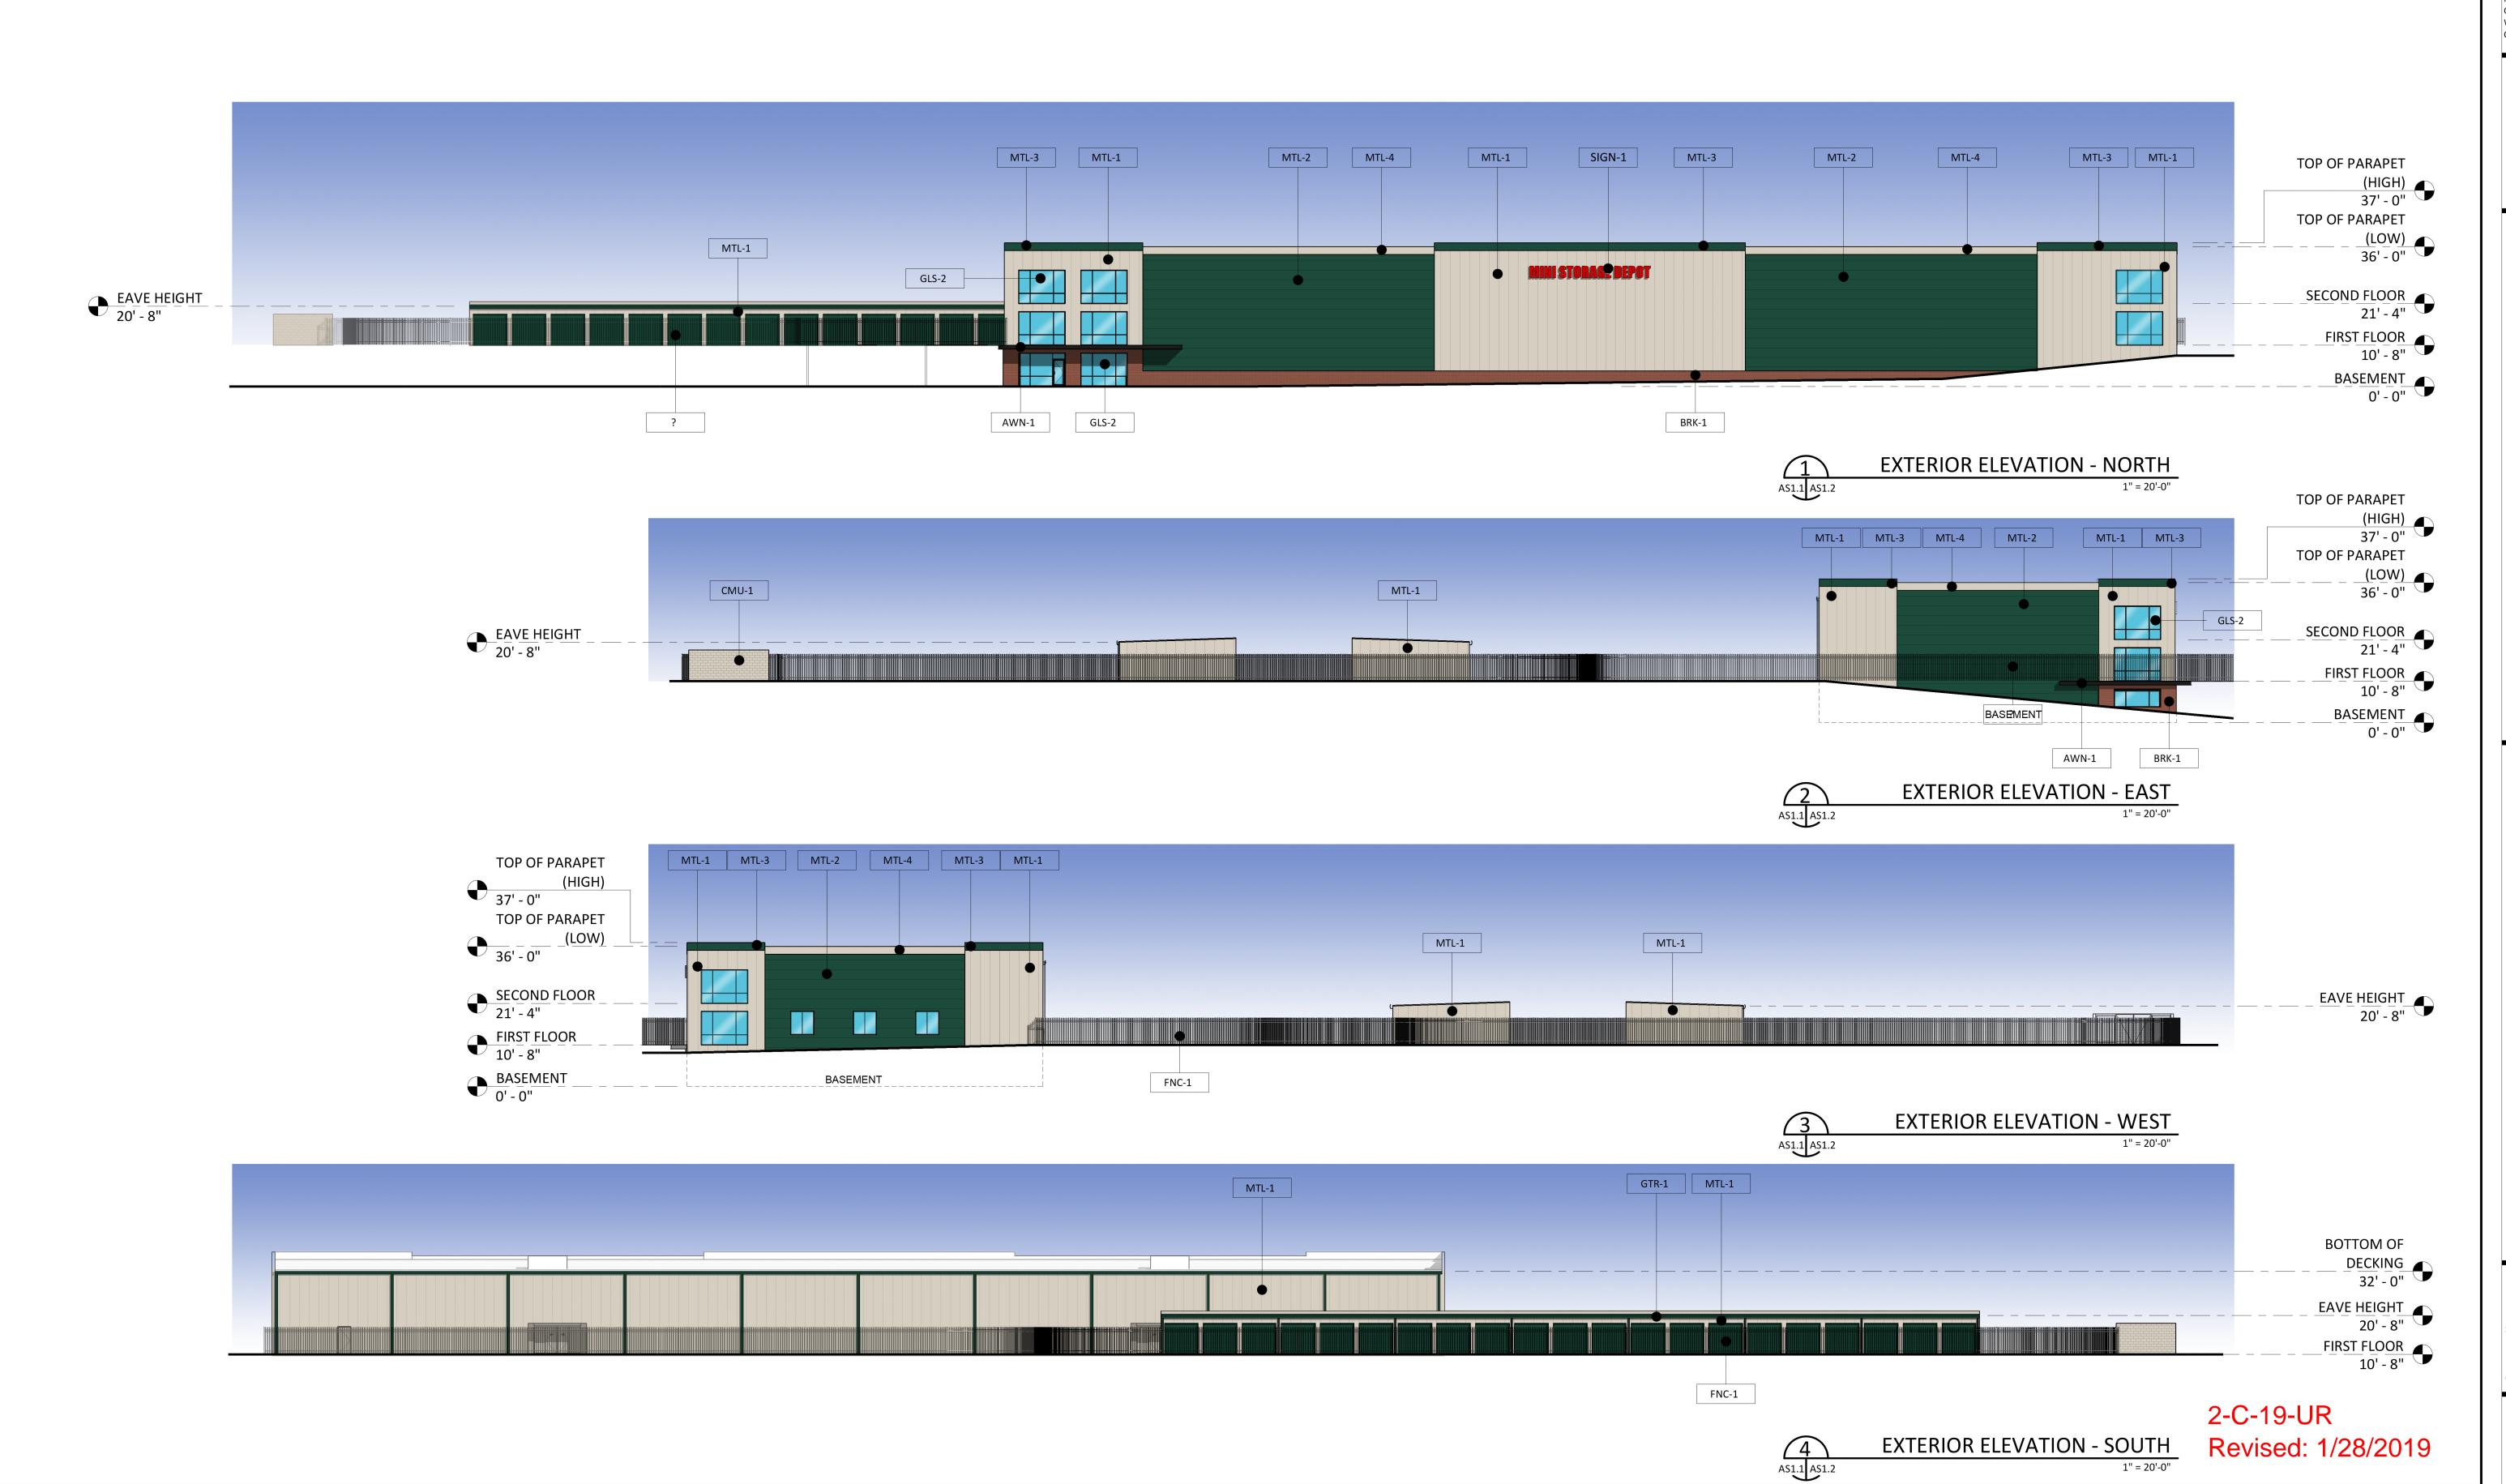
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DVILLE DVILLE

EXTERIOR SITE ELEVATION
MINI STORAGE DEPOT ON MAYNARD

ISSUES / REVISIONS

E DESCRIPTION

O18 CITY REVIEW


PROJECT NO: 2018-0030

DATE: 12-21-2018

SCALE: 1" = 20'-0"

DRAWN BY: PH
CHECKED BY: PH

AS1.2

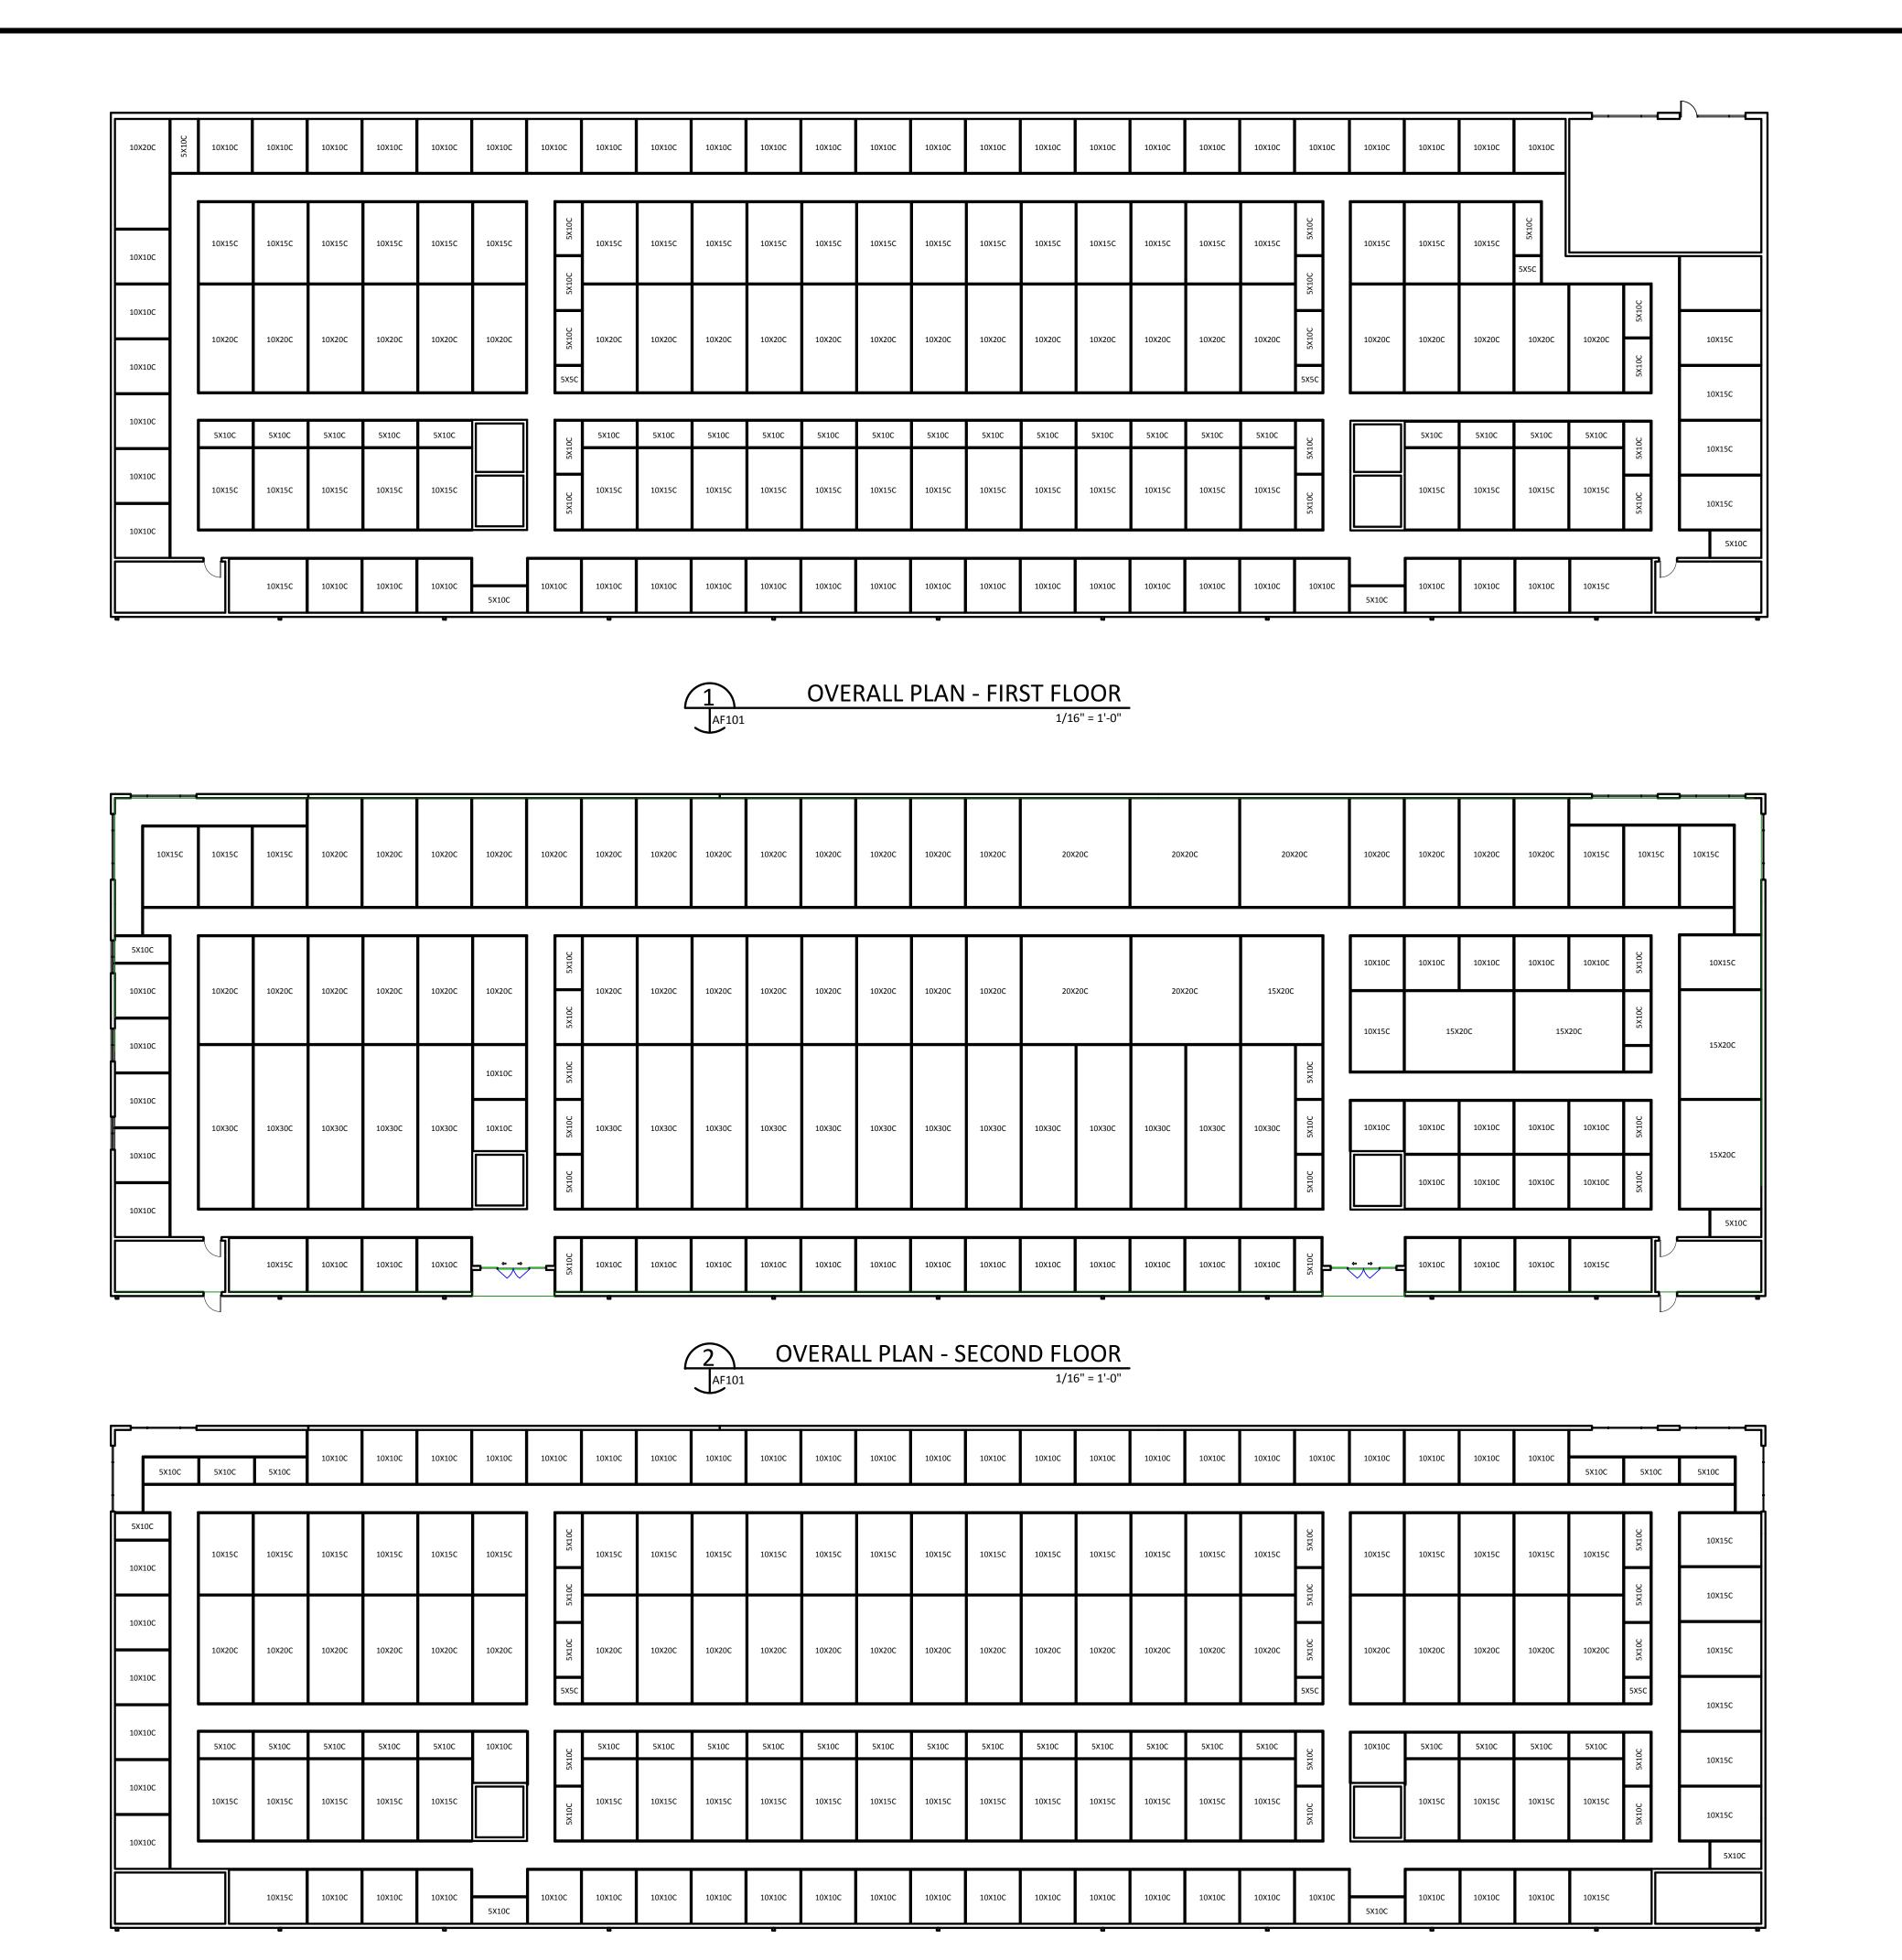

UNIT MIX UNIT SQUARE DESCRIPTION FOOTAGE 5X5C 150 5200 5X10C 104 10X10C 14400 144 10X15C 17100 114 10X20C 16000 5400 10X30C 15X20C 1500 20X20C 2000 61750 61750 476

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PROJECT MINI STORAGE DEPOT ON MAYNARDVILLE

PROJECT NO: 2018-0021

DATE:

SCALE: 1/16" = 1'-0"

DRAWN BY: Author

CHECKED BY: Checker

2-C-19-UR

Revised: 1/28/2019

AF101