


S.F. OPEN

FRONT ELEVATION

SCALE: 1/4" = 1'-0"

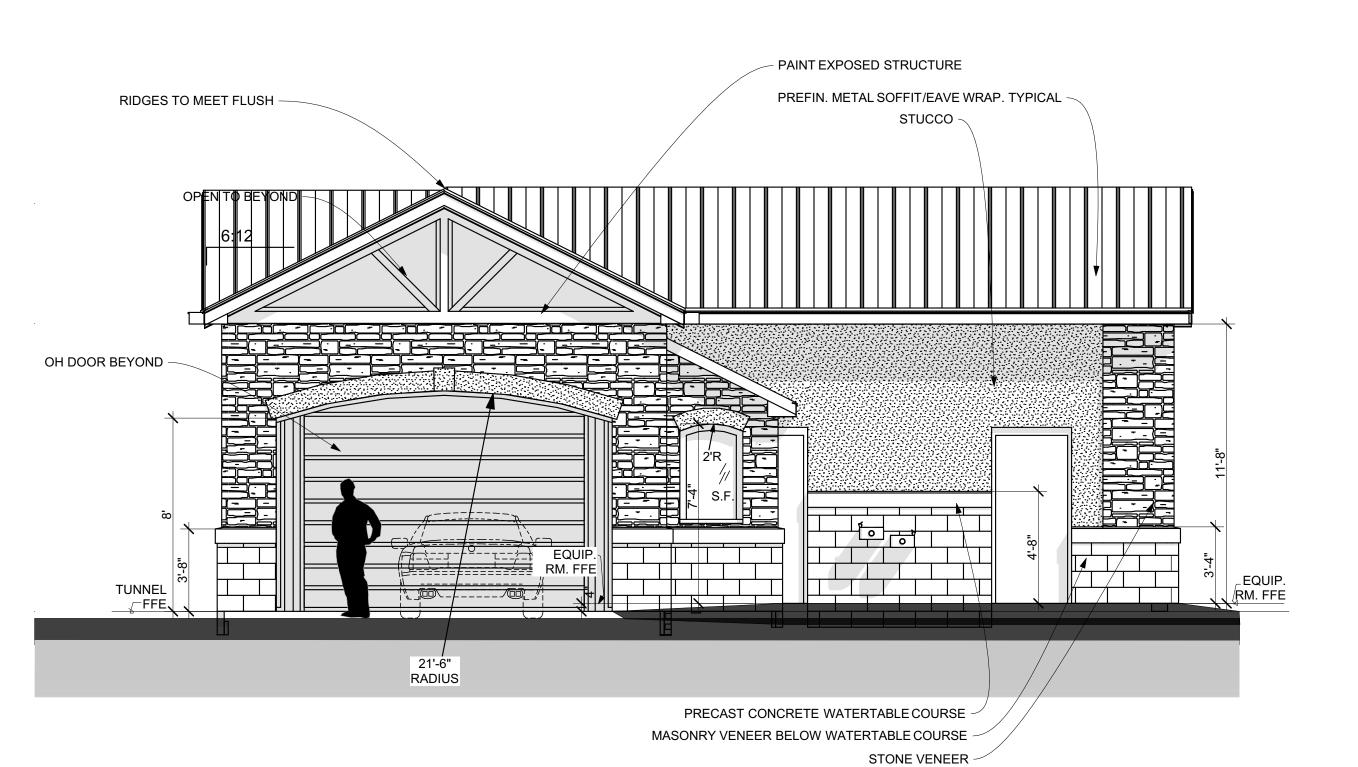


SIDE ELEVATION - ENTRY

SCALE: 1/4" = 1'-0"

PRECAST CONCRETE WATERTABLE COURSE

STONE VENEER

MASONRY VENEER BELOW WATERTABLE COURSE

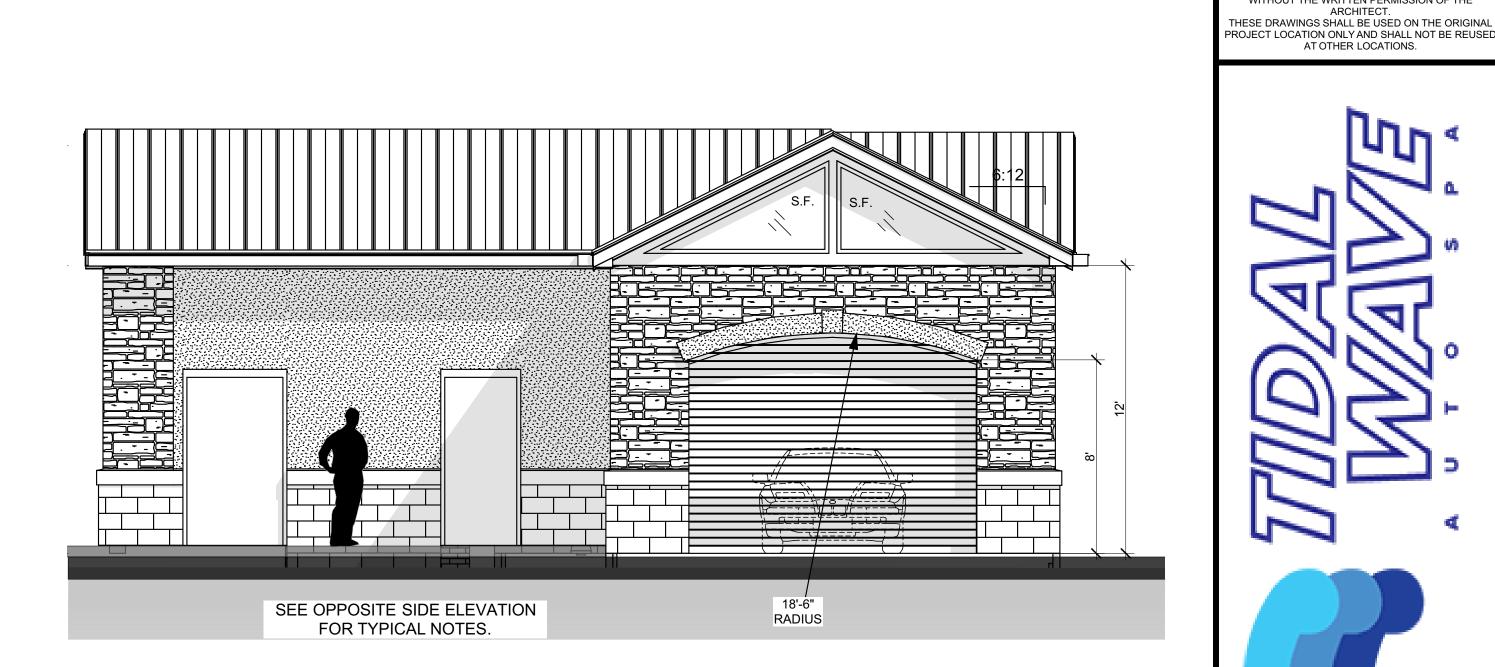

PREFIN. METAL SOFFIT/EAVE WRAP. TYPICAL

PAINT EXPOSED STRUCTURE -

SIDE ELEVATION - EXIT

SCALE: 1/4" = 1'-0"




PH 770-550-3275 mtoddalbritton architect@gmail.com

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TIDAL WAVE AUTO

EAST THOMPSON STREET THOMASTON GEORGIA 30286



EXTERIOR ELEVATION

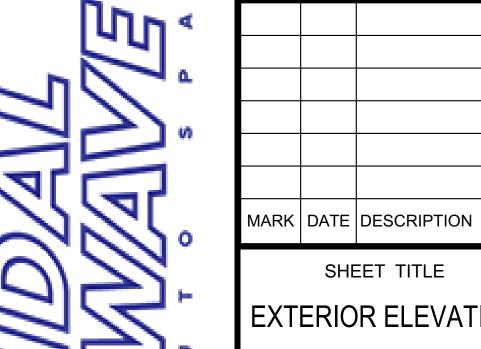PROJECT DATE: ##### PROJECT NUMBER: ## DRAWN BY: Name



M. TODD ALBRITTON **ARCHITECT**

202 EAST MAIN STREET THOMASTON, GEORGIA 30286 PH 770-550-3275 mtoddalbrittonarchitect@gmail.com

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NEW TIDAL WAVE AUTO SPA

> 1800 RICHMOND ROAD WILLIAMSBURG, VIRGINIA

TIDAL WAVE AUTO

EAST THOMPSON STREET THOMASTON GEORGIA 30286




MARK DATE DESCRIPTION

SHEET TITLE

COLOR ELEVATIONS

PROJECT DATE: xxxxx


PROJECT NUMBER: ## DRAWN BY: Name

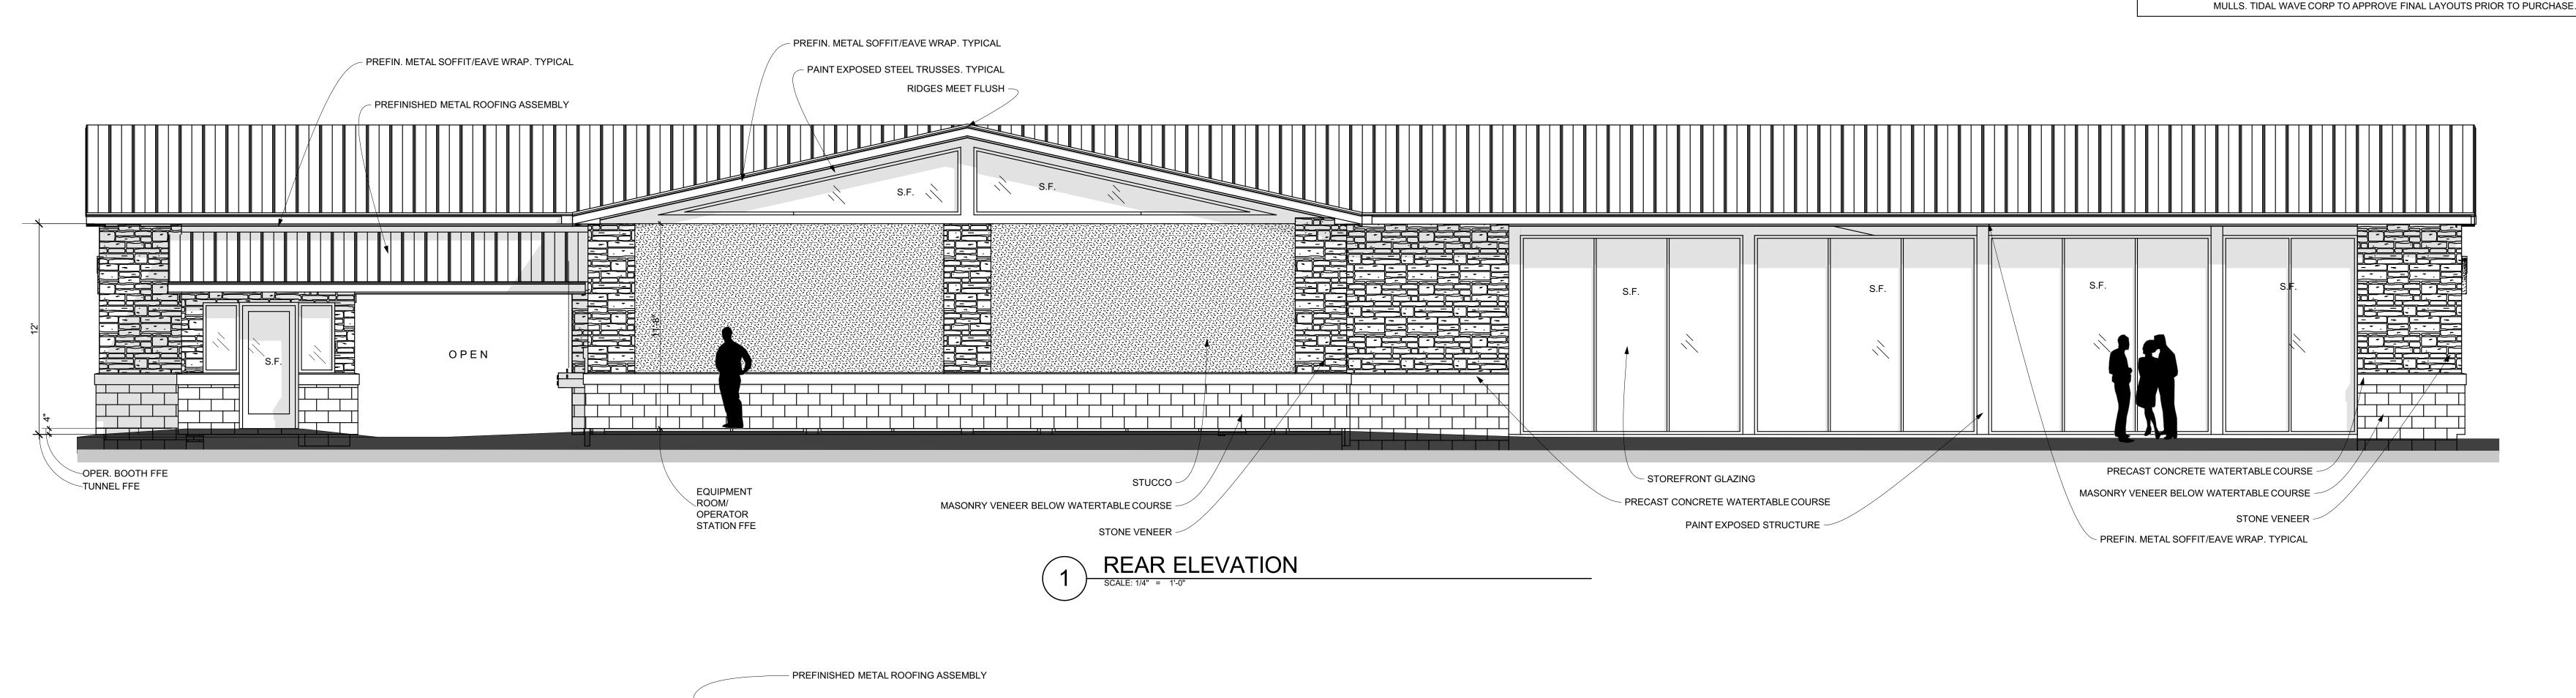

S.F. OPEN

FRONT ELEVATION

SCALE: 1/4" = 1'-0"

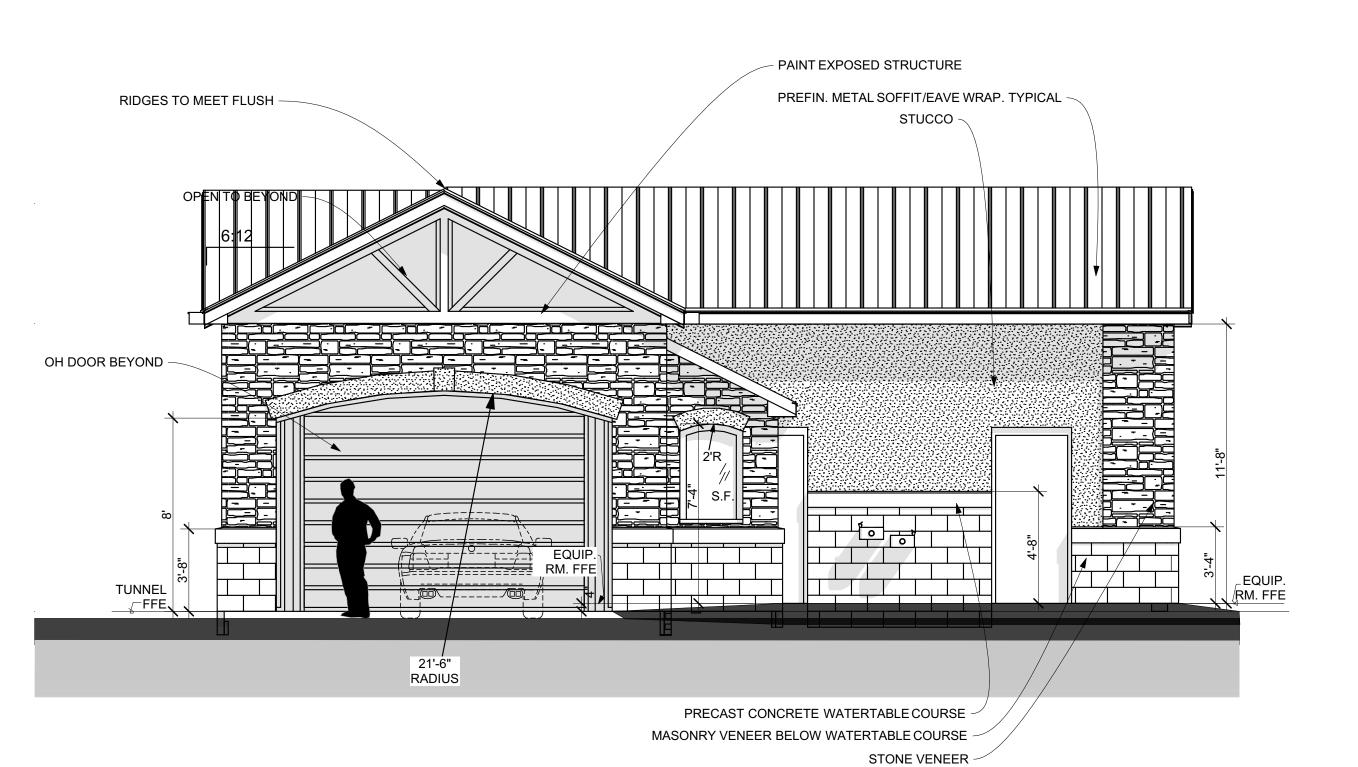


SIDE ELEVATION - ENTRY

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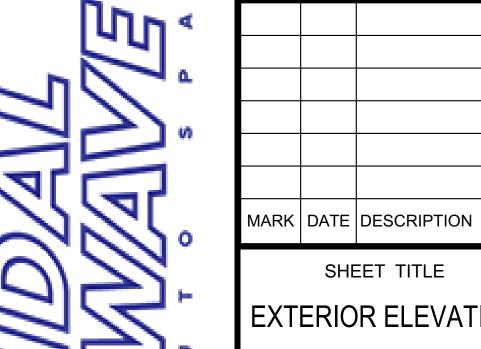
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TIDAL WAVE AUTO

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EXTERIOR ELEVATION

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> 1800 RICHMOND ROAD WILLIAMSBURG, VIRGINIA

TIDAL WAVE AUTO

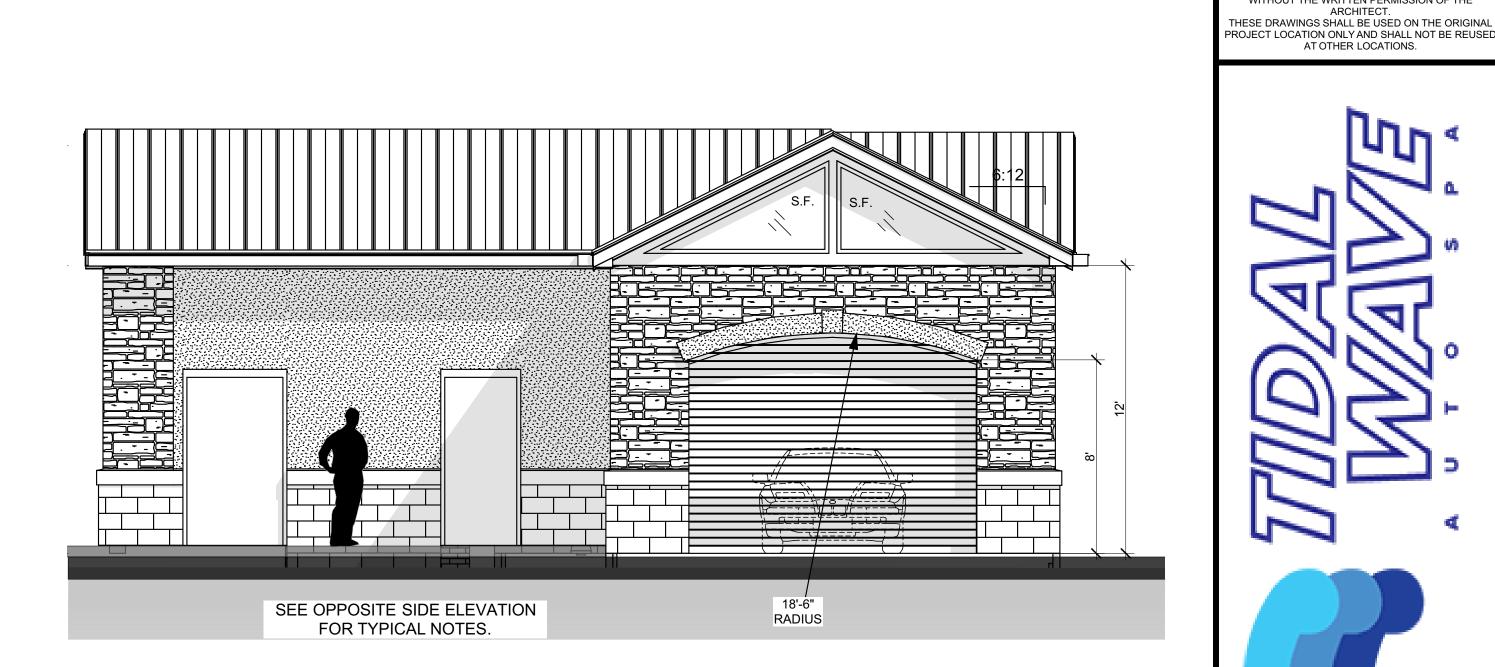EAST THOMPSON STREET THOMASTON GEORGIA 30286



MARK DATE DESCRIPTION

SHEET TITLE

COLOR ELEVATIONS

PROJECT DATE: xxxxx

PROJECT NUMBER: ## DRAWN BY: Name





M. TODD ALBRITTON ARCHITECT 202 EAST MAIN STREET THOMASTON, GEORGIA 30286 PH 770-550-3275 ddalbrittonarchitect@gmail.

NEW TIDAL WAVE AUTO SPA

1800 RICHMOND ROAD WILLIAMSBURG, VIRGINIA

TIDAL WAVE AUTO SPA

EAST THOMPSON STREET THOMASTON GEORGIA 30286



MARK DATE DESCRIPTION SHEET TITLE

COLOR ELEVATIONS


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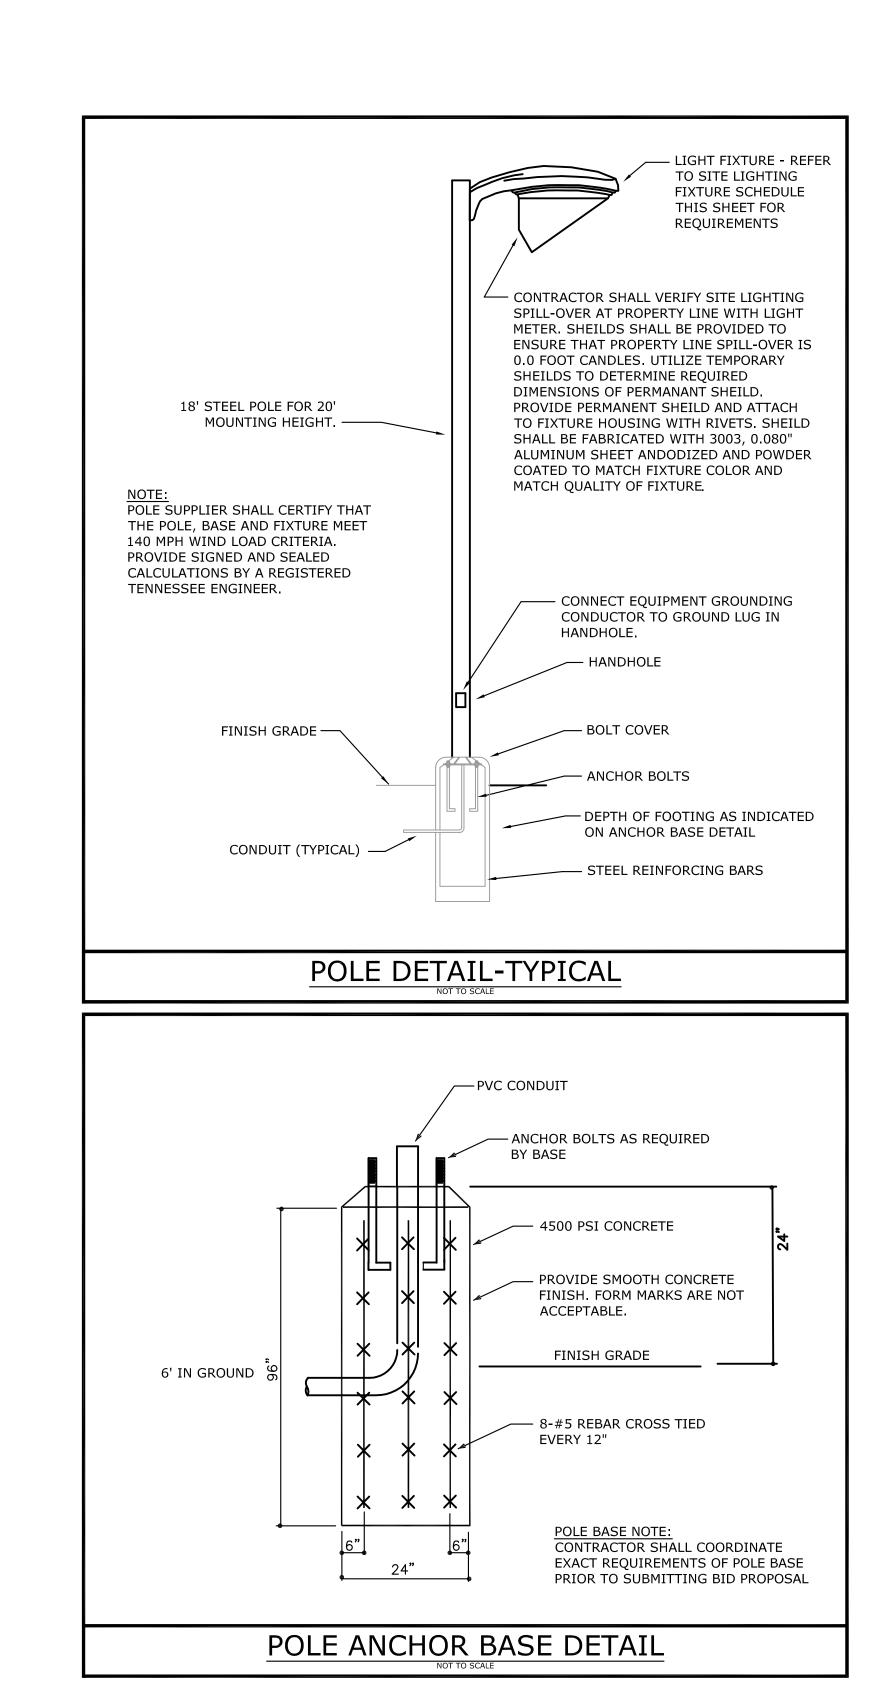
PROJECT NUMBER: ##

A2.1A

SITE LIGHTING FIXTURE SCHEDULE									
SYMBOL	LABEL	QTY	CATALOG NUMBER	MANUFACTURER	DESCRIPTION	LUMENS PER LAMP	LIGHT LOSS FACTOR	WATTAGE	
•	SP3	9	OSQ-A-XX-4ME-B-57K- ULXXXXX W/OSQ-BLSMF		CREE OSQ SERIES AREA LUMINAIRE, TYPE III MEDIUM W/ BACKLIGHT SHIELD, B INPUT POWER DESIGNATOR, 5700K	9196	0.9	86	
0	WM1	4	VWPV-L60-740-TFT-XXX-CGL-DIM-UNV	OUTDOOR	VOLTAIRE VERTICAL ARCHITECTURAL WALL PACK WITH FORWARD THROW MOLDED REFRACTIVE CLEAR ACRYLIC LED LENS AND A CLEAR GLASS LENS.	3829	0.9	42	
0	LC2	13	TFX2 LED 40K Mvolt	LITHONIA LIGHTING	TFX2-SERIES FLOODLIGHT, 4000K, 70CRI AND TYPE FL DISTRIBUTION	12827	0.9	94	

Statistics	Statistics						
Description	Symbol	Avg	Max	Min	Max/Min	Avg/Min	
Boundary	+	0.7 fc	1.6 fc	0.0 fc	N/A	N/A	
Parking Lot	+	5.3 fc	23.3 fc	0.2 fc	116.5:1	26.5:1	



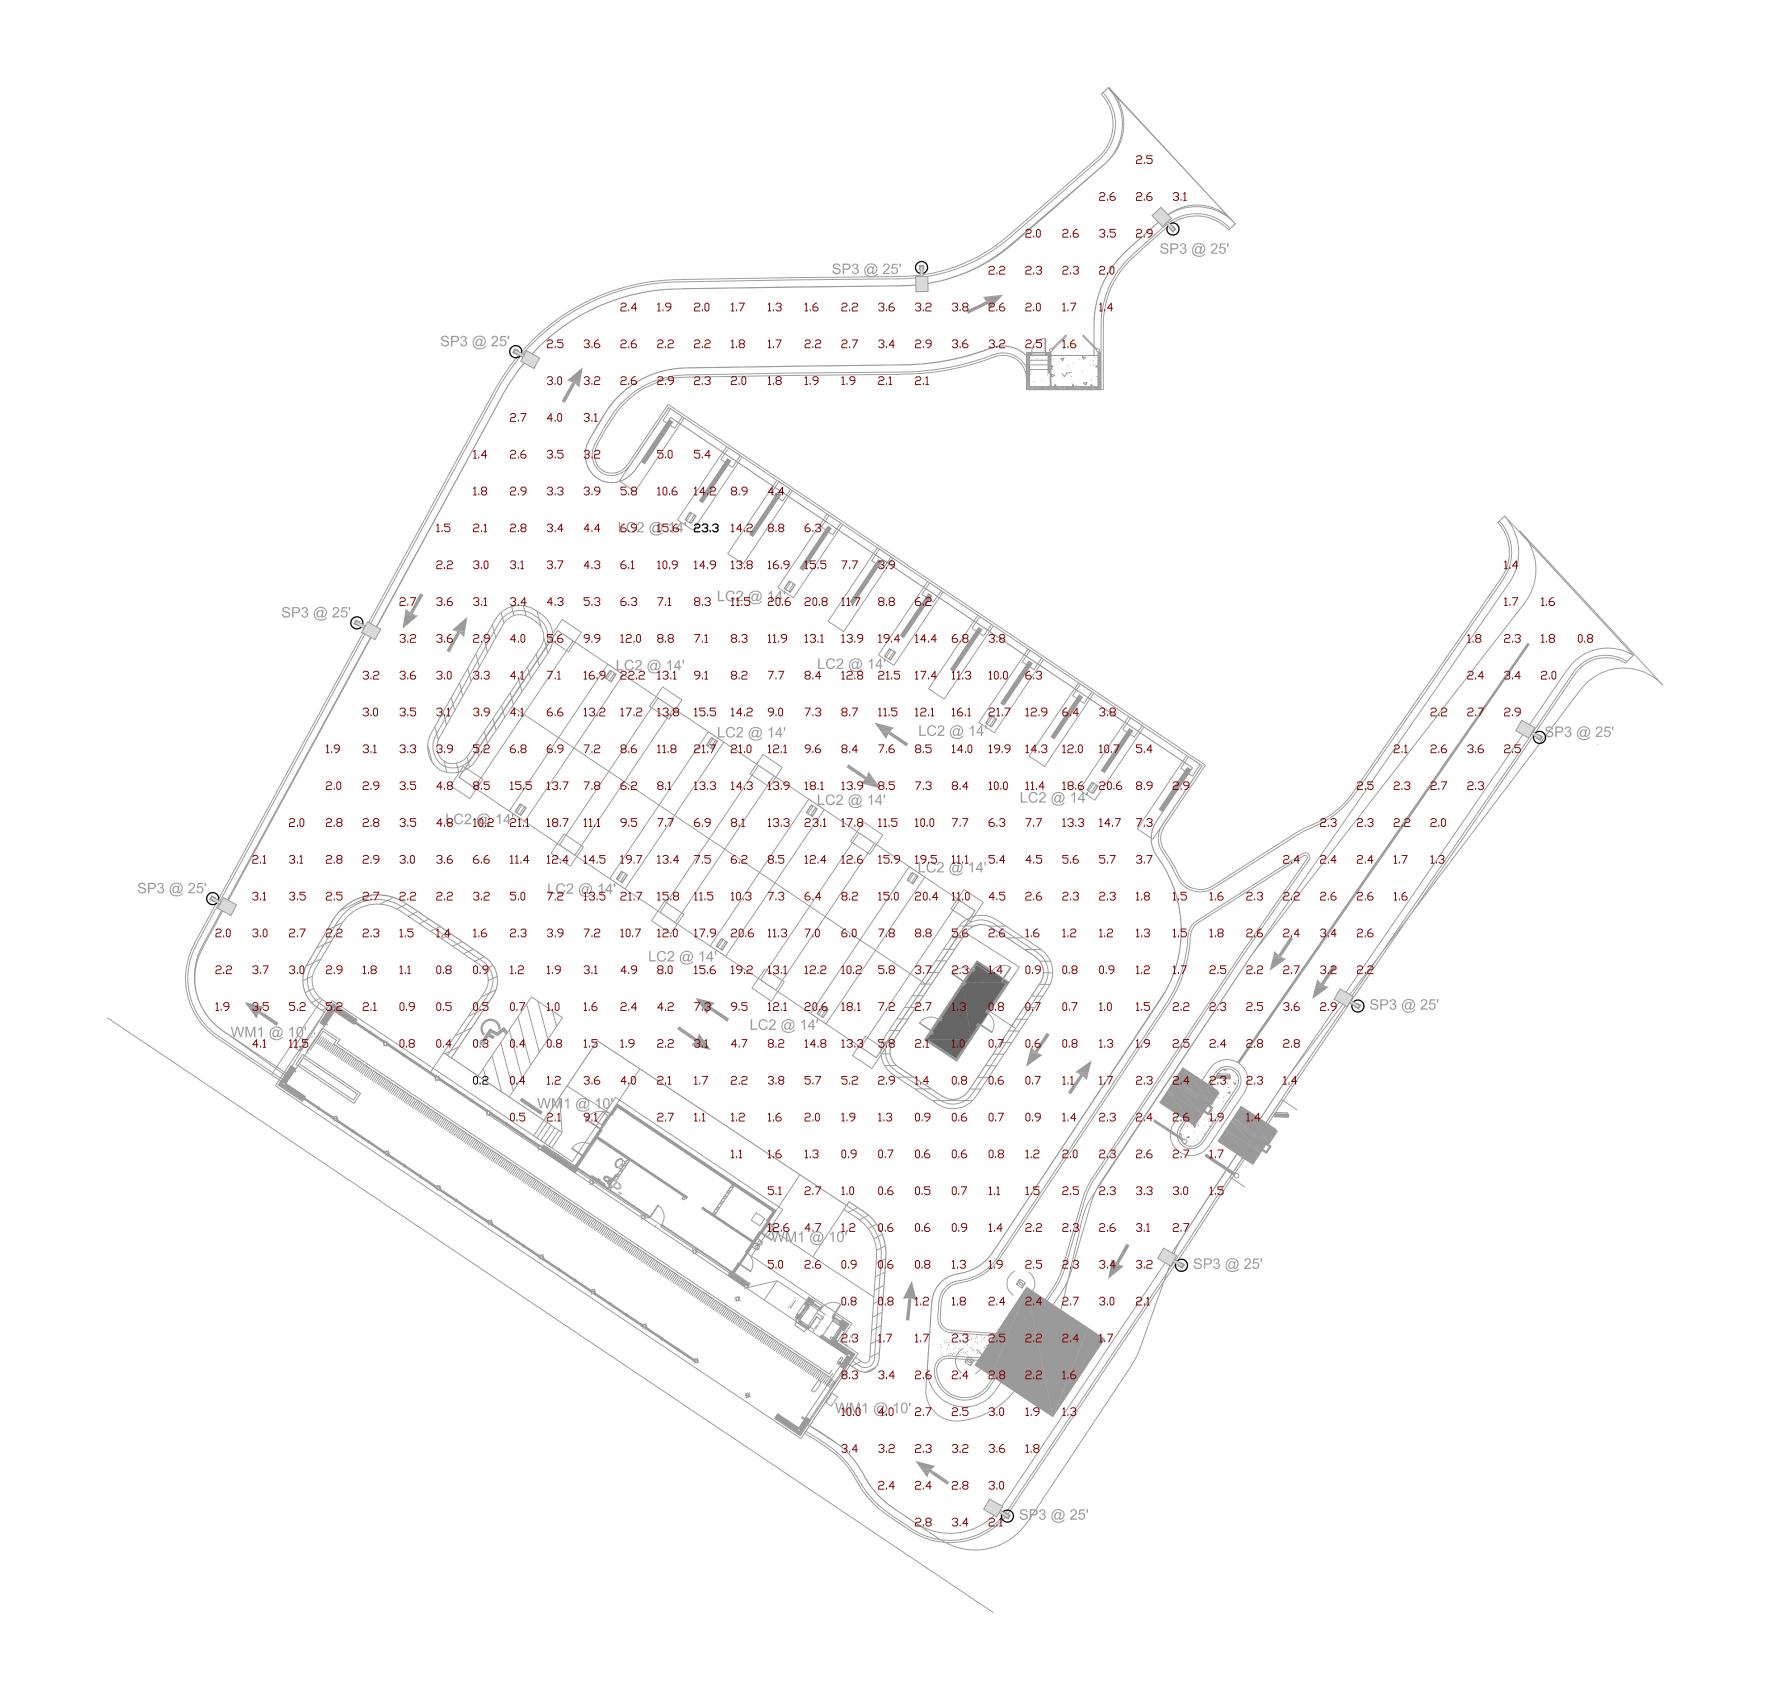

3-C-23-DP Received 2/21/2023 M. TODD ALBRITTON

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NEW TIDAL WAVE AUTO SPA 134 LEFT ENTRY

> STD NORRIS EW

NORRIS FWY & JESSILEE DR KNOXVILLE, TN 37938

OWNER:
TIDAL WAVE
AUTO SPA

EAST THOMPSON STREET THOMASTON GEORGIA 30286



MARK DATE DESCRIPTION

SHEET TITLE


SITE PHOTOMETRIC PLAN

PROJECT DATE: 02.20.2023

PROJECT NUMBER: 2023-0039

DRAWN BY: AKS

E1.2

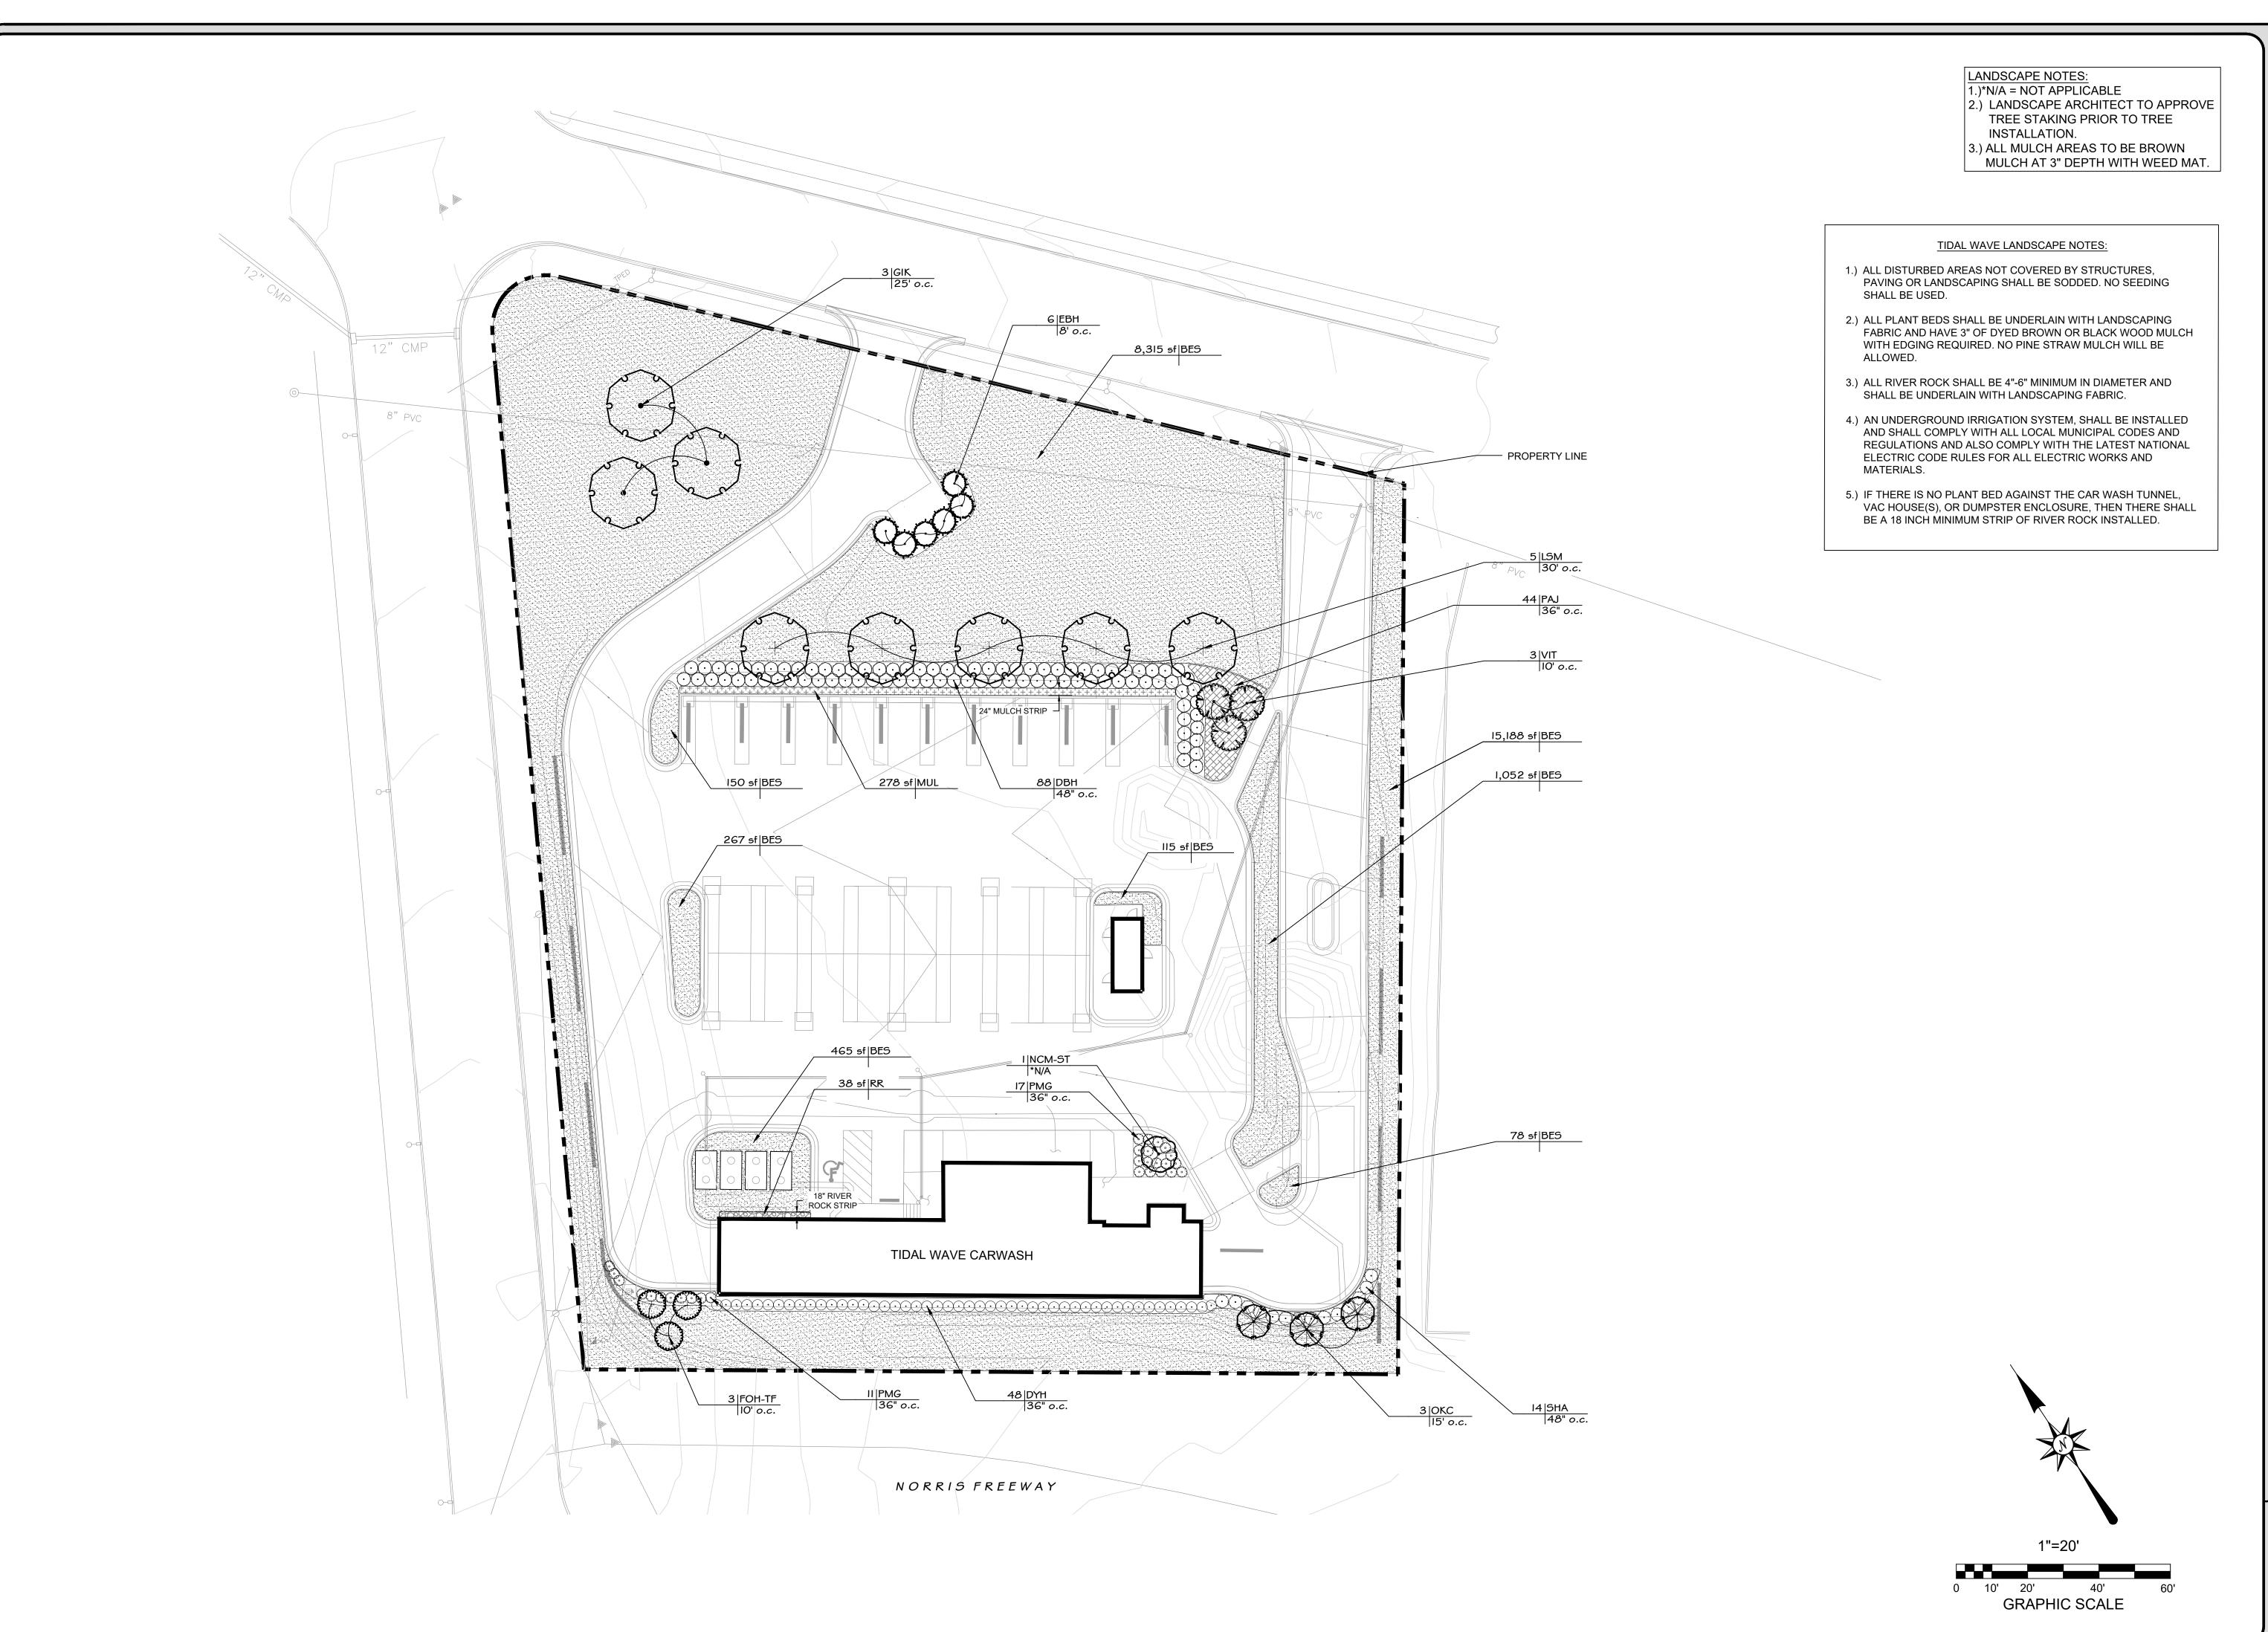

REVISIONS
DESCRIPTION
DA

TIDAL WAVE AUTO SPA
NORRIS FREEWAY
KNOXVILLE, TENNESSEE
SHJ CONSTRUCTION

- STRENGTH & ASSOCIATES,
RING - TRANSPORTATION ENGINEERING - LAND SURVEYIN
PLANNING - LANDSCAPE ARCHITECTURE
1550 WOODS OF RIVERCHASE DRIVE SUITE 200
HOOVER, ALABAMA 35244
PHONE: (205) 942-2486
FAX: (205) 942-3033

AGACCILTURE

AGACC

03.02.23 WG.NO. 1.0 R 0

L1.0 R 0 PROJECT 22-0698

TIDAL WAVE KNOX COUNTY PLANT SCHEDULE

	TREES	CODE	QTY	COMMON / BOTANICAL NAME	SIZE	CONTAINER	SPACING	REMARKS
		VIT	3	Chaste Tree / Vitex agnus-castus `Shoal Creek`	10` Ht.	B&B	10' o.c.	Full, Multi-Trunk, 3 Stem Minimum, Matching
		NCM-ST	1	Crape Myrtle / Lagerstroemia x `Natchez`	8' Ht.	B&B	*N/A	2" Cal., Standard, Full
~	0	ЕВН	6	Emily Bruner Holly / Ilex x `Emily Bruner`	8` Ht.	B&B	8' o.c.	Full To Ground, Matching
\(\frac{1}{2}\)	a d	LSM	5	Legacy Sugar Maple / Acer saccharum `Legacy`	2" Cal.	В&В	30' o.c.	12' Ht., Full, Specimen, 5` Clear Trunk Minimum
E		GIK	3	Maidenhair Tree / Ginkgo biloba `Autumn Gold` TM	2" Cal.	B&B	25' o.c.	12' Ht., Full, 5' Clear Trunk Minimum, Fruitless Male Specimen
	+	FOH-TF	3	Foster`s Holly / Ilex x attenuata `Fosteri`	8` Ht.	B&B	10' o.c.	2" Cal., Tree-Form, 3` Clear Trunk Minimum, Full
		OKC	3	Okame Cherry / Prunus x okame	10` Ht.	B&B	15' o.c	2" Cal., Matching
	SHRUBS	CODE	QTY	COMMON / BOTANICAL NAME	SIZE	CONTAINER	SPACING	REMARKS
	\odot	DYH	48	Dwarf Yaupon / Ilex vomitoria `Nana`	3 gal.	Pot	36" o.c.	Full, 18" Ht.
	\odot	SHA	14	Shamrock Inkberry Holly / Ilex glabra 'Shamrock'	3 gal.	Pot	48" o.c.	Full, 18" Ht., 18" Spread
	\odot	DBH	88	Dwarf Burford Holly / Ilex cornuta `Burfordii Nana`	3 gal.	Pot	48" o.c.	Full, 18" Ht., 18" Spread
	©	PMG	28	Pink Muhly / Muhlenbergia capillaris `Pink Cloud`	3 gal.	Pot	36" o.c.	Full, 18" Spread
	GROUND COVERS	CODE	QTY	COMMON / BOTANICAL NAME	SIZE	CONTAINER	SPACING	REMARKS
	7058870 028/803 208/807 208/800	RR	250 sf	Gravel				**Note
		MUL	278 sf	Mulch				Brown Wood Mulch, 3" Depth
		BES	24,951 sf	Bermuda Grass / Cynodon dactylon `419 Hybrid`	sod			
		PAJ	44	Parsoni Juniper / Juniperus chinensis `Parsonii`	3 gal.	Pot	36" o.c.	Full, 18" Spread
	- * * * * * * * * * * * * * * * * * * *	NOTES:						
		4 45.174		DI 10 A DI E				

1. *N/A = NOT APPLICABLE

(205) 665-1376

** = RIVER ROCK TYPE TO BE APPROVED BY OWNER
 TREES TO BE OF THE HIGHEST GRADE AND PURCHASED FROM THESE SELECTED VENDORS ONLY:

ALABAMA:
- HUNTER TREES
(866) 348-6837
- PLANTATION TREE CO.
(334) 875-9176
- GREEN VALLEY FARMS, INC.

- BOLD SPRINGS NURSERY (478) 783-4975 - SELECT TREES (706) 743-5124 - SOUTHEAST GROWERS, INC. SOUTH CAROLINA:
- SHADY GROVE NURSERY
(803) 534-5683
- RAY BRACKEN NURSERY
(864) 277-1990

- HAWKERSMITH NURSERY

(931) 455-5436

(706) 310-1151 - MID GEORGIA NURSERY, INC. (770) 567-3874

4. IF TREES ARE NOT AVAILABLE AT THE INDICATED NURSERIES, CONTRACTOR TO SUBMIT ALTERNATIVE NURSERIES. ALL TREES OBTAINED AT LISTED NURSERIES MUST MEET ALL OF THE SPECIFICATIONS REQUIRED.

LANDSCAPING NOTES:

- 1. Examination of Site: Installer shall visit the site of work to acquaint himself with condition affecting his work. By submission of bid, installer acknowledges he has complied with all requirements and no additional compensation or relief from any obligation of Contract will be considered because of lack of knowledge of the site conditions.
- 2. Notes on Drawings: Installer is responsible for all notes on drawings which call attention to particular requirements or conditions which may or may not be included in the written Specifications.
- 3. Protection of Existing Work: It shall be the contractor's responsibility to perform all work in a manner that protects completed work by others, such as curbs, utilities, storm drainage, fences, driveway aprons, drives, vegetation, etc. The contractor shall be responsible for the cost of satisfactory repair of all damage in kind resulting from his failure to comply.
- 4. Utilities: Prior to construction operations, installer shall verify locations of all utilities and structures which may or may not be indicated on the drawings. He shall conduct work so as to prevent interruption of services. Any damage shall be repaired to its original condition or satisfaction of utility company at no expense to Owner.
- 5. Right-Of-Ways: Any work performed within a state, city or utility company's R.O.W., shall be properly permitted, approved and conform to that governing authority's specifications
- 6. Substitutions: No substitutions of products, plant types or sizes shall be made without the written approval of the owner and landscape architect. Requests for substitution shall be in writing, and shall state the reasons for the substitution request, the suggested alternative, and the changes in cost. Requests in plant materials shall state the names of nurseries who have been unable to supply the originally specified material.
- 7. Quantities: Quantities of plants as shown by plant symbols on the plan shall govern over the quantities shown in the plant list. The contractor is to verify plant list totals with quantities shown on plan. The landscape architect shall be alerted by the contractor of any discrepancies prior to final bid negotiation.
- 8. Plant Materials: All plant materials shall conform to the applicable standards of the American Association of Nurserymen, Inc. American Standard For Nursery Stock. ANSI Z60.1, latest edition. Plant materials shall have been grown under climatic conditions similar to those in the locality of the project. Botanical Names take precedence over Common Names. Note: plants budding into leaf or having tender growth, shall be sprayed with an anti-desiccant at grower prior to digging. All tress shall have a straight central leader.
- 9. Installation: Install as per written Specifications and Planting Details. After placement of material, construct an earthen saucer around the root ball and fill with water. While watering, insert a rod into soil and rotate to release any air and continue until no more water will percolate into the soil. Fill holes left by rod and settlement. Remove all bamboo shafts and plastic tape from trunks prior to placing in tree pit. Remove soil from top of root ball in order to expose root flares.
- 10. Tree Pits: Installer shall dig a test tree pit for percolation. Fill hole half way with water. If tree pit will not percolate at a rate sufficient enough to insure proper root growth and survival, raise the root ball to the minimum height above surrounding grade to insure proper root growth and survival.
- 11. Topsoil: Unless otherwise specified, install a minimum of 4 inches of approved topsoil over all areas to be turfed and landscaped.
- 12. Guarantee & Maintenance: All plant materials and workmanship shall be guaranteed for a period of twelve months beginning at time of written acceptance. All sodded and areas shall be guaranteed until a full healthy stand of grass is achieved and acceptable to Owner. Trees, shrubs, and grass shall be maintained (as a part of the original bid) in a healthy growing condition until final inspection and approval by Owner. Maintain by watering on a regular basis, applications of fertilizer, insecticides and fungicides when required. Straighten leaning plants and raise plants that have settled. Remove dead or dying plants and replace with a plant material as originally specified and carry same guarantee.


 SODDING NOTES:
- 1. Soil Test Report: Installer shall provide and pay for a Soil Test Report to determine type and quantities of fertilizers and other amendments necessary to establish proper pH factor and nutrients to bring existing soil to a satisfactory level for plant growth. Testing shall include existing soil and topsoil. Furnish copies of Soil Test Report to Landscape Architect and or Engineer. Contact local County Agent for testing.
- Preparation: Install 4 inches of approved topsoil over all areas to be sodded. Rake smooth to finished grades shown. Add fertilizers and other soil amendments in quantities as recommended in the Soil Test Report, unless otherwise specified in the Specifications.
- 3. Sod: Provide fresh well-rooted sod free of weeds, nutgrass, disease, insects, and other grasses. Sod shall be machine cut with clean sharp edges to a uniform thickness with 1½ inches of topsoil and a turf height of 1 to 1½ inches. Mow prior to cutting.
- 4. Installation: Install with tight fitted joints. Lay perpendicular to direction of slope. Stagger strips to offset joints of adjacent courses. Set sod by rolling with a water ballast roller and water thoroughly to saturate sod and subsoil. Secure sod with staples on slopes 2.5:1 and steeper.
- 5. Guarantee & Maintenance: All sodded areas shall be guaranteed and maintained in strict accordance with the Specification. Maintain also by watering, fertilizing, mowing, weeding, applications of herbicides, fungicides, insecticides, until a full healthy stand of grass, free from weeds, disease, and insects is achieved and acceptable to Owner. Replace any dead sod.

IRRIGATION NOTES:

1. Landscape Contractor responsible for design build of irrigation. Landscape contractor shall provide for 100% coverage for plant material.


STABILIZATION NOTES:

- 1. Permanent stabilization shall be accomplished in all disturbed areas by covering the soil with vegetation, or other forms of soil stabilization.
- 2. The Contractor is required to initiate permanent soil stabilization measures immediately upon reaching final grade. For those areas not at final grade that will not be disturbed for greater than 13 days, the Contractor should initiate temporary stabilization per the temporary seeding or stabilization detail.
- 3. The Contractor has 7 days from initiation of stabilization to complete soil preparation, seeding, mulching, and any other required activities related to the planting and establishment of vegetation.
- 4. Soils must be prepared before installation of sod.
- 5. Final site stabilization is achieved when perennial vegetative cover provides permanent stabilization with a uniform density greater than 85 percent over the entire area to be stabilized by vegetative cover.

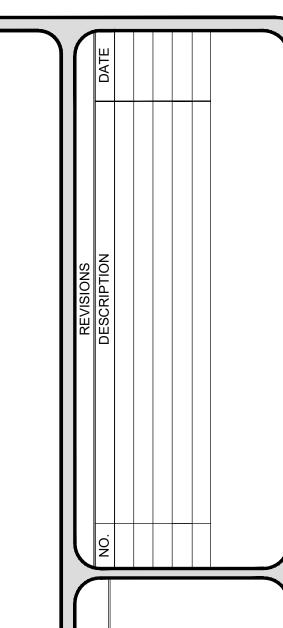


TIDAL WAVE AUTO SPA NORRIS FREEWAY KNOXVILLE, TENNESSEE SHJ CONSTRUCTION THOMASTON, GEORGIA

ENGTH & ASSOCIATES, II SPORTATION ENGINEERING - LAND SURVEYING S - LANDSCAPE ARCHITECTURE OF RIVERCHASE DRIVE SUITE 200 DOVER, ALABAMA 35244 PHONE: (205) 942-2486 FAX: (205) 942-3033

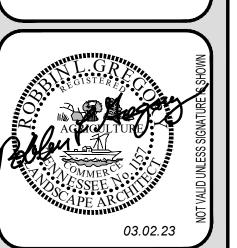


DWG.NO. L2.0 R 0 PROJECT 22-0698 SITE CONTRACTOR TO REMOVE EXISTING SOIL IN PARKING LOT ISLAND TO A DEPTH OF 2', THROUGHOUT ENTIRE ISLAND. IF NOT POSSIBLE COMPACTED SUBSOIL SHOULD BE TILLED.


STAKING NOTE: CONTRACTOR TO REMOVE ALL STAKING AT TIME OF 1 YEAR WARRANTY COMPLETION.

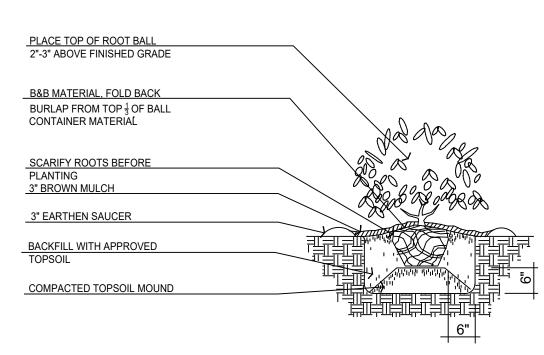

4 SHRUB PLANTING DETAIL


NTS

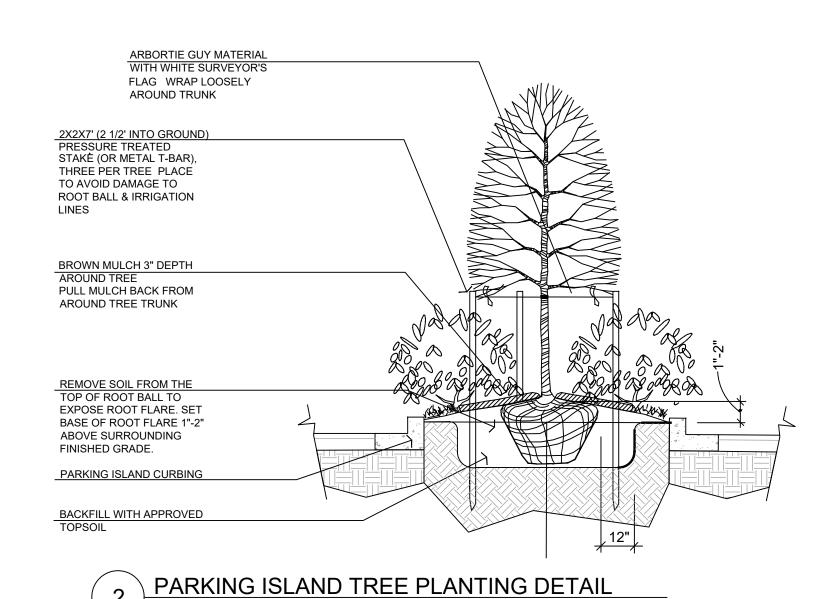

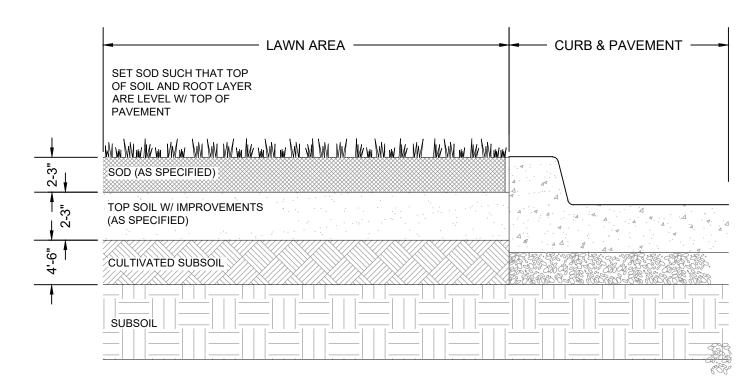


5 TURF AT CURB DETAIL

NTS

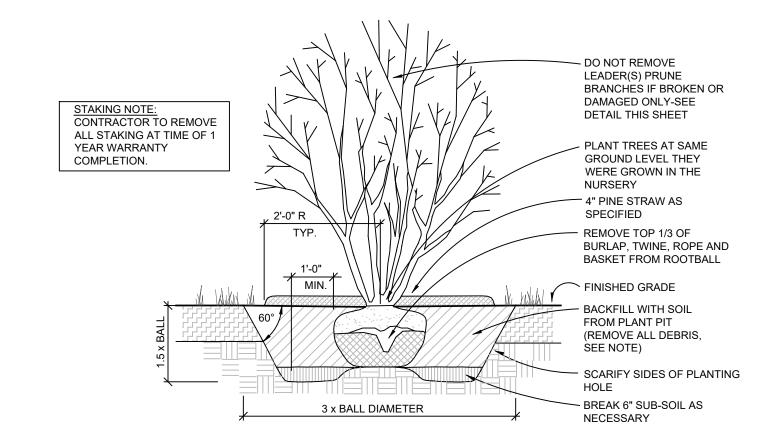



GENERAL NOTES: IF ROOTBALL IS WRAPPED IN NON-BIODEGRADEABLE BURLAP, REMOVE ENTIRE WRAP AFTER PLACED IN PIT. WHEN BACKFILLING PLANT PIT, PLACE PLANTING SOIL IN TWO LIFTS. AFTER FIRST LIFT, PUDDLE SOIL IN WITH WATER TO REMOVE ALL AIR POCKETS. PLACE SECOND LIFT AND REPEAT. CONTINUE TO PUDDLE AND FILL AS NECESSARY.

3 MULTI-TRUNK TREE PLANTING DETAIL

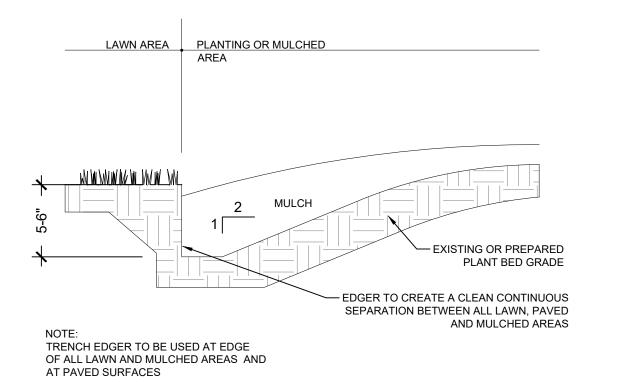

BED EDGING DETAIL

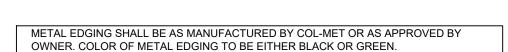


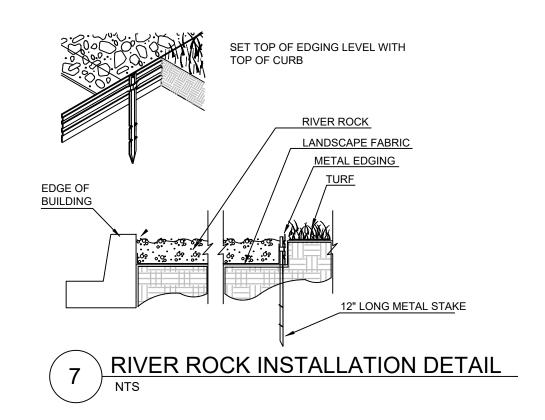



SP

TIDAL

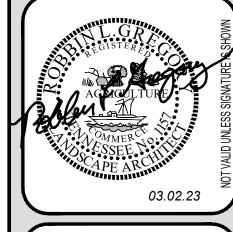


DWG.NO. L3.0 R 0 PROJECT 22-0698

Monument Sign-6' Tidal Wave

Double Faced Illuminated Monument Sign



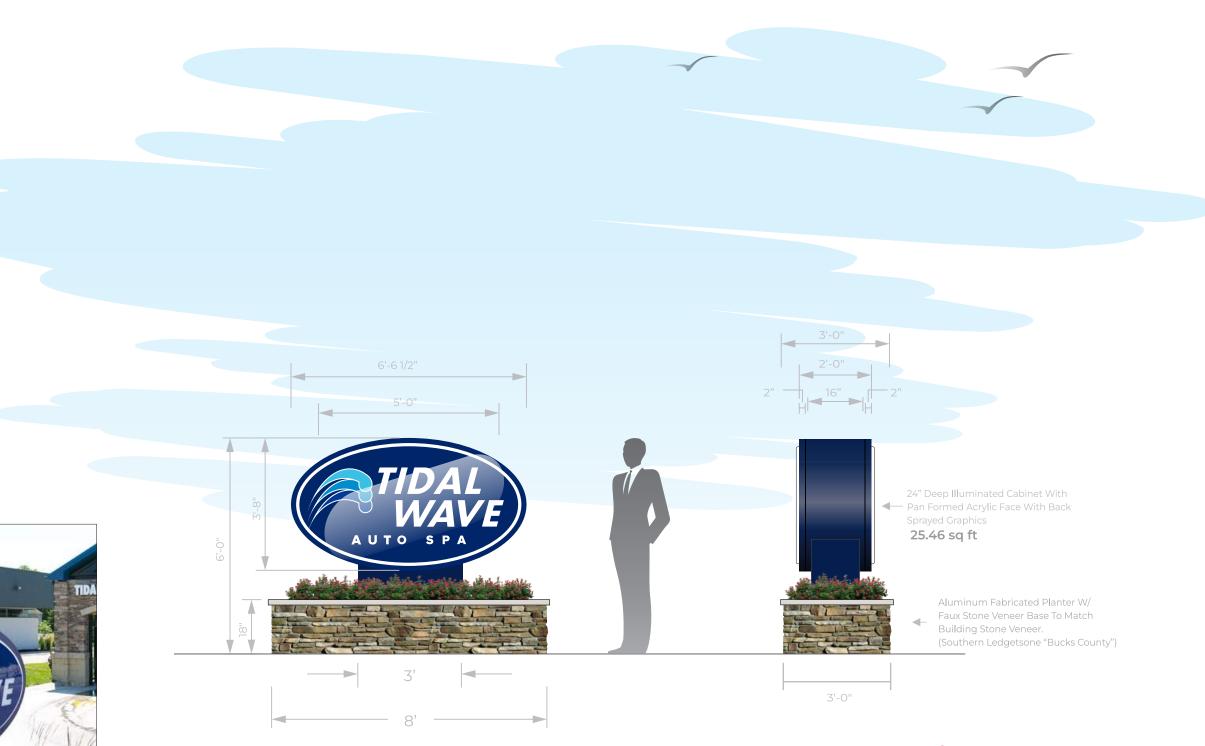

3-C-23-DP Received 2/21/2023

