

PC-1 Landscape Requirements per City of Knoxville

Parking Area

Five hundred (500) square feet of landscaping for every twenty thousand (20,000) square feet or fraction thereof paved parking area.

Total Square footage: 16,110 SF Landscape Required: 16,110 / 20,000 = 500 SF Landscape Provided: Requirement met, see plans

One (1) tree that will obtain a minimum height of forty (40) feet at maturity for each five thousand (5,000) square feet of parking area.

Total Parking Square footage: 16,110 SF
Trees Required: 16,110/ 5,000 = 3.2 (4 trees)
Trees Provided: 24 trees
Trees are 40' at maturity provided: 12 (noted with an *)

Yard Space:

One (1) tree for each five thousand (5,000) square feet of yard of open space.

Total Yard Space: 23,672 SF
Trees Required: 23,672 / 5,000 = 4.7 (5 trees)
Trees Provided: 24

Parking Lot Landscape Requirement per City of Knoxville

Between Parking Lots and Mixed Use or Non-Residential Zones: Perimeter screening areas no less than five (5.0) feet wide, measured from the edge of the parking lot to the property line, shall be provided between the parking lot and any property zoned for mixed use or nonresidential purposes, including parking lots on adjacent property. Such perimeter screening areas shall be planted so as to be continuous when plants reach maturity. A

Requirement met, see plan.

Tree preservation per City of Knoxville

minimum of fifty (50) percent of the shrubs shall be evergreen.

Where trees cannot be retained pursuant to this article, or do not exist on the site, they shall be provided, within twelve (12) months of construction completion, at the rate of eight (8) trees per acre, with at least one-half of the required number being species capable of attaining a height of fifty (50) feet or more at maturity. Such trees shall have a minimum trunk diameter of two (2) inches at six (6) inches above ground at planting, unless of an ornamental variety, which shall have a minimum trunk diameter of one and one-fourth $(1\frac{1}{4})$ inches at six (6) inches above ground at planting.

Total property acreage: 2.85 acres
Required Trees: 2.85 x 8 = 22.8 (23 trees)
Trees Provided: 24
Trees are 50' at maturity provided: 12 (noted with an *)

4-F-19-UR

Revised: 3/26/2019



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Kingston Corner



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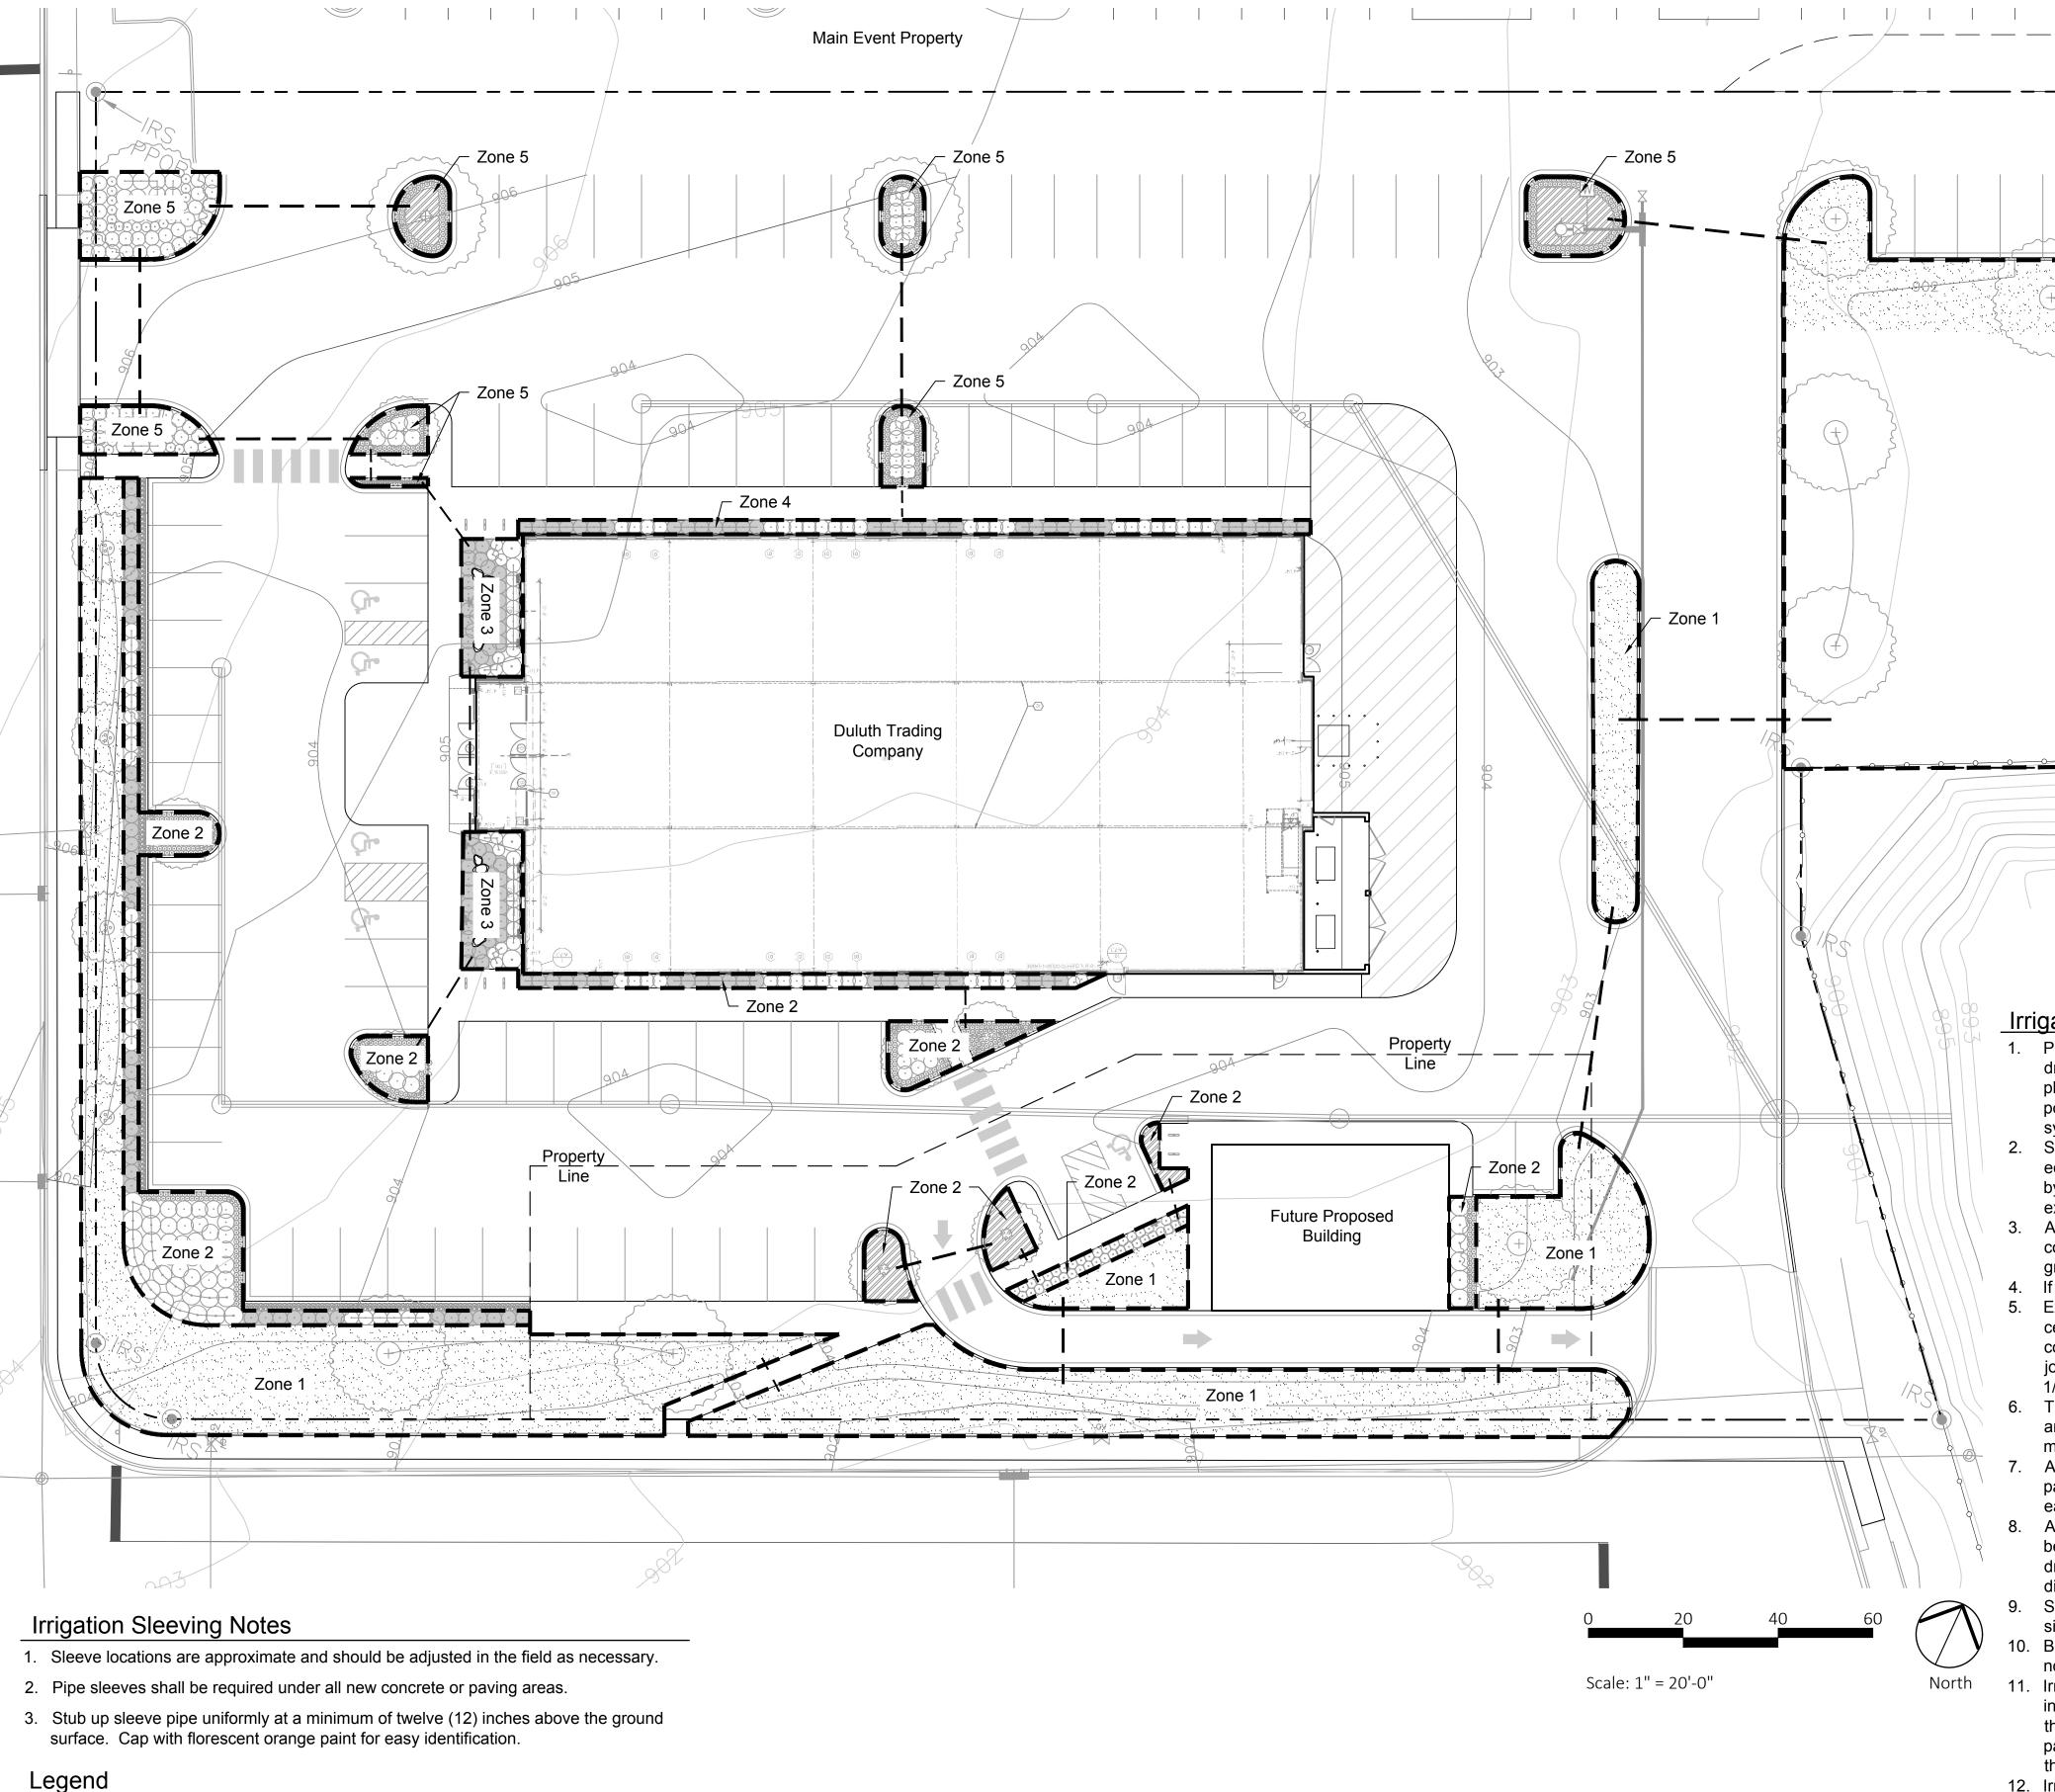
Sheet Name:

Planting Plan

Sheet Number:

L100

0 20 40 60 Scale: 1" = 20'-0" North



Irrigation zone boundary

Western facing storefront plant beds

4" PVC Pipe

Southern facing plant beds

Northern facing plant beds

19

Parking lot islands

Large open lawn

Lawn

Zone 1

Zone 2

Zone 3

Zone 4

Zone 5

Zone 6

Totals

Schedule 40

Irrigation Notes & Specifications

Zone 6

- 1. Provide lawn irrigation system consisting of mini jets, misters, pop-up risers, adj. bubblers, adj. sprayers, dripper nozzles (emitters), automatic control valves, timer, controllers and all related accessories for new planting areas as indicated on the drawings. Irrigation Contractor shall provide all work, including all power and control wiring, testing, adjusting, and start-up as required for a complete, properly functioning system.
- 2. Sprinkler heads and related accessories shall be manufactured by "rainbird", "toro", "hunter" or other equivalent approved by the Owner's Representative. Installation shall be as designed and recommended by the manufacturer's authorized representative and shall be performed by a company specializing and experienced in this type of work.
- 3. All control valves shall be manufactured by "rainbird", "toro" or "hunter" and shall be installed in concrete, fiberglass or cast iron valve boxes with heavy duty, vandal-proof covers. Set boxes flush to grade.
- 4. If a new controller is required, it shall be located per the Owner's direction.
- 5. Except as otherwise required by codes, main supply piping shall be schedule 40 PVC with solvent cemented joints, and branch piping shall be sdr 26, class 160, PVC 1120 and/or section 15c and/or local codes. Threaded adaptors and threaded pipe for PVC shall be schedule 80, minimum. Solvent for PVC joints shall be nsf approved and per pipe manufacturer's recommendations. Minimum pipe size shall be
- 6. The irrigation system shall be zoned as required to provide the most economical layout and pipe sizing and as per the site's microclimates. The system shall be designed and zoned to be compatible with a maximum of a 1-1/2" water meter size, unless otherwise approved by the Owner's Representative.
- 7. All valves and quick couplers shall be located 12" min. from sidewalks, curbs, asphalt areas, concrete paving, etc. (slopes excluded). The irrigation contractor shall ensure that there are quick couplers on each house facade in new planting areas.
- 8. All exterior wiring shall be direct burial cable or shall be in schedule 40 PVC conduit. Minimum wire shall be 18 gauge for low voltage control wiring with size increase for longer runs as required to limit voltage drop for proper operation. Provide 120 volt power supply to the controller. Mount controller location as directed by the Owner.
- Sleeves shall be installed by the Irrigation Contractor. Irrigation Contractor shall coordinate locations and size of sleeves with General Contractor prior to installation of walks, walls, curbs, drives, etc.
- 10. Backfill shall be clean materials free of rocks larger than 2" and shall be compacted to prevent noticeable settlement and irregularities.
- 11. Irrigation Contractor shall keep the premises clean and free of excess equipment, materials and rubbish incidental to the job during the installation. Upon completion of installation and before final acceptance, the Irrigation Contractor shall remove all material, equipment and debris resulting from this work. All paved areas shall be broom cleaned and the site left in a neat and acceptable condition as approved by the Owner's Representative.
- 12. Irrigation system shall be cleaned during installation by flushing all components before final installation to ensure that no dirt/debris have entered the system. After flushing all piping shall be pressure tested until proven leak-free. Flushing and pressure testing shall be coordinated with installation of plantings to prevent damage to both plants and piping system.
- 13. After all sprinkler heads and plantings are installed, adjust system for optimum coverage and coordination with plantings. Adjust all valves, alignments, and coverage for optimum performance for final approval by the Owner's Representative.
- 14. Irrigation system shall be winterized by professionals familiar with similar systems.
- 15. Irrigation system filter(s) shall be periodically checked and flushed clean to remove debris. At initial system start-up filter shall be checked every day for the first (3) three days.
- 16. Irrigation Contractor shall recommend and set the program on the controller, provide thorough, detailed operating instructions for this specific system, and give verbal operating instructions to the Owner's operating personnel.
- 17. Drip irrigation shall be used within 5' of all windows and no overspray from irrigation heads shall hit the windows.

Hedstromdesign.com 110 West Magnolia Ave.
www.hedstromdesign.com Knoxville, TN 37917

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Kingston Corner Knoxville, TN

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Duluth



Date	: 03.26.19			
Job 1	Number: 19-0	13		
Drav	Drawn By: LGG Ck'd By:			SHP
Rev	ev Description		Date	

Sheet Name:

Irrigation Zone Plan

Sheet Number:

L101

Planting Notes

- Contractor shall verify all existing conditions in the field and report any discrepancies to the Owner's Representative prior to starting work.
- 2. No planting shall occur until soil sample results have been received from all planting areas and soils are properly amended based on the results of the soil tests. See this sheet for soil sampling instructions.
- 3. No planting shall occur until percolation testing has been completed and soils have been properly amended to drain. See this sheet for percolation testing procedures.
- 4. All new plant material shall conform to the guidelines established for nursery stock published by the American Association of Nurserymen, Inc. In addition, all new plant material for the project shall be of the highest specimen quality. Plant material delivered to the site that does not meet the requirements stated herein may be rejected by the Owner's Representative.
- 5. Do not assume trunk flare will be exposed at the nursery. Contractor to expose trunk flares to check for root girdling. Pull mulch away from the trunk flare of trees and from
- 6. No plant material shall be planted before acceptance of rough grading. The finished grade shall not cover any part of the tree trunk flare. See tree planting detail.
- All new plants shall be balled and burlapped or container grown unless otherwise noted on the plant list.
- 8. The Contractor shall locate and verify all existing utility lines prior to planting and report any conflicts to the Owner's Representative.
- Stake location of all proposed trees and planting areas for approval by the Owner's Representative prior to the commencement of planting.
- 10. Planting plans are not layout plans. Plants may need to be shifted in the field, based on the existing conditions. Coordinate with the Owner's Representative prior to any changes.
- 11. All lawn areas disturbed by construction operations inside and outside the limit of work shall be prepared and sodded as noted herein.
- 12. Prepare all shrub beds with planting soil to a minimum depth matching the depth of shrub root balls; prepare perennial beds with a minimum of 12" planting soil; prepare groundcover beds with a minimum of 6" planting soil.
- 13. All plant beds are to receive one and a half inches (1.5") of double shredded hardwood mulch.
- 14. Thoroughly water trees and shrubs during the first 24 hours after planting. Wet the soil to a depth of 18-24". When runoff starts, stop watering, let the water soak in and repeat until the proper depth is wet.
- 15. Any proposed substitutions of plant species shall be made with plants of equivalent overall form, height, branching habit, flower, leaf, color, fruit, and culture only as approved by the Owner's Representative.
- 16. All areas to be sodded shall receive soil preparation as noted herein prior to sodding, unless otherwise noted on plan.
- 17. Contractor's base bid to include all materials, labor, permits, equipment, tools, insurance, etc. to perform the work as described in the contract documents.
- 18. Contractor to complete work within schedule established by Owner.
- 19. Contractor to provide one year warranty for all material from date of substantial completion. Contractor to provide interim maintenance (watering, pruning, fertilizing, guying, mowing, trimming, adequate drainage of ponding areas, edging, weeding, mulching, and general landscape clean-up) until substantial completion notice is provided by the Owner's Representative. Application of insecticides/herbicides must be approved by Owner's Representative prior to use on site.
- 20. Plant beds to join walks or walls at an angle between 90° & 60°.
- 21. Shade trees to be planted a minimum of 5' from sidewalks, water line, sewer line or manholes. Evergreen and ornamental trees to be planted a minimum of 3' from sidewalks, water line, sewer line or manholes.
- 22. Mulch rings around shade trees to be a minimum diameter of 5' and a minimum of 3' around ornamental and evergreen trees. If evergreen trees are specified as full to ground, mulch ring to extend a minimum of 12" beyond the edge of plant.
- 23. Square footage of sod quantities is approximate and is an estimate of the disturbed areas. Contractor to verify quantities prior to purchase and installation.

Groundcover/perennial, place crown above

PLAN

See Percolation test notes, this sheet.

mass prior to planting.

Undisturbed or compacted subgrade must percolate.

Reject all plants that are root-bound and break up root

mulch, space as shown on plant list

- 24. See civil drawings for further information regarding:
- Locations of existing and proposed structures, paving, driveways, cut and fill areas, and retention areas.
- Limits of construction.
- Locations of existing and proposed utilities or easements.
- 25. See electrical drawings for parking lot light locations. Trees may need to be adjusted based on location of light poles.

Percolation Test Notes

- 1. Dig a hole 18- 24" deep & a minimum of 6" wide.
- 2. Fill hole with water to the top and let drain for several hours. Ideally let the hole pre-wet over night and test the following day.
- 3. Refill hole to within a couple inches of the top.
- 4. To aid in measurement, place a stick across the top of the hole and use a second stick to mark periodic drops in water level; mark side of hole; or mark soil on side of hole with nail or stick.
- 5. Measure drop in water level after 30 minutes and one hour. If possible measure drop in water level the next day.
- 6. Determine drop in water level per hour. If water level in hole drops more than one inch per hour, it is well drained and suitable for all plant species.


Instructions For Existing Soil Sampling:

- 1. Using a spade, dig a v-shape hole to a 6" depth; then cut a thin slice of soil from one side of the hole. Place the slice in a plastic bucket, do not use a metal bucket. Mix slices together and fill a plastic sample bag with three (3) cups of dirt. The sample bags can be ziploc bags that are labeled with the project name and sample number.
- A well mixed composite from 10 to 20 random locations should be
- subsampled to make the three (3) cup sample.
- Send samples to Waypoint Analytical Labs, Inc., 2790 Whitten Road,
- 5. Results to be copied to the Owner.

See plant list

for spacing

plant bed

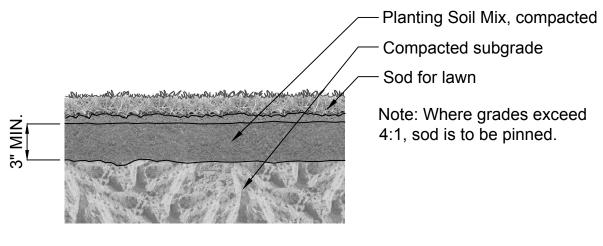

Groundcover/Perennial Planting Detail


Sod Detail
Scale: NTS

Size of pot plus 4

of the pot size

Groundco Scale: NTS

- Mark the plan to show soil sample locations.
- Memphis, Tennessee 38133, 800-264-4522, www.al-labs.com.

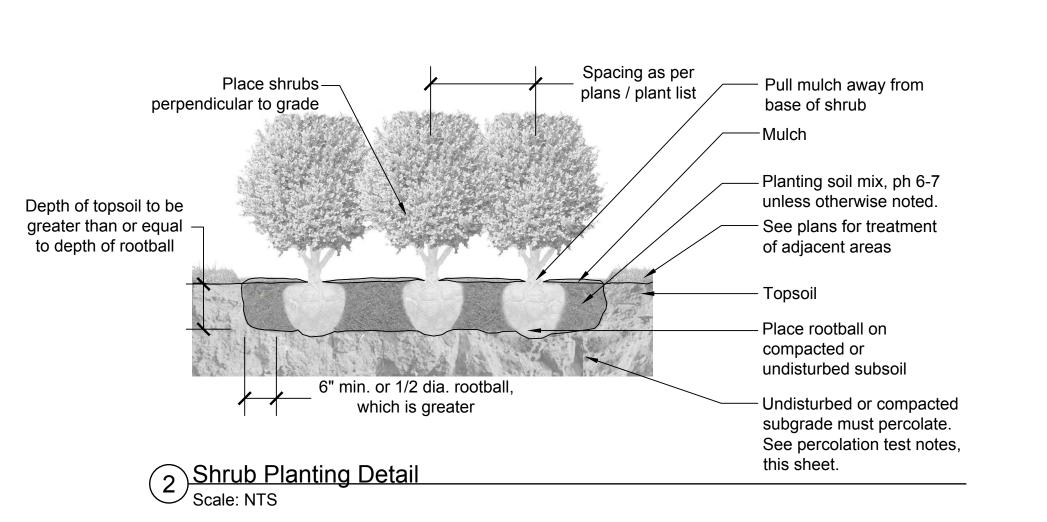

Plant Schedule

EVERGREEN TREES

ORNAMENTAL TREES

SHRUBS

SOD

HARDSCAPE

SHADE TREES

Key | Quantity | Botanical Name

2 Liriodendron tulipifera 'Arnold'

8 Quercus phellos 'Greenenvy'

10 Lagerstroemia indica x fauriei 'Natchez'

44 Abelia x grandiflora 'Rose Creek'

6 Prunus laurocerasus 'Otto Luyken'

116 Juniperus horizontalis 'Blue Rug'

30 Perovskia atriplicifolia 'Little Spire'

66 Panicum virgatum 'Shenandoah'

20 Muhlenbergia capillaris 'White Cloud'

41 Pennisetum alopecuroides 'Cassian's Choice'

940 Liriope muscari 'Variegata'

14 Rhaphiolepis x deacourii 'Georgia Petite'

4 Liriodendron tulipifera

TOE 4 Thuja occidentalis 'Emerald'

54 | Distylium 'PP 27631'

60 | llex glabra 'Shamrock'

14 Aster laevis 'Bluebird'

257 Hypericum calycinum

12,555 Festuca arundinacea

7 Landscape Boulders

315 River Rock

* Contractor to provide quantity for mulch

30 | Itea virginica 'Spirch'

GROUNDCOVERS & PERENNIALS

ORNAMENTAL GRASSES

Common Name

Arnold Tulip Poplar

Kingpin Willow Oak

Emerald Green Arborvitae

Natchez Crape Myrtle

Rose Creek Abelia

Otto Luyken Laurel

Blue Rug Juniper

Variegated Liriope

Cinnamon Girl Distylium

Shamrock Inkberry Holly

Bluebird Smooth Aster

Creeping St. John's Wort

Little Spire Russian Sage

White Cloud Muhly Grass

Shenandoah Switchgrass

Turf-type Tall Fescue

Cassian's Choice Pennisetum

Little Henry Virginia Sweetspire

Georgia Petite Indian Hawthorn

Tulip Poplar

Size

2" cal.

2" cal.

2" cal.

8' hgt. min.

8' hgt. min.

3 gal.

24" hgt min B&B or can.

36" hgt. min B&B or can.

3 gal.

3 gal.

1gal.

3 gal.

1 gal.

3 gal.

3 gal.

sf

2-3"

36" hgt. min. B&B or can. 4' o.c., full & dense

24" hgt. min. B&B or can. 3' o.c., full & dense, white flowers

Notes

6' CT -Central leader, full, well branched

6' CT -Central leader, full, well branched

MT, 3 cane min., full & well branched, white flowers

6' CT -Central leader, full, well branched

3' o.c., full & dense, white flowers

3' o.c., full & dense, white flowers

2' o.c., full & dense, purple flowers

4' o.c., full & dense, white plumes

No smaller than 2'x3'x1.5' T No larger than 3'x4'x2' T

FTG, full, well branched

3' o.c., full & dense

3' o.c., full & dense

30" o.c., blue flowers

3' o.c., full & dense


2' o.c., full & dense

3' o.c., full & dense

3-4" Depth

12" o.c., full & dense

18" o.c., yellow flowers

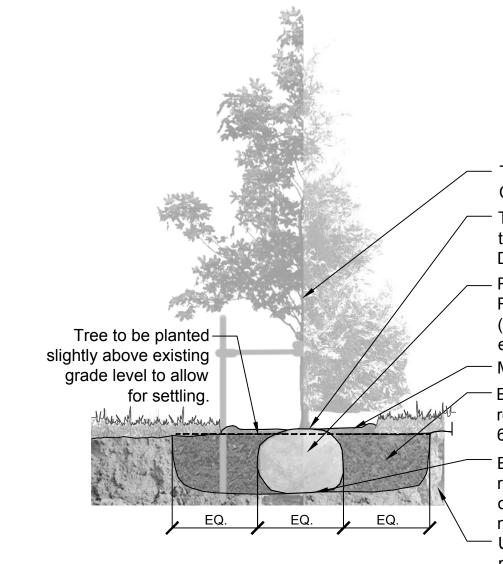

Tree shall be plumb after settlement. Contractor shall stake at planting. Trunk flare of each tree shall be exposed. Set tree so that no part of the trunk flare is buried. Do not cover the trunk flare with mulch. Remove & discard burlap except under ball. Remove all synthetic soil wrapping materials (treated burlap, nylon twine, wire baskets, etc.) and discard.

 Mulch (pull mulch away from trunk of tree) Excavate hole to diameter 3x wider than rootball. Backfill hole with planting soil mix, ph 6 unless otherwise noted.

Excavate topsoil substrate as required to place rootball to proper elevation. Place rootball directly on undisturbed subgrade or compacted planting

Undisturbed or compacted subgrade must percolate. See percolation test notes, this sheet.

Tree Planting Detail Scale: NTS

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Date	: 03.26.19					
Job Number: 19-013						
Drawn By: LGG Ck'd By:			SHP			
Rev	Descript	ion	Date			

Sheet Name:

Planting Schedule, Notes & Details

Sheet Number:

L200





WEST ELEVATION




SE CORNER VIEW



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SOUTH ELEVATION

- (1) ILLUMINATED SIGN
- 2) 4" NORMAN BRICK VENEER W/ METAL STUD BACK-UP, 1/3 RUNNING BOND. INTERSTATE BRICK, MOUNTAIN RED.
- (3) CONCRETE MASONRY UNITS VENEER, 8x4x16 CENTER SCORED, RUNNING BOND. COUNTY MATERIALS CORP., PREMIER ULTRA BURNISHED MASONRY UNITS, COLOR: MOONBEAM 63-214B.
- 4 CAST STONE CAP
- (5) 4" NORMAN BRICK VENEER W/ METAL STUD BACK-UP, 1/3 RUNNING BOND. INTERSTATE BRICK, 60% TUMBLEWEED, 40% CEDAR.
- (6) 4" NORMAN THIN BRICK VENEER W/ METAL STUD BACK-UP, 1/3 RUNNING BOND. INTERSTATE BRICK, MOUNTAIN RED.
- (7) ILLUMINATED 'BLADE' SIGN
- (8) STOREFRONT 4 1/2" DEEP THERMALLY BROKEN FRAME W/ A 2" SIGHTLINE. COLOR: KAWNEER CLASSIC BRONZE UC109580.
- (9) CAST STONE SILL, TYP.

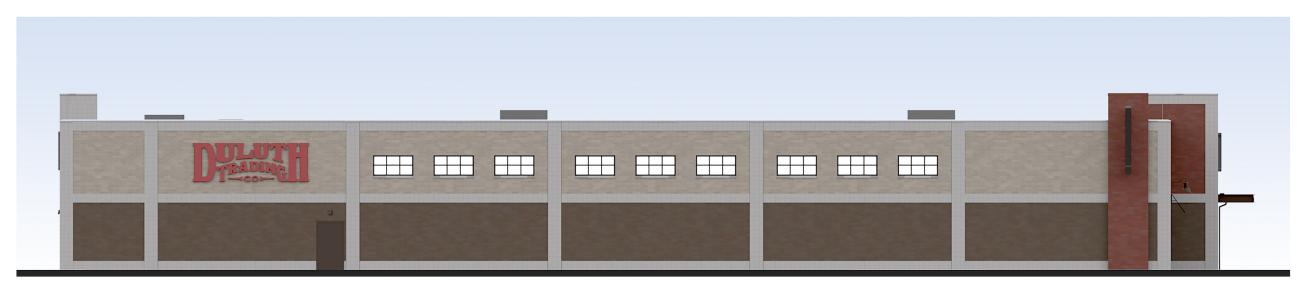

- 10 FABRIC AWNING
- (1) STEEL CANOPY, COLOR TO MATCH STOREFRONT FRAME.
- (2) 4" NORMAN BRICK VENEER W/ METAL STUD BACK-UP, 1/3 RUNNING BOND. INTERSTATE BRICK, MOCHA.

4-F-19-UR

	DTC - CHERRY HILL, NJ		SCALE	1/16" = 1'-0"	117
PROJECT	DULUTH TRADING COMPANY		AREA		
ADDRESS		REV	DATE	02.14.2019	
	CHERRY HILL, NJ	PROJ NO 1448.046.000	SHEET	SK-1.1	



INTERSTATE BRICK CEDAR



INTERSTATE BRICK TUMBLEWEED



INTERSTATE BRICK MOCHA




INTERSTATE BRICK RED MOUNTAIN




ICOUNTY MATERIALS CORP. MOONBEAM



INTERSTATE BRICK 60% TUMBLEWEED 40% CEDAR

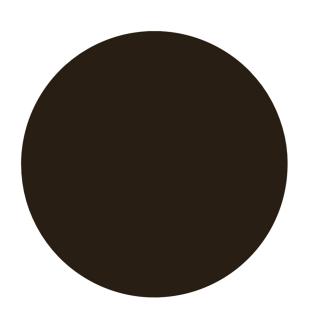

KAWNEER: CLASSIC BRONZE

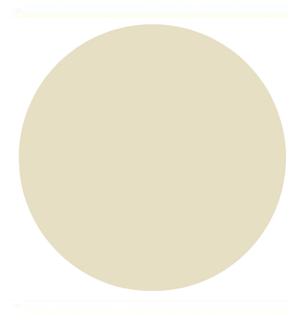

CAST STONE

inter:work

interwork architects incorporated 1200 shermer rd. northbrook, il 60062 t: 847.509.4070 f: 847.509.9604 www.interworkarchitects.com

DTC - CHERRY HILL, NJ

PROJECT DULUTH TRADING COMPANY

ADDRESS CHERRY HILL, NJ

PROJ NO <u>1448.046.000</u> **SHEET** SK-1.2

SCALE 1/16" = 1'-0' AREA

DATE 02.14.2019