

EXISTING WALL TO REMAIN

OPENING TO BE CUT IN

W/ FRAMING PLAN

EXISTING WINDOW

EXISTING DOOR

NEW DOOR

TANKLESS WATER HEATER

INDICATES WALL TYPE "x"

DOOR DESIGNATION

ELECTRICAL PANEL

REFRIGERATOR

WASHER/DRYER

DISHWASHER

NEW WALL

EXISTING WALL, COORDINATE

__ _ _ _ WALL TO REMOVE



GENERAL DEMOLITION

- 1. UTILITIES: MAINTAIN SERVICES INDICATED TO REMAIN:
- PROTECT FROM DAMAGE DURING DEMOLITION. 2. PROTECTION: PROVIDE BARRICADES AND DEMARK AREAS OF DANGER IN ORDER TO PROVIDE SAFE PASSAGE OF
- PEOPLE AROUND AREA OF WORK. 3. DISPOSAL: REMOVE AND TRANSPORT DEBRIS OFF SITE AND DISPOSE OF IN ACCORDANCE WITH STATE AND FEDERAL REGULATIONS. TRANSPORT IN A MANNER THAT WILL PREVENT SPILLAGE ON ADJACENT SURFACES AND AREAS.
- PROTECT AREAS TO REMAIN FROM DAMAGE. 4. DO NOT REMOVE STRUCTURAL ELEMENTS WITHOUT APPROVAL OF ARCHITECT. PROVIDE TEMPORARY SUPPORT TO EXISTING CONSTRUCTION. SUCH SUPPORT SHALL BE DESIGNED BY A LICENSED STRUCTURAL ENGINEER.
- 5. PROVIDE PROTECTION FROM WEATHER AT OPENINGS IN THE EXTERIOR ENVELOPE. PROTECTION SHALL MAINTAIN A BARRIER TO AIR, MOISTURE, AND DIRT.
- 6. CUT HOLES AND SLOTS AS SMALL AS POSSIBLE, NEATLY TO SIZE, AND WITH MINIMUM OF DISTURBANCE. 7. CLEAN ADJACENT STRUCTURES OF DUST, DIRT, AND DEBRIS

CAUSED BY DEMOLITION AT END OF WORK DAY OR MORE

FREQUENTLY AS NECESSARY TO PREVENT SPREAD OF

- 8. REMOVE DIRT, DUST, AND LOOSE DEBRIS FROM BUILDING. BUILDING SHALL BE SWEPT CLEAN IMMEDIATELY PRIOR TO COMPLETION OF WORK.
- 9. REMOVE EMPTY CONDUIT, LOOSE WIRE, PIPING OR MISCELLANEOUS WOOD OR STEEL COMPONENTS THAT ARE NO LONGER IN USE OR SERVE NO PURPOSE FROM CEILING,
- WALLS, AND FLOORS. 10. UPON COMPLETION OF DEMOLITION, VISUALLY INSPECT FOR RESIDUAL MOLD. IF MOLD IS ENCOUNTERED, NOTIFY OWNER AND HAVE MOLD MITIGATED.

1. REMOVE DOORS, FRAMES, AND HARDWARE LOCATED IN

- WALLS INDICATED TO BE DEMOLISHED (TYP.) 2. DASHED WALL INDICATE PARTITION TO BE REMOVED,
- INCLUDING STUDS, PLASTER, TRIM AND MOLDINGS, ETC. 3. SAW CUT TO PROVIDE CLEAN BREAK POINT AT MASONRY WALLS. ALIGN CUT WITH VERTICAL JOINTS WHERE POSSIBLE. COORDINATE WITH INSTALLATION OF MASONRY LINTEL TO MAINTAIN STRUCTURAL INTEGRITY.

1. FLOOR SHALL BE LEFT AS CLEAN, BARE CONCRETE. (TYP. THROUGHOUT)


2. CONCRETE SLAB SHALL BE SCRUBBED CLEANED: DIRT, DUST, OILS, AND ADHESIVES REMOVED.



- 1. FIELD VERIFY DIMENSIONS. REPORT DISCREPANCIES TO
- 2. INTERIOR AND EXTERIOR WALL AND PARTITION DIMENSIONS ARE FROM FACE OF STUD TO FACE OF STUD, UNLESS NOTED OTHERWISE. MASONRY DIMENSIONS ARE FROM OUTSIDE EDGE TO OUTSIDE EDGE, UNLESS NOTED OTHERWISE.
- 3. INTERIOR PARTITIONS, UNLESS NOTED OTHERWISE, ARE TO
- BE 2x4 WOOD STUDS WITH 1/2" GYP. BOARD ON EACH SIDE. 4. PROVIDE SOLID WOOD BLOCKING OR PLYWOOD FOR

INSTALLATION OF TOILET ACCESSORIES, SHELVING,

CASEWORK, AND OTHER SPECIALTY OR WALL MOUNTED

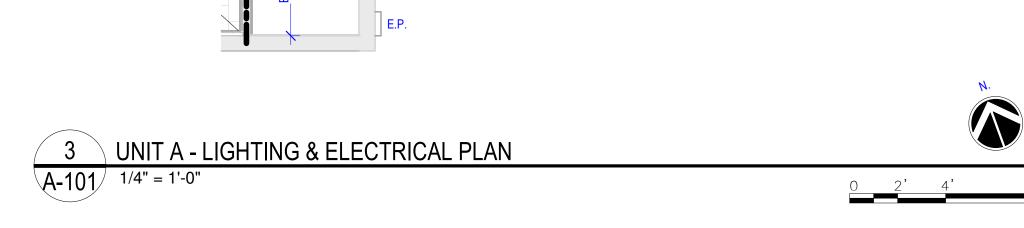


BEDROOM 2

SHADED AREA TO RECEIVE 1/2" GYP.

INSULATION ABOVE CEILING IN ROOF

BOARD AT CEILING (MOISTURE RESISTANT IN BATHROOM) & R-49 BATT

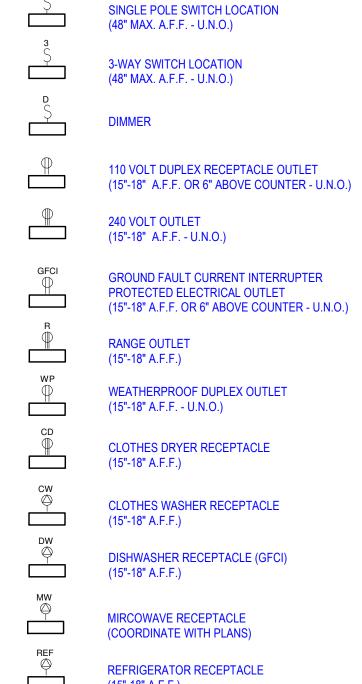

CONSULT WITH OWNER FOR FINAL LOCATION.

CONSULT WITH OWNER FOR FINAL LOCATION.


TV DATA CONNCECTION RECEPTACLE.

(15"-18" A.F.F.)

(60" A.F.F.)

ELECTRICAL SYMBOL LEGEND



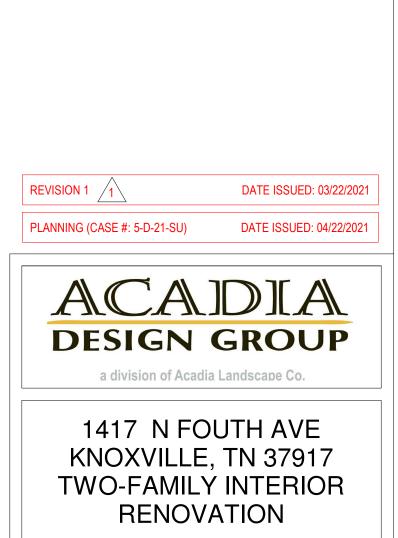

UNIT A - DEMOLITION,

FRAMING, LIGHTING AND

ELECTRICAL PLANS

A-101

DATE ISSUED: 01/08/2021

RELEASE FOR CONSTRUCTION

DRAWN BY: JM

ISSUED BY: PB


GENERAL NOTES:

1. CENTER LIGHT FIXTURE IN ROOM UNLESS NOTED

WASHER / DRYER STACK. EXHAUST TO EXTERIOR.

BEDROOM 1

5-D-21-SU

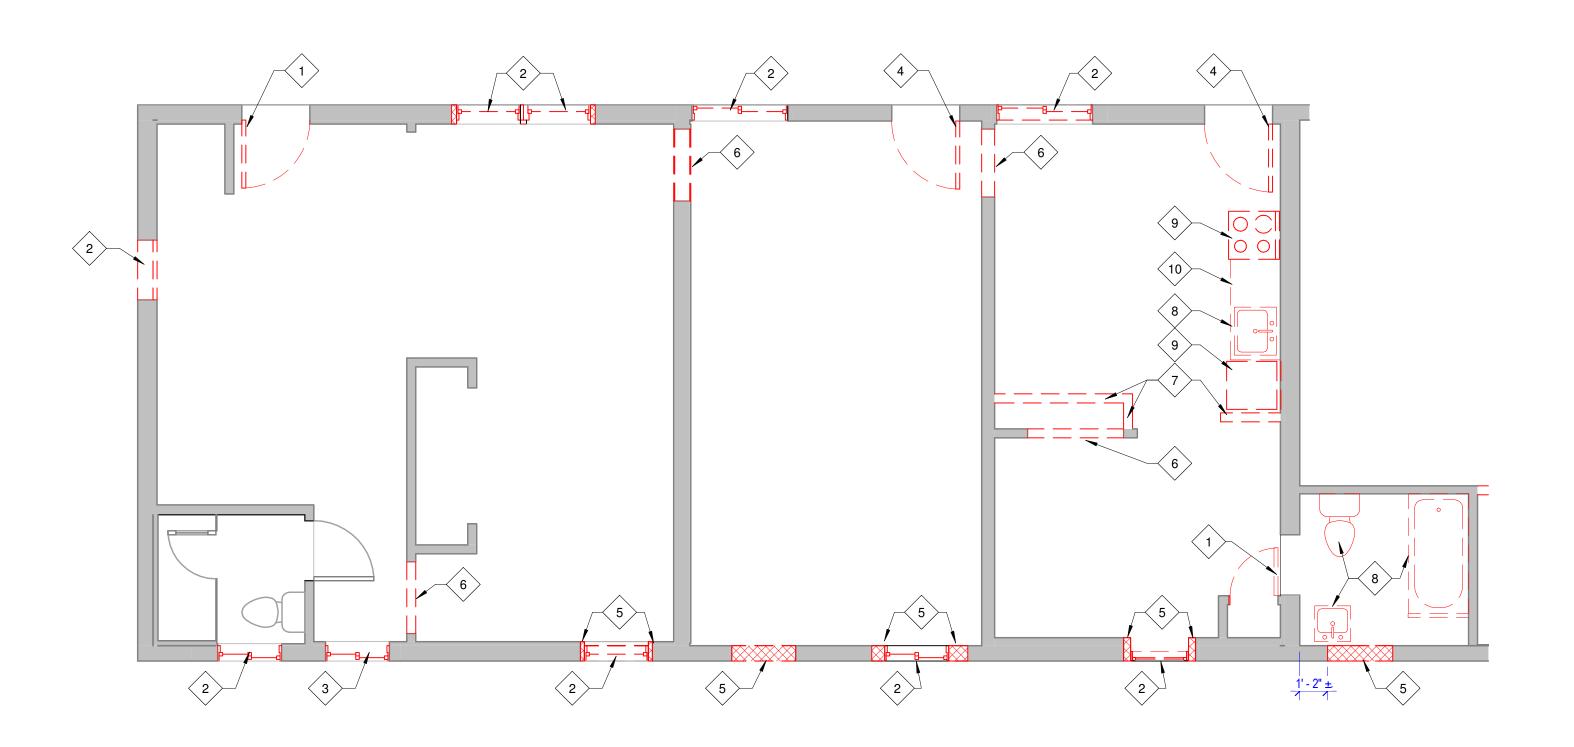





DEMOLITION KEYNOTES: (#)

- REMOVE EXISTING DOOR. EXISTING DOOR FRAME TO REMAIN IN PLACE.
- 2. REMOVE EXISTING WINDOW.
- 3. EXISTING WINDOW OPENING. SEE FRAMING PLAN AND WINDOW SCHEDULE FOR WINDOW SIZE.
- 4. REMOVE EXISTING DOOR & FRAME.
- 5. PREP WALL FOR NEW WINDOW. COORDINATE WITH FRAMING PLAN AND WINDOW SCHEDULE FOR EXTENTS.
- 6. PREP WALL FOR DOOR. COORDINATE WITH FRAMING PLAN AND DOOR SCHEDULE FOR EXTENTS.
- 7. REMOVE WALL. COORDINATE WITH FRAMING PLAN.
- 8. REMOVE PLUMBING FIXTURES.
- 9. REMOVE APPLIANCES.
- 10. REMOVE COUNTERTOP.

GENERAL DEMOLITION NOTES

- 1. UTILITIES: MAINTAIN SERVICES INDICATED TO REMAIN;
- 2. PROTECTION: PROVIDE BARRICADES AND DEMARK AREAS OF DANGER IN ORDER TO PROVIDE SAFE PASSAGE OF
- REGULATIONS. TRANSPORT IN A MANNER THAT WILL
- PROTECT AREAS TO REMAIN FROM DAMAGE. 4. DO NOT REMOVE STRUCTURAL ELEMENTS WITHOUT APPROVAL OF ARCHITECT. PROVIDE TEMPORARY SUPPORT TO EXISTING CONSTRUCTION. SUCH SUPPORT SHALL BE
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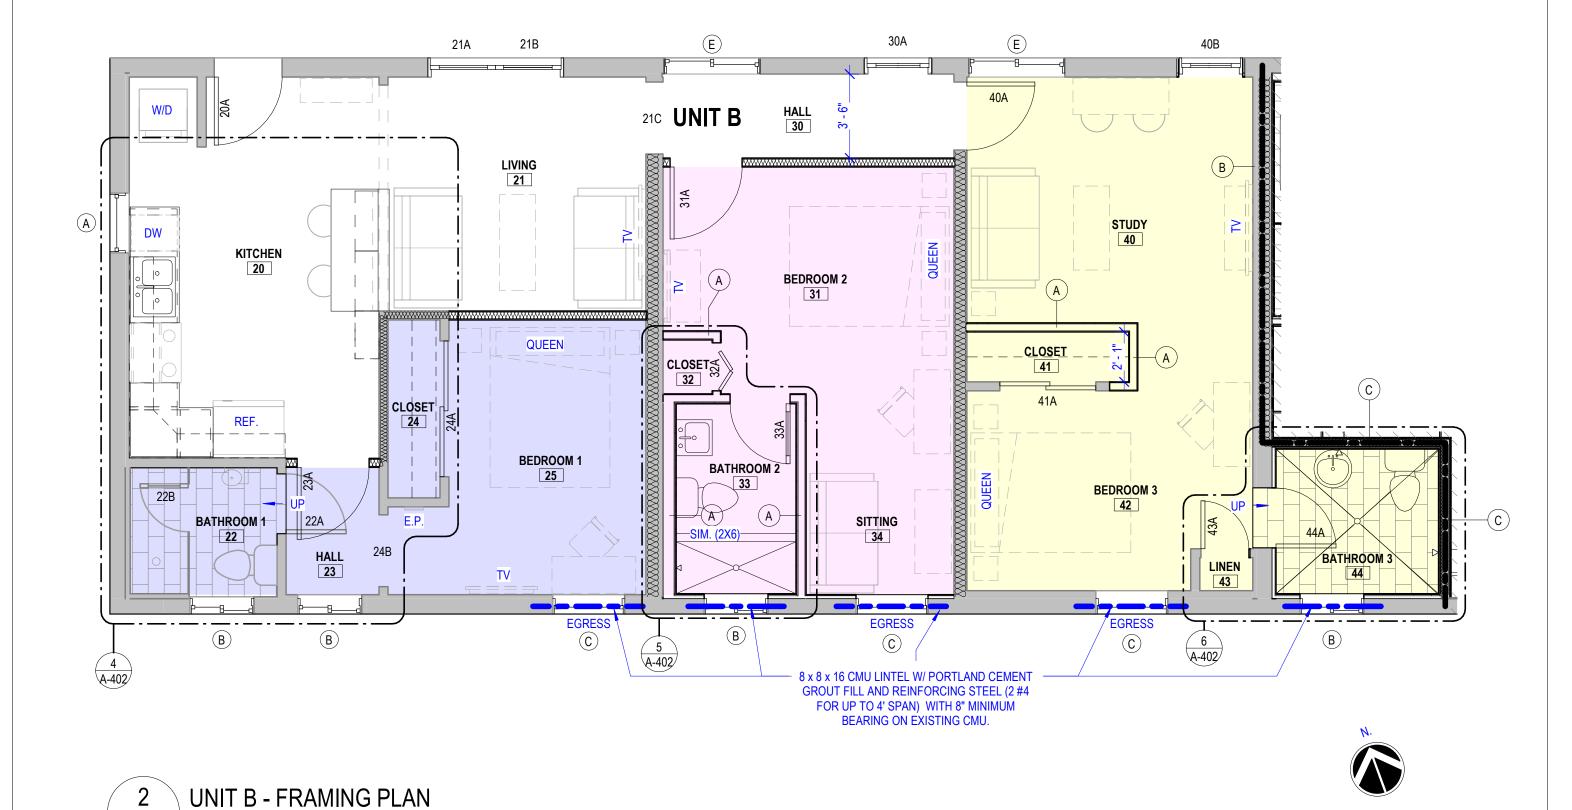
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GENERAL DEMOLITION

- PROTECT FROM DAMAGE DURING DEMOLITION.
- PEOPLE AROUND AREA OF WORK.
- 3. DISPOSAL: REMOVE AND TRANSPORT DEBRIS OFF SITE AND PREVENT SPILLAGE ON ADJACENT SURFACES AND AREAS.
- EXTERIOR ENVELOPE. PROTECTION SHALL MAINTAIN A
- BARRIER TO AIR, MOISTURE, AND DIRT. 6. CUT HOLES AND SLOTS AS SMALL AS POSSIBLE, NEATLY TO
- 7. CLEAN ADJACENT STRUCTURES OF DUST, DIRT, AND DEBRIS
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SYMBOL LEGEND


A-102 1/4" = 1'-0"









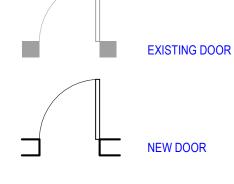

TANKLESS WATER HEATER

DOOR DESIGNATION DISHWASHER

ELECTRICAL PANEL

INDICATES WALL TYPE "x"

REFRIGERATOR WASHER/DRYER

GENERAL FLOOR PLAN NOTES:

- FIELD VERIFY DIMENSIONS. REPORT DISCREPANCIES TO DESIGNER.
- 2. INTERIOR AND EXTERIOR WALL AND PARTITION DIMENSIONS ARE FROM FACE OF STUD TO FACE OF STUD, UNLESS NOTED OTHERWISE. MASONRY DIMENSIONS ARE FROM OUTSIDE EDGE TO OUTSIDE EDGE, UNLESS NOTED
- 3. INTERIOR PARTITIONS, UNLESS NOTED OTHERWISE, ARE TO BE 2x4 WOOD STUDS WITH 1/2" GYP. BOARD ON EACH SIDE.
- 4. PROVIDE SOLID WOOD BLOCKING OR PLYWOOD FOR INSTALLATION OF TOILET ACCESSORIES, SHELVING, CASEWORK, AND OTHER SPECIALTY OR WALL MOUNTED

REVISION 1 /1

PLANNING (CASE #: 5-D-21-SU)

DATE ISSUED: 03/22/2021

DATE ISSUED: 04/22/2021

ACADIA **DESIGN GROUP**

a division of Acadia Landscape Co.

1417 N FOUTH AVE KNOXVILLE, TN 37917 TWO-FAMILY INTERIOR RENOVATION

UNIT B - DEMOLITION AND FRAMING PLANS


DRAWN BY: JM

ISSUED BY: PB

RELEASE FOR CONSTRUCTION DATE ISSUED: 01/08/2021

A-102

5-D-21-SU

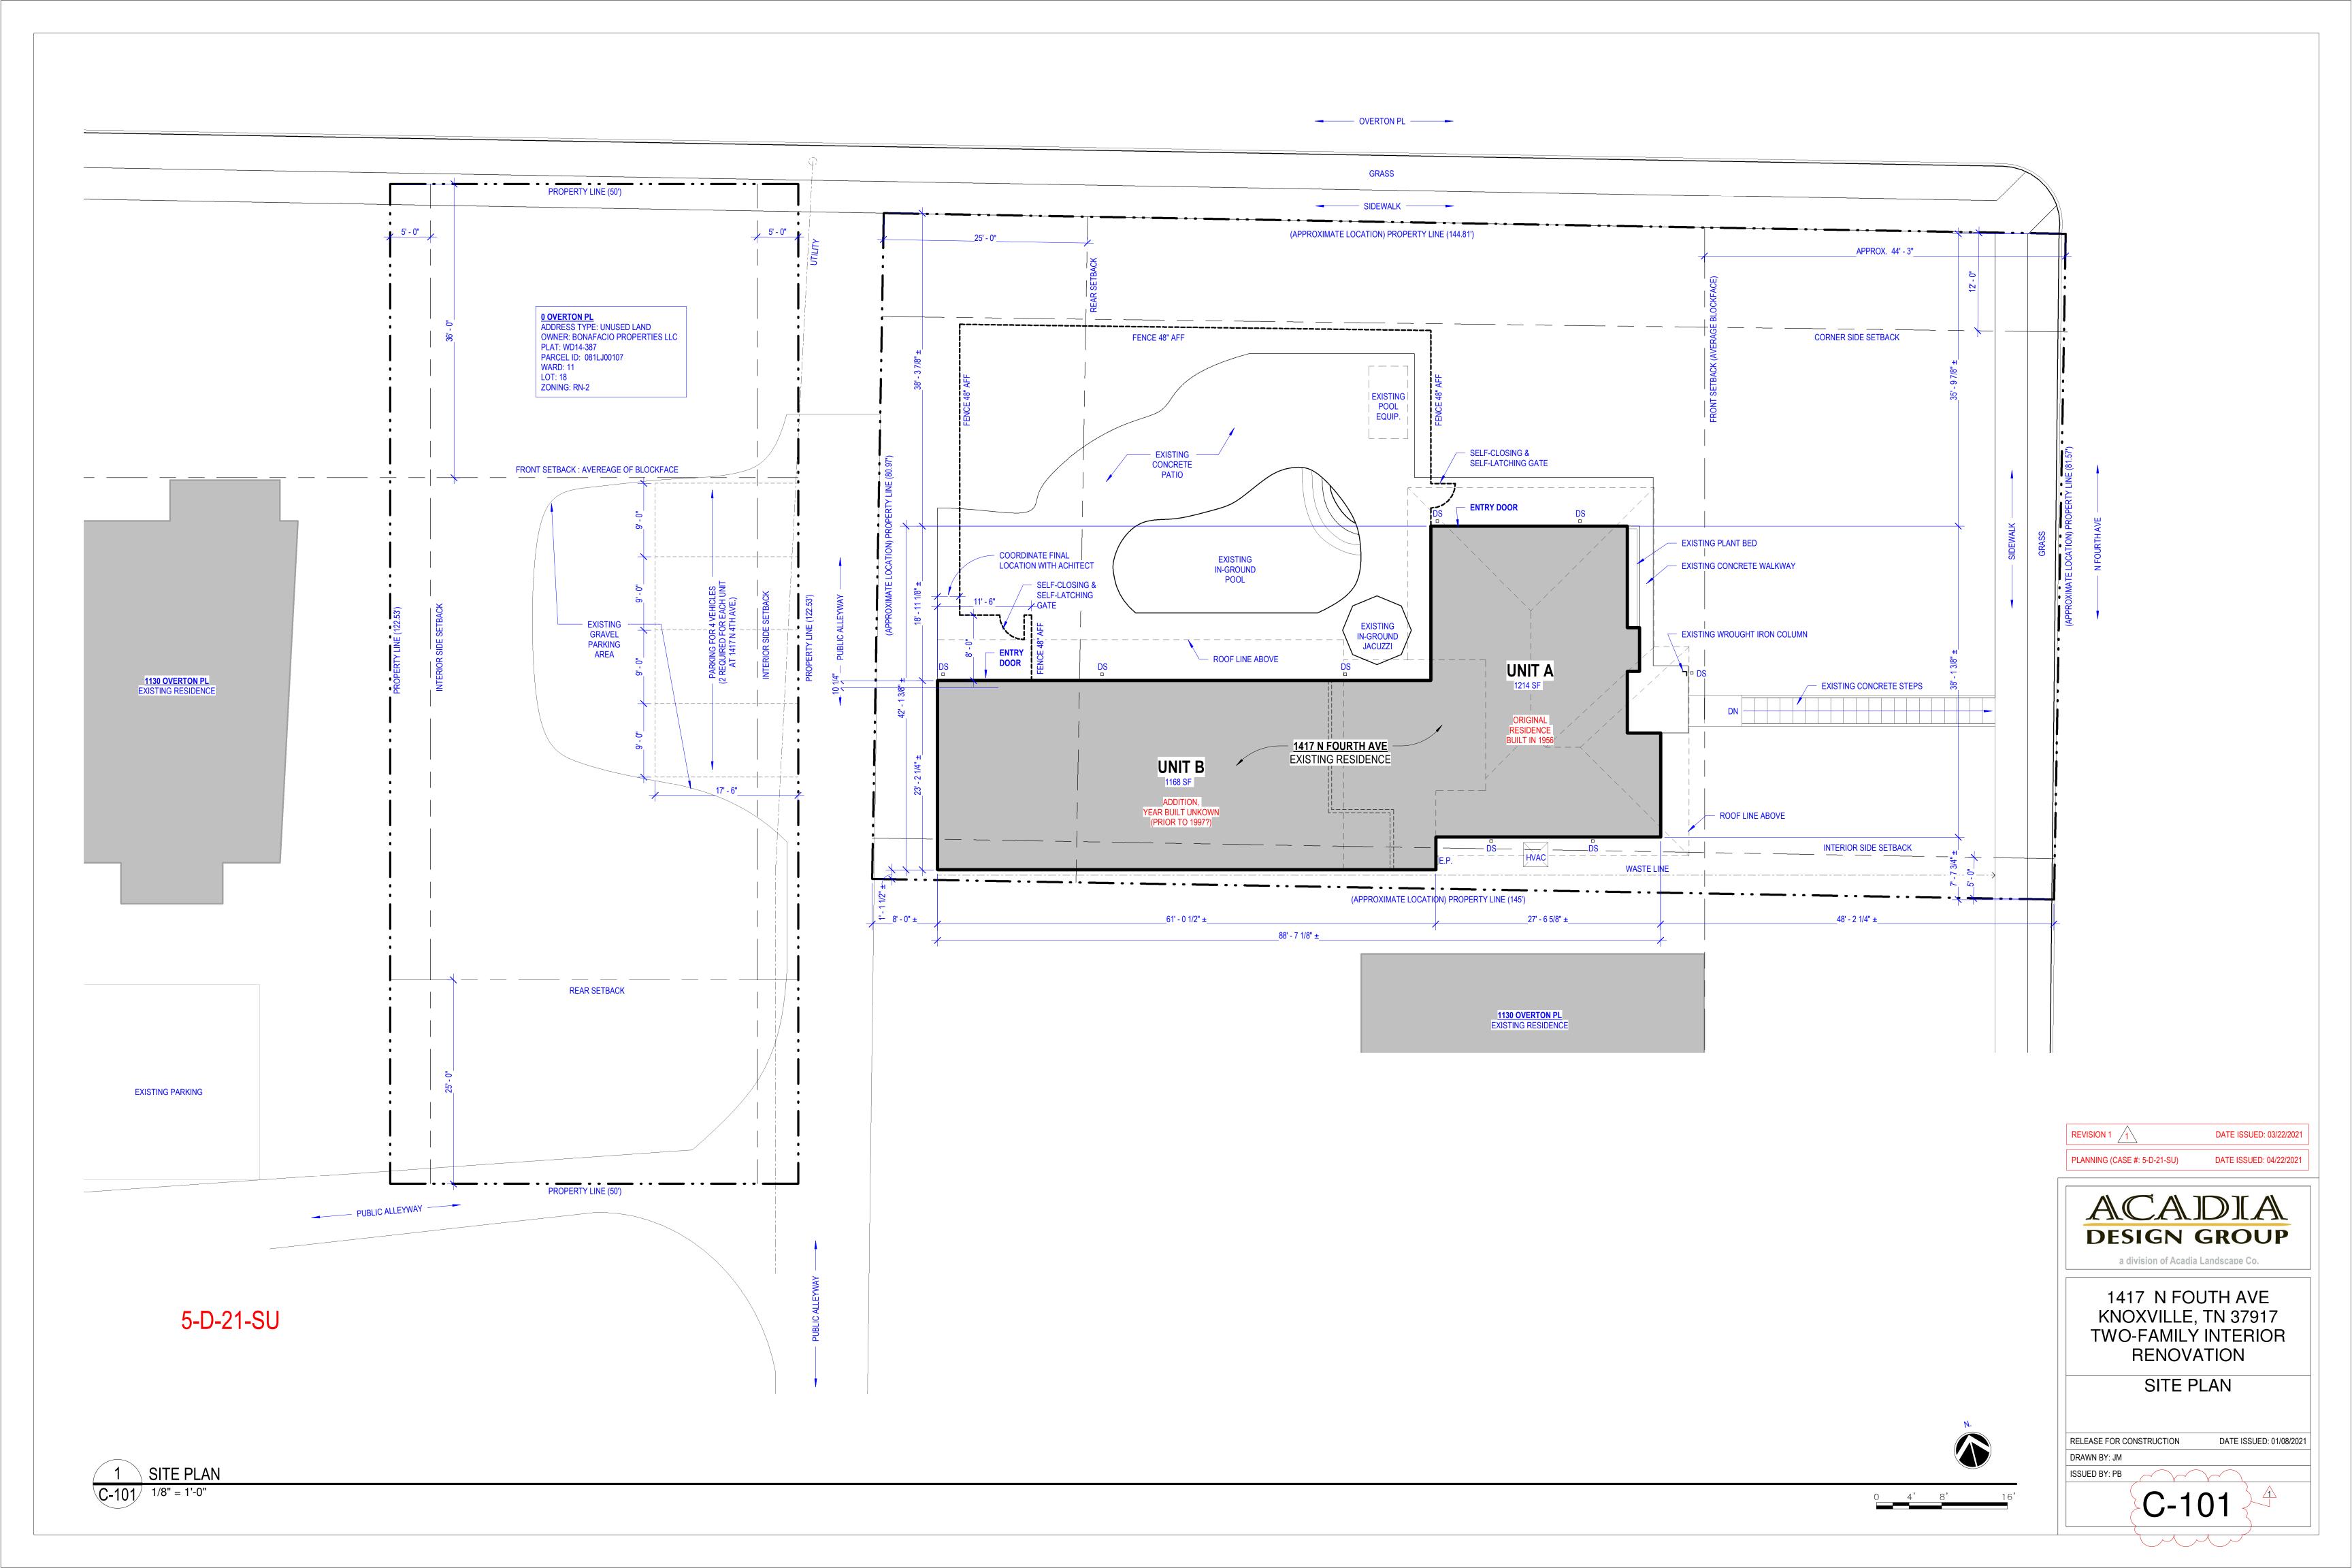

ACADIA DESIGN GROUP




INTERIOR RENOVATION


TWO-FAMILY RESIDENCE

1417 N 4TH AVE KNOXVILLE, TN 37917


OWNER: BONIFACIO PROPERTIES, LLC 203 GORE RD. KNOXVILLE, TN 37919

PHOTOGRAPH OF EXISTING BUILDING

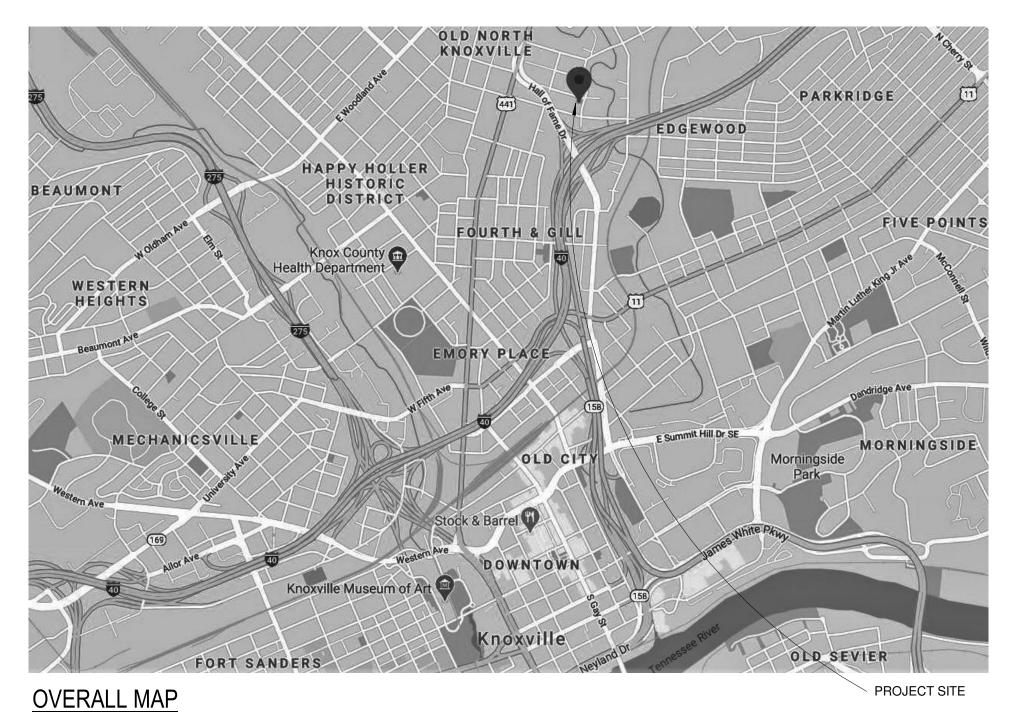


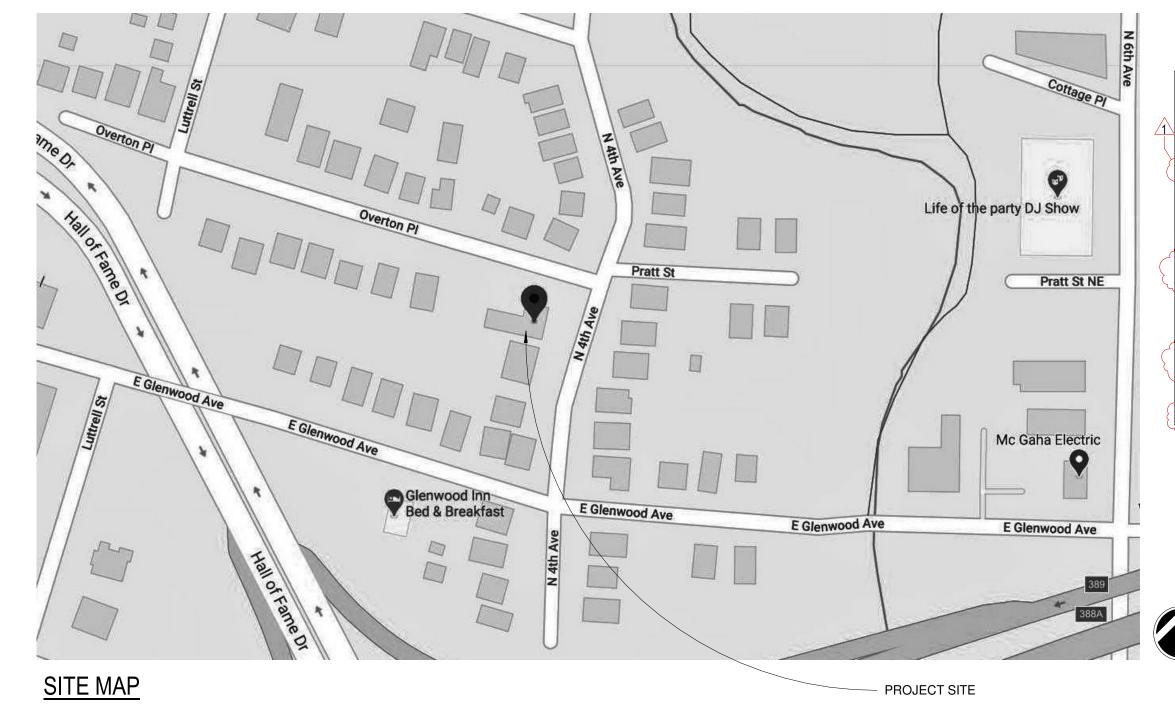



DRAWING INDEX:

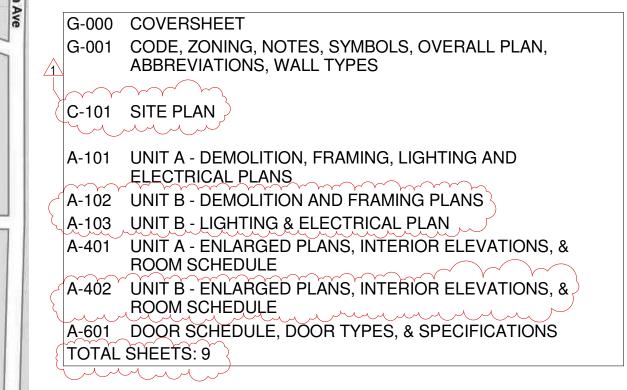

5-D-21-SU

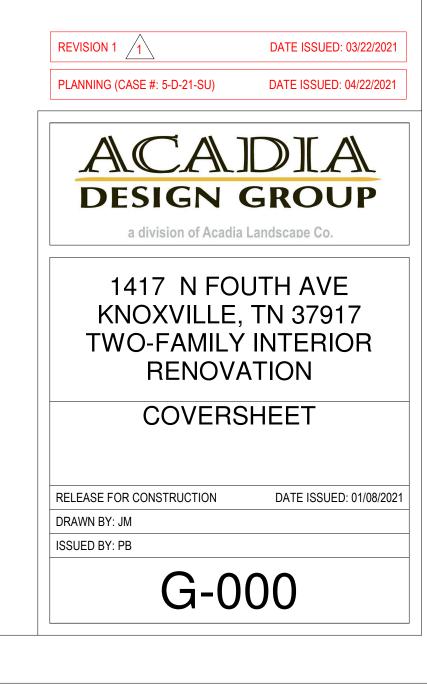

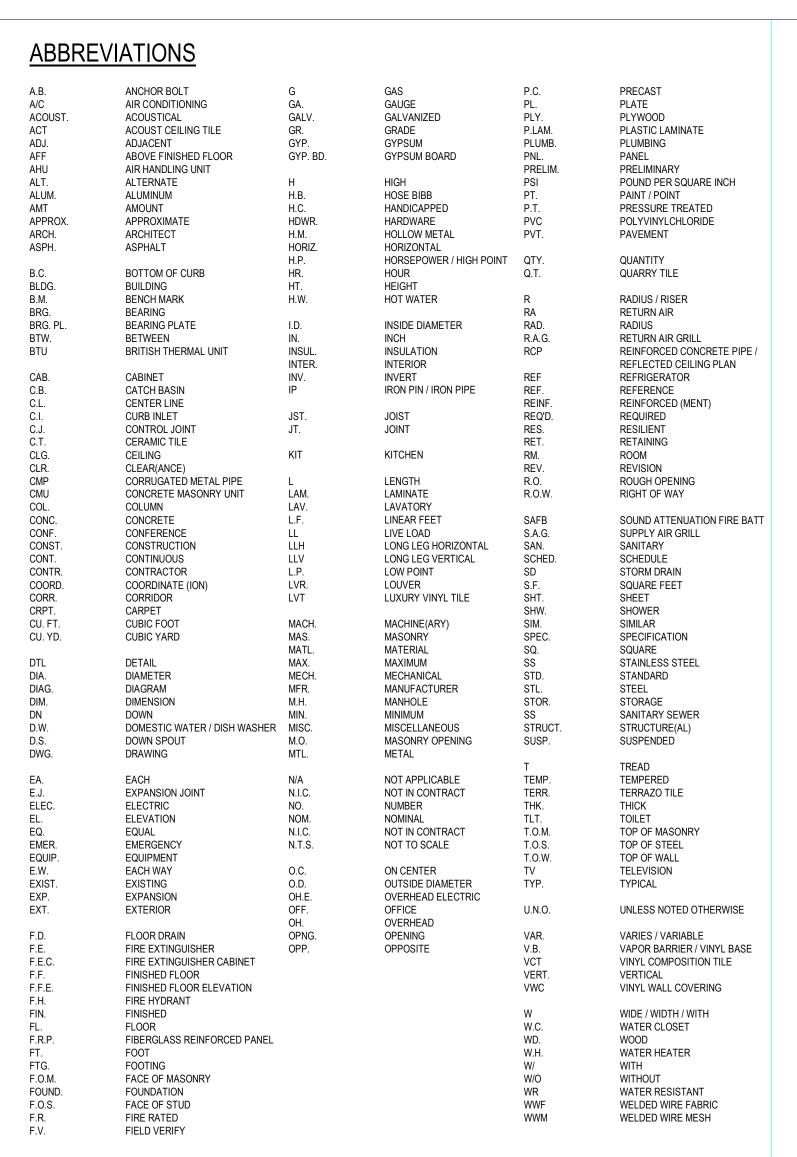

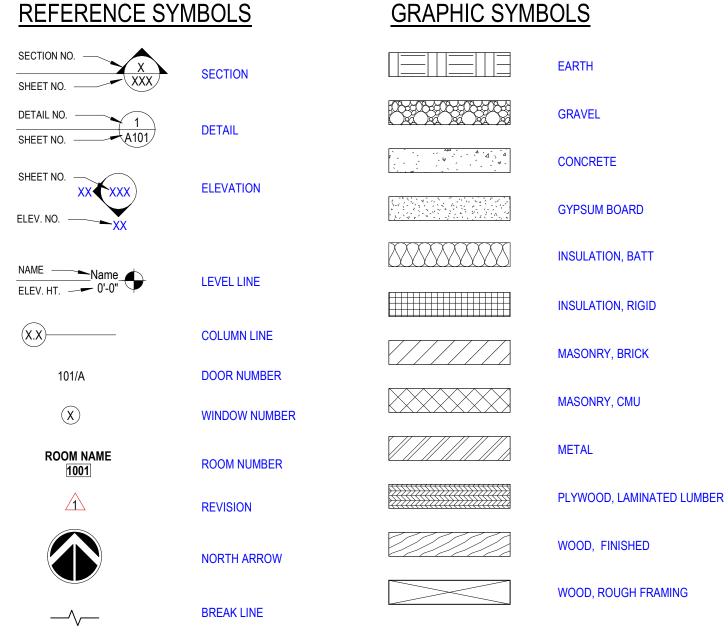

_ _ _ _ _ _

HIDDEN LINE

WALL TYPE

SEE KEYNOTE '1'

ZONING INFORMATION PROJECT: INTERIOR RENOVATION 1417 N 4TH AVE UNIT A KNOXVILLE, TN 37917 $\sim \sim \sim \sim \sim$ PROJECT DESCRIPTION: INTERIOR RENOVATION TO CONVERT EXISTING RESIDENCE TO TWO-FAMILY RESIDENCE. PARCEL ID: 081LJ002 PARCEL: WARD: CITY BLOCK: 11461 RN-2 NONE **SPECIAL DISTRICTS FLOOD PLAIN:** NONE LOCAL HISTORIC DISTRICT: NONE NATIONAL HISTORIC DISTRICT: NONE

CODE INFORMATION

JURISDICTION: CITY OF KNOXVILLE, TN 2018 INTERNATIONAL RESIDENTIAL CODE 2018 INTERNATIONAL EXISTING BUILDING CODE METHOD: CLASSIFICATION OF WORK, ALTERATION - LEVEL 2 2018 INTERNATIONAL ENERGY CONSERVATION CODE 2017 EDITION OF THE NATIONAL ELECTRICAL CODE 2018 EDITION OF THE INTERNATIONAL FUEL GAS CODE 2018 EDITION OF THE INTERNATIONAL MECHANICAL CODE 2018 EDITION OF THE INTERNATIONAL PLUMBING CODE

2018 EDITION OF THE INTERNATIONAL PROPERTY MAINTENANCE CODE 2018 INTERNATIONAL SWIMMING POOL & SPA CODE OCCUPANCY (CHAPTER 3): RESIDENTIAL GROUP R-2

CONSTRUCTION TYPE (CHAPTER 6): TYPE VB, UNPROTECTED, UNSPRINKLERED

BUILDING AREA, CONDITIONED: EXISTING 2,382 SF NUMBER OF STORIES: 1 STORY BUILDING HEIGHT: 12' ±

INTERNATIONAL ENERGY CONSERVATION CODE - RESIDENTIAL

CLIMATE ZONE (C402.3): 4 A (EXCEPT MARINE) MINIMUM INSULATION AND FENESTRATION REQUIREMENTS (TABLE R402.1.1)

ROOFS R-20 OR 13 + 5CI WALLS, WOOD FRAME: R-8 (EXT) OR 13 (INT) WALLS, CMU BASEMENT OR CRAWL SPACE R-10 CI OR R-13 SLAB-ON-GRADE, UNHEATED: R-10 FOR 2 FT FENESTRATION: **WINDOWS** OPAQUE AND GLAZED DOORS SOLAR HEAT GAIN (SHGC)

CLIMATIC AND GEOGRAPHIC DESIGN CRITERIA: (NOTE: TO BE PROVIDED BY CODE JURISDICTION, NUMBERS BELOW ARE FROM KNOXVILLE)

10 PSF

90 MPH


GROUND SNOW LOAD WIND DESIGN SPEED TOPOGRAPHIC EFFECTS SPECIAL WIND REGION WINDBORNE DEBRIS ZONE SEISMIC DESIGN CATEGORY SUBJECT TO DAMAGE FROM WEATHERING FROST LINE DEPTH TERMITE WINTER DESIGN TEMP ICE BARRIER UNDERLAYMENT REQUIRED? FLOOD HAZARDS AIR FREEZING INDEX MEAN ANNUAL TEMPERATURE

SEVERE 12 INCHES MODERATE TO HEAVY 19 DEG F TBD BY COK DEPARTMENT OF ENGINEERING


59.4 MANUAL J DESIGN CRITERIA AS DETERMINED FROM TABLE 1A OR 1B BY PLUMBING/GAS/MECH CHIEF

GENERAL PROJECT NOTES

- DO NOT SCALE DRAWINGS. IF A DIMENSION IS IN QUESTION CONTRACTOR SHALL OBTAIN CLARIFICATION, IN WRITING, FROM THE ARCHITECT.
- 2. CONTRACTOR SHALL COMPLY WITH LOCAL, STATE AND FEDERAL CODES, REGULATIONS AND ORDINANCES. CONTRACTOR SHALL BE RESPONSIBLE FOR OBTAINING PERMITS REQUIRED FOR CONSTRUCTION.
- 3. CONTRACTOR SHALL TAKE NECESSARY PRECAUTIONS TO PROTECT SURROUNDING PROPERTY, STREETS, WALKS, ETC FROM CONSTRUCTION ACTIVITIES AND SHALL BE RESPONSIBLE FOR REPAIRING DAMAGE CAUSED AS A RESULT.
- 4. CONTRACTOR IS SOLELY RESPONSIBLE FOR MEANS AND METHODS OF CONSTRUCTION.
- 5. CONTRACTOR IS SOLELY RESPONSIBLE FOR SAFETY ON THE JOB SITE AND FOR COMPLIANCE WITH OSHA REGULATIONS.
- 6. CONTRACTORS TO VERIFY EXISTING CONDITIONS PRIOR TO BIDDING WORK. IF CONDITIONS VARY FROM THOSE SHOWN ON DRAWINGS, CONTACT ARCHITECT BEFORE PROCEEDING. CHANGE ORDERS WILL NOT BE ISSUED FOR ITEMS ARISING OUT OF FAILURE TO FULLY INSPECT EXISTING CONDITIONS.
- 7. WHERE WORK IS INDICATED TO FIT TO OTHER CONSTRUCITON, FIELD VERIFY DIMENSIONS OF CONSTRUCTION BEFORE FABRICATION. NOTE FIELD MEASUREMENTS OF SHOP DRAWINGS.
- 8. CHANGE ORDERS WILL NOT BE ISSUED FOR CHANGES UNLESS APPROVED BY OWNER PRIOR TO BEGINNING WORK.
- 9. DETAILS OR NOTES DESCRIBED FOR A CONDITION SHALL APPLY TO SIMILAR CONDITIONS, UNLESS NOTED OTHERWISE.

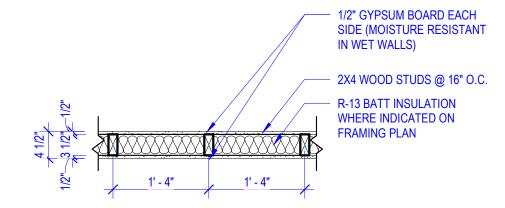

WALL TYPE "A" - NON-RATED WOOD 2x4 INTERIOR PARTITION

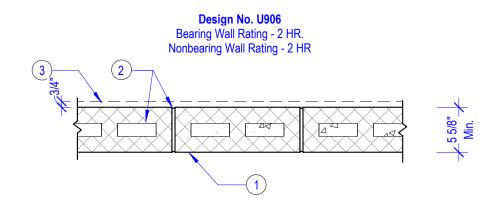


- 1. **Concrete Blocks*** Nominal 6 by 8 by 16 inch, hollow or solid. Classification D-2 (2 hr.)
- **Anchor Concrete Products, Inc.** Florida Rock Industries, Inc. Pike Industries Inc., d/b/a Tilcon Whitcomb


Westbrook Concrete Block Co., Inc.

- 2. Mortar Blocks laid in full bed of mortar, nom. 3/8in. thick, of not less than 2-1/4 and not more than 3-1/2 parts of clean sharp sand to 1 part Portland cement (proportioned by volume) and not more than 50 percent hydrated
- lime (by cement volume). Vertical joints staggered. 3. Portland Cement Stucco or Gypsum Plaster - Add 1/2 hr to Classification if used. Attached to concrete
- 4. Foamed Plastic* (Optional Not Shown) 1-1/2 in. thick max, 4 ft wide sheathing attached to concrete blocks Celotex Corp - Type Thermax
- * Bearing the UL Classification Marking

blocks (Item 1).



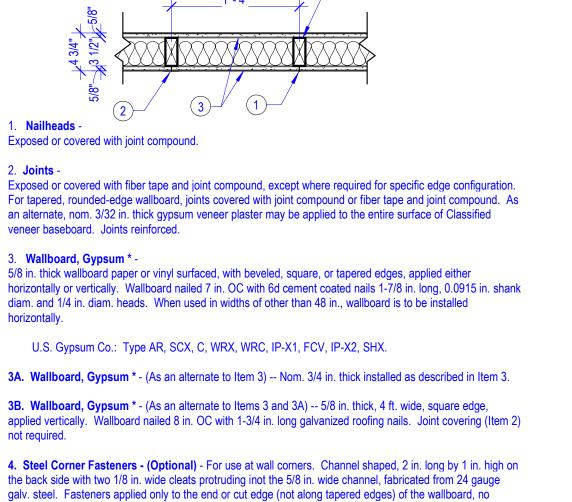

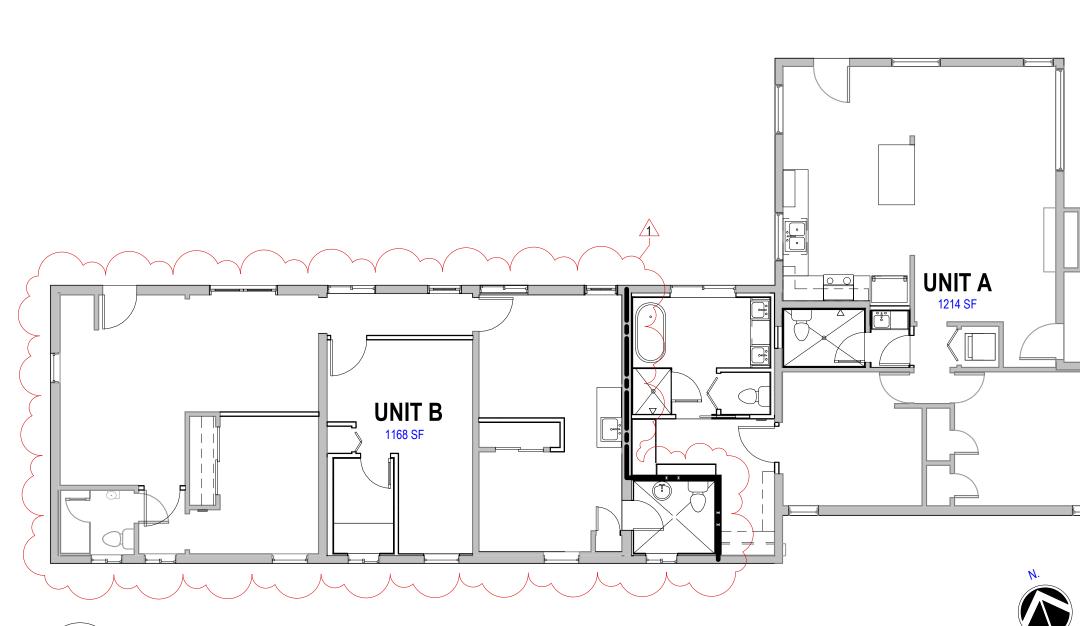

OVERALL FLOOR PLAN



LIFE SAFETY NOTES

- 1. CONTRACTOR SHALL COMPLY WITH LOCAL, STATE AND FEDERAL CODES, REGULATIONS AND ORDINANCES. CONTRACTOR SHALL BE RESPONSIBLE FOR OBTAINING PERMITS REQUIRED FOR CONSTRUCTION.
- 2. AT FIRE-RATED PARTITIONS, THE SURFACE AREA OF INDIVIDUAL METALLIC OUTLET OR SWITCH BOXES SHALL NOT EXCEED 16 SQUARE INCHES. THE AGGREGATE SURFACE AREA OF THE BOXES SHALL NOT EXCEED 100 SQUARE INCHES PER 100 SQUARE FEET.
- 3. BOXES LOCATED ON OPPOSITE SIDES OF WALLS OR PARTITIONS SHALL BE SEPARATED BY A HORIZONTAL DISTANCE OF NOT LESS THAN 24 INCHES.
- 4. FIRE-RATED PARTITIONS SHALL BE TIGHTLY SEALED TO THE UNDERSIDE OF DECK. INTEGRITY OF FIRE-RATED PARTIITONS SHALL BE MAINTAINED AT CORNERS AND AT INTERSECTIONS WITH OTHER PARTITION TYPES.
- 5. PENETRATIONS IN FIRE-RATED PARTITIONS BY CONDUIT PIPING OR OTHER ITEMS SHALL BE FILLED WITH AN APPROVED NON-COMBUSTIBLE MATERIAL TO PROVIDE AN UL TESTED SEAL TO PROHIBIT THE PASSAGE OF FIRE AND SMOKE.

REFERENCE SYMBOLS

5-D-21-SU

1-HR FIRE-RATED PARTITION.

SEE FRAMING PLAN & WALL TYPES.

CODE, ZONING, NOTES, SYMBOLS, OVERALL PLAN, ABBREVIATIONS, WALL TYPE\$ DATE ISSUED: 01/08/2021

ACADIA

DESIGN GROUP

a division of Acadia Landscape Co.

1417 N FOUTH AVE

KNOXVILLE, TN 37917

TWO-FAMILY INTERIOR

RENOVATION

DATE ISSUED: 03/22/2021

DATE ISSUED: 04/22/2021

RELEASE FOR CONSTRUCTION DRAWN BY: JM

ISSUED BY: PB

REVISION 1 /

PLANNING (CASE #: 5-D-21-SU)

G-001

WALL TYPE "C" - FIRE RATED WALL ASSEMBLY (U305)

5. Batts and Blankets* - (Optional, Not Shown) glass fiber or mineral wool insulation.

using No. 6d cement coated nails.

* Bearing the UL Classification Marking

greater than 2 in. from corner of wallboard, max. spacing 16 in. OC. Nailed to adjacent stud through tab using one No. 6d cement coated nail per fastener. Corners of wall board shall be nailed to top and bottom plate