Sheet List Table						
Sheet Number	Sheet Title					
G-001	Cover Sheet					
V-101	Preliminary Subdivision Survey					
C-101	Demolition Plan					
C-102	Erosion Control Plan- Stage 1					
C-103	Erosion Control Plan- Stage 2					
C-104	Site Layout Plan					
C-105	Grading and Drainage Plan					
C-106	Water and Sewer Utility Plan					
C-201	Profiles					
C-301	Stormwater Calculations Summary					
C-401	Stabilization Specifications					
C-402	Details					
C-403	Details					
C-404	Details					
C-405	Details					
C-406	Details					

# SITE DEVELOPMENT PLANS FOR: Fast Lube

TTCDA FILE NUMBER: 6-B-TOB

PLANNING COMMISSION FILE NUMBER: 6-C-24-DP

## SITE INFORMATION:

ADDRESS: 1405 LOVELL RD, KNOXVILLE, TN 37932

PARCEL ID: 118-016.01

JURISDICTION: KNOX COUNTY

## OWNER / DEVELOPER:

NAME: SHARPS TOTAL PERFORMANCE

ADDRESS: 7500 ASHEVILLE HIGHWAY, KNOXVILLE, TN 37924

CONTACT: SCOTT SHARP PHONE: (423)871-1333

EMAIL: FASTLUBETN@GMAIL.COM


## PREPARED FOR:

NAME: OYSK3 ARCHITECTS

ADDRESS: 1545 WESTERN AVE, KNOXVILLE, TN 37921

CONTACT: CARA KNAPP PHONE: (865)523-8200


EMAIL: CARA@OYSK3ARCHITECTS.COM

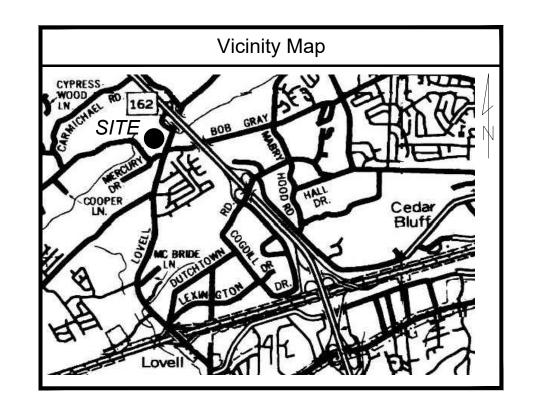

### **Project General Notes**

- IN THE EVENT OF ANY CONFLICT BETWEEN REQUIREMENTS INDICATED IN THESE DRAWINGS, THE MORE STRINGENT REQUIREMENT SHALL GOVERN
- CONTRACTOR SHALL ACQUIRE ALL NECESSARY PERMITS TO PERFORM CONSTRUCTION OF THE PROJECT PRIOR TO THE
- APPLICABLE LOCAL. STATE AND FEDERAL OSHA CONSTRUCTION SITE SAFETY MEASURES.
- NOTIFY THE OWNER OF DISCREPANCIES BETWEEN SITE
- PHOTOGRAPHS, OR OTHER METHODS, AND PROVIDE COPIES OF DOCUMENTATION TO OWNER.

- REPLACING WORK THAT FAILED TO COMPLY WITH QUALITY CONTROL REQUIREMENTS
- EXCAVATE OR DEMOLISH AT LEAST THREE (3) WORKING DAY CALENDAR DAY
- I.INSTALLATION AND REMOVAL OF, AND USE CHARGES FOR, TEMPORARY FACILITIES AND UTILITY SERVICES SHALL BE THE RESPONSIBILITY OF THE CONTRACTOR. ARRANGE WITH UTILITY AUTHORITY, OWNER, AND EXISTING USERS FOR A TIME WHEN SERVICE CAN BE INTERRUPTED, IF NEEDED, TO MAKE CONNECTIONS FOR TEMPORARY UTILITY SERVICES. ALLOW OTHER ENTITIES TO USE TEMPORARY SERVICES AND FACILITIES, INCLUDING BUT NOT LIMITED TO, TESTING AGENCIES AND AUTHORITIES HAVING JURISDICTION.
- 2. CONTRACTOR SHALL PROVIDE TEMPORARY TOILETS, WASH FACILITIES. AND DRINKING WATER FOR USE OF CONSTRUCTION PERSONNEL. COMPLY WITH REQUIREMENTS OF AUTHORITIES HAVING JURISDICTION FOR TYPE, NUMBER. LOCATION, OPERATION, AND MAINTENANCE OF FACILITIES.
- 13. THE CONTRACTOR SHALL MAINTAIN SURFACE AND SUBSURFACE DRAINAGE DURING CONSTRUCTION, AND PROVIDE ALL PUMPS, PIPES, AND DEWATERING DEVICES
- 14. THE CONTRACTOR SHALL PROVIDE TEMPORARY BARRICADES AND OTHER PROTECTION REQUIRED TO PREVENT INJURY TO PEOPLE AND DAMAGE TO ADJACENT BUILDINGS AND FACILITIES TO REMAIN.
- 5. CONTRACTOR SHALL PROVIDE AND MAINTAIN SHORING, BRACING, AND STRUCTURAL SUPPORTS AS REQUIRED TO PRESERVE STABILITY AND PREVENT MOVEMENT, SETTLEMENT, OR COLLAPSE DURING CONSTRUCTION.
- 6. CONTRACTOR SHALL COMPLY WITH MANUFACTURER'S WRITTEN INSTRUCTIONS AND RECOMMENDATIONS FOR INSTALLING PRODUCTS IN APPLICATIONS INDICATED.
- 7. CONTRACTOR SHALL USE PRODUCTS, CLEANERS, AND INSTALLATION MATERIALS THAT ARE NOT CONSIDERED HAZARDOUS.
- 18.CONTRACTOR SHALL CLEAN PROJECT SITE AND WORK AREAS DAILY, INCLUDING COMMON AREAS. PROVIDE SUITABLE LITTER AND DEBRIS CONTAINERS ON-SITE, AND DISPOSE OF MATERIALS LAWFULLY.
- 9. CONTRACTOR SHALL MAINTAIN ONE PAPER COPY SET OF MARKED-UP RECORD DRAWINGS, INCORPORATING NEW AND REVISED DRAWINGS AS MODIFICATIONS ARE ISSUED. CONTRACTOR SHALL PROVIDE RECORD DRAWINGS TO OWNER AT THE COMPLETION OF WORK. MARK-UP DRAWINGS SHALL SHOW ACTUAL INSTALLATION WHERE INSTALLATION VARIES FROM THAT SHOWN ORIGINALLY. REQUIRE ENTITY WHO OBTAINED RECORD DATA TO PROVIDE INFORMATION FOR PREPARATION OF CORRESPONDING MARKED-UP RECOR DRAWINGS. IDENTIFY AND DATE EACH RECORD DRAWING; INCLUDE THE DESIGNATION "PROJECT RECORD DRAWING" IN A PROMINENT LOCATION

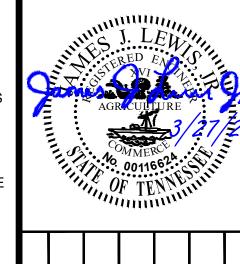

Revision	3/27/24 Submitted for permit review	4/18/24 SWQ structure; TTCDA and PC submittal	5/18/24 TTCDA PC comments and Knox Co Comments				!
Date	3/27/24	4/18/24	5/18/24				
No.	0	1	2		-		-
Drawn By:				MBB			
Checked By:				JJL			
Approved By:				JJL			
LT Project No.:				2312068			

D(O)453-F LT Drawing No. 3/27/24 N/A

**Cover Sheet** 

G-001


MAP CABINET N, SLIDE 329D


865-938-2042

FAX (865) 588-6473


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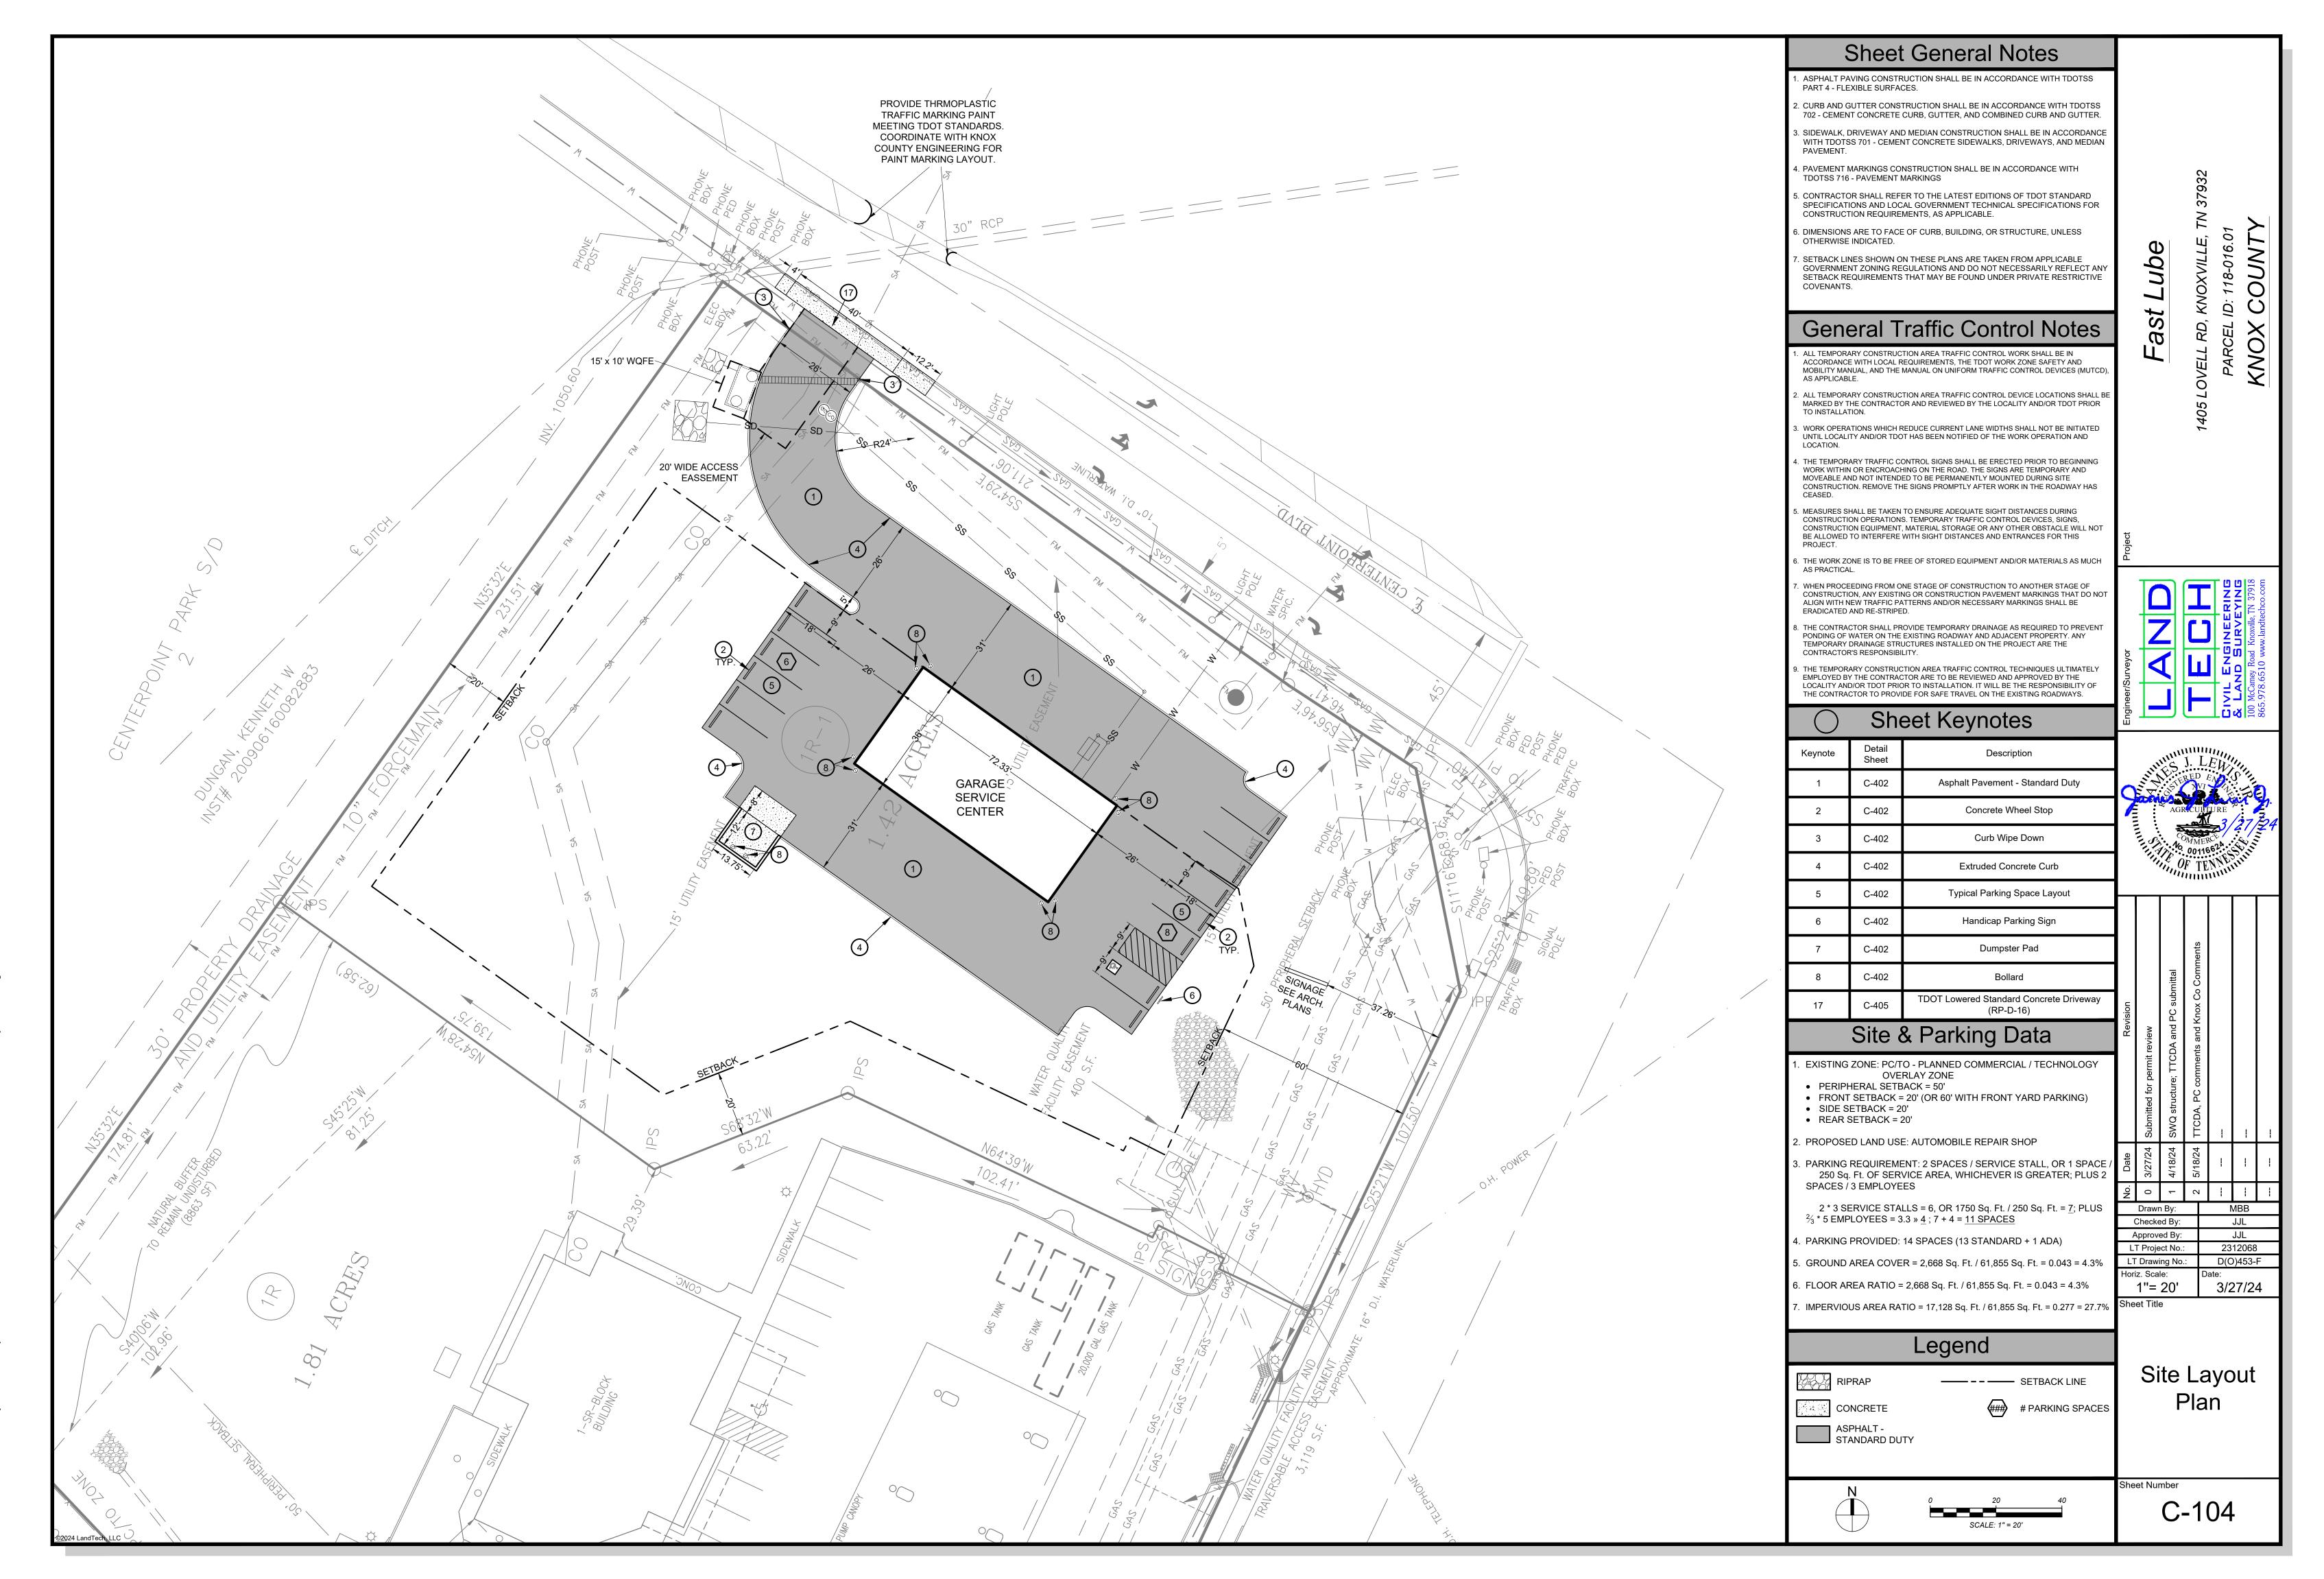


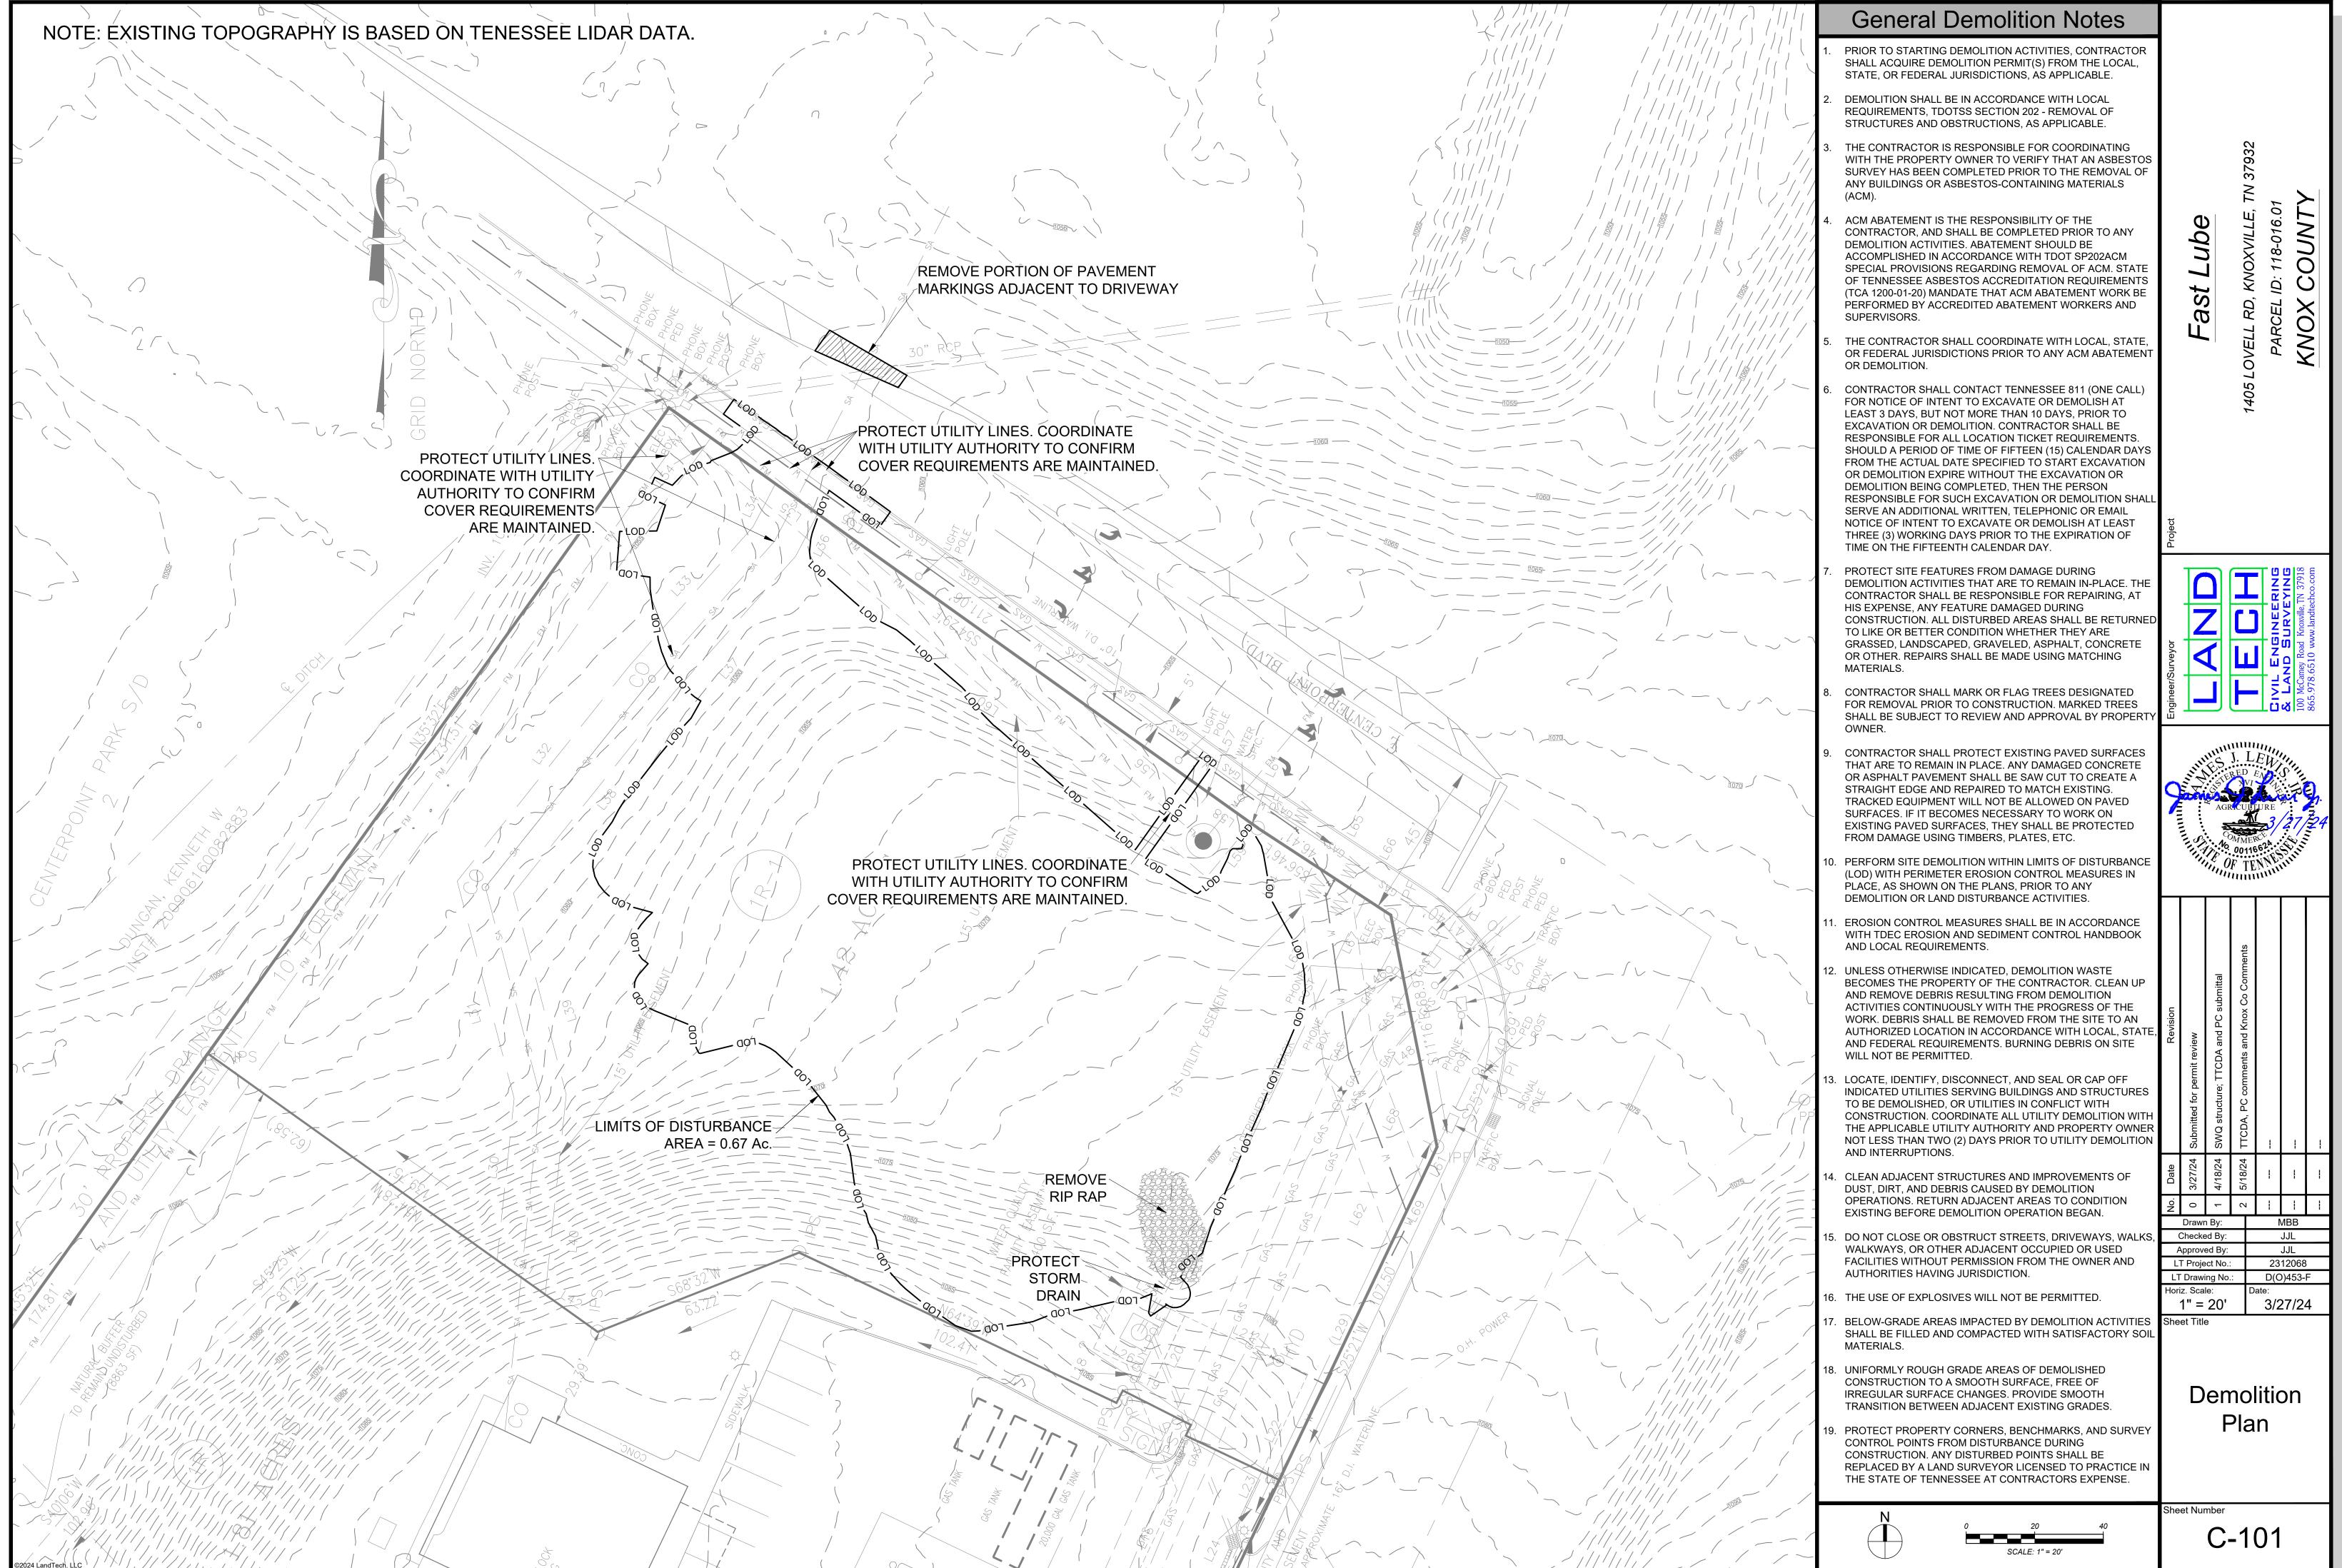


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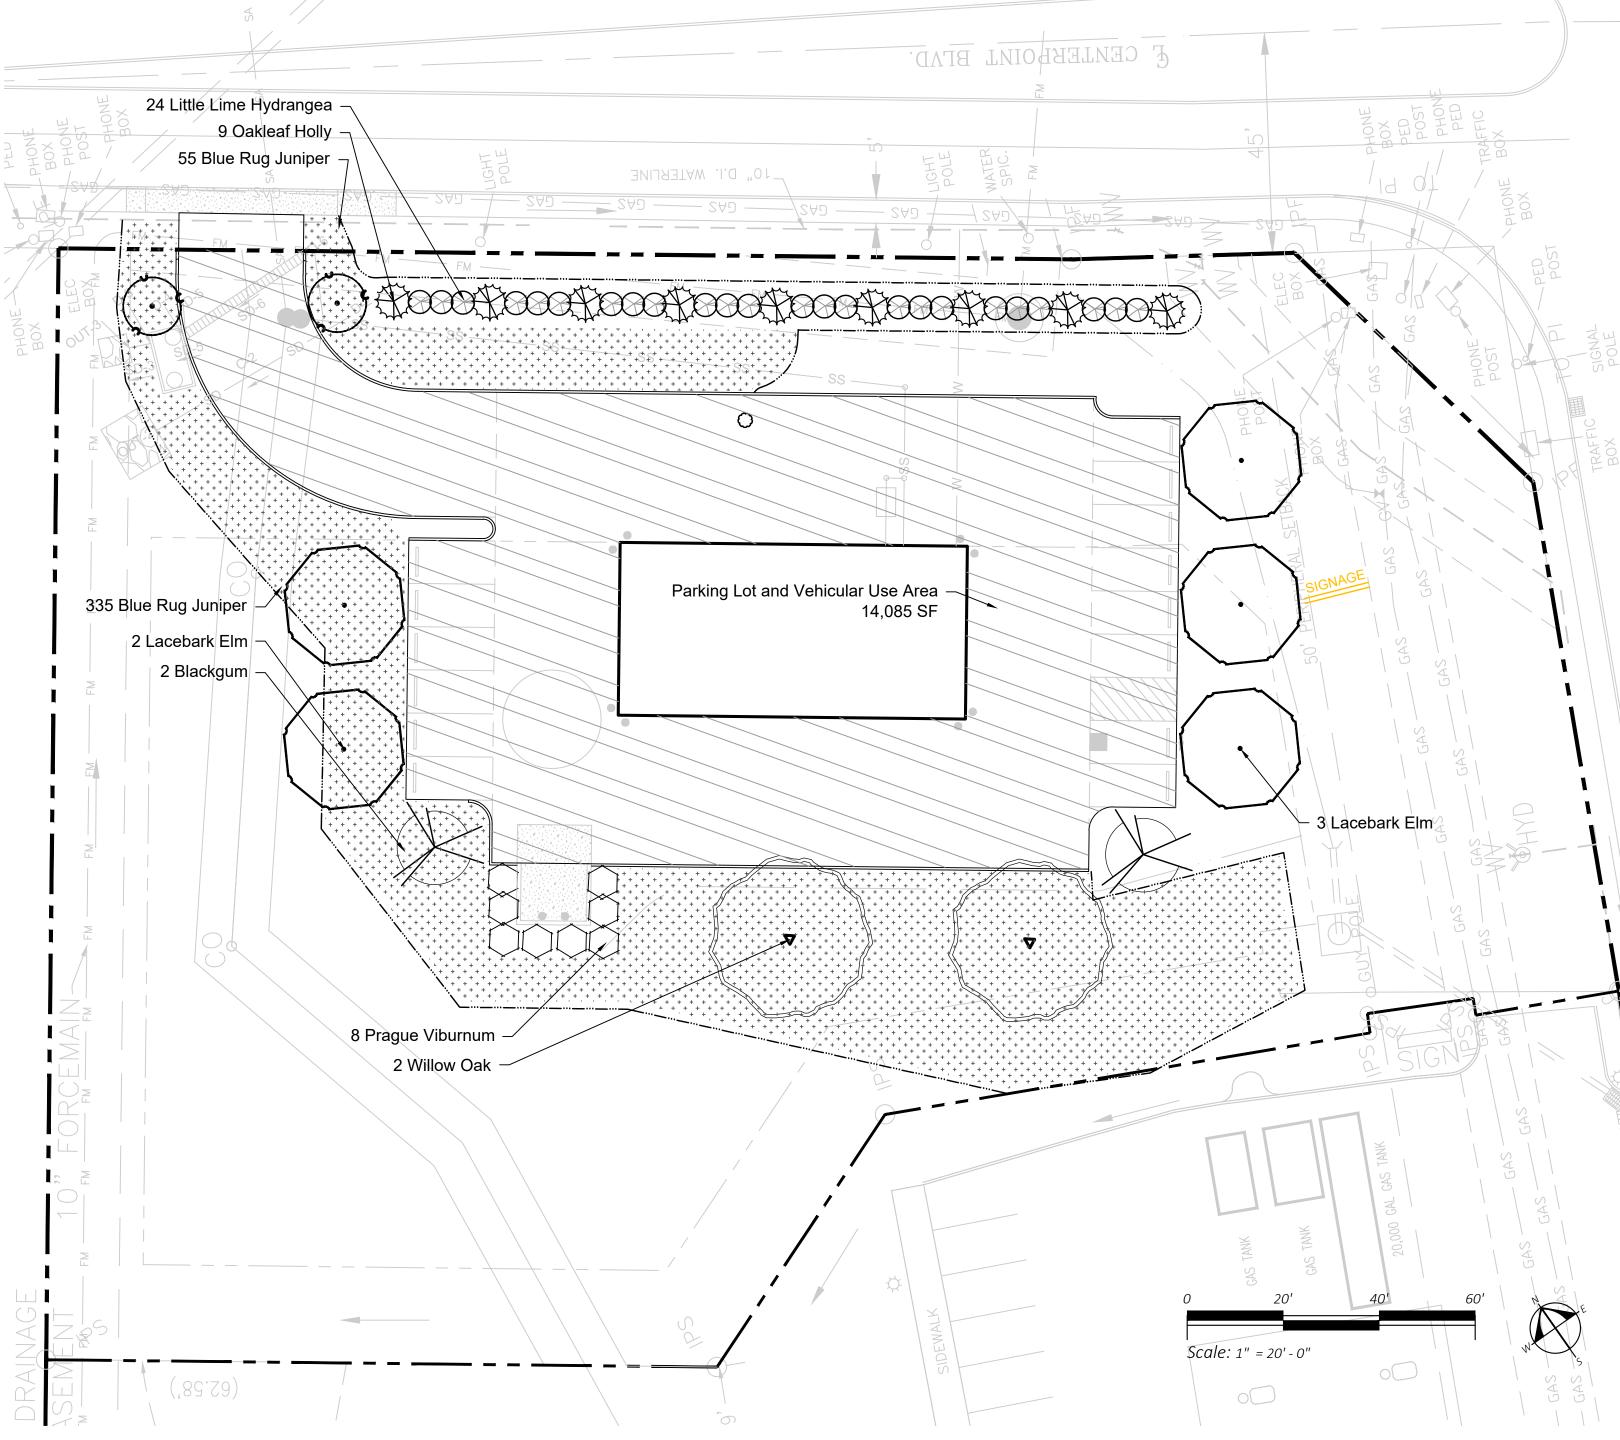
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### PLANTING NOTES:

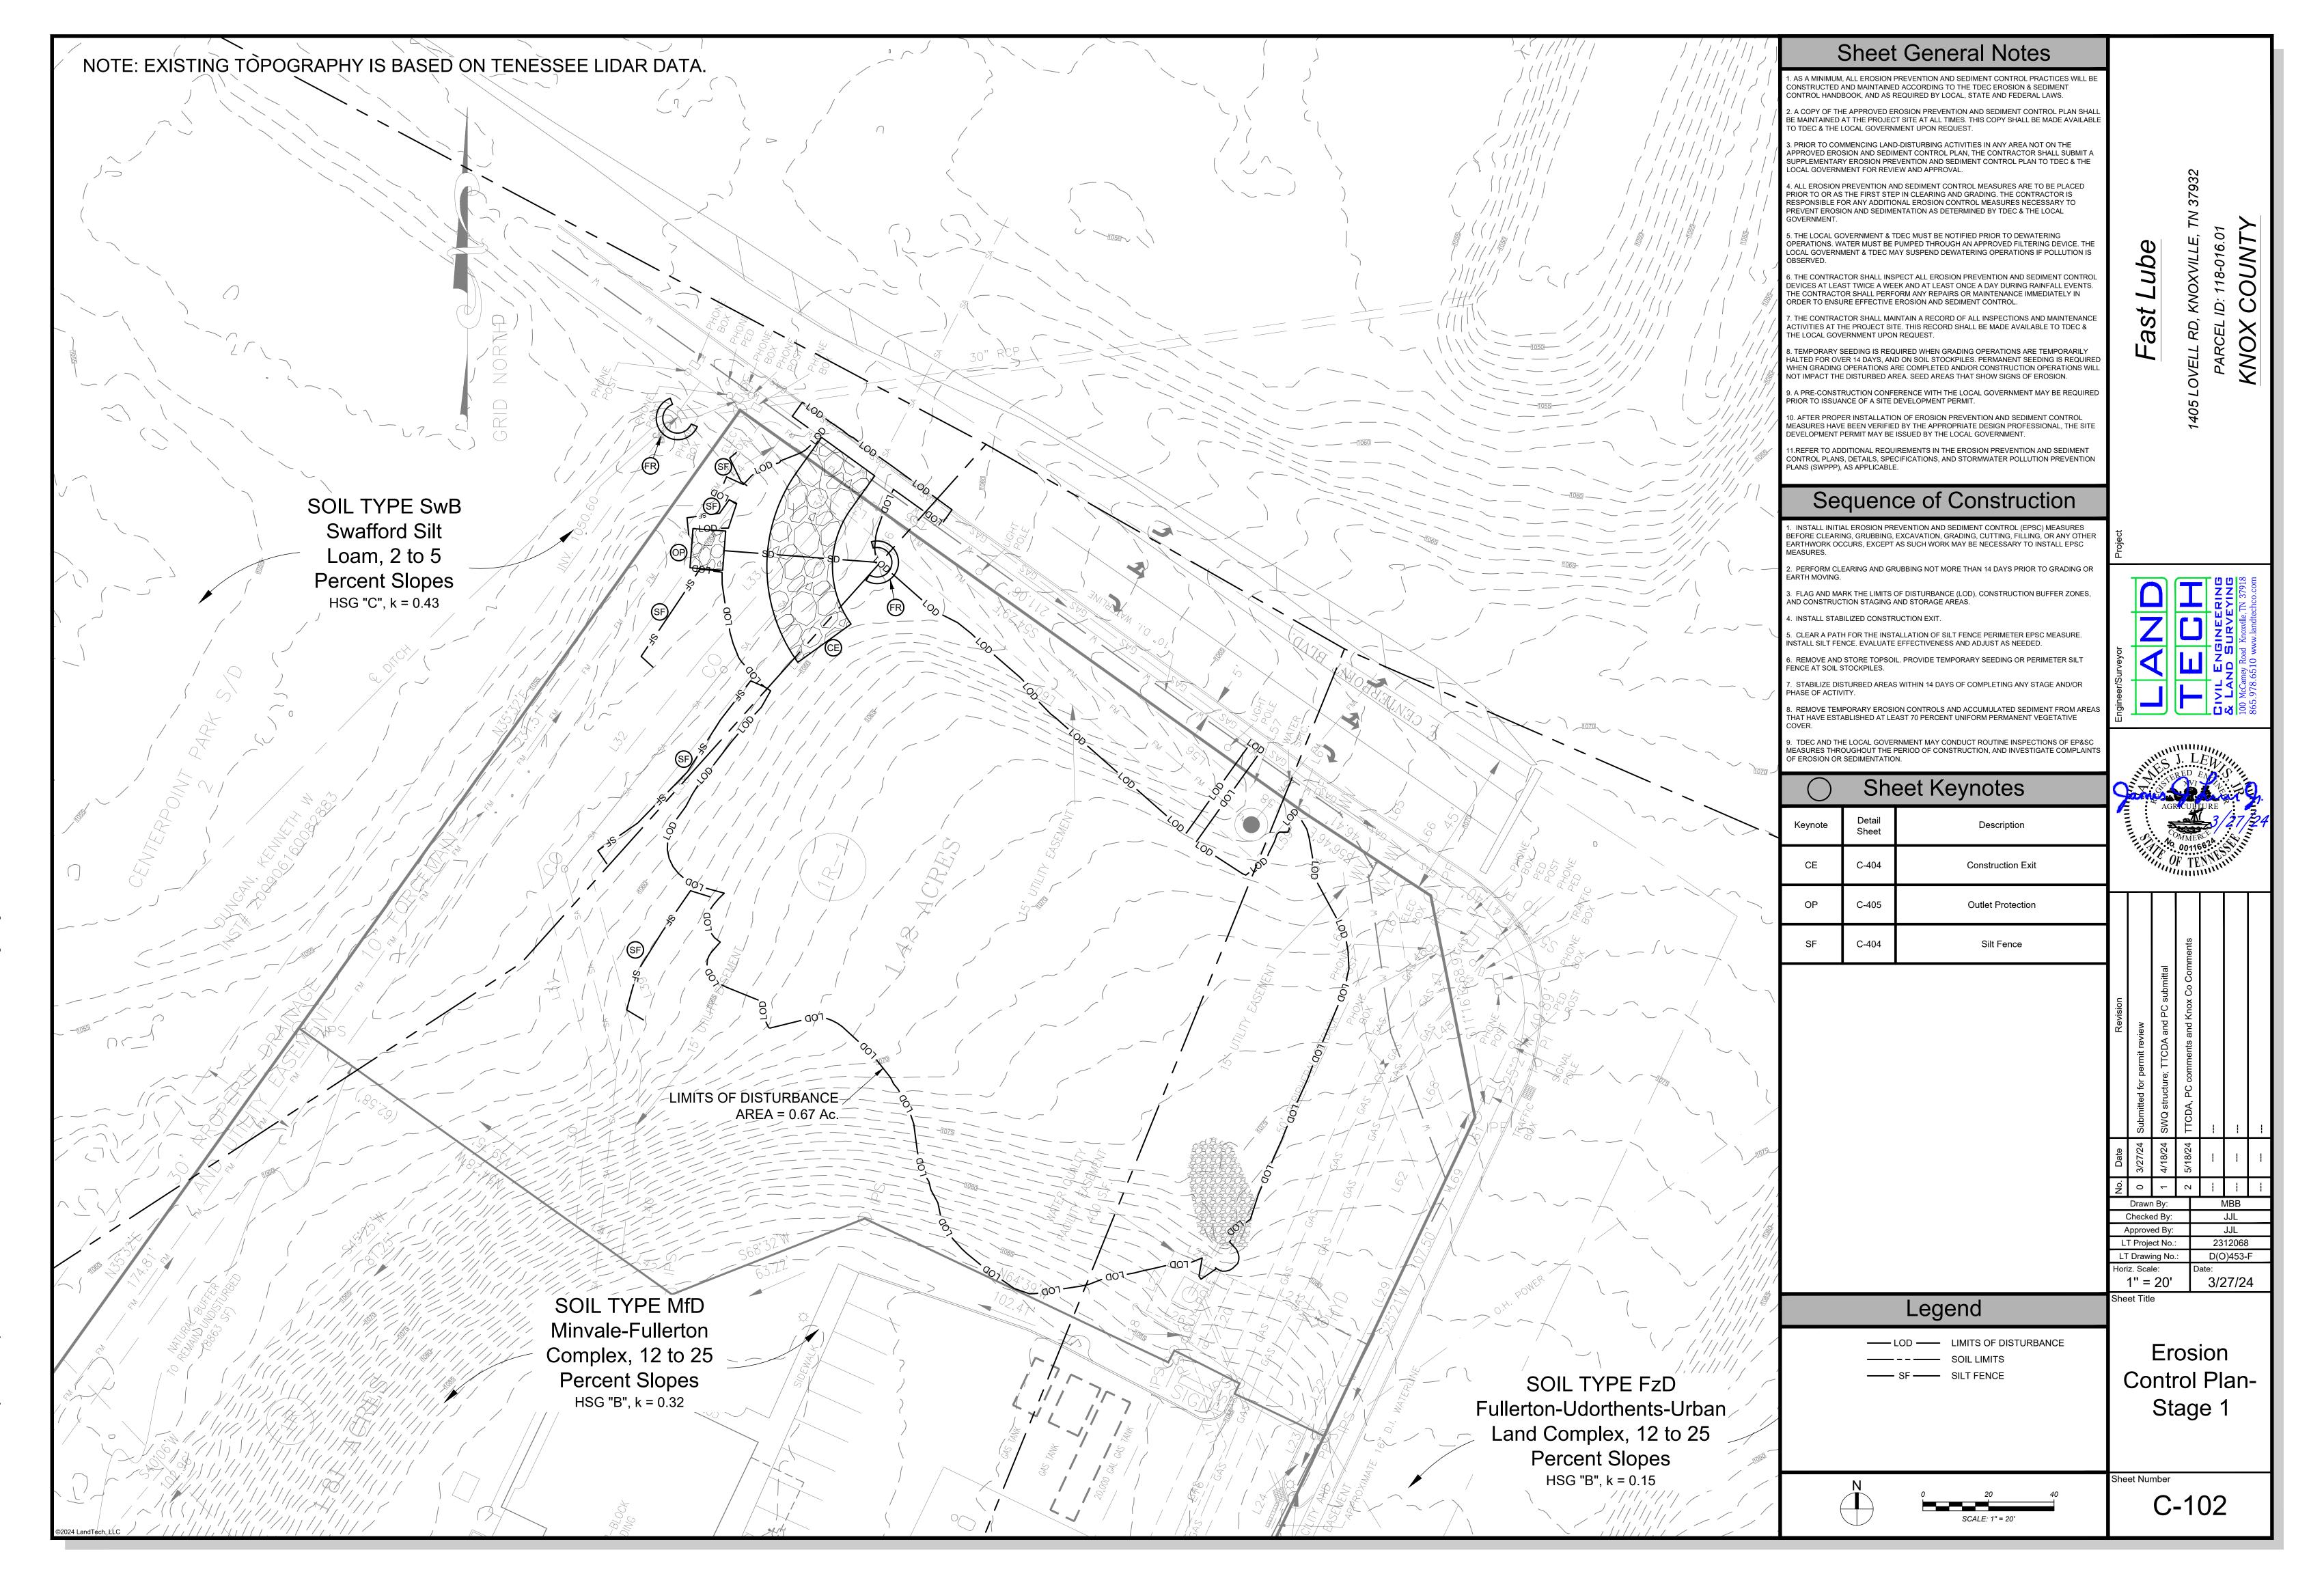- Contractor's base bid to include all materials, labor, permits, equipment, tools, insurance, etc. to perform the work as described in the contract documents.
- Contractor to provide allowance for soil ammendments, percolation tests, soil tests, mulch and irrigation.
- 3. Irrigation system to be drip unless otherwise noted and approved.
- 4. Contractor to complete work within schedule established by owner.
- 5. Contractor to provide one year warranty for all plant material from date of substantial completion.
- 6. Contractor to provide interim maintenance (watering, pruning, fertilizing, guying, mowing, trimming, adequate drainage of ponding areas, edging, weeding, mulching, application of insecticides/herbicides, and general landscape clean-up) until substantial completion notice is provided by the owner or landscape architect.
- 7. The contractor shall locate and verify all existing utilities prior to planting and report any conflicts to the landscape architect. Perform work in compliance with all applicable laws, codes, and regulations required by authorities having jurisdiction over such work and provide for permits required by local authorities.
- 8. All plant material to be specimen quality as established by the American Association of Nurserymen, horticultural standards, latest edition. quality of the plant material to be judged by the landscape architect. Inferior plant material to be rejected.
- 9. Plant material to be free of disease, weeds and insect pests. Damaged plant material shall be rejected.
- 10. No planting shall take place until rough grade has been reviewed and approved by the landscape architect.
- 11. Planting plans may need to be adjusted in the field. Contractor to coordinate layout of plant material with landscape architect for on site approval prior to installation.
- 12. Test plant beds and plant pits for adequate drainage. Hardpan or moisture barriers shall be broken, or drain pipes to be installed to provide proper drainage of plant areas. Plant pits shall be excavated to the bottom of the pit. Fill each plant pit with water and observe the pit for 2 hours. If the water has not dissipated by 50% within 2 hours, notify landscape architect of such in writing before installing plants in the questionable area. Otherwise contractor shall be held liable for plants.
- 13. Trees shall be installed 3" above finish grade in hardpan areas to provide good drainage unless otherwise directed.
- 14. Groundcover and shrub mass beds shall be cultivated to a depth of 12 inches below grade to break through compacted or hardpan soil. Remove all stones, roots, and weeds. Add specified soil amendments and fertilizer. Install plants, edge bed area, mulch and water thoroughly.
- 15. Set all plants plumb and turned so that the most attractive side is viewed.
- 16. Plants shall be measured to their main structure, not tip to tip of branches.
- 17. Tree pit and shrub pit to be twice the size of the root mass. Fill with plant mix.
- 18. Broken root balls for trees shall be rejected. Contractor to check root balls and expose rootflares to check for root girdling. Do not assume the rootflare is exposed upon purchase from the nursery.
- 19. Any plant materials shipped to site in uncovered vehicles/ trailer shall be rejected regardless of season.
- 20. All tree scars over 1 1/2" shall be rejected and tree to be replaced.
- 21. All shrubs to be dense and full. All trees to have a symmetrical growth habit (360 degrees) unless uncharacteristic to plant type or otherwise noted on plans.
- 22. Remove all excess growth of trees and shrubs as directed by landscape architect. Do not cut central leader.
- 23. If rootball is wrapped in non-biodegradeable burlap, remove entire wrap after placed in pit.


#### TTCDA - LANDSCAPE REQUIREMENT NOTES:

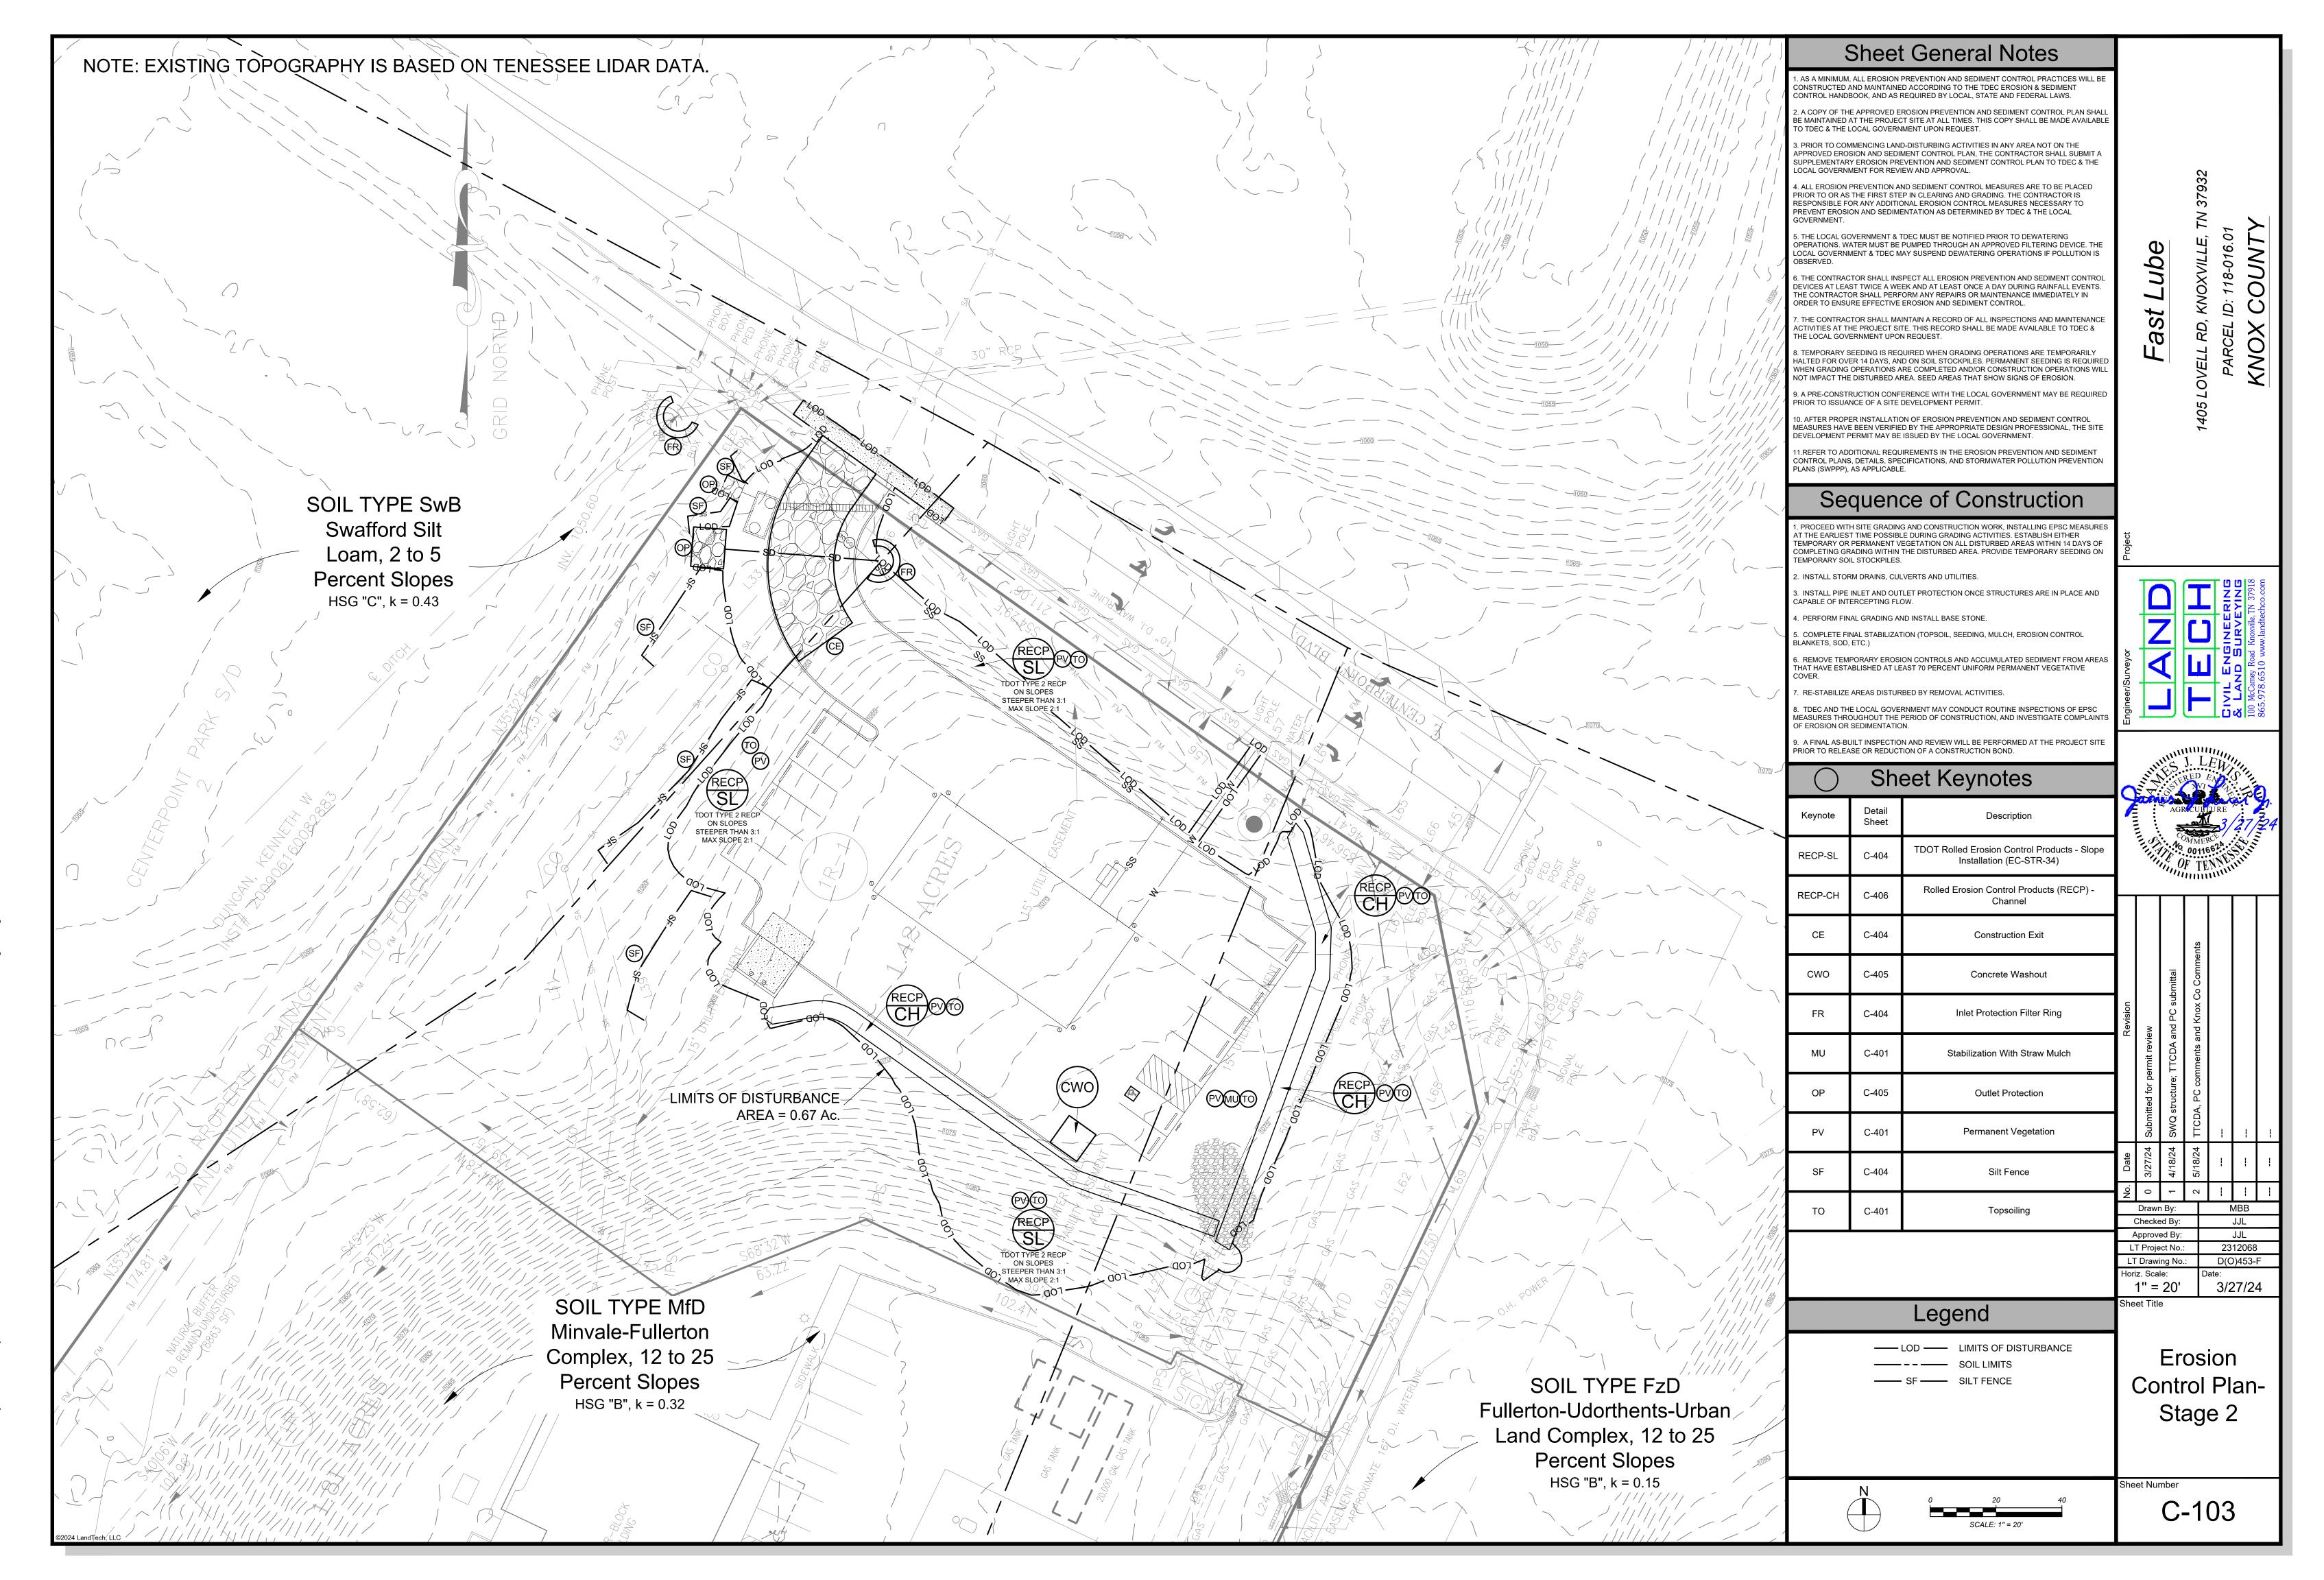- 3.1.4 In order to provide year-round greenery, at least 25% of newly planted or conserved trees should be evergreen.
- 20 trees proposed
- 9 evergreen = 45%
- 3.1.5 When planting trees on a development site, a roughly equal combination of large, medium and small trees (see Appendix B)
- should be planted, with at least 10 large maturing trees per acre of yard space.
- 1.4 acres \* 10 = 14 trees
- 20 trees proposed
- 3.1.8 The required front yard for a 1-, 2- or 3-story building with no parking in front shall be landscaped. A minimum 20-foot landscaped yard shall be placed between the right-of-way and a parking area in front of a building.
- landscape yard provided
- 3.2.1 The arrival areas should be landscaped to make an introductory statement about each site.
- landscape provided at driveway entrance and front of building
- 3.2.2 Landscaping should be used to accentuate entryways to the site and the building(s) and to provide areas of shade
- all entry areas landscaped, shade provided where adequate room for tree growth is available
- 3.3.2 Entrances into buildings should be accented by plantings. - all entry areas landscaped
- 3.3.3 Areas around buildings equal to 50% of the area of each front and side elevation shall be planted with ornamental trees, shrubbery and bedding plants (see Appendix B)
- No planting areas provided directly around building
- 3.3.4 Minimize shading of south-facing facades in winter; maximize shading of south-facing facades in summer. - trees proposed near south facade
- 3.3.5 Landscaping should buffer the building from the microclimate of the parking area.
- trees proposed around parking and drive aisles
- 3.3.6 Landscaping should be used to screen mechanical equipment or other unsightly exterior building elements.
- 3.4.1 Parking areas should be screened from public rights-of-way by landscaped berms, low level shrubbery or a combination of the two.
- NA
- 3.4.2 If surface parking is necessary, existing trees both upslope and downslope should be conserved for environmental and aesthetic purposes. In cases where existing vegetation cannot be saved, or does not exist, medium and large maturing canopy trees should be planted between parking areas.
- trees proposed near all parking areas
- 3.4.3 Trees shall be required at the rate of one (1) medium or large maturing canopy tree for every ten parking spaces provided.
- 14 parking space proposed, 7 large trees proposed
- 3.4.4 In addition to the planting of required canopy trees, planting areas for ornamental trees, shrubbery and bedding plants shall be no less than five (5) percent of the surface area devoted to parking.
- Total Parking Lot and Vehicular Use Area = 14,085 square fee
- Total Landscape Bed Area = 11,427 square feet
- 3.4.5 Medium and large maturing canopy and ornamental trees may be chosen from the recommended species list in Appendix B.
- 3.3.6 Mature trees that are preserved within eight feet of the parking area may be used to satisfy up to 50% of the required number of canopy trees, as described in (a) above. In all other respects, however, the number of trees and other plantings required for parking areas shall be in addition to those required under Section 3.1.
- N/A, no trees preserved
- 3.3.7 Required canopy trees shall be located within the parking areas as terminal islands, interior islands, interior wells, medians, traffic delineators, between rows of parking spaces, or in planting areas adjacent to buildings in a manner such that no parking space is located more than sixty (60) feet from the trunk of a large canopy tree.
- trees puroposed within 60' of all parking spaces
- 3.3.8 Interior islands at the rate of one for every 200 feet of parking shall be installed to break up long rows of parking stalls.


#### PLANTING LEGEND

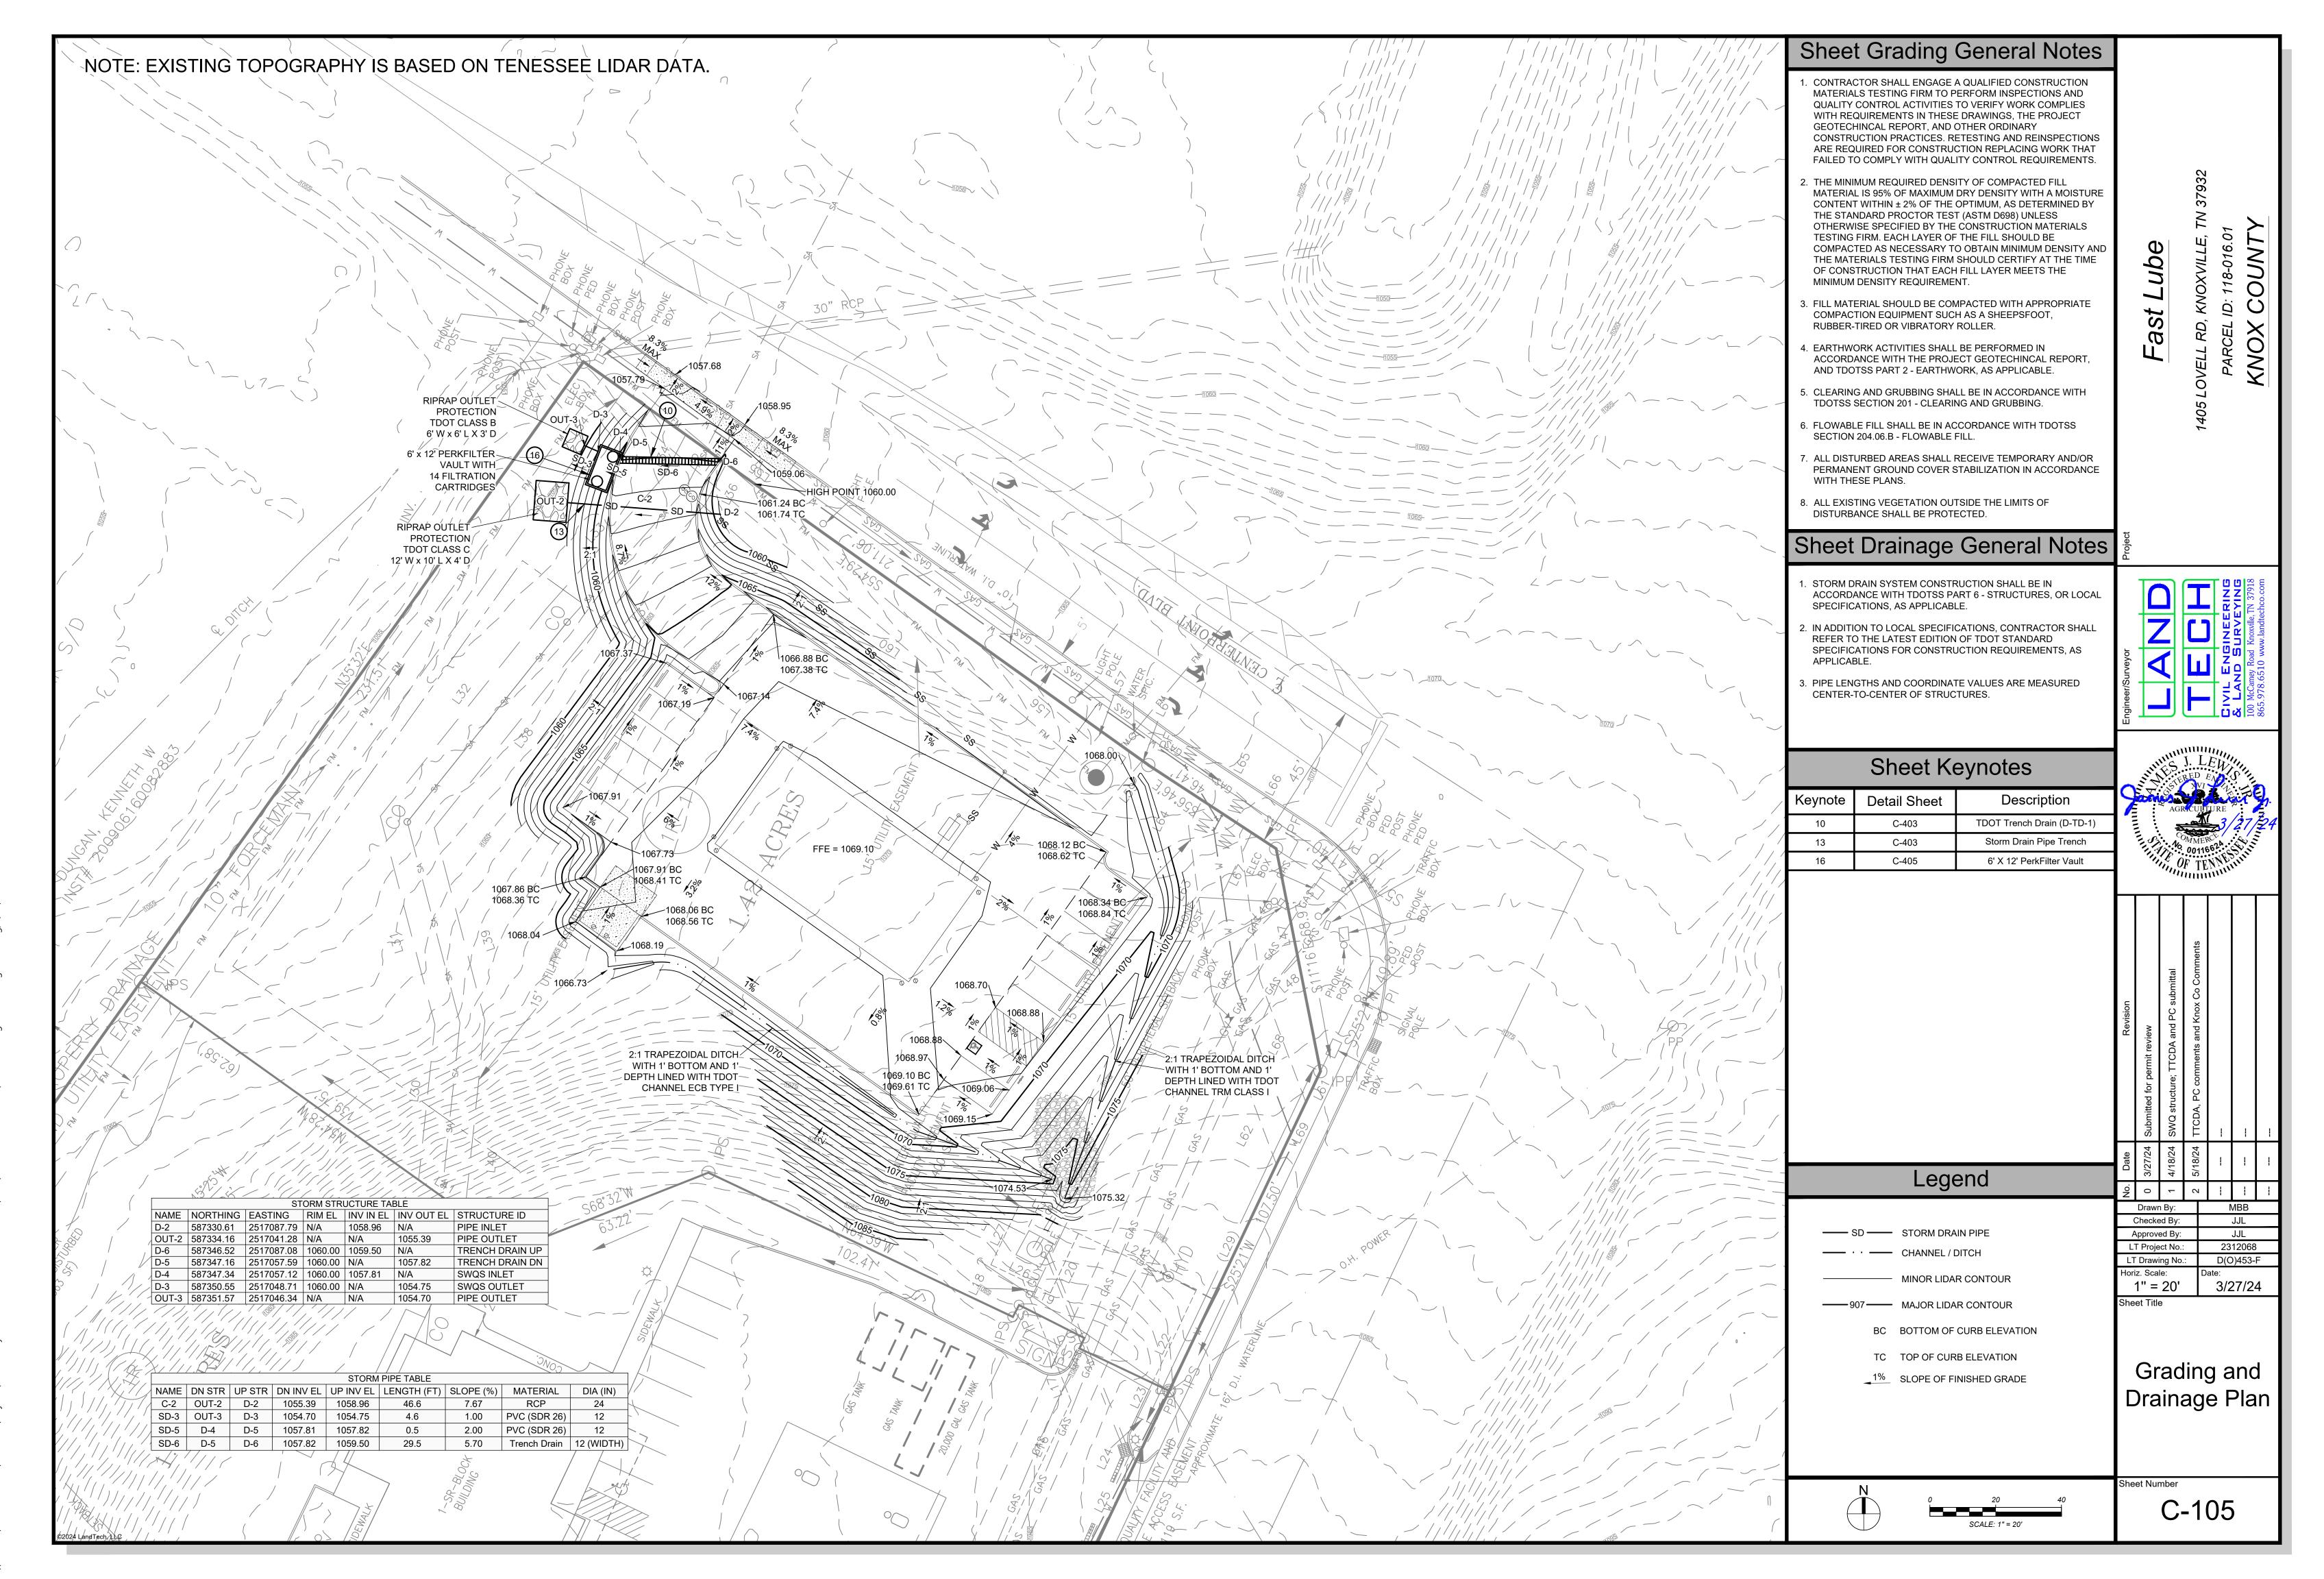Qnty	Botanical Name	Common Name	Size	Notes	Size
Deciduo	us Trees				
2	Cercis canadensis	Redbud	2" cal.	central leader, full and dense	S
2	Nyssa sylvatica	Blackgum	2" cal.	central leader, full and dense	M
2	Quercus phellos	Willow Oak	2" cal.	central leader, full and dense	L
5	Ulmus parvifolia	Lacebark Elm	2" cal.	central leader, full and dense	M
Evergree	en Trees				
9	llex x 'Conaf'	Oakleaf Holly	6' hgt.	central leader, full and dense	M
Deciduo	us Shrubs				
24	Hydrangea paniculata	Littel Lime Hydrangea	3 gallon	full and dense	
Evergree	en Shrubs				
390	Juniperus horizontalis	Blue Rug Juniper	3 gallon	full and dense	
8	Viburnum x pragense	Prague Viburnum	3 gallon	full and dense	

- This landscape plan is designed to meet minimum TTCDA landscape requirements only.
- All HVAC units shall be screened with vegetation as per TTCDA landscaping ordinance.
- Planning Commission File # ???
- TTCDA Case #???

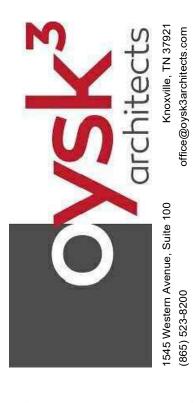



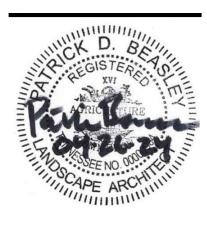


Drawn by: PB Checked by:

LANDSCAPE PLAN

DATE: 04/26/2024 PROJECT: 23180

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LIGHTING FIXTURE SCHEDULE ILLUMINATION MOUNTING CEILING WALL DESCRIPTION: SHIELDING, TYPE MATERIALS, FINISH, MOUNTING \* EQUAL PRODUCT MANUFACTURER'S PRODUCT ITEM REMARKS PERMITTED CATALOG NO. YES NO COMPANY VERIFY MOUNTING HEIGHT WITH D 18 2000 4000 80 COMPACT EXTERIOR WALL PACK, DARK BRONZE FINISH, CUTOFF XTOR2B−W−BZ | • | METALUX OPTICS ARCHITECT \* UNLESS NOTED, EQUAL PRODUCT TO THAT SPECIFIED WILL BE ACCEPTED. THE DESIGN PROFESSIONAL SHALL HAVE SOLE JUDGEMENT CONCERNING EQUIVALENCY OF SUBSTITUTION.

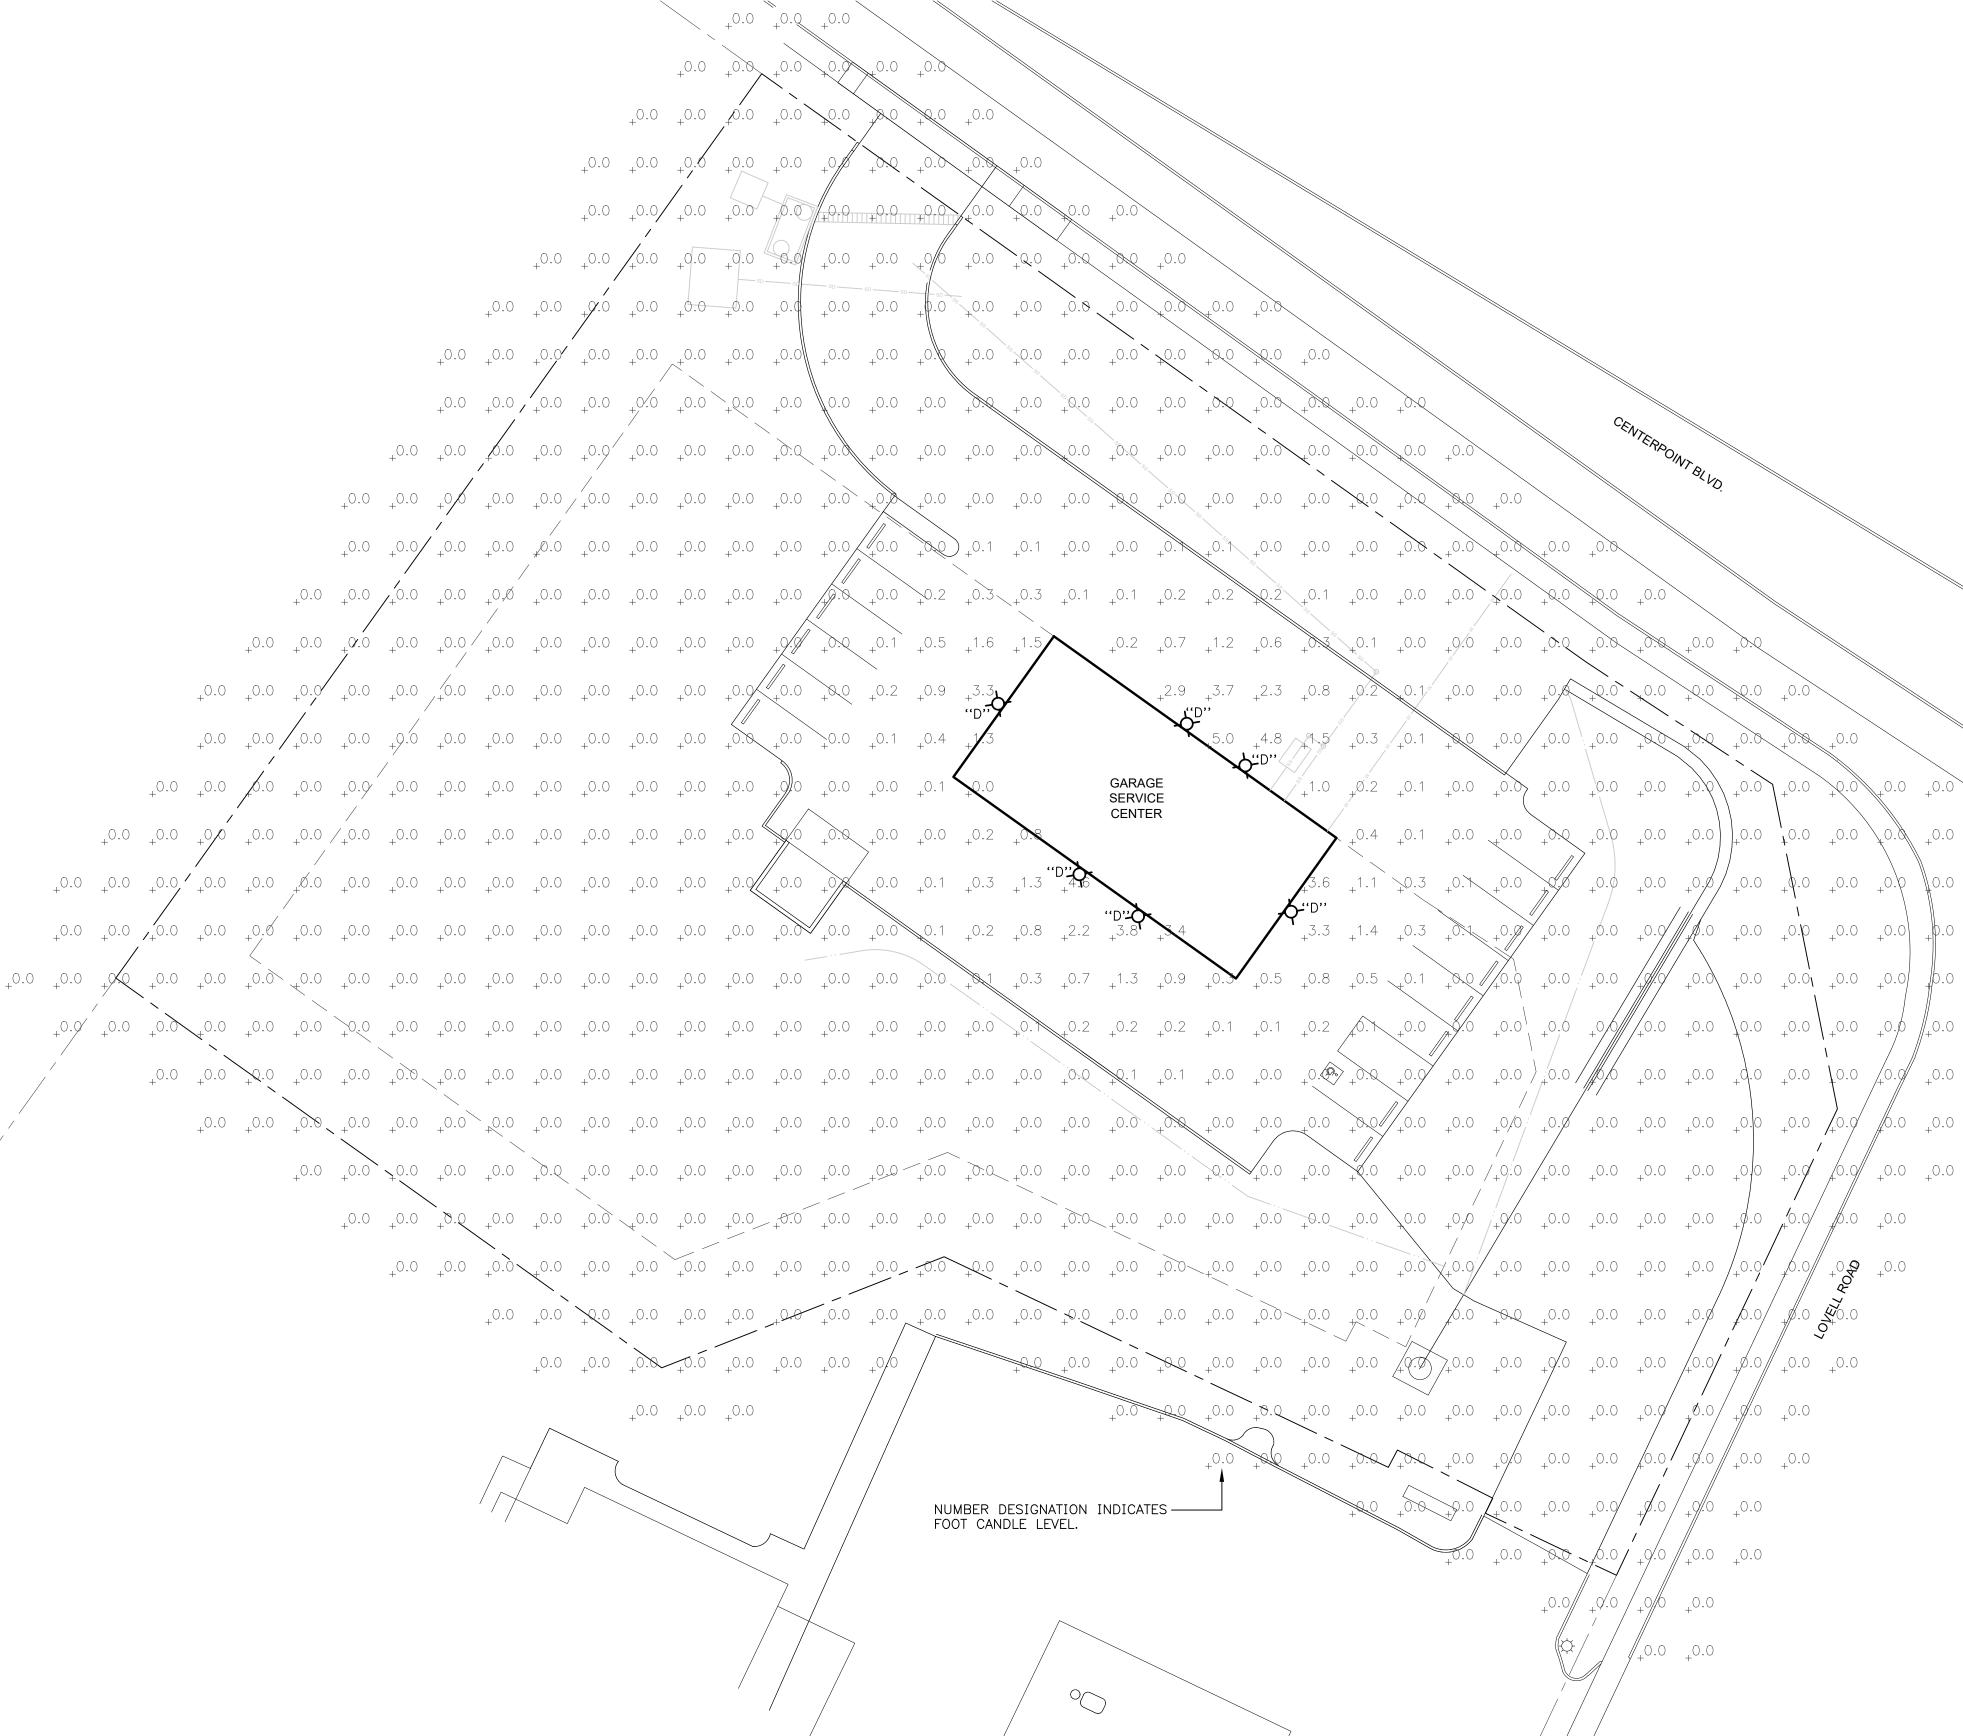SITE ILLUMINATION PLAN SCALE: 1" = 20' - 0"

 $^{\circ}$ 

### NOTES:

- VALUES INDICATE COMPUTER CALCULATED MAINTAINED ILLUMINATION LEVELS IN FOOTCANDLES; USING A TOTAL MAINTAINENCE FACTOR UTILIZED OF 0.82.
- 2. FOOTCANDLE LEVELS SHOWN INDICATE CONTRIBUTIONS FROM NEW LIGHT SOURCES SHOWN ON THIS DRAWING ONLY. LIGHT LEVELS VARY DUE TO ORIENTATION AND CONTRIBUTIONS FROM NEIGHBORING LIGHTING FIXTURES.

ENTIRE DRAWING ADDED TO SET.

Checked by: HD

Drawn by: VEI


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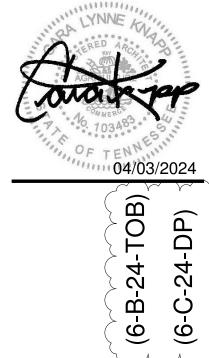
SITE ILLUMINATION PLAN

DATE: 1/23/2024 PROJECT: 23180 © COPYRIGHT 2023

Vreeland Engineers Inc. 3107 Sutherland Ave. P.O. Box 10648 Knoxville, TN 37939 865-637-4451 1-800-362-9789





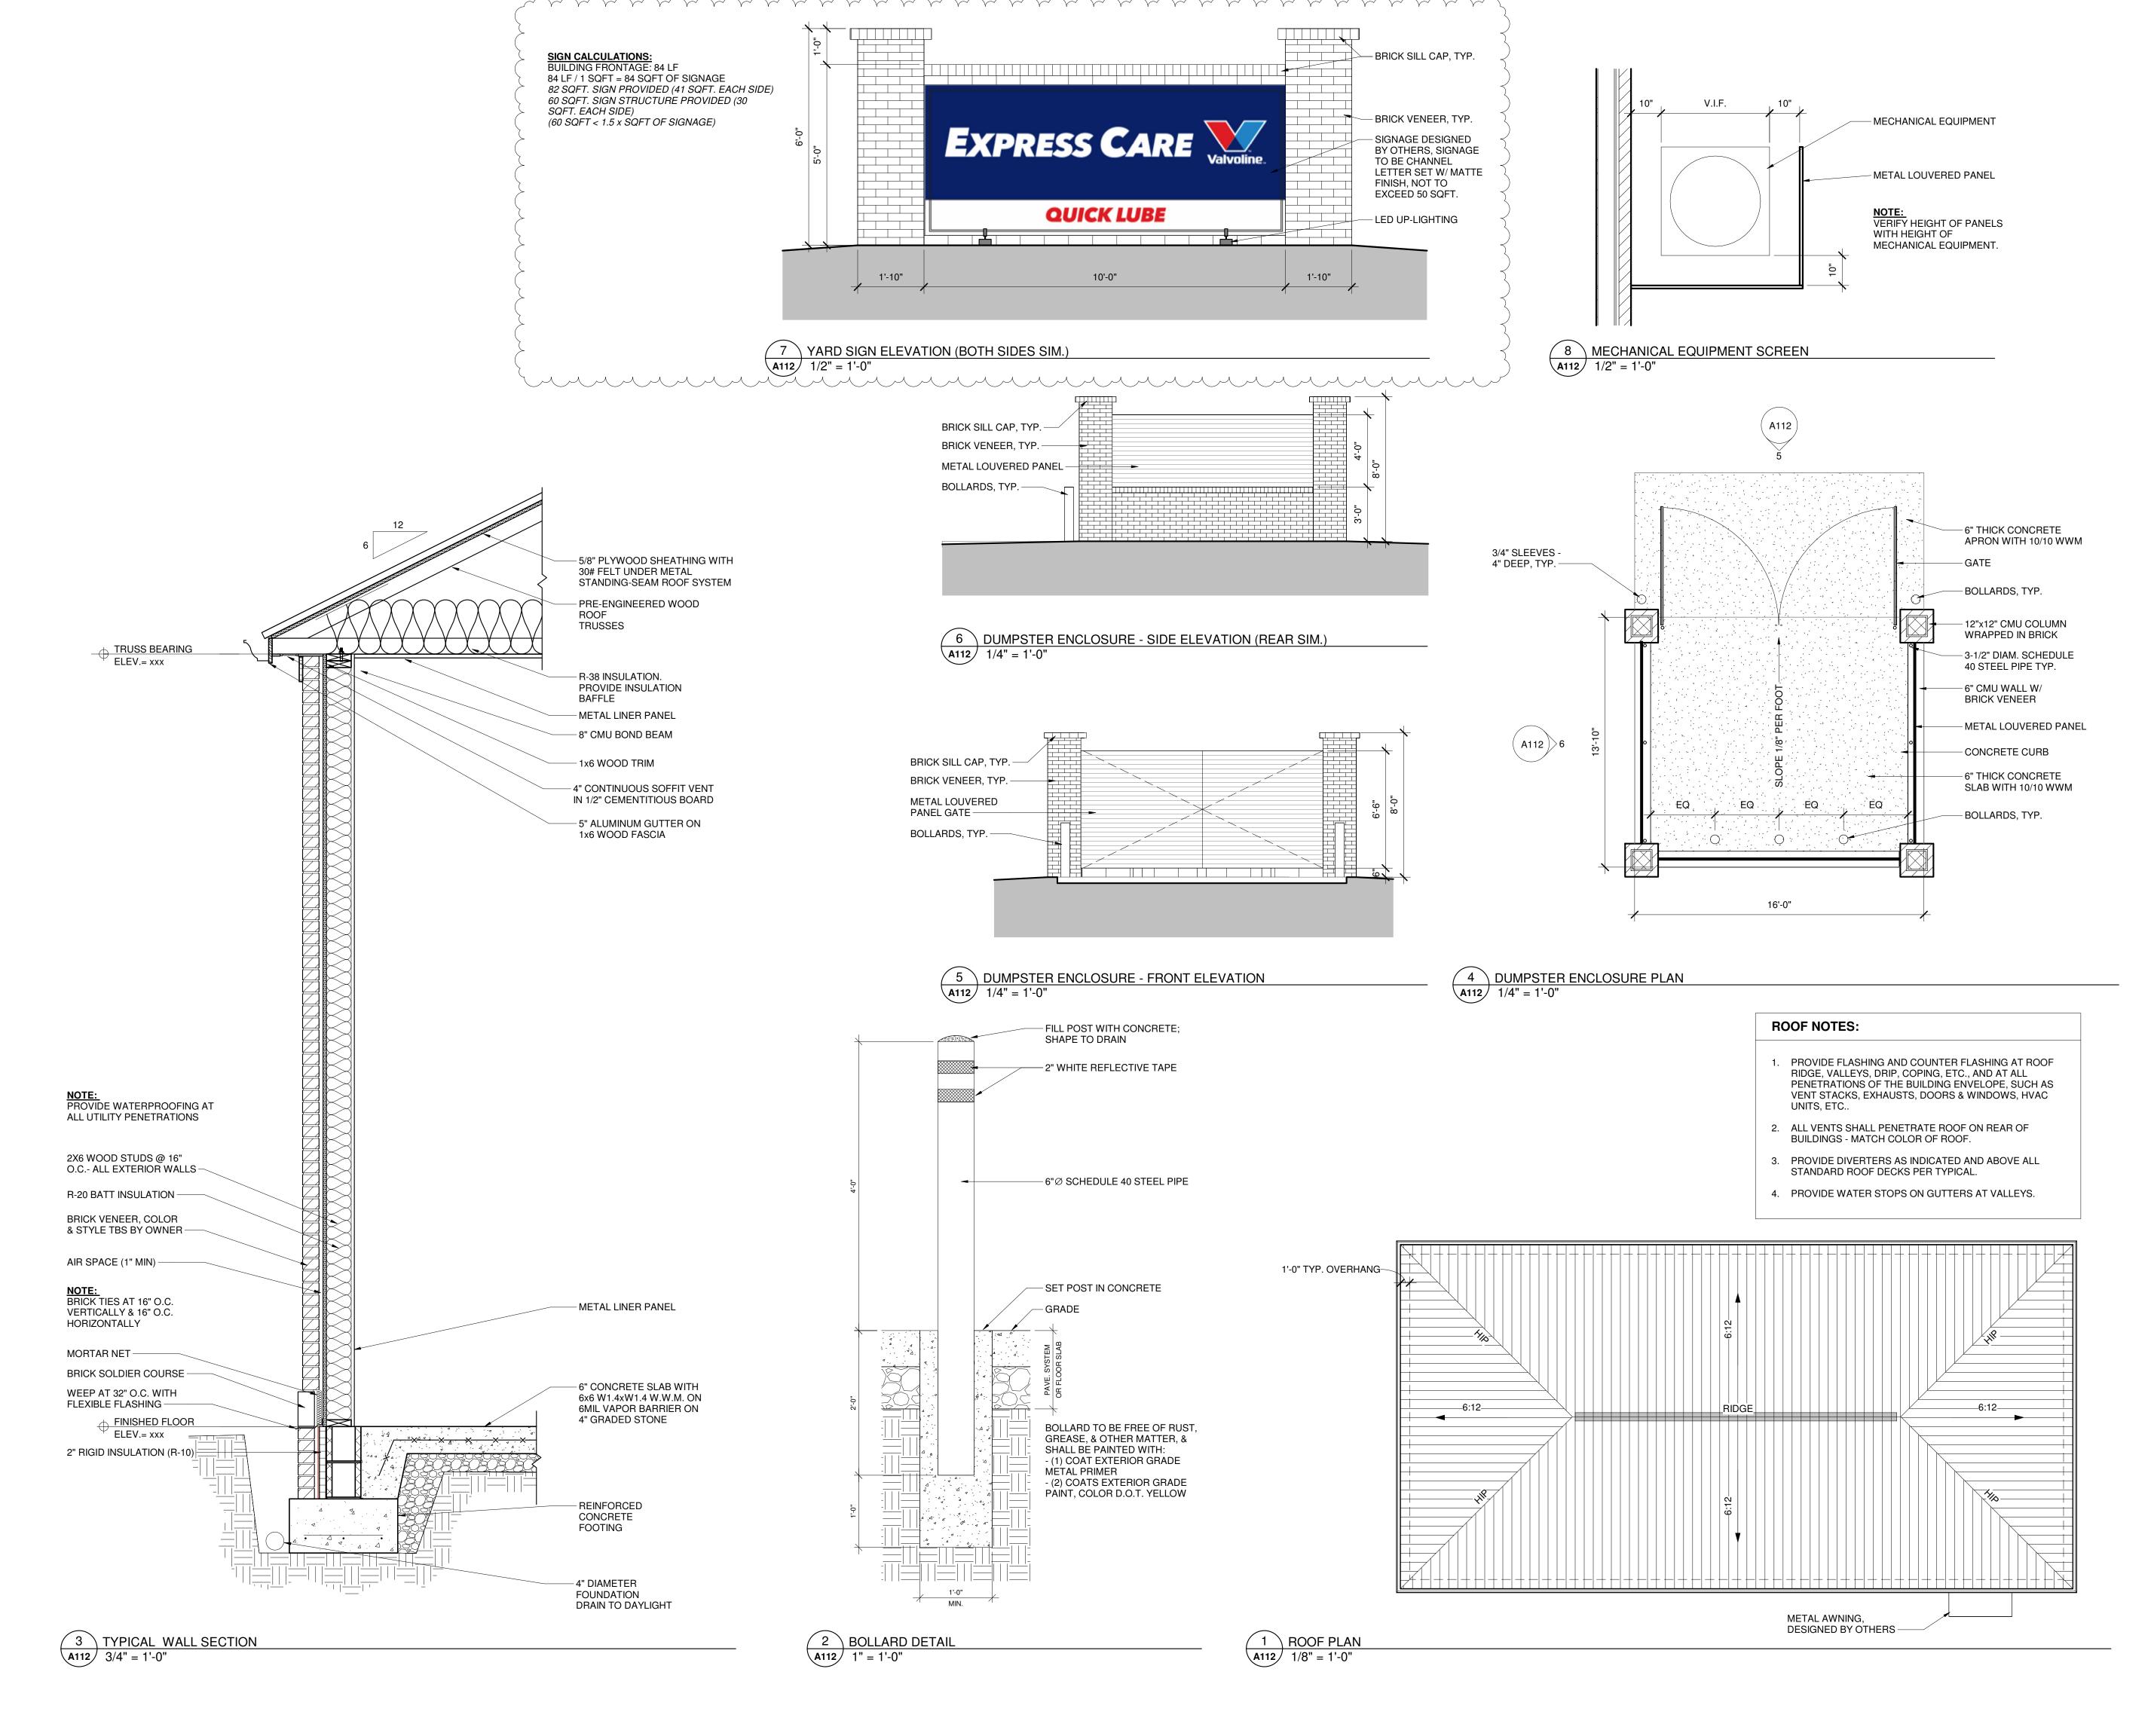

JAD (6-B-)

FAST LUBE LOVELL ROAD


Drawn Date Issued For 5/20/2024 PLANNING REV 1

Drawn by: MB
Checked by: SBS


ROOF PLAN & DETAILS

A112

DATE: 04/03/2024
PROJECT: 23180
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SE LOVELL ROAD
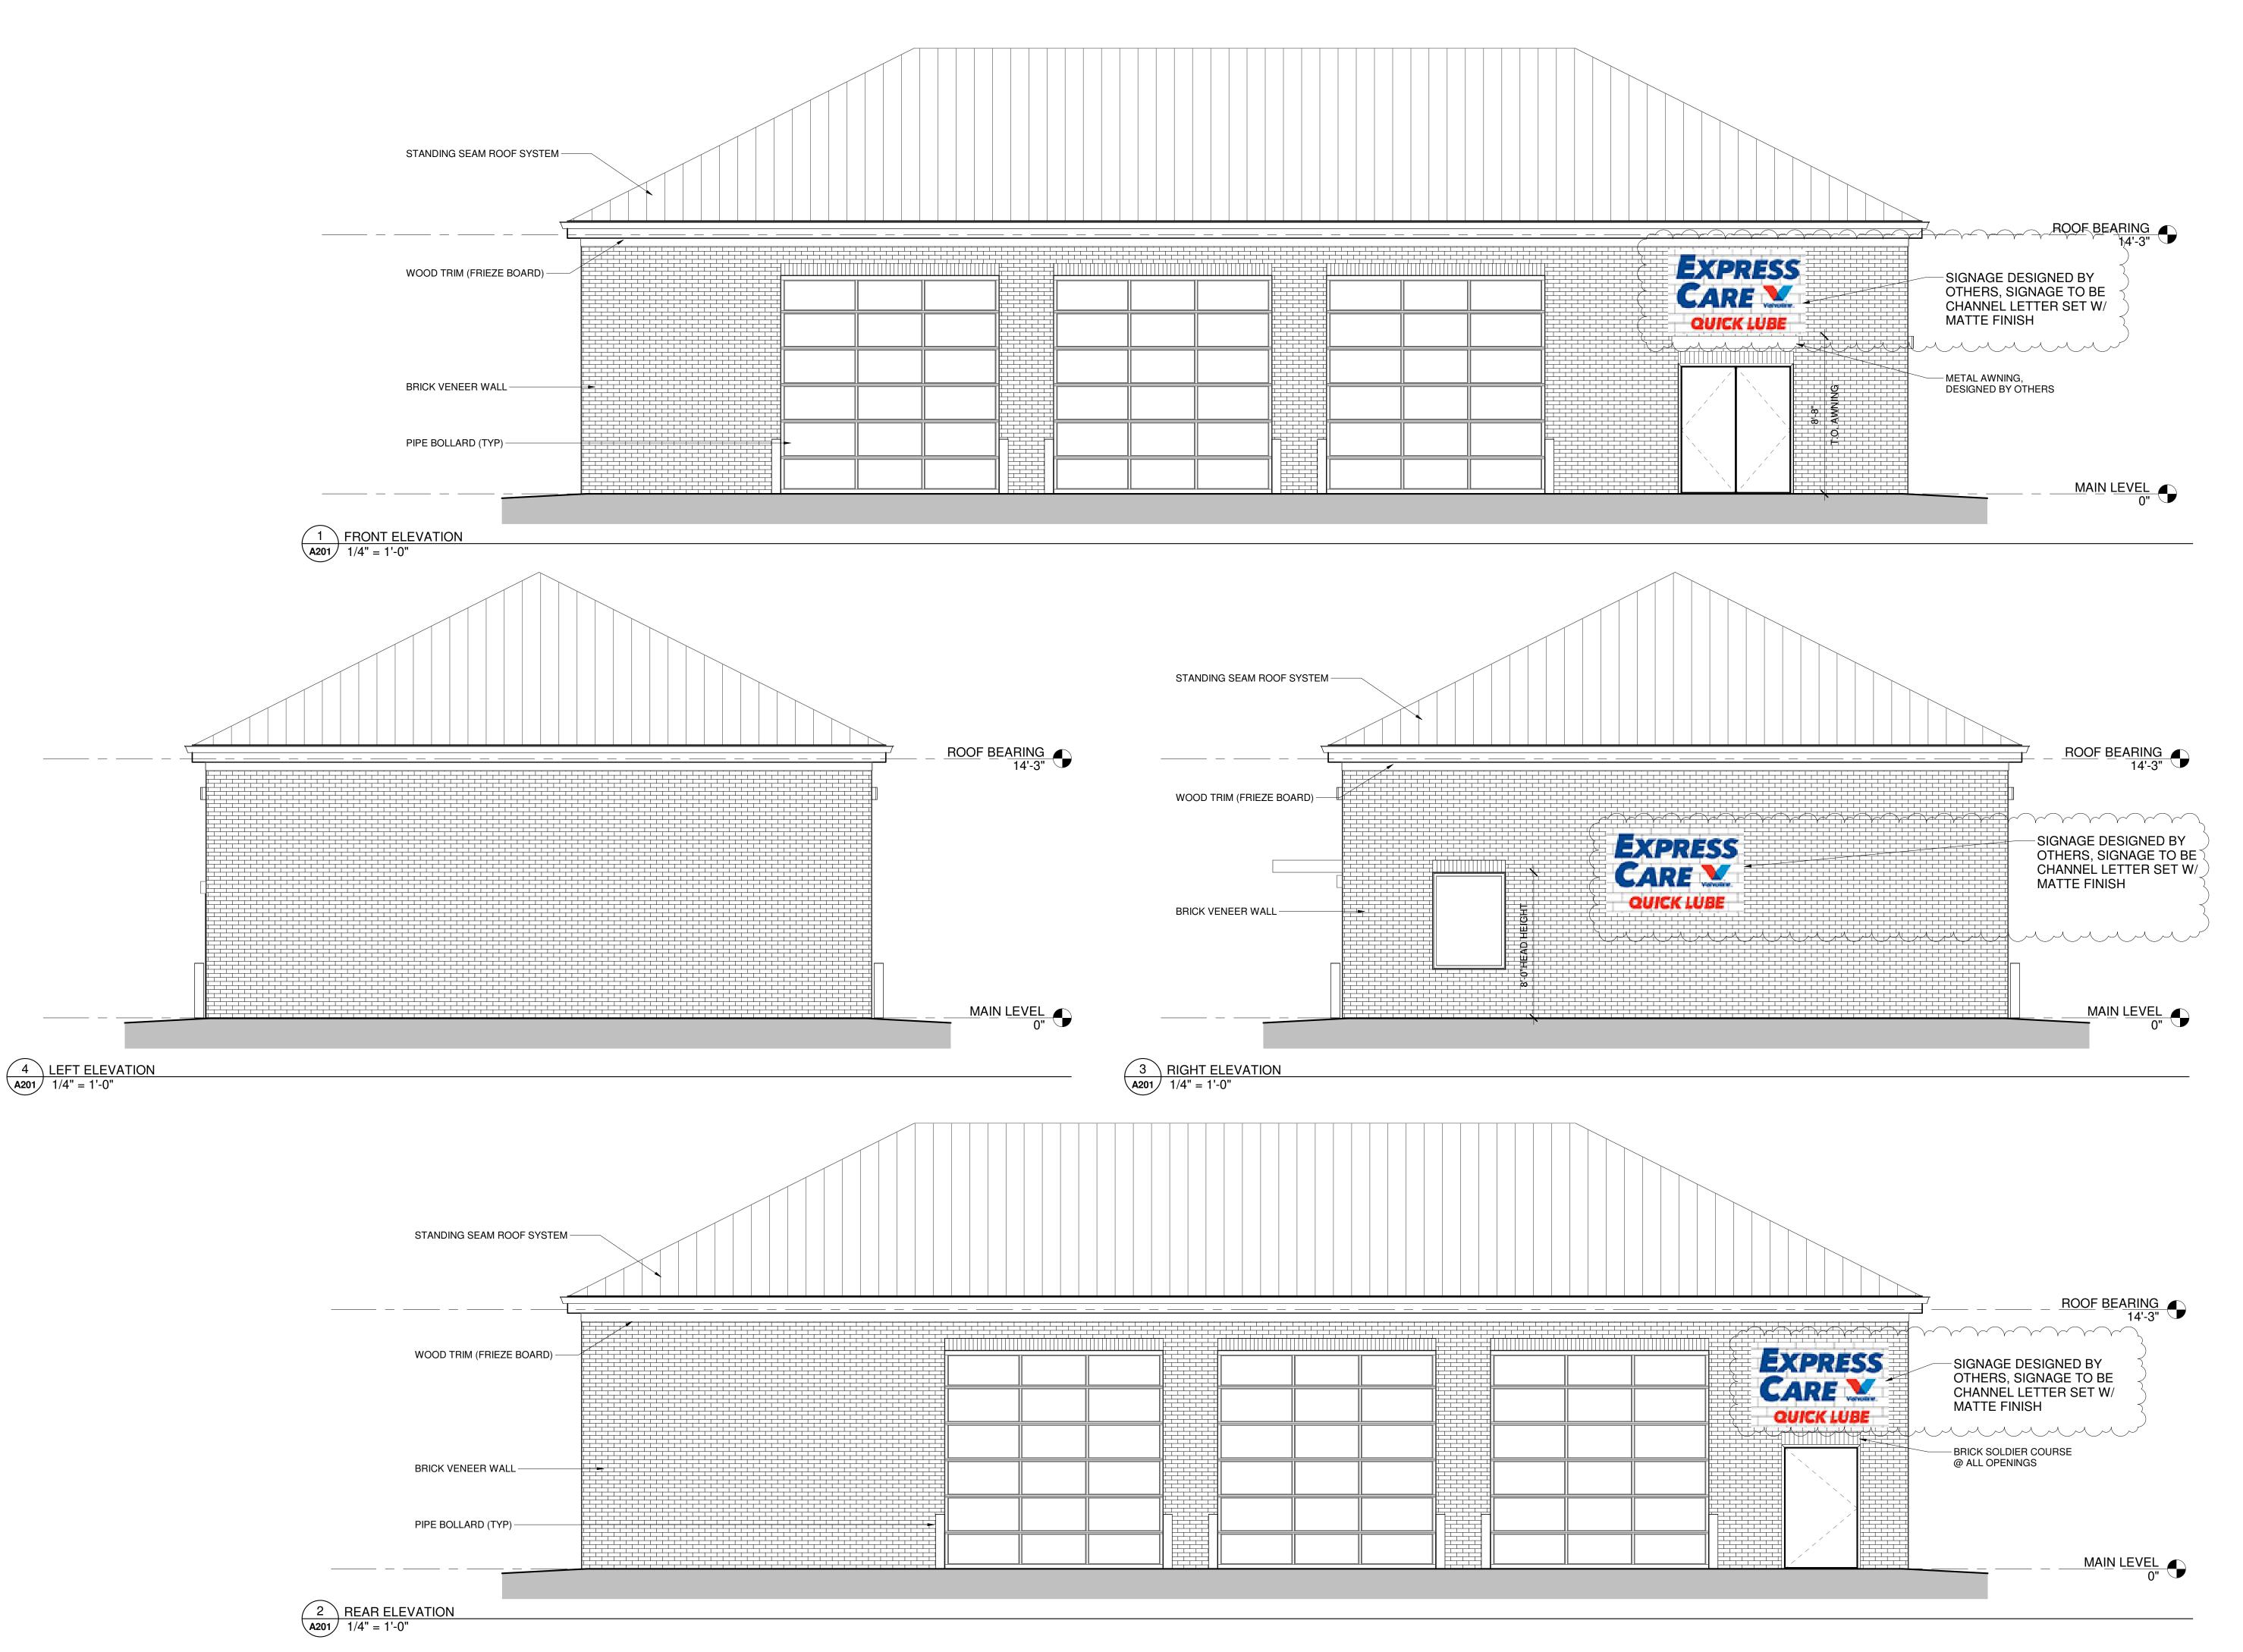
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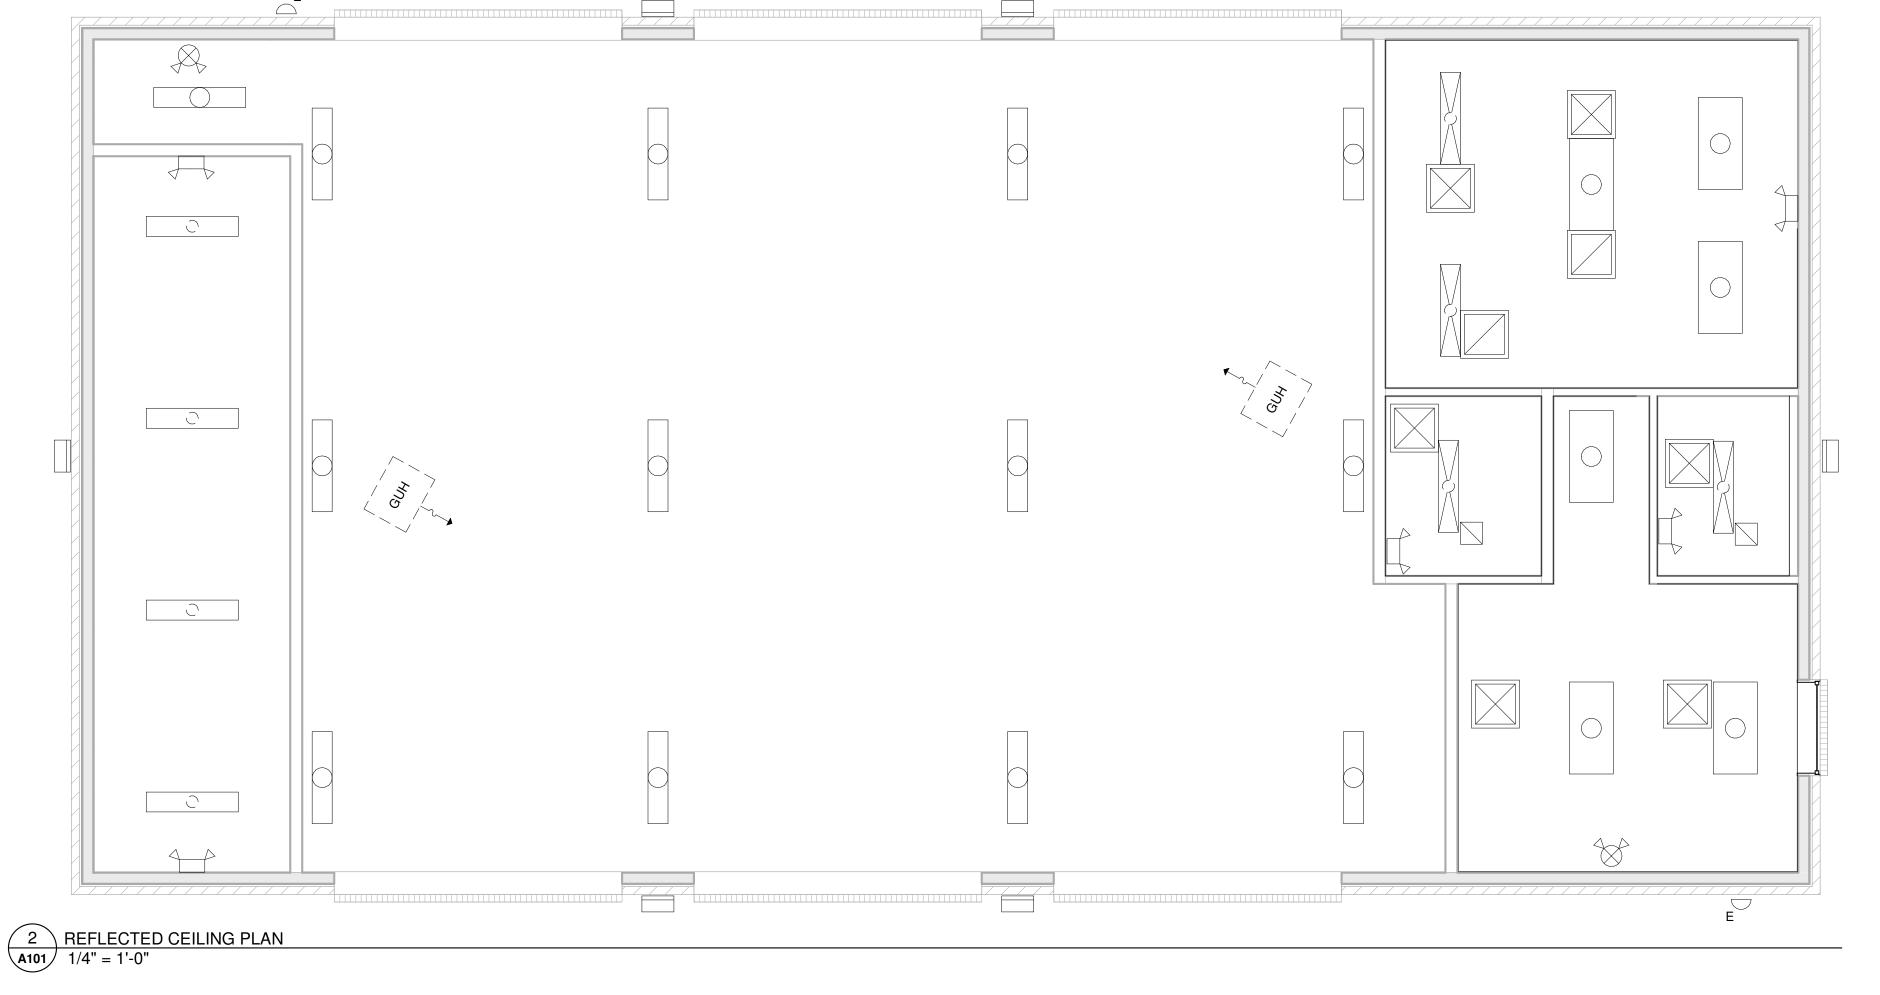
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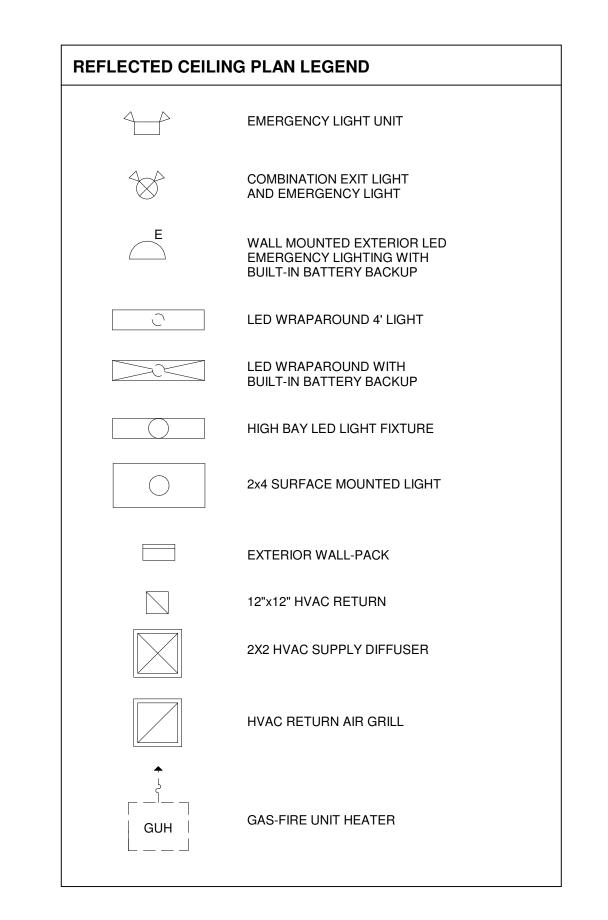
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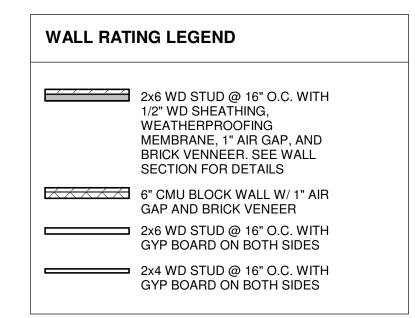
EXTERIOR ELEVATIONS

A201

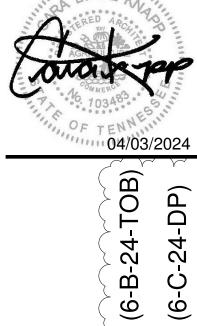DATE: 04/03/2024
PROJECT: 23180
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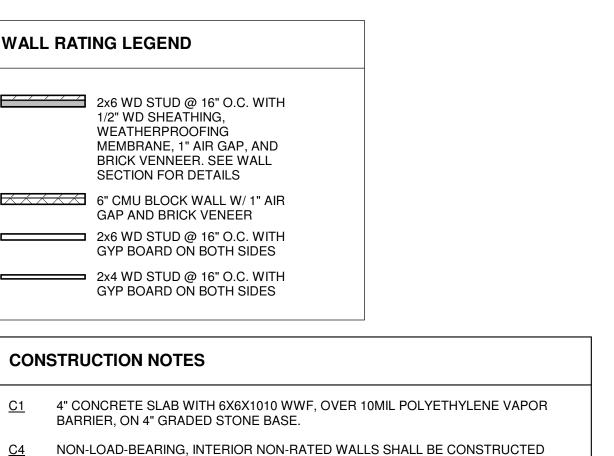
- C1 4" CONCRETE SLAB WITH 6X6X1010 WWF, OVER 10MIL POLYETHYLENE VAPOR
- C4 NON-LOAD-BEARING, INTERIOR NON-RATED WALLS SHALL BE CONSTRUCTED OF 2X4 WOOD STUDS FROM FLOOR TO CEILING @16" O.C., WITH 1/2" GYPSUM
- ALL WOOD IN CONTACT WITH MASONRY OR CONCRETE SHALL BE PRESSURE-
- PROVIDE TERMITE TREATMENT AT CONCRETE SLAB & FOUNDATION.

BOARD ON EACH SIDE. BRACE TO STRUCTURE @6'-0" O.C.

- MISCELLANEOUS STEEL TO BE MINIMUM A36 GRADE.
- CONTRACTOR SHALL PROVIDE WOOD BLOCKING CONCEALED IN WALL FOR ALL
- WALL-HUNG MILLWORK UNITS, DOOR JAMBS, SHELVES, SIGNS, FIXTURES, GRAB BARS, ETC. AS REQUIRED.
- PROVIDE THE FOLLOWING FOR EACH TOILET ROOM (DIMENSIONS GIVEN ARE FOR ACCESSIBLE TOILET ROOMS): TOILET WITH FIXTURE CENTERLINE 18" FROM WALL, & SEAT HEIGHT AT
  - 17-19" AFF URINAL (IF INDICATED) WITH LIP AT 17" MAX. AFF, & FLUSH LEVER AT 48"
  - TOILET PAPER DISPENSER, 24" AFF & 36" FROM BACK WALL LAVATORY AT 34" MAX. TO RIM, 29" MIN. CLEAR BENEATH, 15" MIN. FROM

FIXTURE CENTERLINE TO WALL, & SINGLE LEVER-CONTROLLED FAUCET

- SUPPLY AND DRAIN PROTECTION BELOW SINK (PRE-FORMED INSULATION) MIRROR, WITH BOTTOM OF GLASS AT 40" AFF
- PAPER TOWEL & SOAP DISPENSERS, MOUNTED SO THAT ACTUATOR AND DISPENSE LEVELS ARE AT 48" MAX. HEIGHT.
- C11 IF TOILET ROOM IS DESIGNATED ACCESSIBLE TO THE HANDICAPPED, ADD THE FOLLOWING ELEMENTS TO THOSE SPECIFIED IN NOTE C10: - 24" OR 36" BACK GRAB BAR, & 42" SIDE GRAB BAR, BOTH AT 34" AFF AND LOCATED AS SHOWN IN THE ENLARGED TOILET PLANS; PROVIDE BLOCKING IN WALL AS REQUIRED TO SUPPORT 250 LBS.
  - PROVIDE SIGNAGE TO IDENTIFY TOILET ROOMS, AS PER THE ADA & THE NORTH CAROLINA ACCESSIBILITY CODE: BUILDINGS THAT HAVE MORE THAN (1) TOILET ROOM PER FLOOR SHALL DISPLAY THE INTERNATIONAL SYMBOL FOR ACCESSIBILITY; USE THE WORDS "MEN" OR "WOMEN" WITH THEIR RESPECTIVE MALE/FEMALE SYMBOLS; VISIBLE TEXT SHALL BE ACCOMPANIED BY GRADE 2 BRAILLE; THE IDENTIFYING PLAQUE OR SIGN SHALL BE MOUNTED 60" AFF.
- C12 PROVIDE FLASHING AND COUNTERFLASHING AT ROOF RIDGE, VALLEYS, DRIP, COPING, ETC., AND AT ALL PENETRATIONS OF THE BUILDING ENVELOPE, SUCH AS VENT STACKS, EXHAUSTS, DOORS & WINDOWS, HVAC UNITS, ETC.
  - PROVIDE FIRE EXTINGUISHERS (5 LB. 2A10BC) AS INDICATED ON PLANS; INSTALL MOUNTS SO AS TO PLACE EXTINGUISHER HANDLE/CONTROL POINTS AT 48"



04/03/2024

(6-B-24-TOB)

Drawn by: MB Checked by: SBS

FLOOR PLAN & RCP

A101

DATE: 04/03/2024 PROJECT: 23180 © COPYRIGHT 2024

