
### Zambezi Realty, LLC

# HOME TO DUPLEX RENOVATION

5405 Central Ave Pike Knoxville, TN 37912

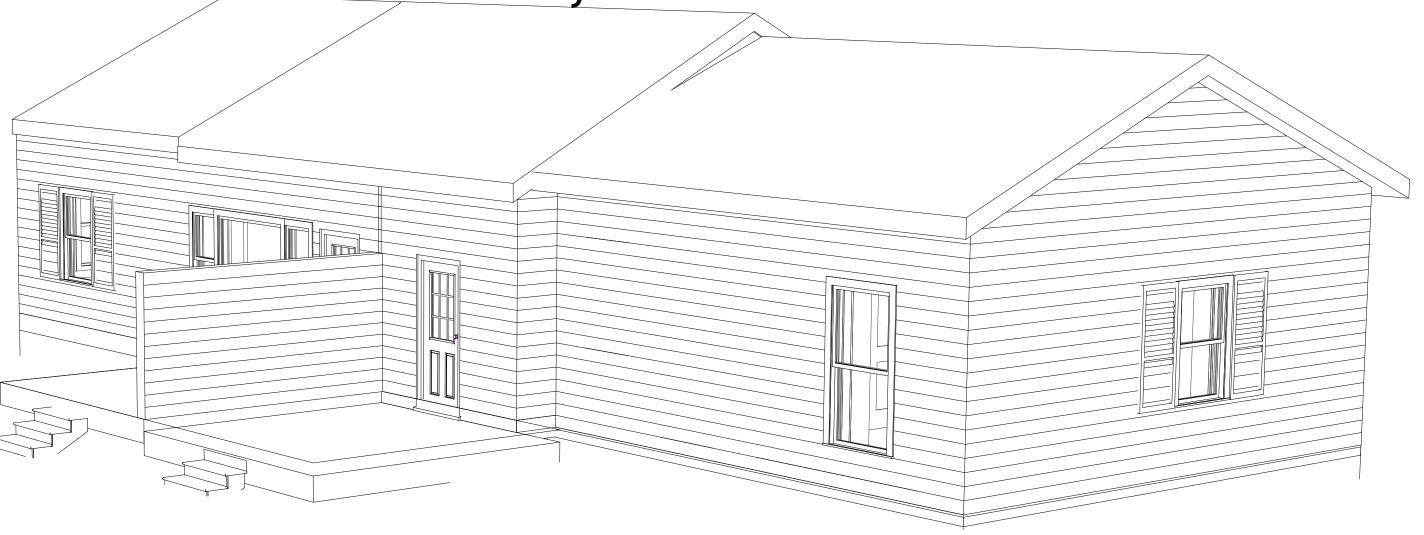

#### SCOPE OF WORK & BUILDING SIZE:

EXISTING 1,500SF SINGLE FAMILY RESIDENTIAL HOME TO BE REMODELED & RENOVATED TO A DUPLEX W/ UPGRADED FINISHES. EXISTING FOUNDATION, EXTERIOR WALLS, & ROOF STRUCTURE TO REMAIN. 1-HR FIRE RATED WALL TO BE INSTALLED

#### **ZONING & REQUIREMENTS**

PARCEL ID: 068FC055

CLT MAP: 68 INSERT: F GROUP: C
PARCEL: 55 WARD: 39 CITY BLOCK: 39630
PLANNING SECTOR: NORTH CITY
ZONING: RN-1

### CLIMATIC & GEOGRAPHIC DESIGN CRITERIA

CLIMATE ZONE = 4
WIND SPEED 90 MPH
SEISMIC DESIGN CATEGORY - C
WEATHERING - SEVERE
FROST LINE - 12 INCHES
TERMITE - MODERATE TO HEAVY

### APPLICABLE CODES


2018 IRC - INTERNATIONAL RESIDENTIAL CODE

### DIMENSIONAL STANDARDS & SETBACKS


SEIBACKS					
	ZONE REQD	PROVIDED			
MIN LOT SIZE	15,000sf	16,623sf ETR			
MIN LOT WIDTH	75ft	118ft ETR			
MAX BLDG HT	35ft	16ft ETR			
MAX BLDG COVERAGE	30%	12.25%			
MIN FRONT SETBACK	25ft	57'-5" ETR			
MIN INT SIDE SETBACK	8ft	13'-9" ETR			
MIN CORNER SIDE STBK	15ft	41'-3" ETR			
MIN REAR SETBACK	25ft	15'-10" ETR			

	SHEET L	<u>.IST</u>		V
NO.	SHEET NAME	ISSUE	CURRENT	
110.	OFFICE TWO WILL	DATE (	REV	REV DATE
01 GENE	RAL		>	
G100	COVER SHEET	05/18/2024	1	5-28-2024
G101	GENERAL NOTES	05/18/2024	1	5-28-2024
02 CIVIL			>	
C100	SITE PLAN	05/18/2024	1	5-28-2024
04 ARCH	ITECTURAL		-	
A100	EXISTING/DEMO FLOOR PLAN	05/18/2024	1	5-28-2024
A101	PROPOSED FLOOR PLAN	05/18/2024	1	5-28-2024
A200	BUILDING ELEVATIONS	05/18/2024	1	5-28-2024
A300	BUILDING SECTIONS	05/18/2024	1	5-28-2024
A301	BUILDING SECTIONS	05/18/2024	1	5-28-2024
A401	WALL SECTION & DETAILS	05/18/2024	1	5-28-2024

#### **LOCATION MAP**

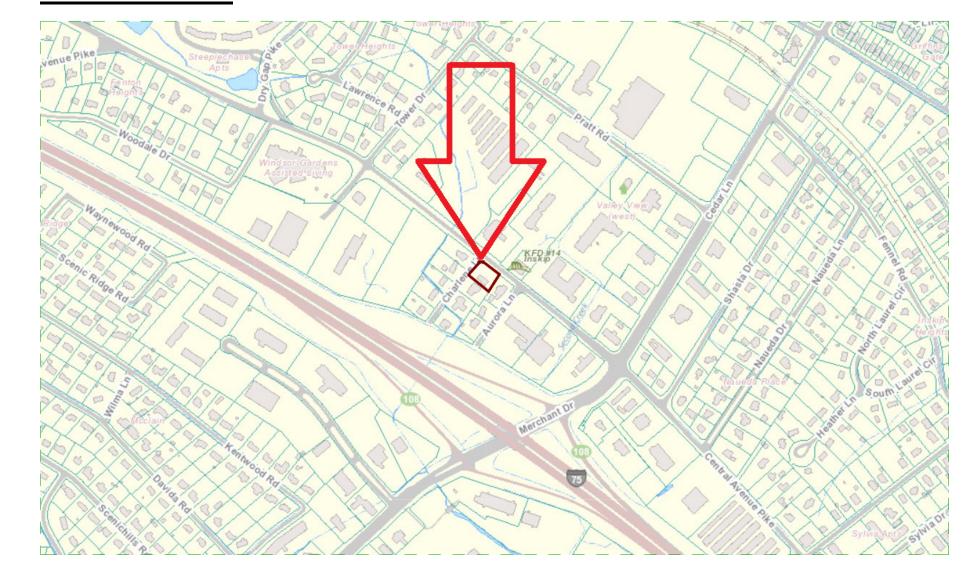




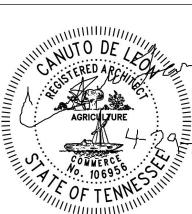

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### COVER SHEET

OOVERTORILLT	
Project number	224016
Date	05.25.2024
Drawn by	EKG
Checked by	CdL

G100

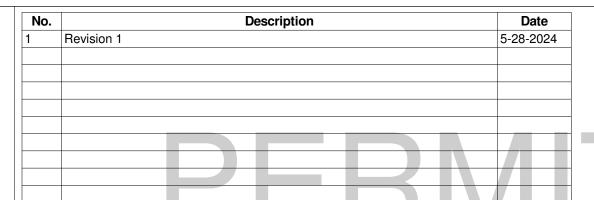Scale

### PERMISEI

°F	
-	DEGREE FAHRENHEIT
#	POUND OR NUMBER
&	AND
@	AT
AFF	ABOVE FINISH FLOOR
ALUM	ALUMINUM
BD	BOARD
CLG	CEILING
CONC	CONCRETE
CONT	CONTINUOUS
CPT	CARPET
DBL	DOUBLE
DIA	DIAMETER
DIM	DIMENSION
DIMS	
	DIMENSIONS
DWG	DRAWING
EA	EACH
EJ	EXPANSION JOINT
ELEC	ELECTRICAL
ELEV	ELEVATION
EQ	EQUAL
EXIST	EXISTING
EXT	EXTERIOR
FIXT	FIXTURE
FLR	FLOOR
GA	GAUGE
GALV	GALVANIZED
GF	GROUND FAULT CIRCUIT INT
GYP BD	GYPSUM BOARD
HVAC	HEAT, VENT & AIR CONDITIONING
INSUL	INSULATED OR INSULATION
INT	INTERIOR
	MAXIMUM
MAX	
MECH	MECHANICAL
MIN	MINIMUM
MMR	MOLD & MOISTURE RESISTANT
MTL	METAL
NO	NUMBER
OC	ON CENTER
PLUMB	PLUMBING
PT	PRESSURE TREATED
PTD	PAINTED
PVC	POLYVINYL CHLORIDE
RCP	REFLECTED CEILING PLAN
REQD	REQUIRED
RM	ROOM
SIM	SIMILAR
SPEC	SPECIFIED OR SPECIFICATION
SSTL	STAINLESS STEEL
STL	STEEL
	<u> </u>
	STRUCTURE OR STRUCTURAL
T&G	TONGUE AND GROOVE
TEL	TELEPHONE
TLT	TOILET
TO	TOP OF
TYP	TYPICAL
	UNLESS NOTED OTHERWISE
UNO	SINEE SINE IED SINE INVIOL
	VERIFY IN FIELD
UNO	

#### **ARCHITECT'S NOTES:**

- 1. SEPARATE LICENSED CONTRACTORS WHO ARE REGISTERED W/ THE CITY OF KNOXVILLE SHALL BE REQD TO PERFORM ELECTRICAL, PLUMBING, AND MECHANICAL WORK. THESE CONTRACTORS WILL NEED TO OBTAIN THEIR OWN PERMITS.
- 2. THE GENERAL CONTRACTOR SHALL VERIFY ALL DIMENSIONS AND SITE CONDITIONS BEFORE COMENCEMENT OF THE WORK.
- 3. THE INTENT OF THESE DRAWINGS IS THAT ALL MATERIAL AND WORKMANSHIP SHALL CONFORM TO BUILDING CODES LISTED ON COVER SHEET AND ALL OTHER APLICABLE CODES GOVERNING WORK INDICATED ON DRAWINGS.
- 4. GC TO VERIFY ALL WALL LOCATIONS, THICKNESS & DIMS W/ BUILDING PLANS PRIOR TO CONSTRUCTION.
- 5. THE GC SHALL COORDINATE THE PLACEMENT OF FOOTINGS, COLUMNS, SLABS, WALLS, SHAFTS, ETC. W/ ALL SUB-CONTRACTORS INVOLVED.
- 6. WALLS ARE REPRESENTED ON FLOOR PLANS AS 4" OR 6" FOR CLARITY & ARE TO BE BUILT W/ 3 1/2" & 5 1/2" STUDS W/ EITHER 1/2" GYP BD OR 1/2" SHEATHING DEPENDING ON LOCATION WITHIN PLAN.
- 7. ROOF STRUCTURE (RIDGE BEAM & RAFTERS) TO BE DESIGNED PER BUILDING SUPPLY RECOMMENDATION.
- 8. THE ARCHITECT HAS MADE EVERY EFFORT TO SET FORTH IN THE CONTRACT DOCUMENTS THE COMPLETE SCOPE OF WORK. THE GENERAL CONTRACTOR IS NEVERTHELESS CAUTIONED THAT MINOR OMISSIONS & DISCREPANCIES IN THE DRAWINGS SHALL NOT EXCUSE THEM FROM PROVIDING A COMPLETED PROJECT TO THE OWNER'S SATISFACTION.
- 9. THE GC SHALL SUPERVISE AND DIRECT THE WORK, USING THEIR BEST SKILL AND ATTENTION. THEY SHALL BE SOLELY RESPONSIBLE FOR ALL CONSTRUCTION MEANS, METHODS, TECHNIQUES, SEQUENCES AND PROCEDURES AND FOR COORDINATING ALL PORTIONS OF THE WORK UNDER THE CONTRACT. THE CONTRACTOR SHALL PROVIDE AT THE PROJECT SITE A FULL SET OF CONSTRUCTION DOCUMENTS ANNOTATED WITH THE LATEST REVISIONS AND CLARIFICATIONS FOR THE USE BY ALL.
- 10. CGP COVERAGE, BONDS, COVENANTS, PLATS, DETENTION, SPAP, WATER QUALITY (FF), FLOODPLAIN DEVELOPMENT PERMIT, DOWNSTREAM STUDY, ETC. MAY BE REQUIRED AS PART OF THE PERMITTING FOR THIS SITE.

#### **MECHANICAL NOTES:**

- 1. THE MECHANICAL CONTRACTOR IS TO VERIFY COMPLICANCE OF ALL HVAC ENERGY REQUIREMENTS LISTED BELOW.
- 2. SUPPLY AND RETURN DUCTS IN ATTICS INSULATED >= R-8 WHERE DUCT IS >=3" IN DIAMETER AND >= R-6 WHERE <3". SUPPLY AND RETURN DUCTS IN OTHER PORTIONS OF THE BUILDING INSULATED >= R-6 FOR DIAMETER >= 3" AND R-4.2 FOR < 3" IN DIAMETER.
- 3. BUILDING CAVITIES ARE NOT USED AS DUCTS OR PLENUMS.
- 4. HVAC PIPING CONVEYING FLUIDS ABOVE 105°F OR CHILLED FLUIDS BELOW 55°F ARE INSULATED TO ≥ R-3.
- 5. PROTECTION OF INSULATION ON HVAC PIPING.
- 6. DUCT TIGHTNESS TEST RESULT OF <=4 CFM/100 FT2 ACROSS THE SYSTEM OR <=3 CFM/100 FT2 WITHOUT AIR HANDLER @ 25 PA. FOR ROUGH-IN TESTS, VERIFICATION MAY NEED TO OCCUR DURING FRAMING INSPECTION.
- 7. DUCTS ARE PRESSURE TESTED TO DETERMINE AIR LEAKAGE WITH EITHER: ROUGH-IN TEST: TOTAL LEAKAGE MEASURED WITH A PRESSURE DIFFERENTIAL OF 0.1 INCH W.G. ACROSS THE SYSTEM INCLUDING THE MANUFACTURER'S AIR HANDLER ENCLOSURE IF INSTALLED AT TIME OF TEST. POSTCONSTRUCTION TEST: TOTAL LEAKAGE MEASURED WITH A PRESSURE DIFFERENTIAL OF 0.1 INCH W.G. ACROSS THE ENTIRE SYSTEM INCLUDING THE MANUFACTURER'S AIR HANDLER ENCLOSURE.
- 8. AIR HANDLER LEAKAGE DESIGNATED BY MANUFACTURER AT <=2% OF DESIGN AIR FLOW.
- 9. PROGRAMMABLE THERMOSTATS INSTALLED FOR CONTROL OF PRIMARY HEATING AND COOLING SYSTEMS AND INITIALLY SET BY MANUFACTURER TO CODE SPECIFICATIONS.
- 10. HEAT PUMP THERMOSTAT INSTALLED ON HEAT PUMPS.
- 11. ALL MECHANICAL VENTILATION SYSTEM FANS NOT PART OF TESTED AND LISTED HVAC EQUIPMENT MEET EFFICACY AND AIR FLOW LIMITS.

#### **2015 ENERGY CODE NOTES:**

- 1. HEATING & COOLING EQUIPMENT IS SIZED PER ACCA MANUAL S BASED ON LOADS CALCULATED PER ACCA MANUAL J OR OTHER METHOD APPROVED BY THE CODE OFFICIAL.
- 2. ALL EXTERIOR DOORS TO HAVE A MIN U-FACTOR OF .22
- 3. WINDOWS TO HAVE A MIN U-FACTOR OF .22 AND SHGC OF .25
- 4. U-FACTORS OF FENESTRATION PRODUCTS ARE DETERMINED IN ACCORDANCE W/ THE NFRC TEST PROCEDURE OR TAKEN FROM THE DEFAULT TABLE.
- 5. AIR BARRIER AND THERMAL BARRIER INSTALLED PER MFR INSTRUCTIONS.
- 6. FENESTRATIONS NOT SITE BUILT ARE LISTED AS MEETING AAMA /WDMA/CSA 101/I.S.2/A440 OR OR HAVE INFILTRATION RATES PER NFRC 400 THAT DO NOT EXCEED CODE LIMITS.
- 7. HOT WATER PIPES ARE INSULATED TO ≥ R-3.
- 8. AUTOMATIC OR GRAVITY DAMPERS ARE INSTALLED ON ALL OUTDOOR AIR INTAKES AND EXHAUST.
- 9. ALL INSTALLED INSULATION SHALL BE LABELED OR THE INSTALLED R-VALUES ARE PROVIDED.
- 10. WALL INSULATION IS INSTALLED PER MANUFACTURER'S INSTRUCTIONS
- 11. CEILING INSULATION INSTALLED PER MANUFACTURER'S INSTRUCTIONS. BLOWN INSULATION MARKED EVERY 300 FT<sup>2</sup>
- 12. VENTED ATTICS WITH AIR PERMEABLE INSULATION INCLUDE BAFFLE ADJACENT TO SOFFIT AND EAVE VENTS THAT EXTENDS OVER INSULATION.
- 13. ATTIC ACCESS HATCH AND DOOR INSULATION ≥R-VALUE OF THE ADJACENT ASSEMBLY.
- 14. BLOWER DOOR TEST @ 50 PA. <=5 ACH IN CLIMATE ZONES 1-2, AND <=3 ACH IN CLIMATE ZONES 3-8.
- 15. HOT WATER BOILERS SUPPLYING HEAT THROUGH ONE- OR TWO-PIPE HEATING SYSTEMS HAVE OUTDOOR SETBACK CONTROL TO LOWER BOILER WATER TEMPERATURE BASED ON OUTDOOR TEMPERATURE.
- 16. COMPLIANCE CERTIFICATE TO BE POSTED.
- 17. MFR MANUALS FOR MECHANICAL AND WATER HEATING SYSTEMS SHALL BE PROVIDED.

#### **ELECTRICAL NOTES:**

- IC-RATED RECESSED LIGHTING FIXTURES SEALED @
   HOUSING/INTERIOR FINISH AND LABELED TO INDICATE ≤ 2.0 CFM
- 2. 75% OF LAMPS IN PERMANENT FIXTURES OR 75% OF PERMANENT FIXTURES HAVE HIGH EFFICACY LAMPS. DOES NOT APPLY TO LOW-VOLTAGE LIGHTING.
- 3. FUEL GAS LIGHTING SYSTEMS HAVE NO CONTINUOUS PILOT LIGHT.


#### **PLUMBING NOTES:**

- 1. THE PLUMBING CONTRACTOR IS TO VERIFY COMPLIANCE OF ALL APPLICABLE BUILDING CODES AND LOCAL CODES.
- 2. HOT WATER PIPES SHALL BE INSULATED TO ≥ R-3.

#### **SYMBOLS LEGEND:**

CALLOUT HEAD

**ELEVATION TAG** 

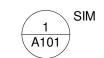


DOOR TAG



101

ELEVATION CALLOUT

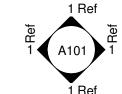


NORTH ARROW




**ROOM TAG** 

101 150 SF

SECTION CALLOUT

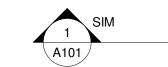

VIEW TITLE/ CALLOUT /

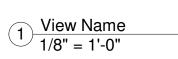

WINDOW TAG

SCALE



Zambezi Realty, LLC HOME TO DUPLEX RENOVATION 5405 Central Ave Pike Knoxville, TN 37912

**GENERAL NOTES** 

Project number 224016


Date 05.25.2024


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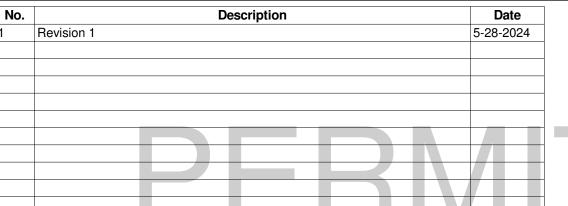
Checked by Checker

G101
| Scale | 1/4" = 1'-0"






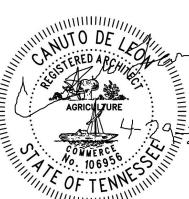

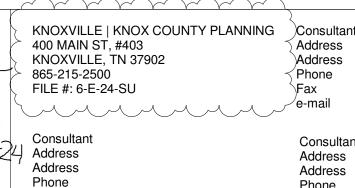






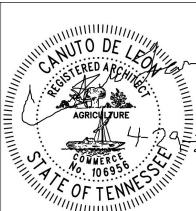

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Fax Consultant Address

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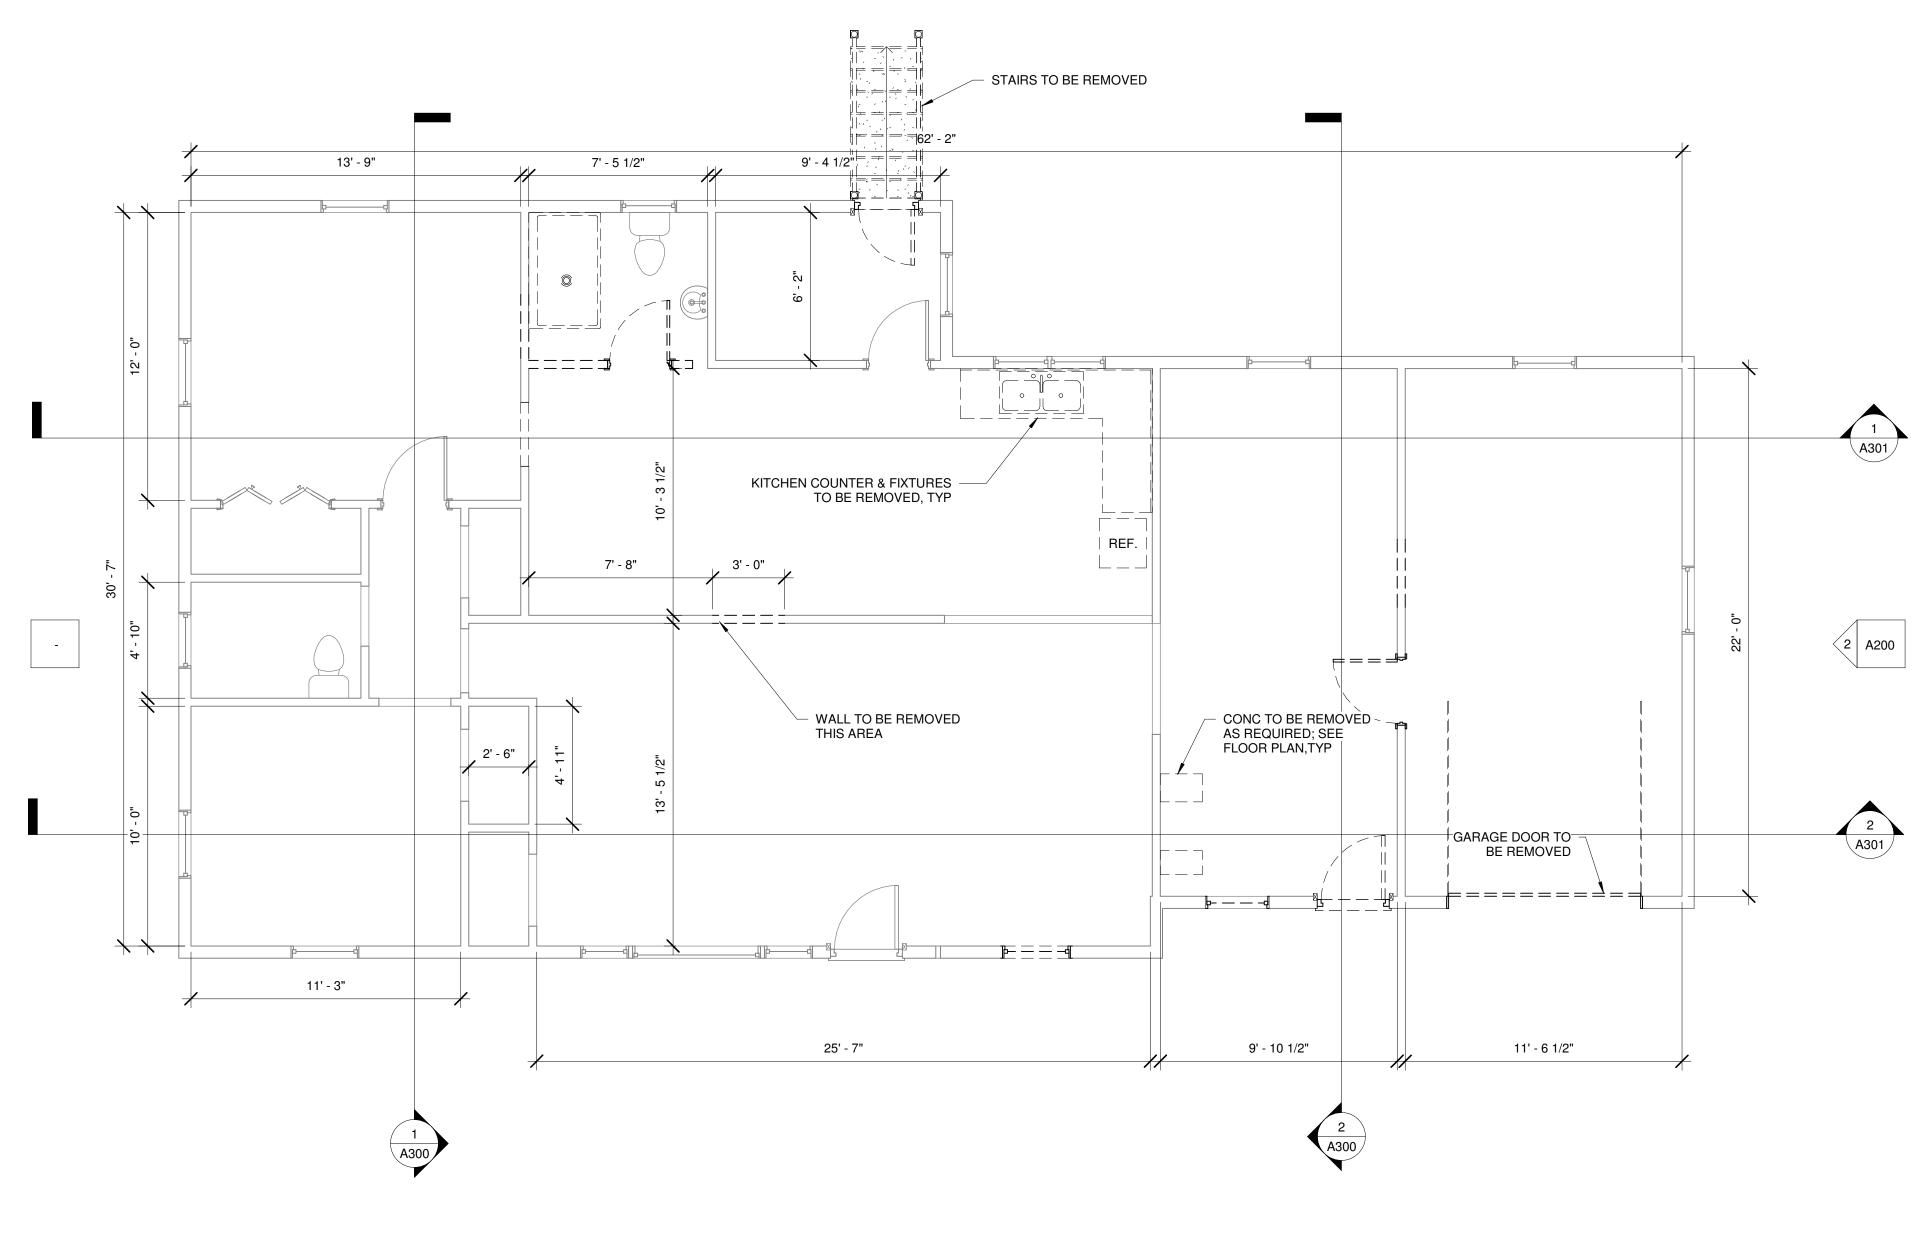


Zambezi Realty, LLC HOME TO DUPLEX RENOVATION 5405 Central Ave Pike Knoxville, TN 37912
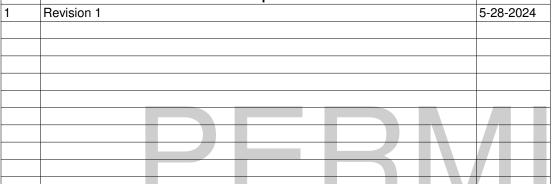
### SITE PLAN

· · · · · · · · · · · · · · · · · · ·	
Project number	224016
Date	05.25.2024
Drawn by	EKG
Checked by	Cdl


1" = 30'-0"






1 MAIN LEVEL FLOOR PLAN 1/4" = 1'-0"



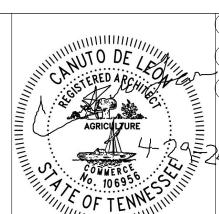

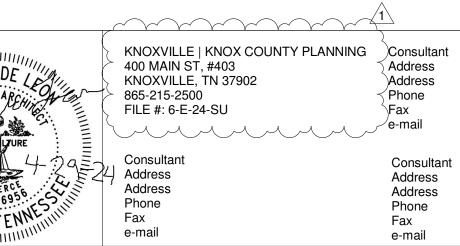


No.	Description			Date		
1	Revision 1				5-28-2	2024
					77	
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L/IOTING/DLIVIO	
Project number	224016
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Drawn by	EKG
Checked by	CdL

A100

Scale 1/4" = 1'-0"




		ROOM SCHEDULE	
Number	Name	Area	Comments
100	A-LIVING ROOM	233 SF	
101	A-COAT	12 SF	
102	A-BED CLO	12 SF	
103	A-HALL	30 SF	
104	A-BEDROOM	113 SF	
105	A-BATH	34 SF	
106	A-M CLO	19 SF	
107	A-MASTER BEDROOM	165 SF	
108	A-M BATH	58 SF	
109	A-KITCHEN/DINING	115 SF	
110	A-UTILITY	10 SF	
111	B-BEDROOM-2	115 SF	
112	B-CLO-1	9 SF	
113	B-CLO	14 SF	
114	A-FRONT DECK	138 SF	
115	B-FRONT DECK	143 SF	
150	B-HALL	60 SF	
151	B-DINING	116 SF	
152	B-KITCHEN	135 SF	
153	B-BATH-2	58 SF	
154	B-BEDROOM-3	69 SF	
155	B-BEDROOM-1	107 SF	
156	B-BATH-1	61 SF	
157	B-CLO-2	15 SF	
Grand total	: 24	1841 SF	

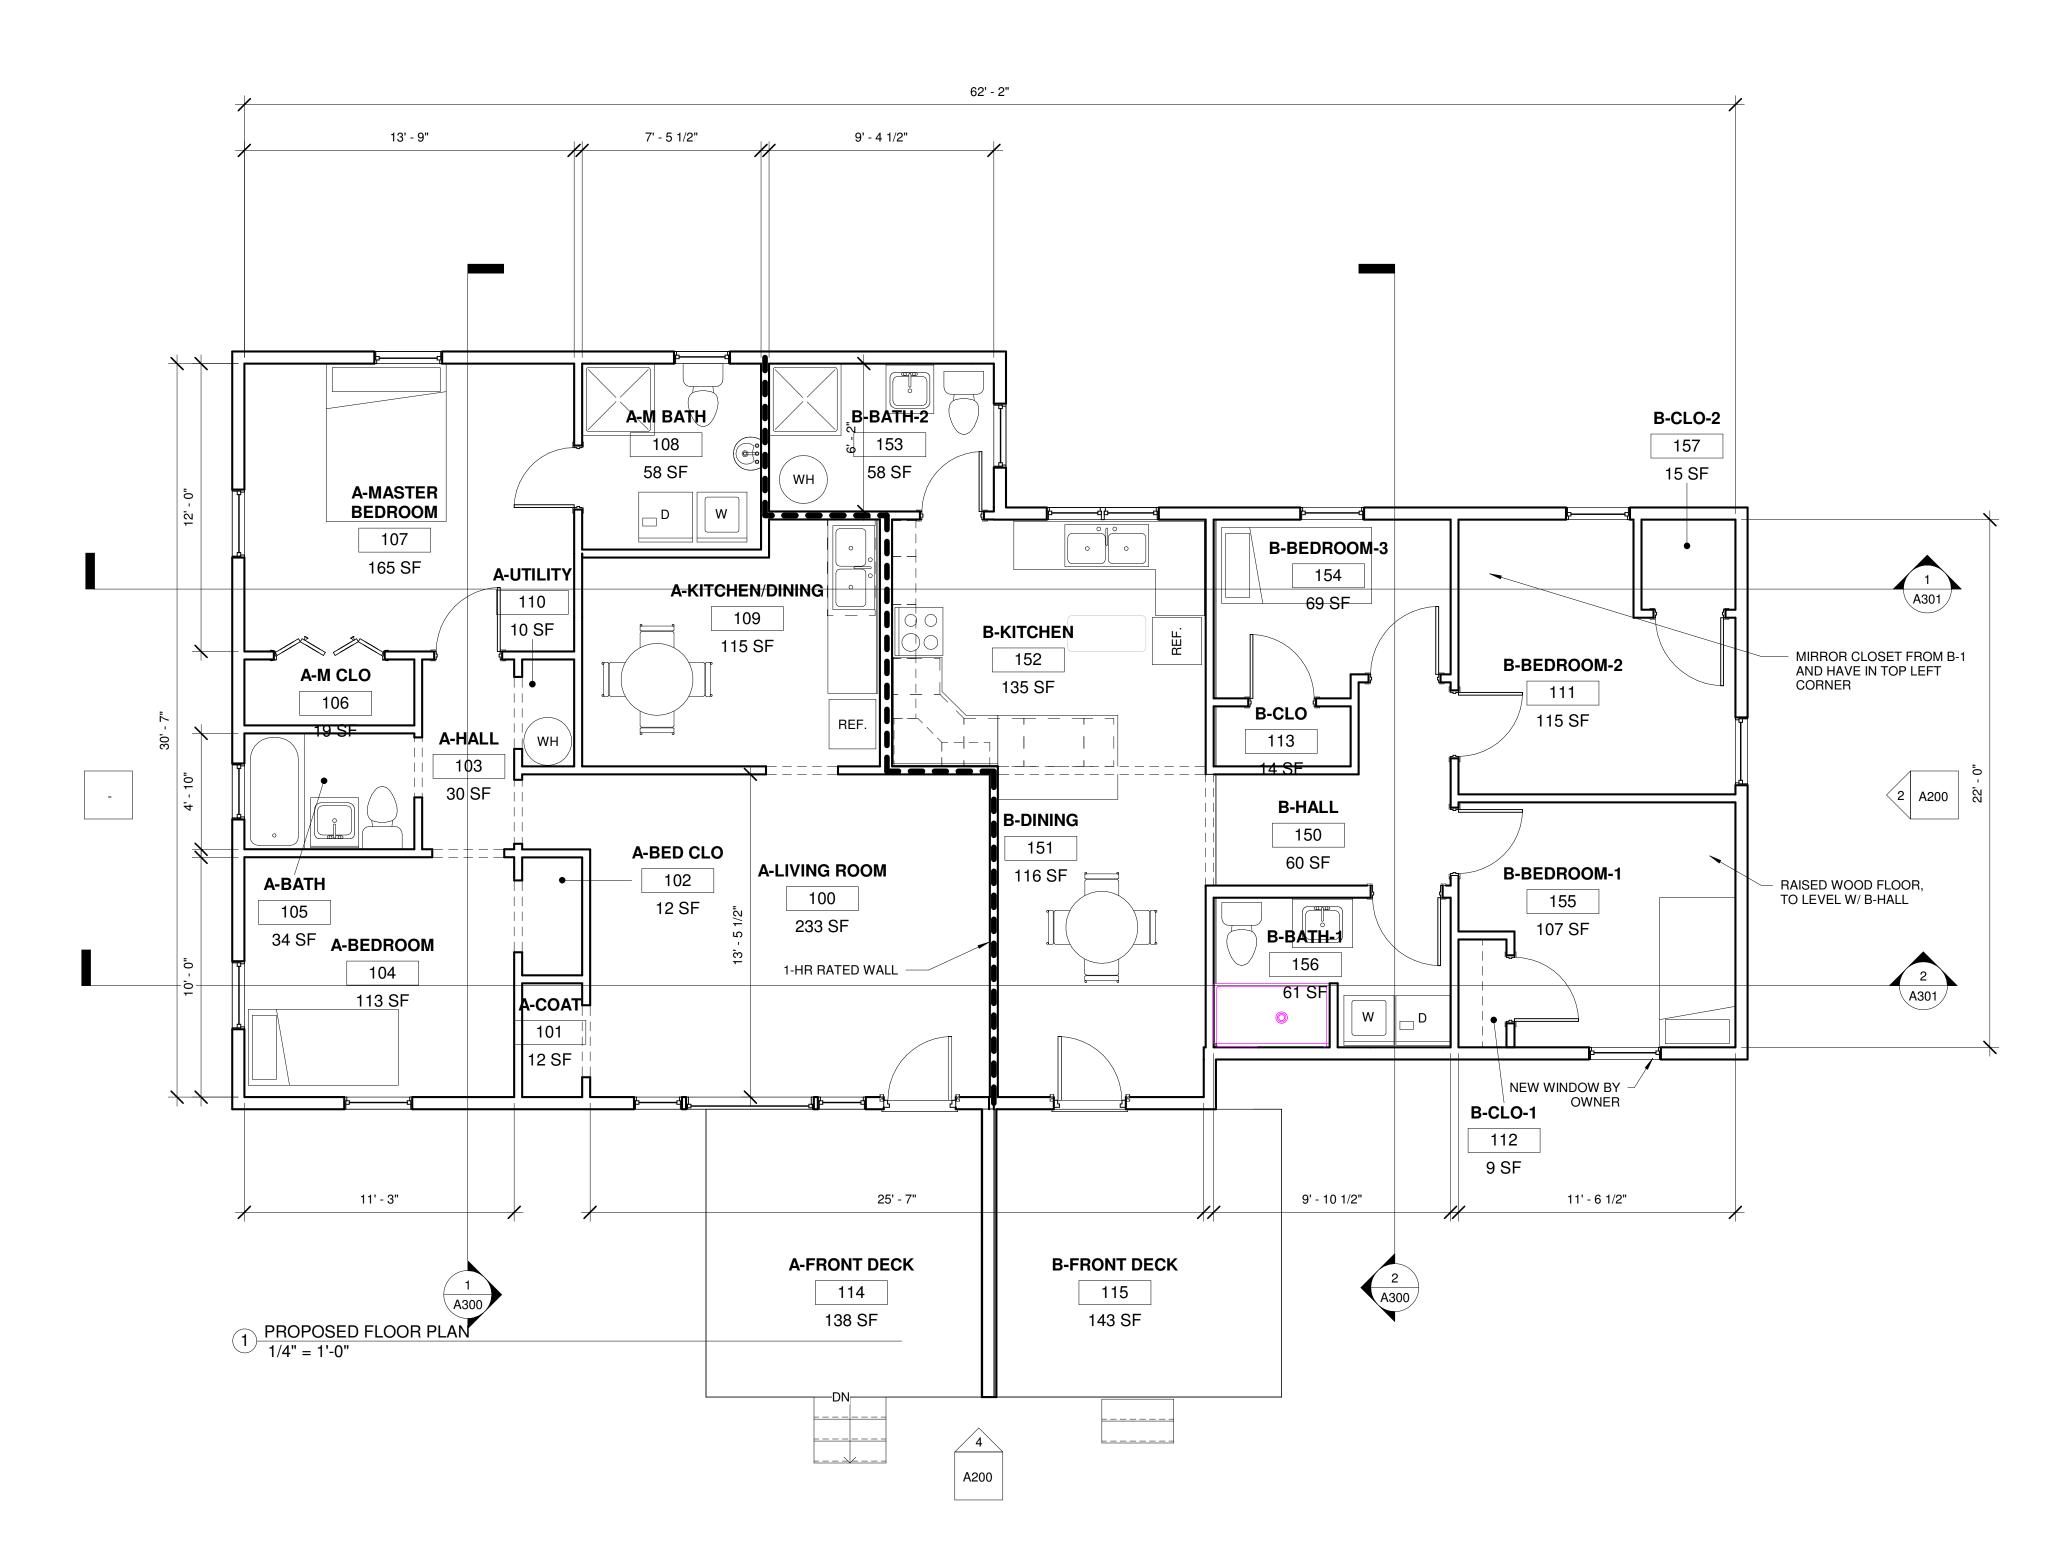
Canuto Architecture + Design

"BUENOS DIAS"

837 Ford St - Alcoa, TN 37701

www.canutodesign.com
865.219.3608

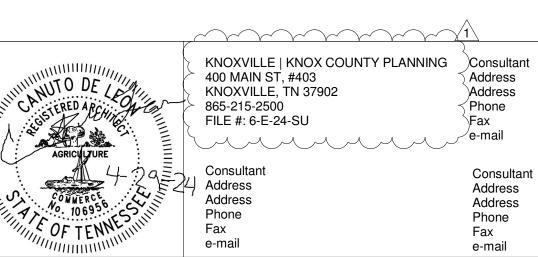

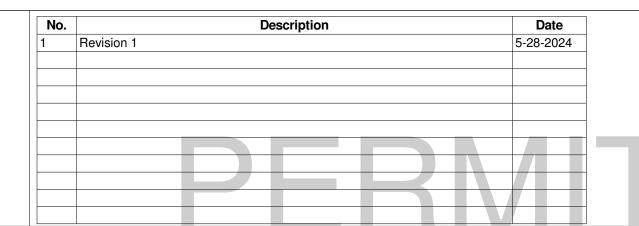


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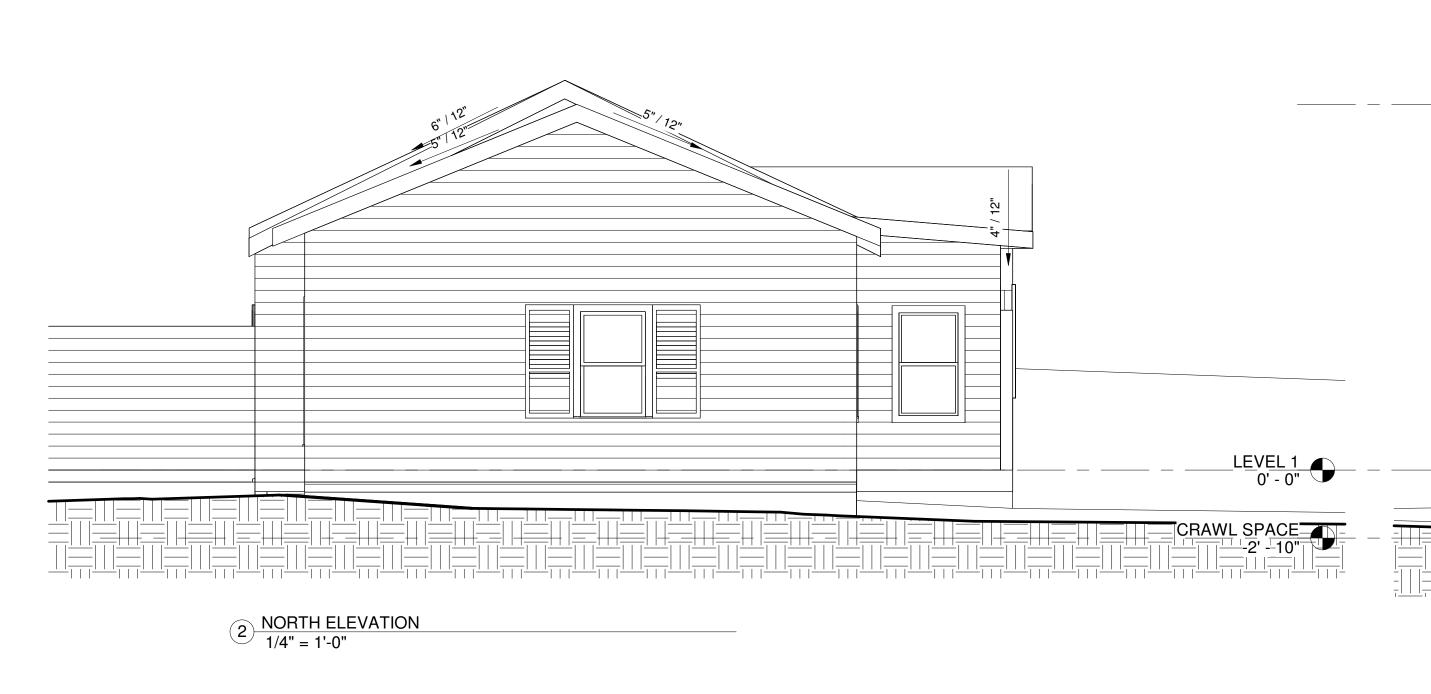
PROPOSED FLOOR PLAN			
Project number	224016		
Date	05.25.2024		
Drawn by	EKG		
Checked by	CdL		


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Scale 1/4" = 1'-0"






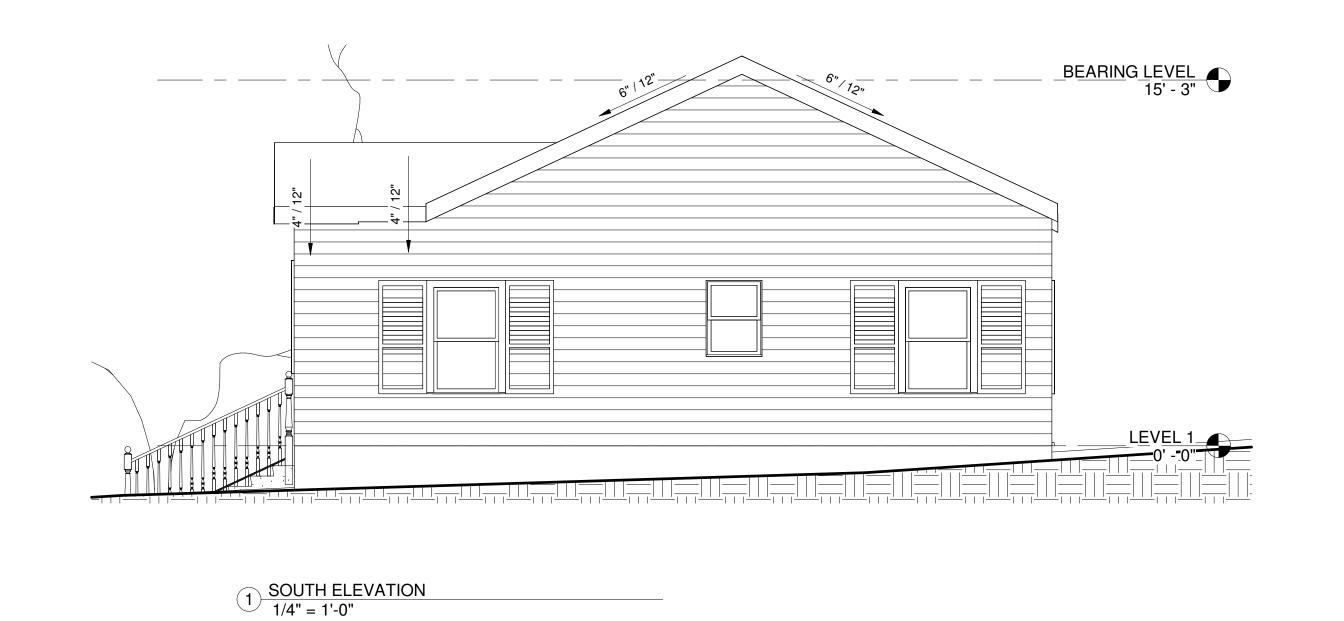

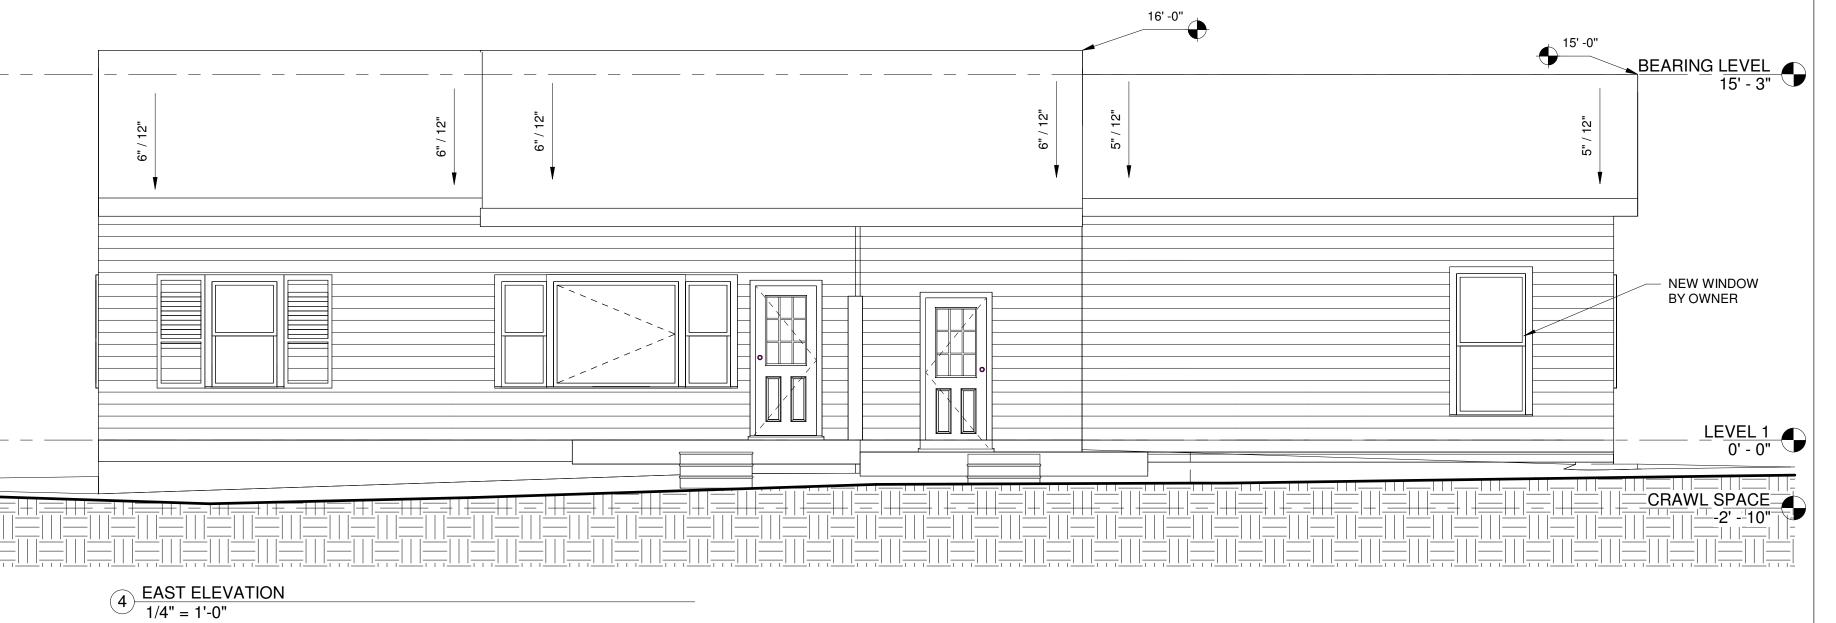


NOTE: EXISTING EXTERIOR FINISHES TO BE RESTORED TO LIKE-NEW CONDITION GC TO UPDATE WINDOWS AS REQUIRED



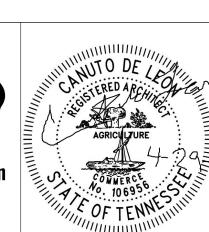

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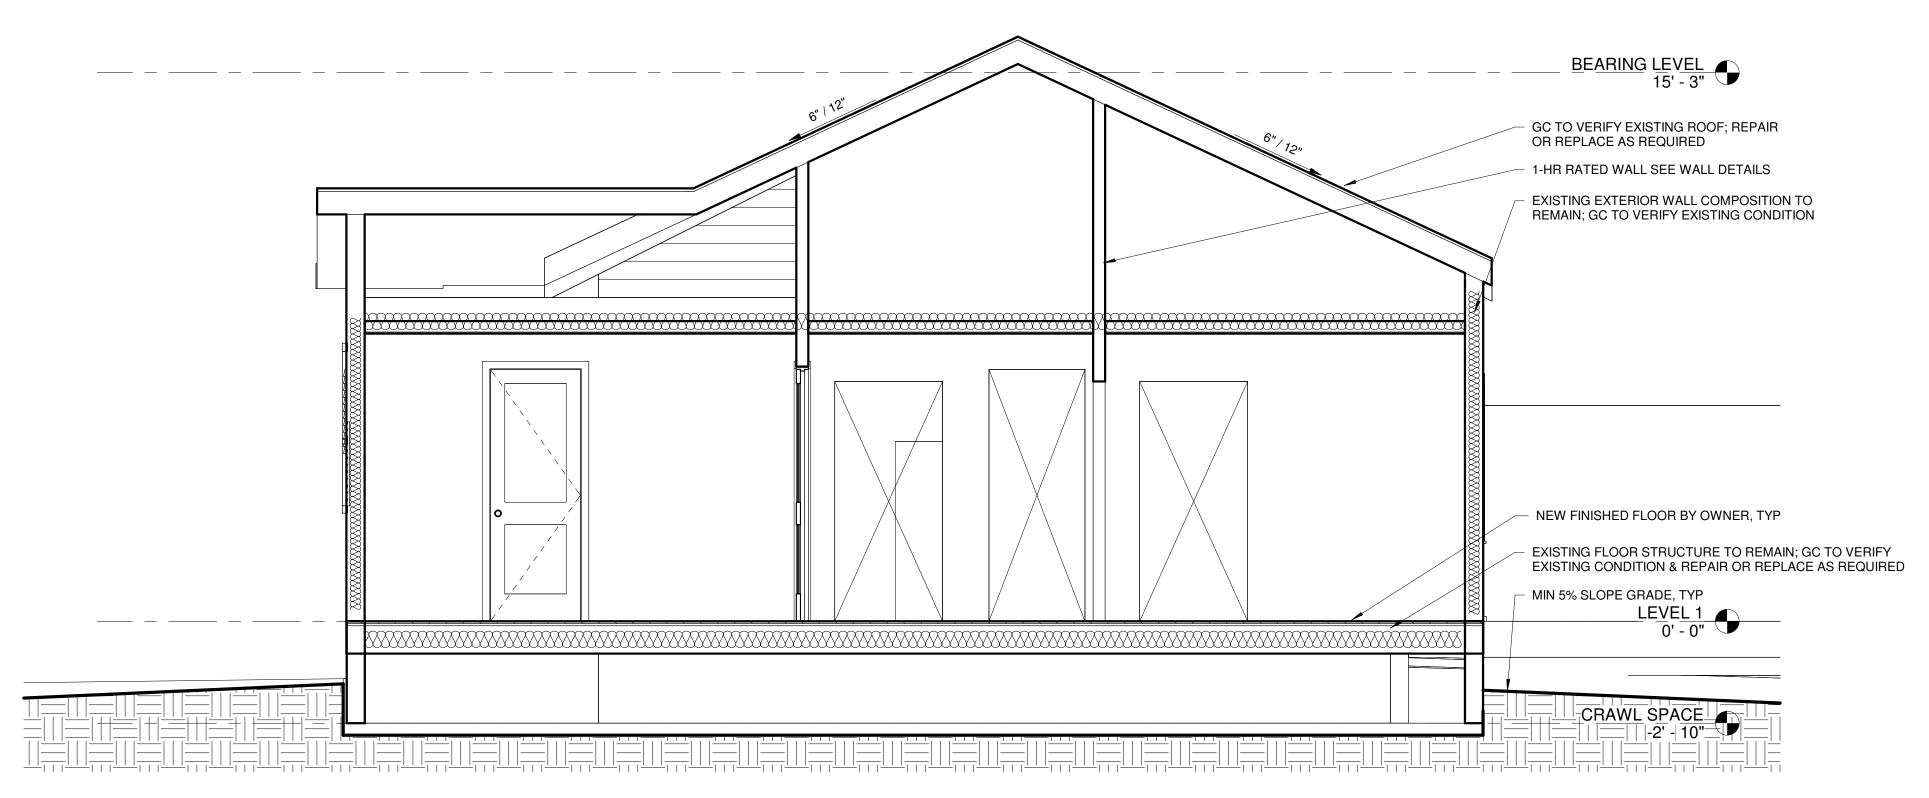
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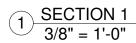
### BUILDING FLEVATIONS


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Project number	224016		
Date	05.25.2024		
Drawn by	EKG		
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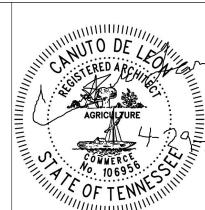
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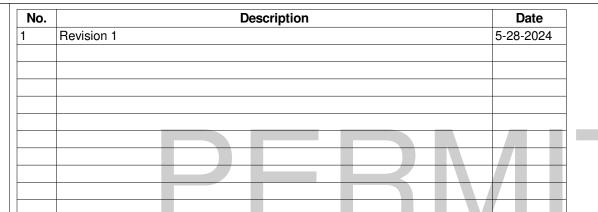


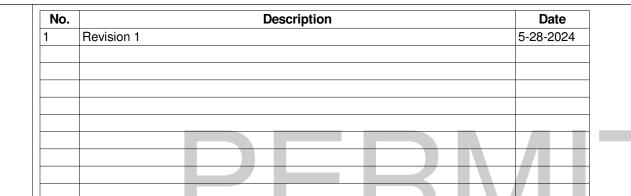



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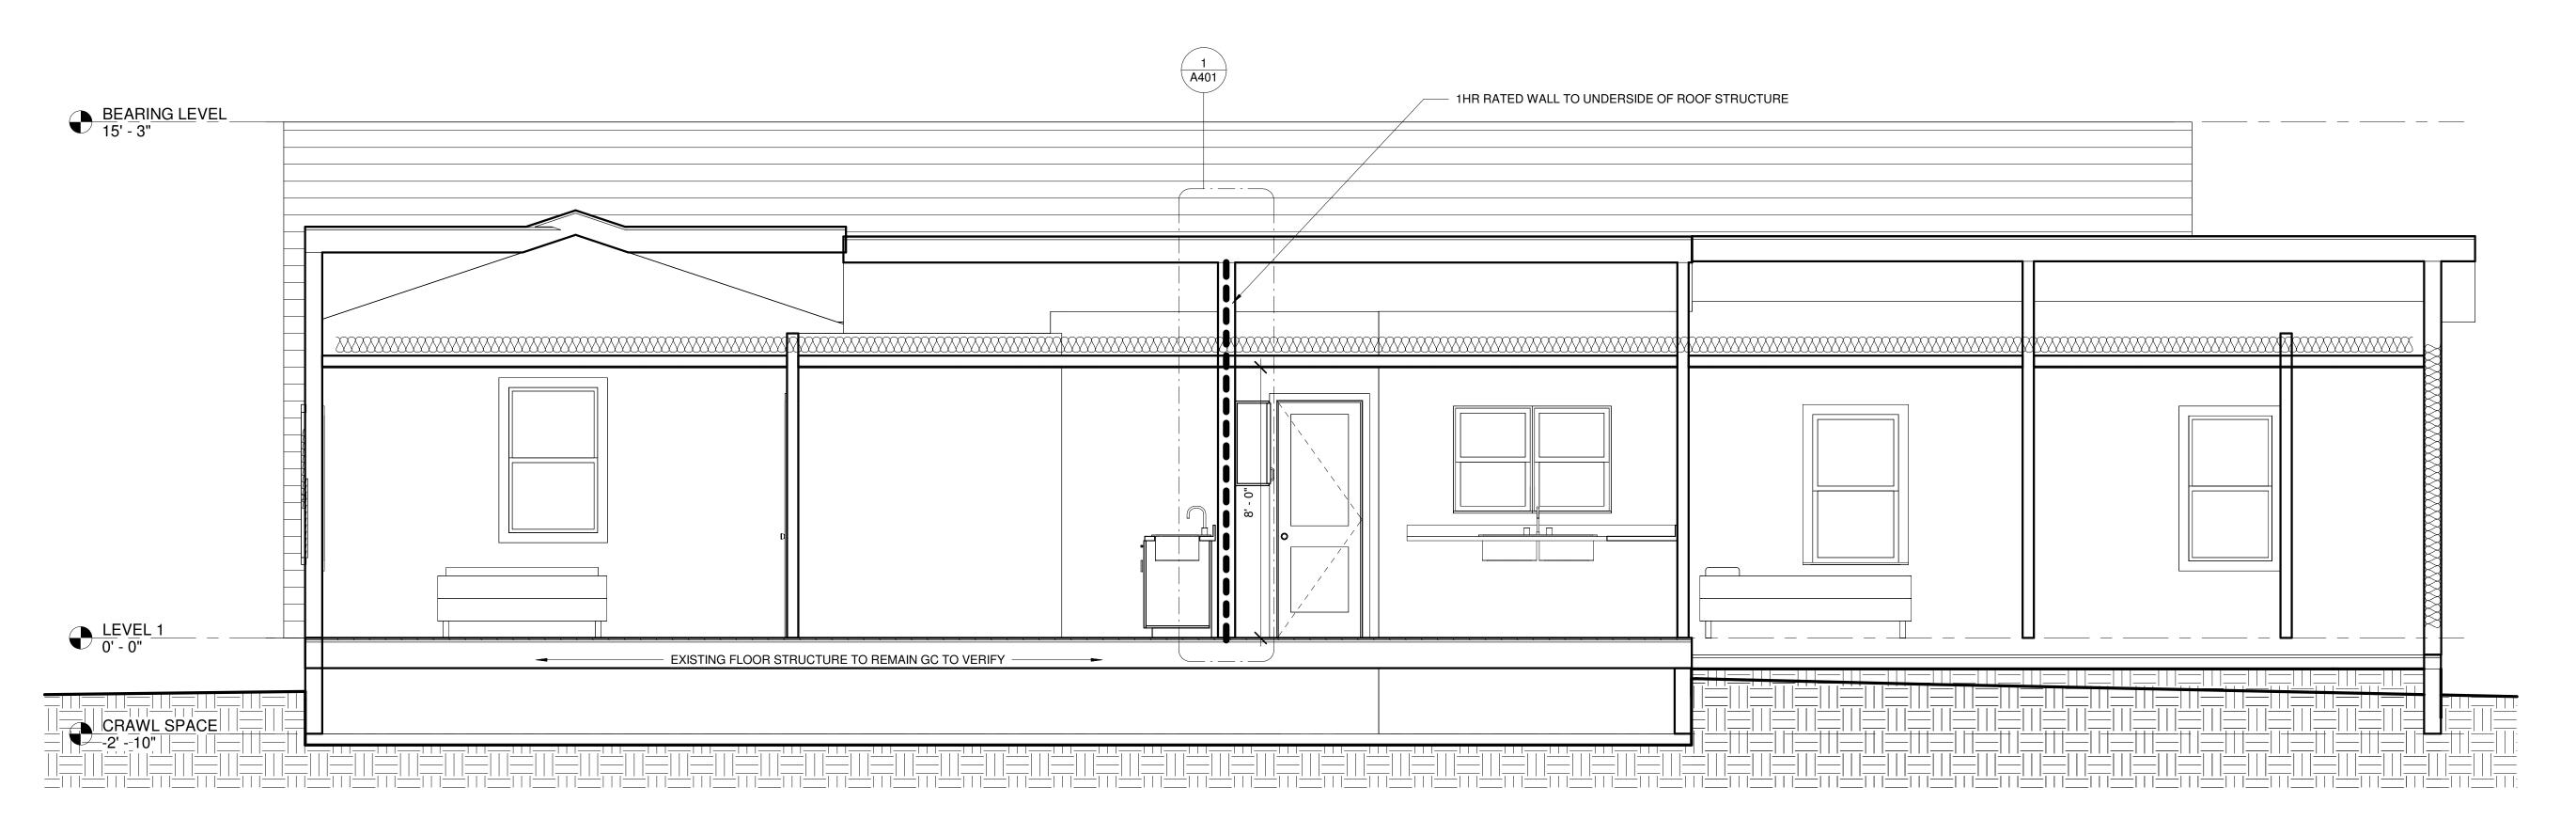
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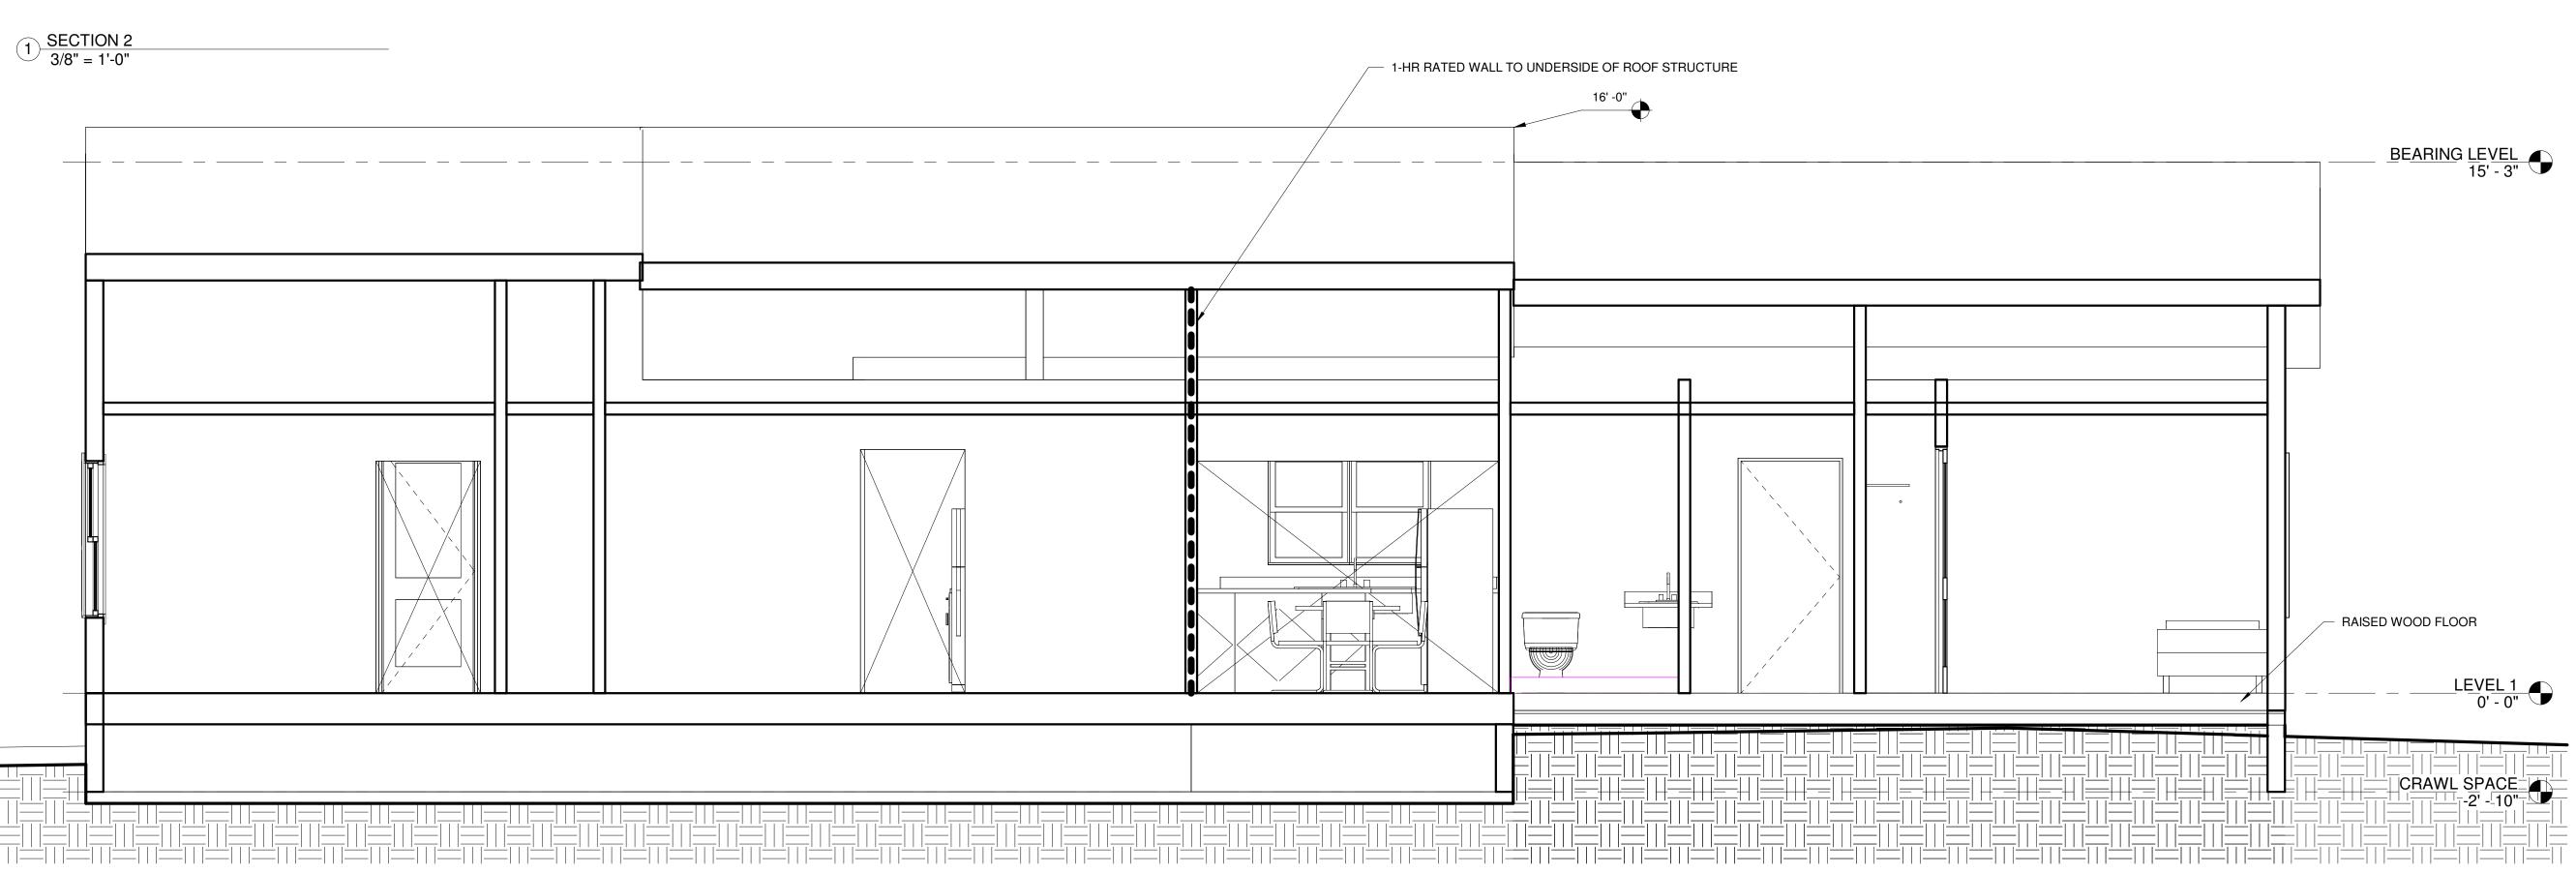
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Project number	224016		
Date	05.25.2024		
Drawn by	EKG		
Checked by	CdL		


A300

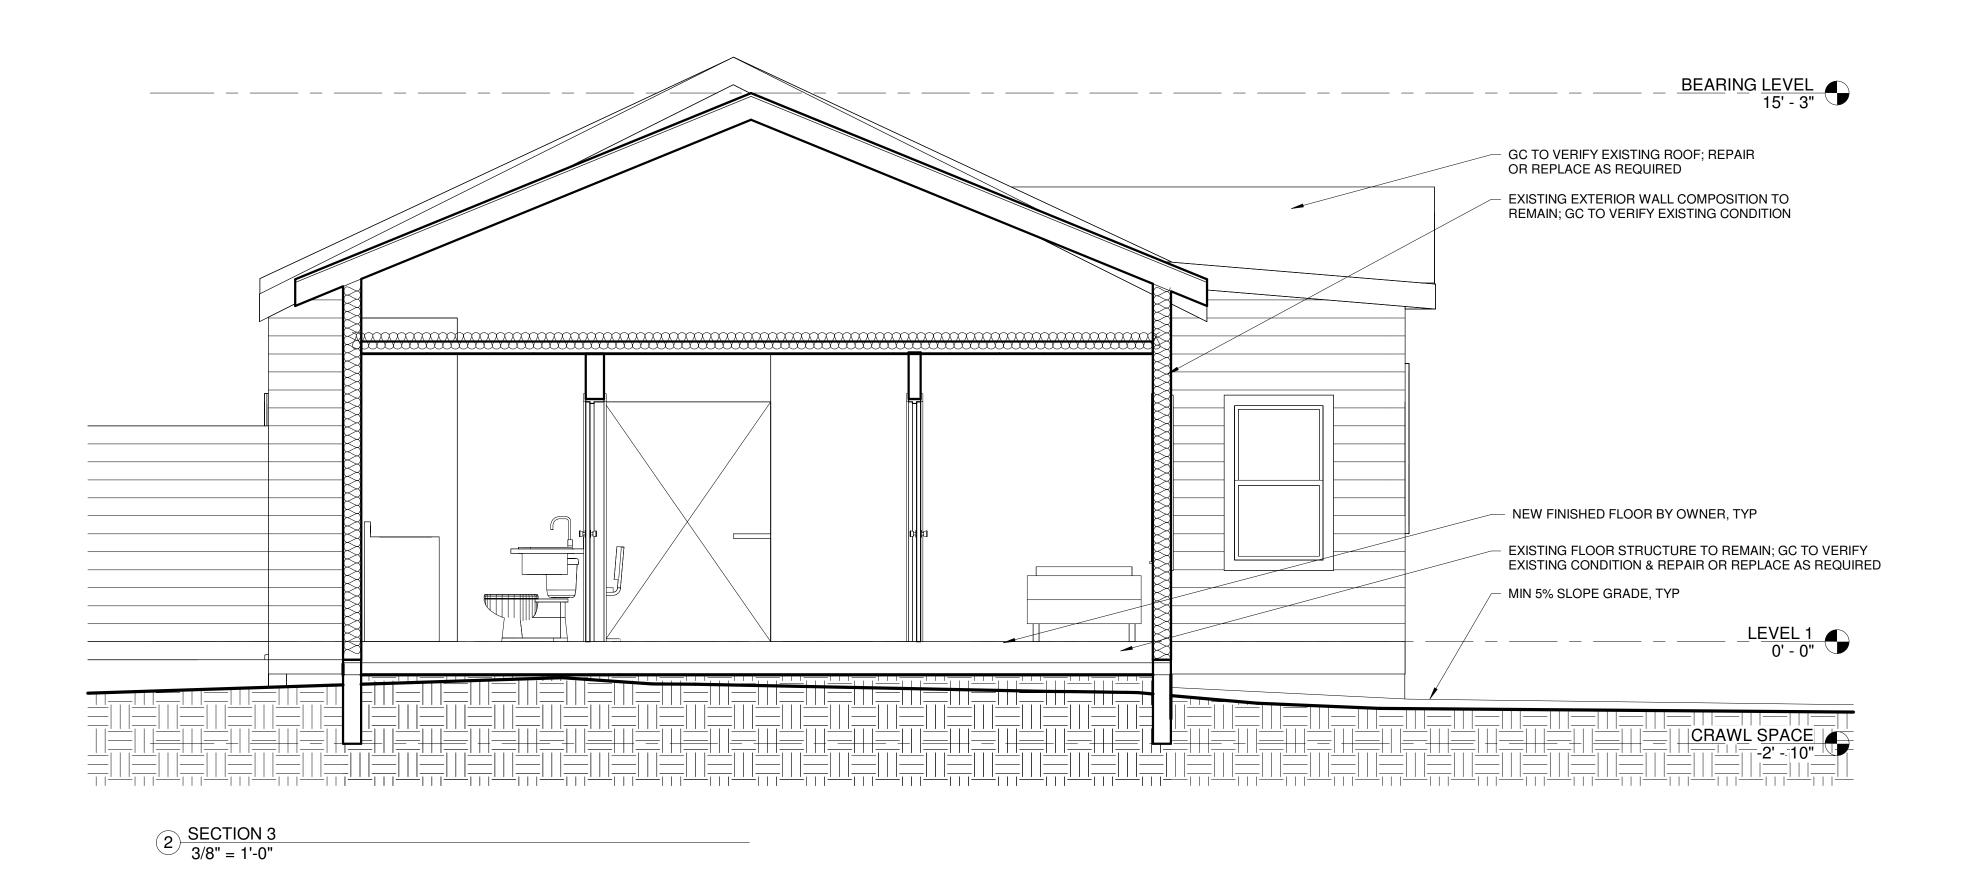Scale 3/8" = 1'-0" <sup>₹</sup>









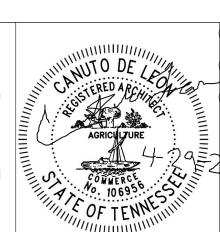

2 SECTION 4 3/8" = 1'-0"

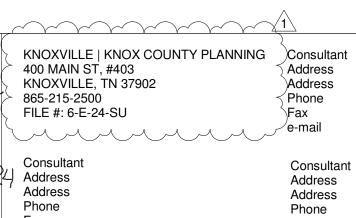

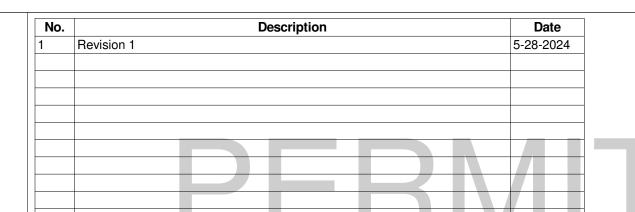


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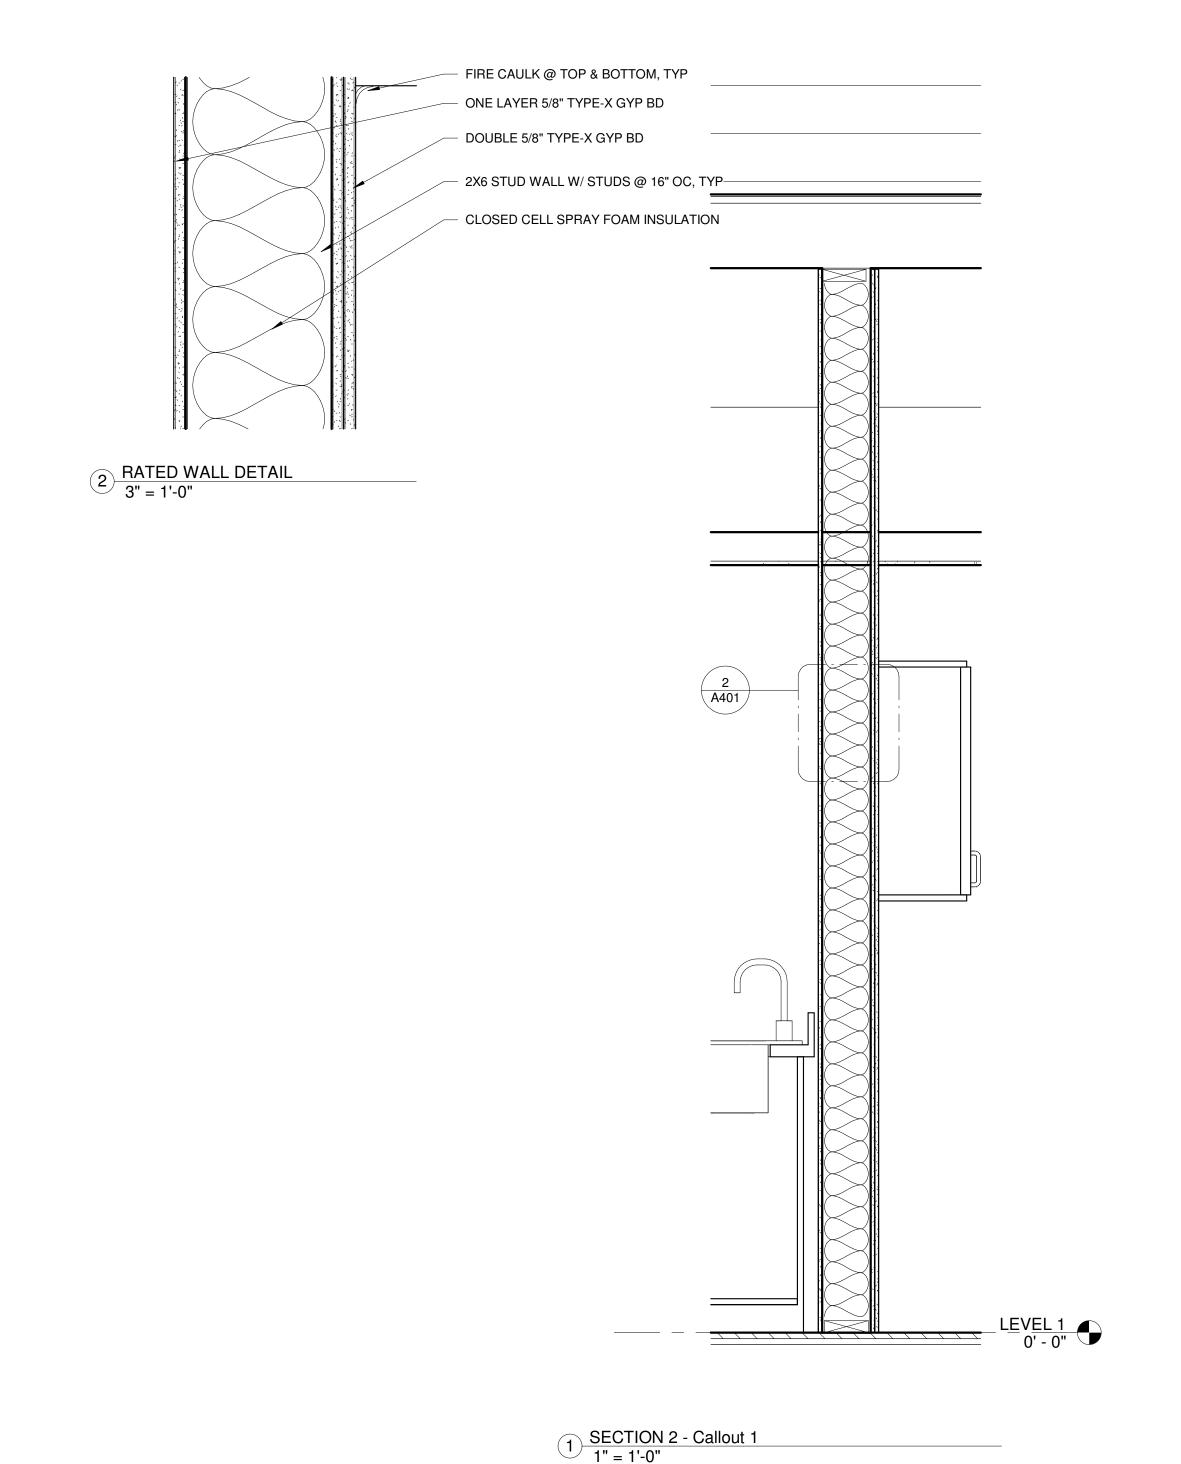
### **BUILDING SECTIONS**

20122110110			
Project number	224016		
Date	05.25.2024		
Drawn by	EKG		
Checked by	CdL		


A301

Scale 3/8" = 1'-0" <sup>₹</sup>



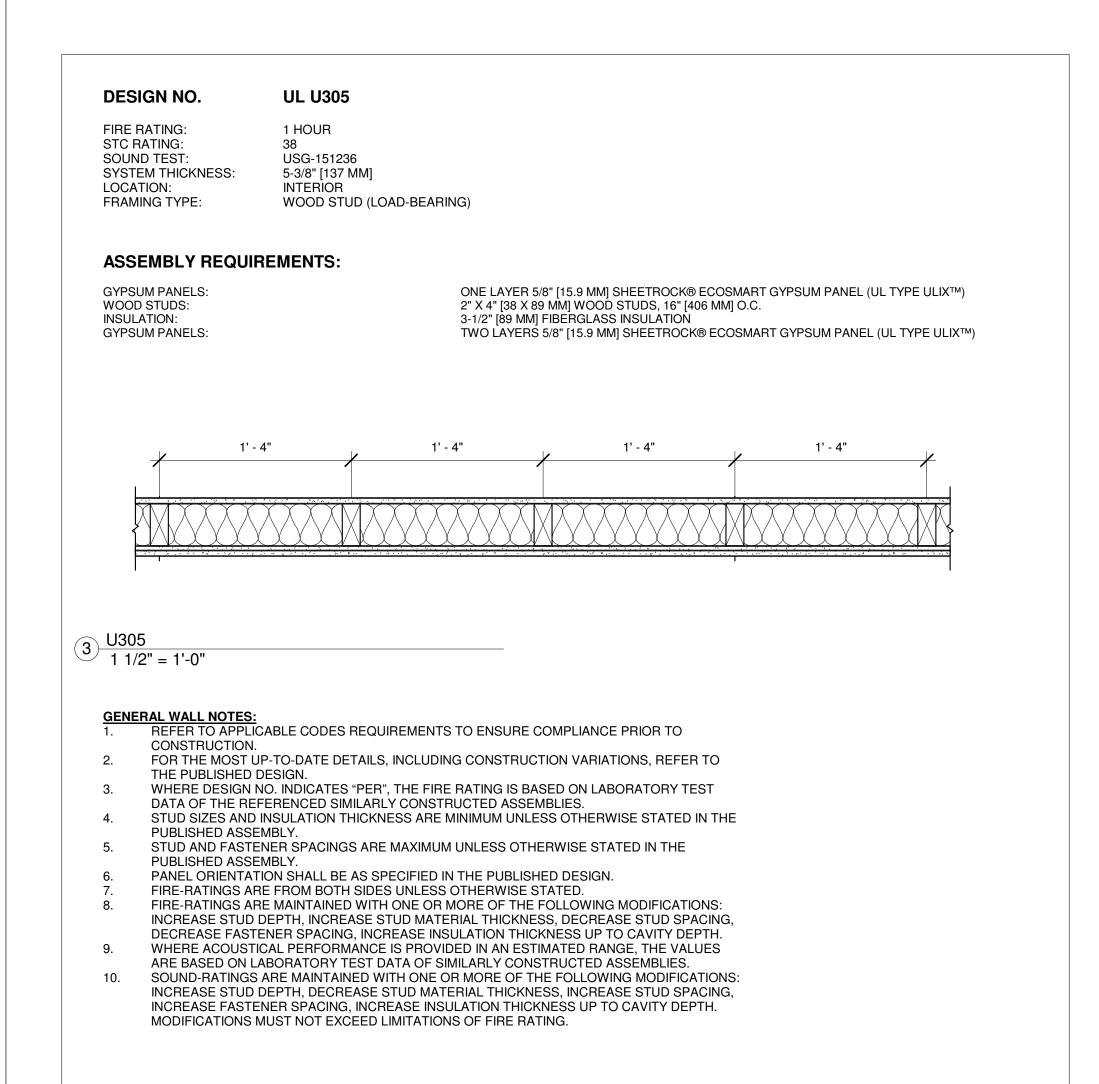



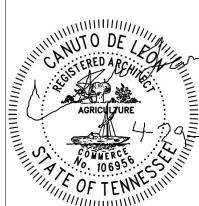

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KNOXVILLE, TN 37902 Address 865-215-2500 ⟨Phone | FILE #: 6-E-24-SU

Consultant Address Address Address Address Phone Fax Phone Fax e-mail

No.	Description		
1	Revision 1		5-28-2024

Zambezi Realty, LLC HOME TO DUPLEX RENOVATION 5405 Central Ave Pike Knoxville, TN 37912

WALL	SECTION 8	DETAILS
Project r	number	22401

WALL SECTION & DETAILS			
Project number	224016		
Date	05.25.2024		
Drawn by	EKG		
Checked by	CdL		