CONCEPT PLAN


NEALS LANDING - UNIT 3

241 NEALS LANDING ROAD, KNOXVILLE, TN DISTRICT NO. 8 SECTOR PLAN: EAST COUNTY


CLT: 61
PARCEL: 061 07001
PART OF PARCEL: 061 071

ENGINEER:
ROBERT G. CAMPBELL
AND ASSOCIATES
7523 TAGGART LANE
KNOXVILLE, TN 37938
PHONE: (865) 947-5996
FAX: (865) 947-7556

DEVELOPER:
MESANA INVESTMENTS
SCOTT DAVIS
1920 EBENEZER ROAD
KNOXVILLE, TN 37922
(865) 693-3356

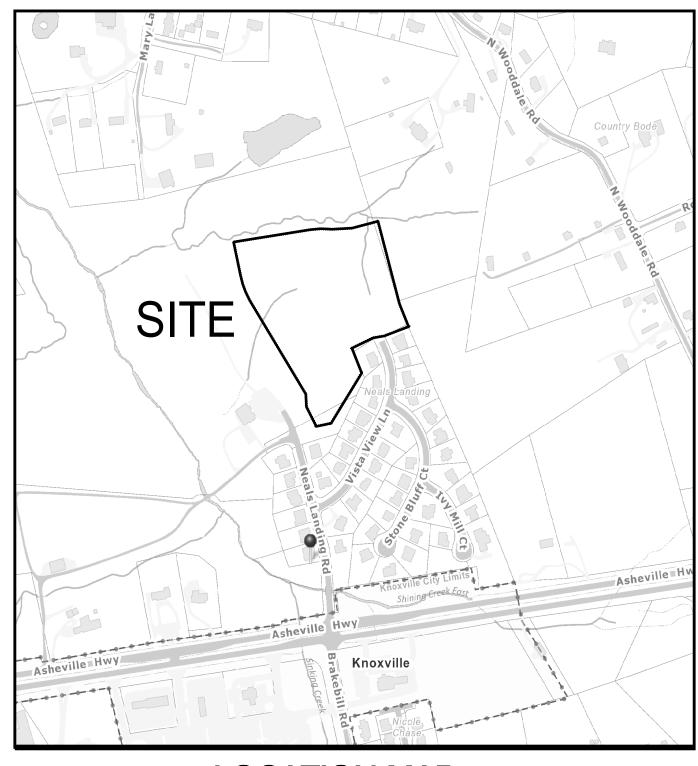


LOCATION MAP

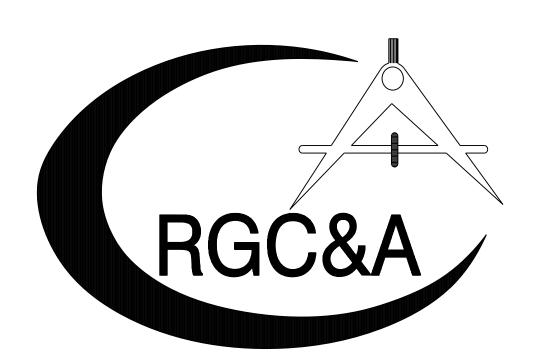

ROBERT G. CAMPBELL & ASSOCIATES, L.P. CONSULTING ENGINEERS KNOXVILLE, TENNESSEE


Certification of Concept Plan.
I hereby certify that I am a registered engineer, licensed to practice engineering under the laws of the State of Tennessee. I further certify that the plan and accompanying drawings, documents and statements conform to all applicable provisions of the Knoxville-Knox County Subdivision Regulations except as has been itemized and described in a


report filed with the Metropolitan Planning Commission.

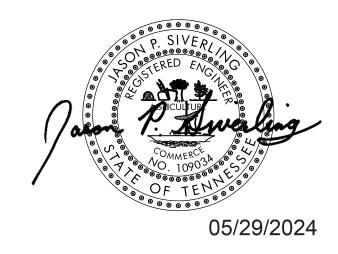



Revised: 6/3/2024

MPC FILE NUMBER: 6-SF-24-C / 6-J-24-DP (ORIGINAL MPC FILE NUMBER: 7-SD-20-C / 7-D-20-UR)

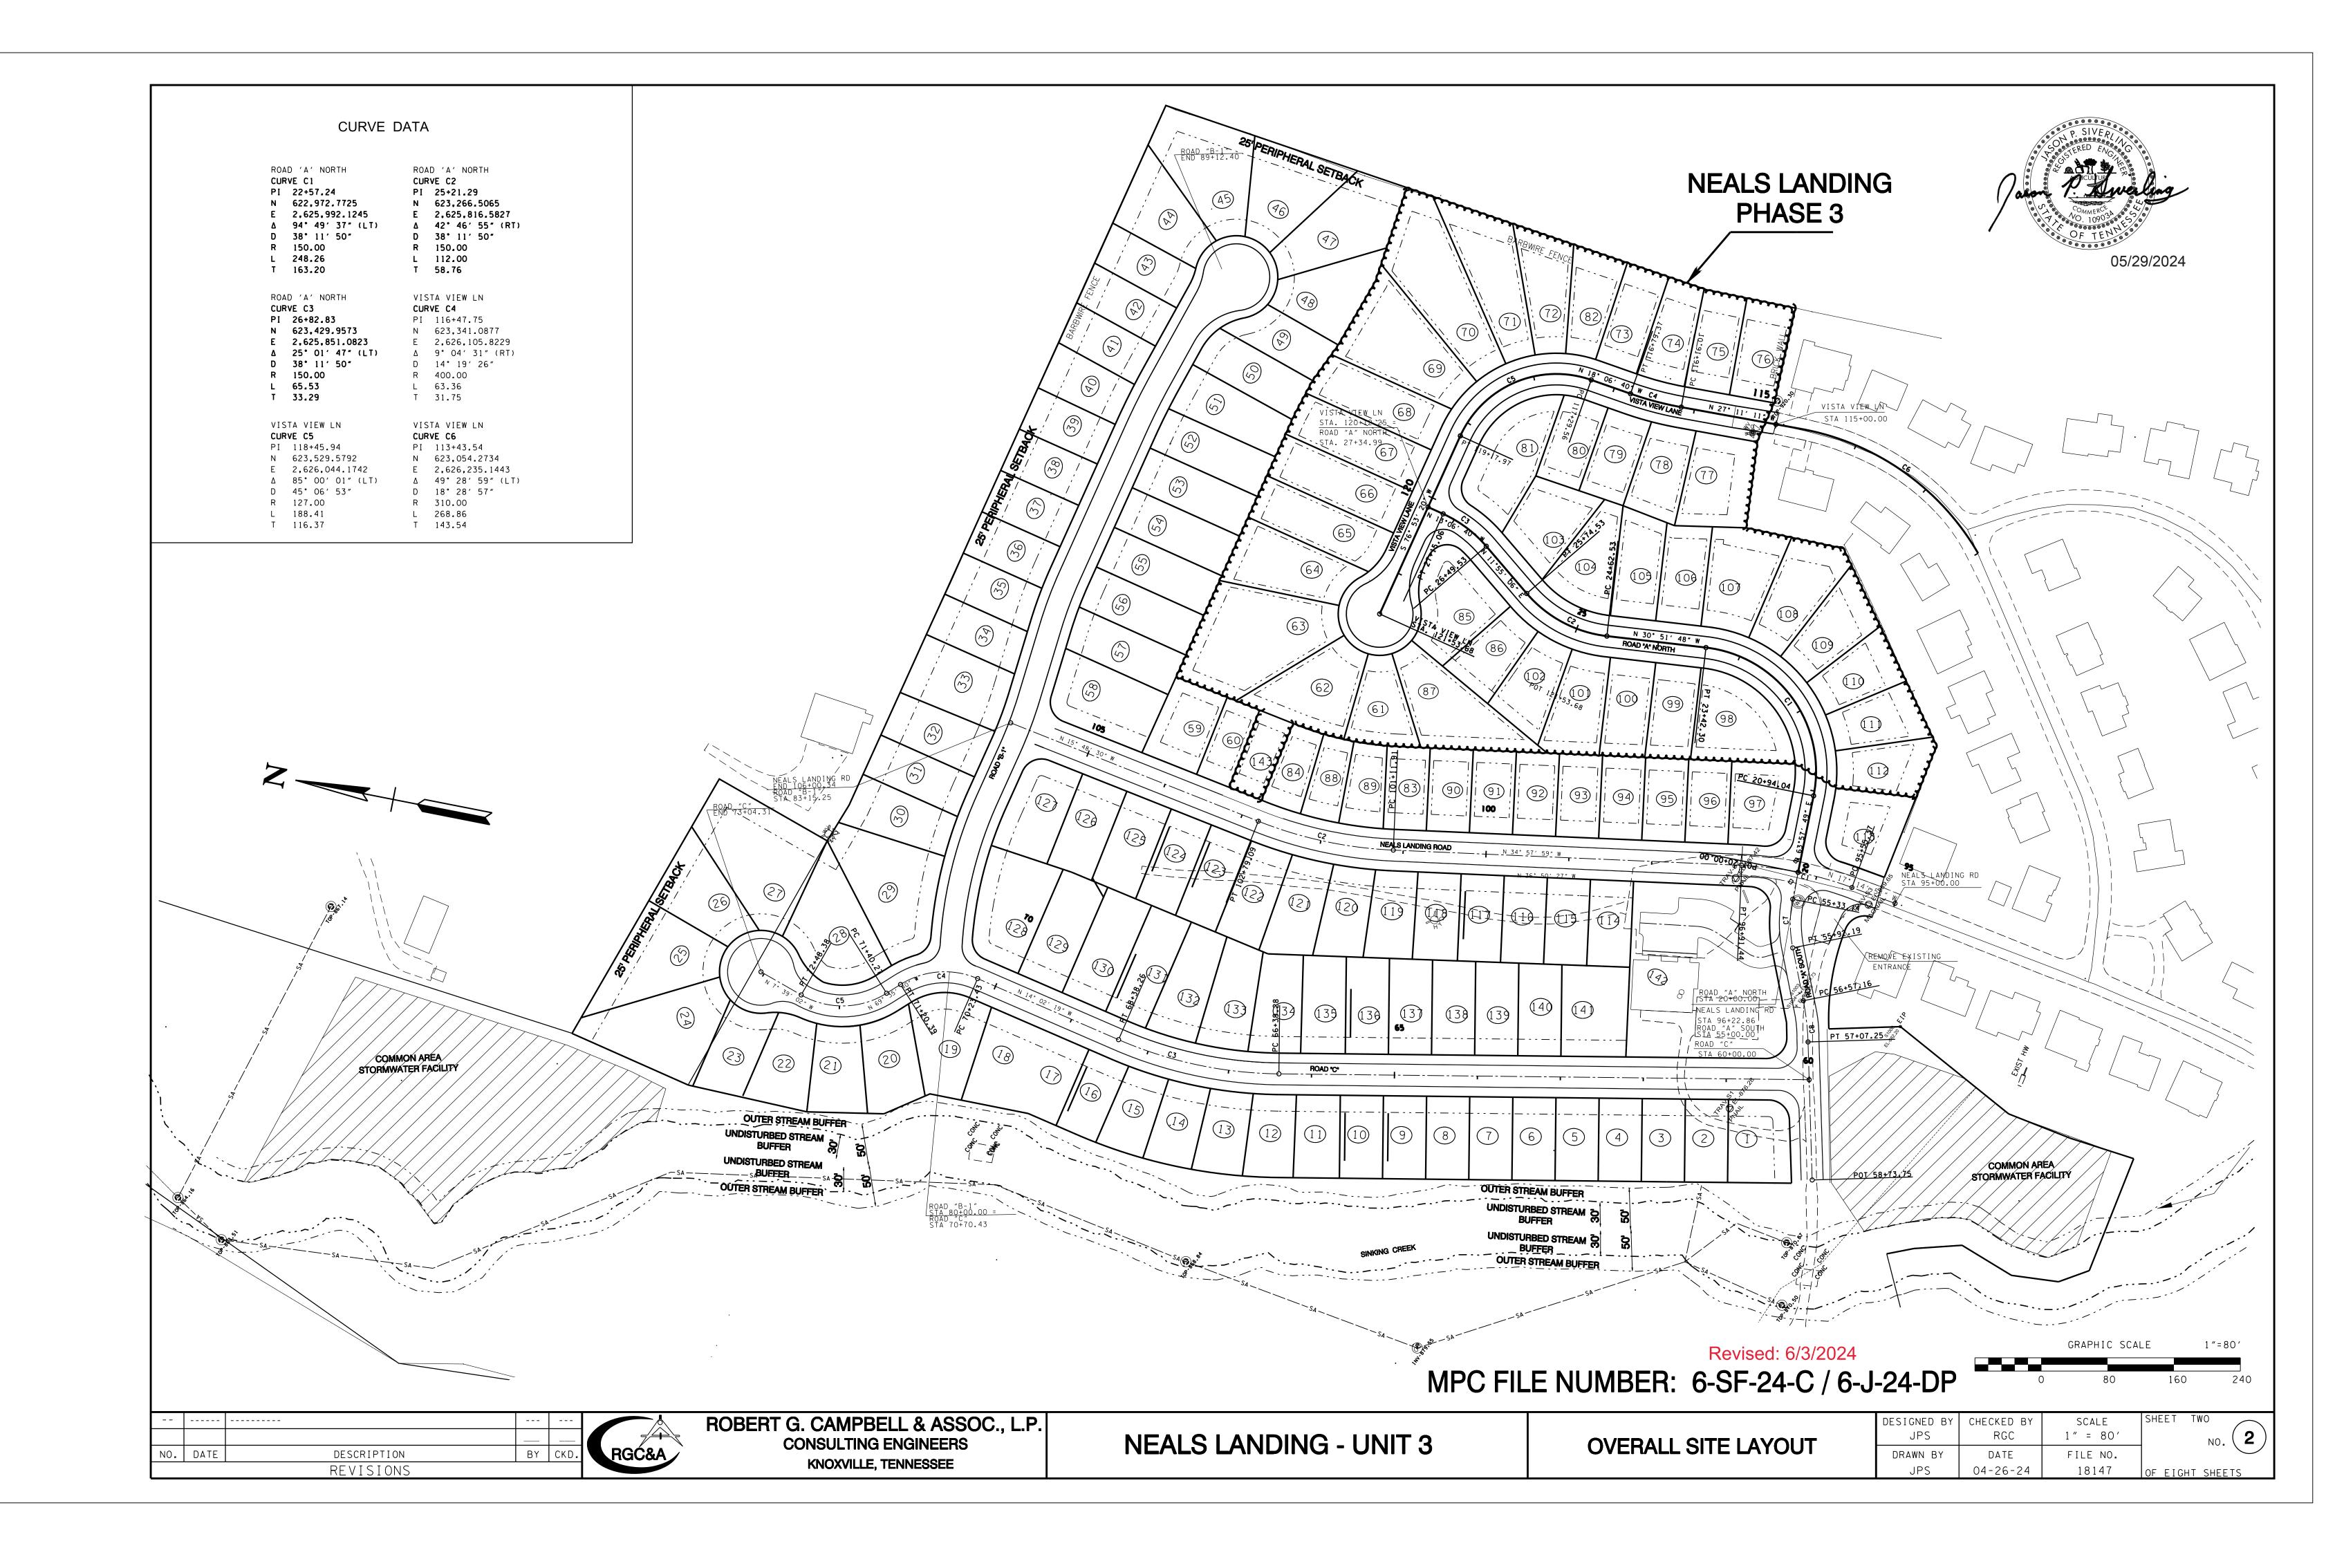

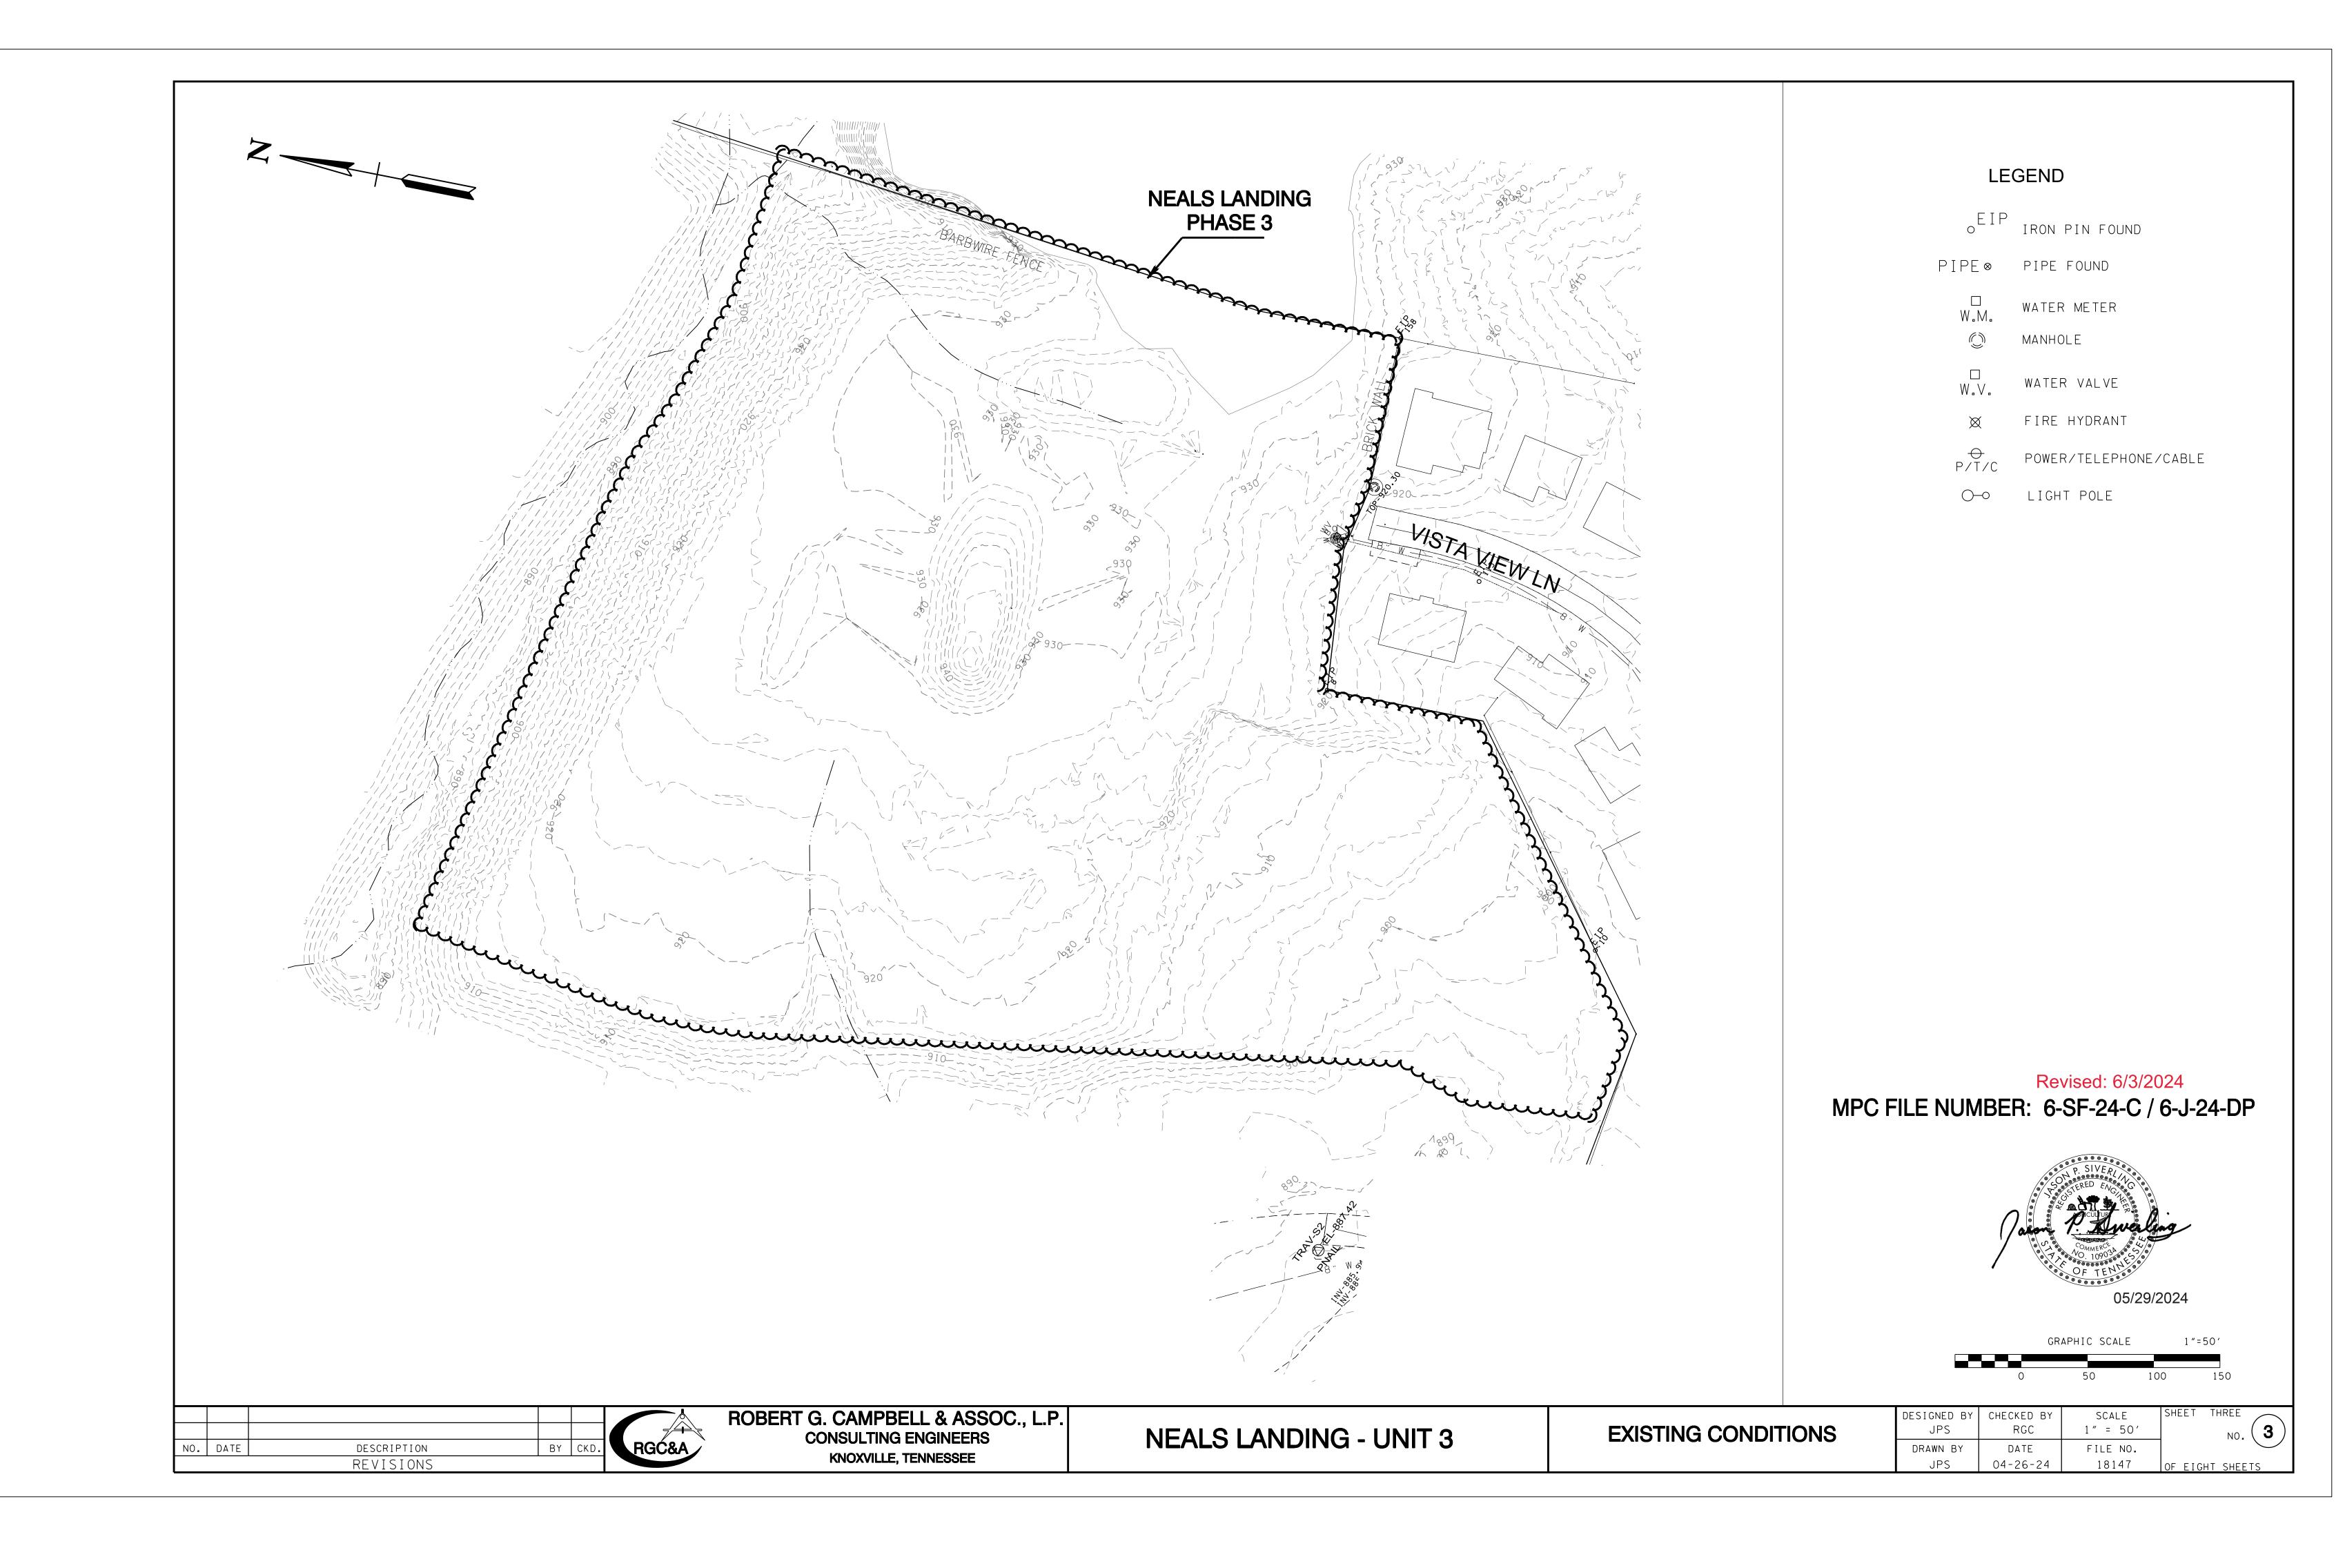

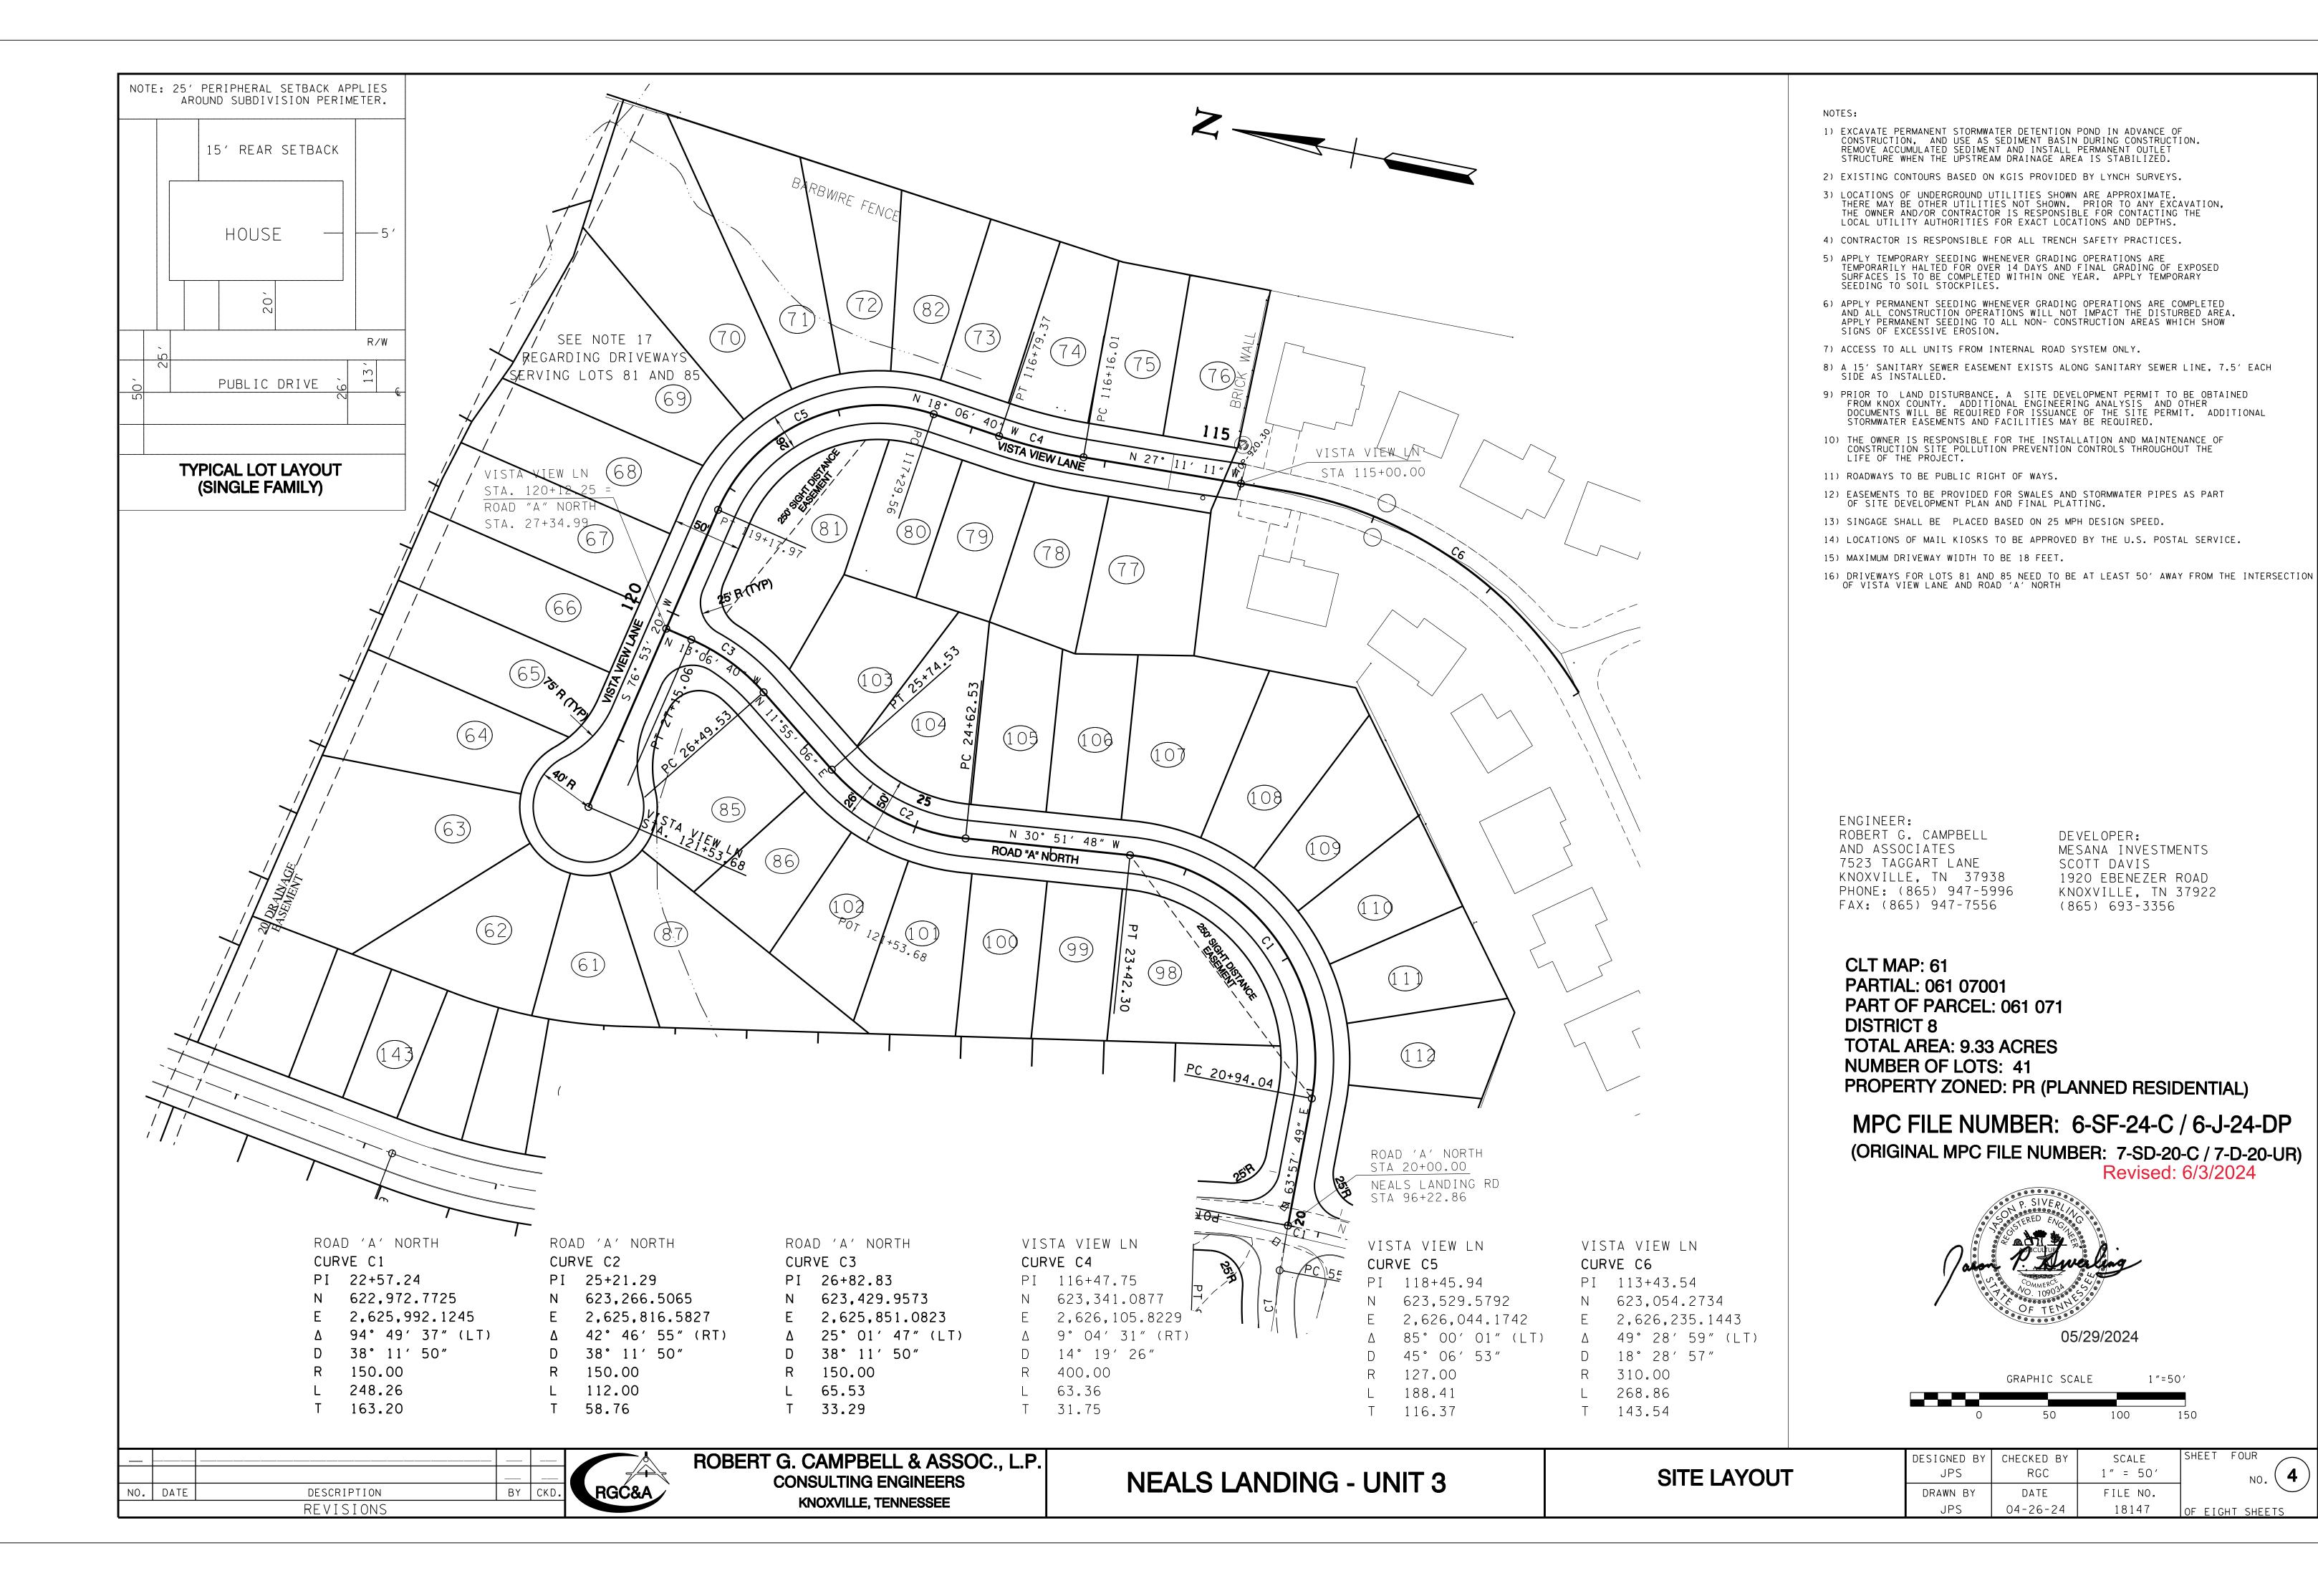

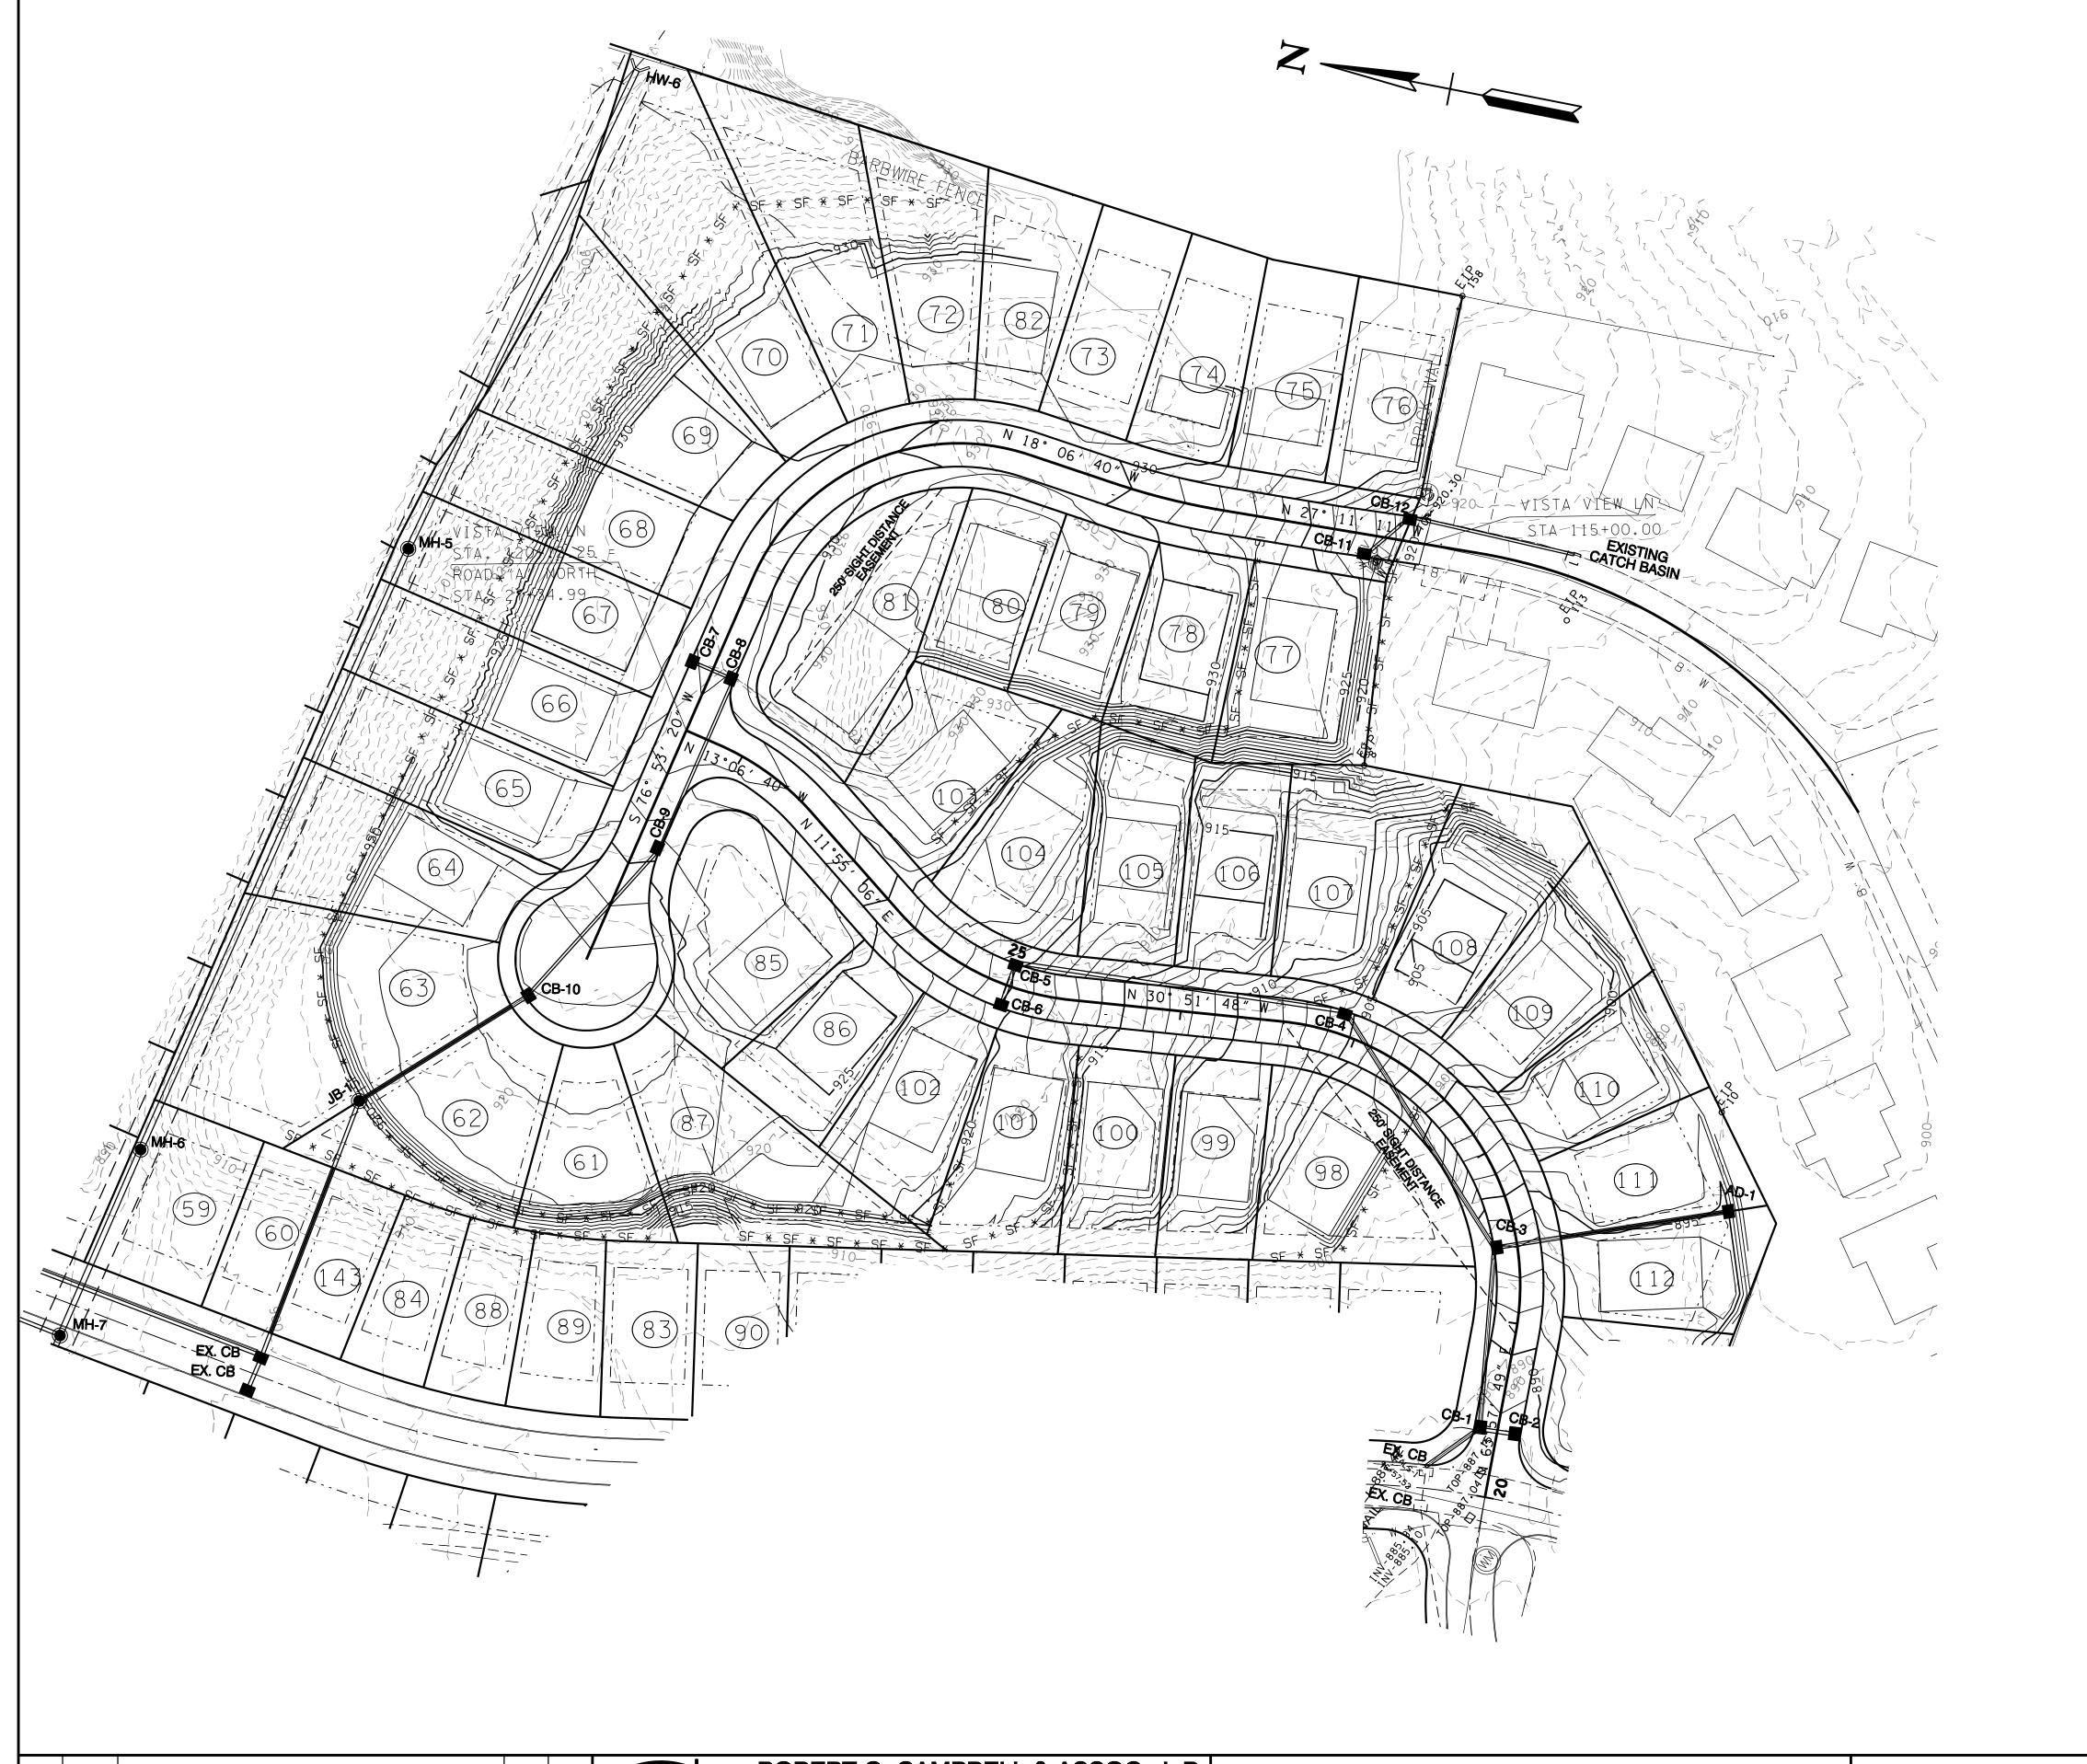

NOTES:

- 1) EXCAVATE PERMANENT STORMWATER DETENTION POND IN ADVANCE OF CONSTRUCTION, AND USE AS SEDIMENT BASIN DURING CONSTRUCTION. REMOVE ACCUMULATED SEDIMENT AND INSTALL PERMANENT OUTLET STRUCTURE WHEN THE UPSTREAM DRAINAGE AREA IS STABILIZED.
- 2) EXISTING CONTOURS BASED ON KGIS PROVIDED BY LYNCH SURVEYS.
- 3) LOCATIONS OF UNDERGROUND UTILITIES SHOWN ARE APPROXIMATE.
 THERE MAY BE OTHER UTILITIES NOT SHOWN. PRIOR TO ANY EXCAVATION,
 THE OWNER AND/OR CONTRACTOR IS RESPONSIBLE FOR CONTACTING THE
 LOCAL UTILITY AUTHORITIES FOR EXACT LOCATIONS AND DEPTHS.
- 4) CONTRACTOR IS RESPONSIBLE FOR ALL TRENCH SAFETY PRACTICES.
- 5) APPLY TEMPORARY SEEDING WHENEVER GRADING OPERATIONS ARE TEMPORARILY HALTED FOR OVER 14 DAYS AND FINAL GRADING OF EXPOSED SURFACES IS TO BE COMPLETED WITHIN ONE YEAR. APPLY TEMPORARY SEEDING TO SOIL STOCKPILES.
- 6) APPLY PERMANENT SEEDING WHENEVER GRADING OPERATIONS ARE COMPLETED AND ALL CONSTRUCTION OPERATIONS WILL NOT IMPACT THE DISTURBED AREA. APPLY PERMANENT SEEDING TO ALL NON- CONSTRUCTION AREAS WHICH SHOW SIGNS OF EXCESSIVE EROSION.
- 7) ACCESS TO ALL UNITS FROM INTERNAL ROAD SYSTEM ONLY.
- 8) A 15' SANITARY SEWER EASEMENT EXISTS ALONG SANITARY SEWER LINE, 7.5' EACH SIDE AS INSTALLED.
- 9) LANDSCAPING SHALL COMPLY WITH ALL ASPECTS OF THE KNOX COUNTY ENGINEEERING. TREE PROTECTION ORDINANCE.
- 10) PRIOR TO LAND DISTURBANCE, A SITE DEVELOPMENT PERMIT TO BE OBTAINED FROM KNOX COUNTY. ADDITIONAL ENGINEERING ANALYSIS AND OTHER DOCUMENTS WILL BE REQUIRED FOR ISSUANCE OF THE SITE PERMIT. ADDITIONAL STORMWATER EASEMENTS AND FACILITIES MAY BE REQUIRED.
- 11) THE OWNER IS RESPONSIBLE FOR THE INSTALLATION AND MAINTENANCE OF CONSTRUCTION SITE POLLUTION PREVENTION CONTROLS THROUGHOUT THE LIFE OF THE PROJECT.
- 12) ROADWAYS TO BE PUBLIC RIGHT OF WAYS.
- 13) EASEMENTS TO BE PROVIDED FOR SWALES AND STORMWATER PIPES AS PART OF SITE DEVELOPMENT PLAN AND FINAL PLATTING.
- 14) SINGAGE SHALL BE PLACED BASED ON 25 MPH DESIGN SPEED.
- 15) LOCATIONS OF MAIL KIOSKS TO BE APPROVED BY THE U.S. POSTAL SERVICE.
- 16) MAXIMUM DRIVEWAY WIDTH TO BE 18 FEET.

LEGEND

PROPOSED SIDEWALK

PROPOSED STORMDRAIN

PROPOSED CATCH BASIN

PROPOSED HEADWALL

— 960 — PROPOSED MAJOR CONTOURS

PROPOSED MINOR CONTOURS

EXISTING ROADS

EXISTING TREE LINE

Revised: 6/3/2024

MPC FILE NUMBER: 6-SF-24-C / 6-J-24-DP



0 50 100 15

NO. DATE DESCRIPTION BY CKD. RGC&A

REVISIONS

ROBERT G. CAMPBELL & ASSOC., L.P. CONSULTING ENGINEERS
KNOXVILLE, TENNESSEE

NEALS LANDING - UNIT 3

GRADING AND DRAINAGE LAYOUT

DESIGNED BY CHECKED BY

JPS RGC 1

DRAWN BY DATE 1

JPS 04-26-24


SCALE


1" = 50'


FILE NO.

18147


OF EIGHT SHEE

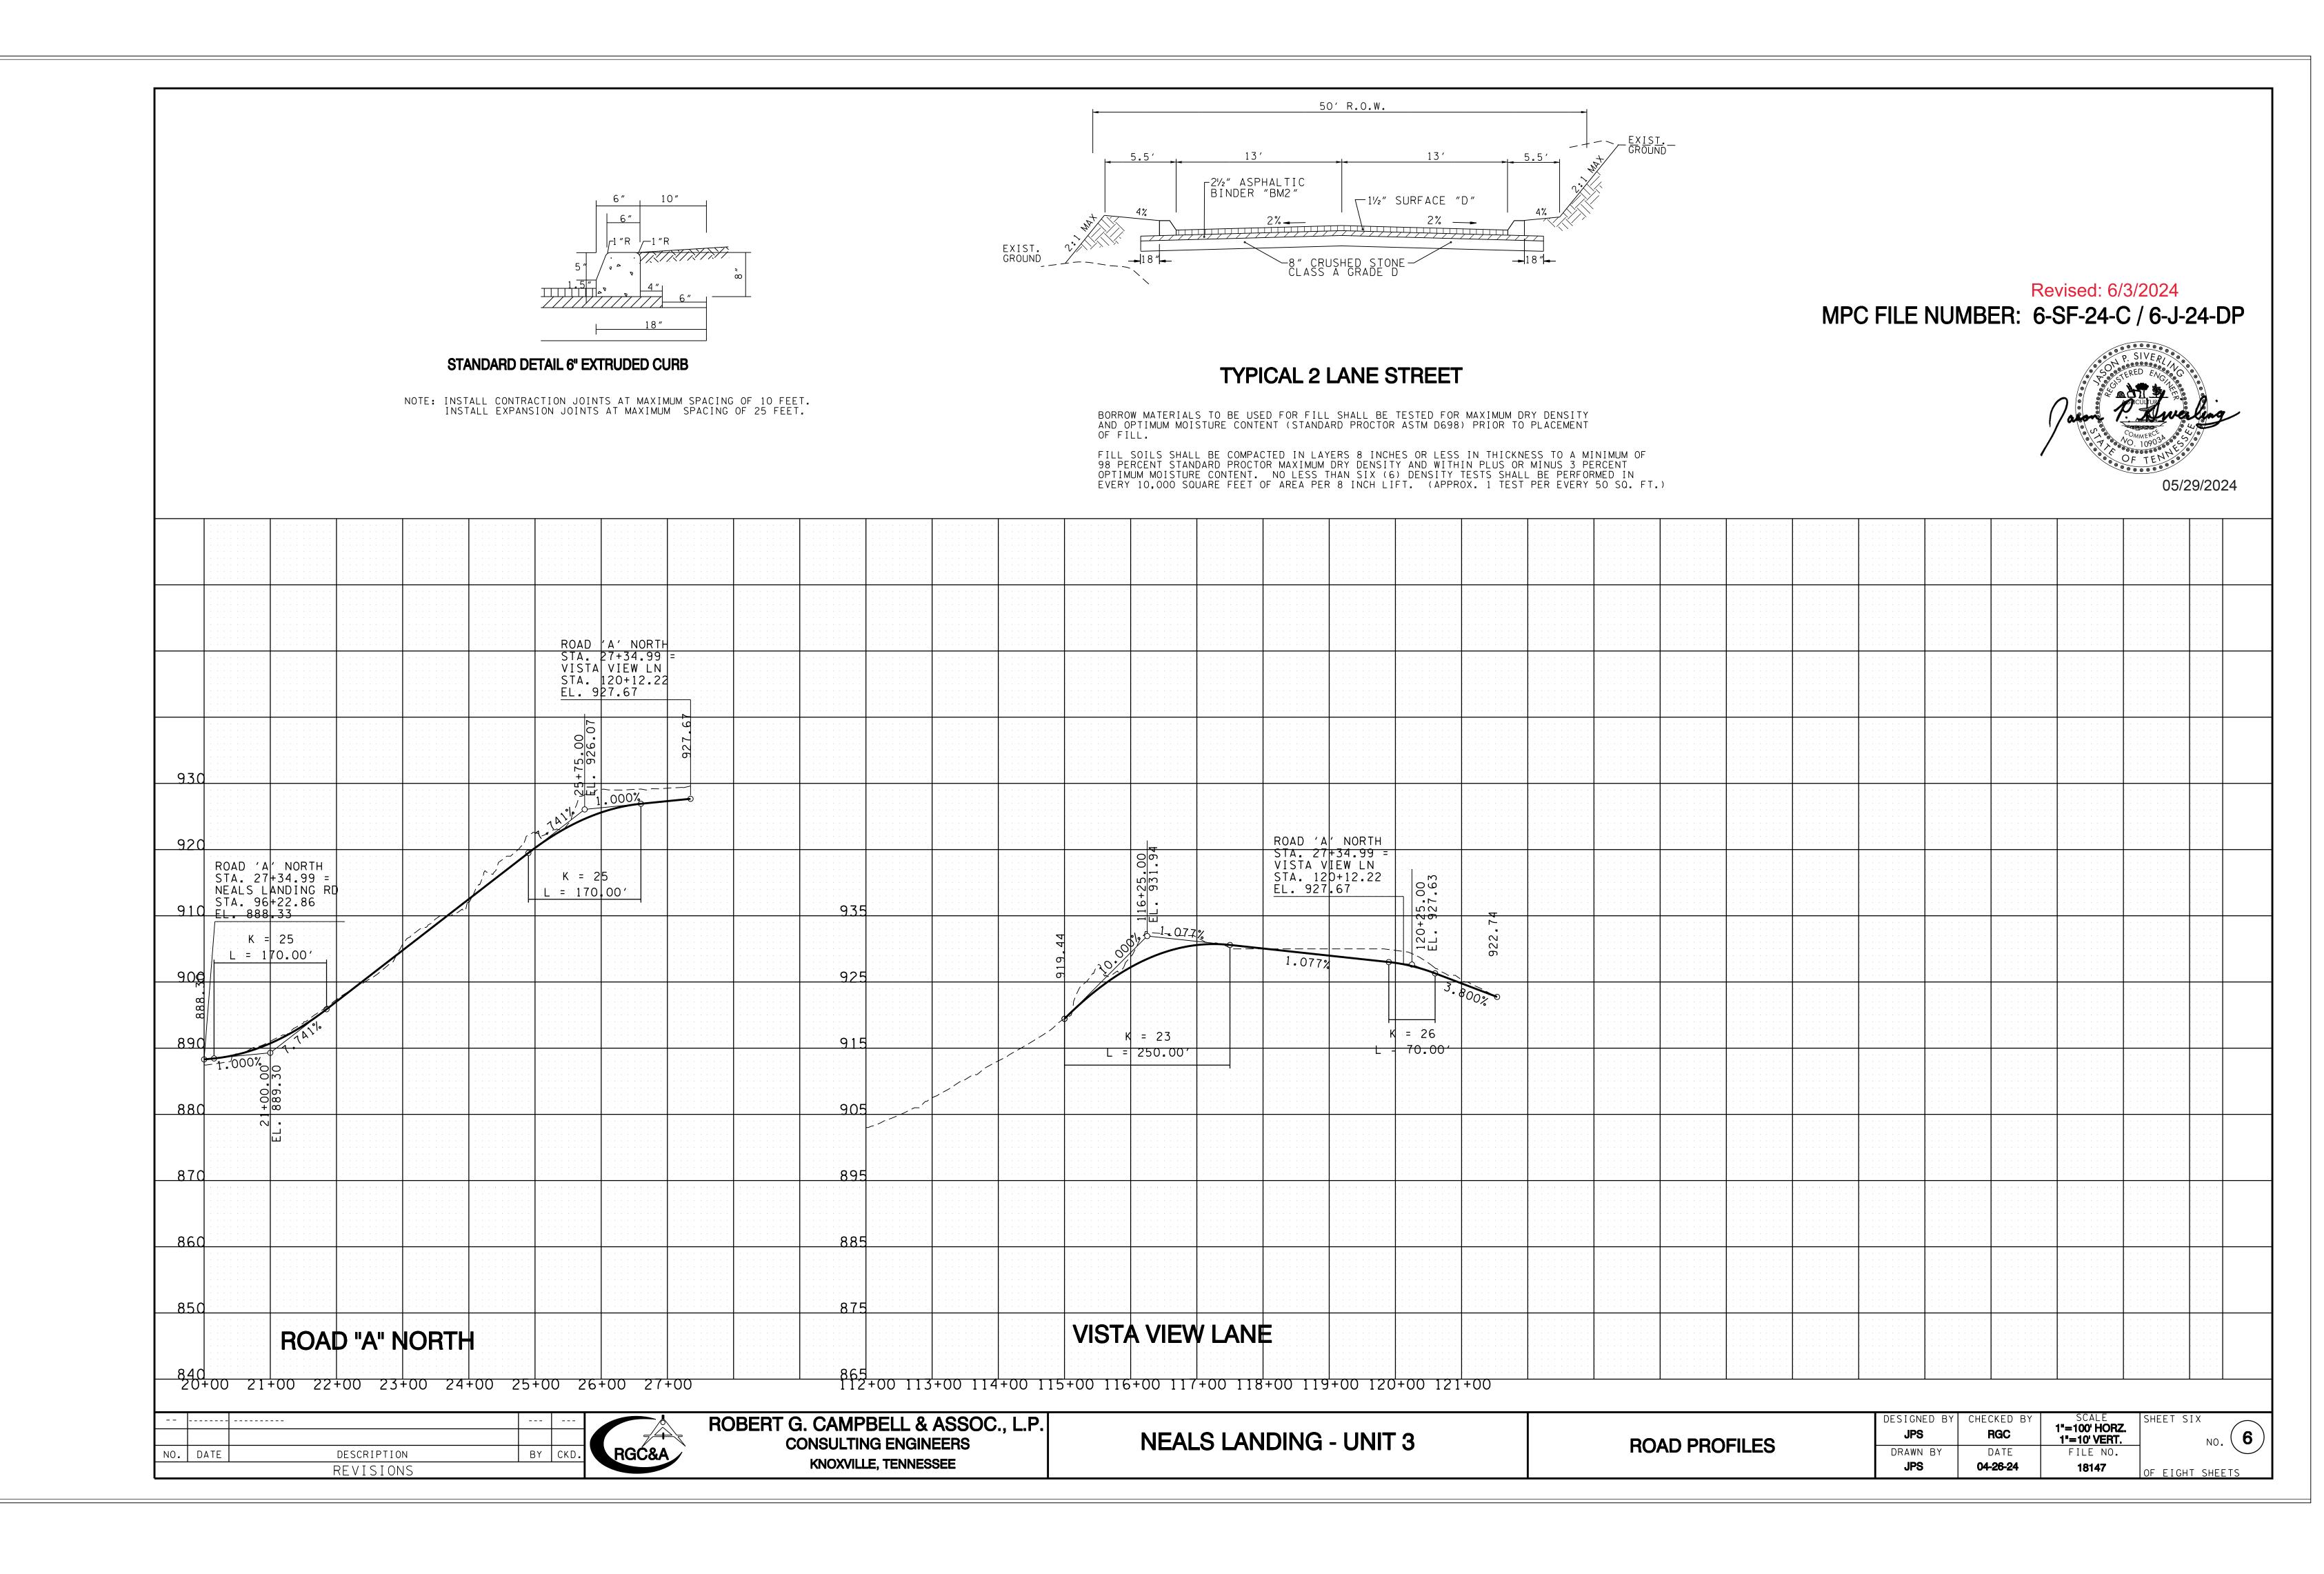

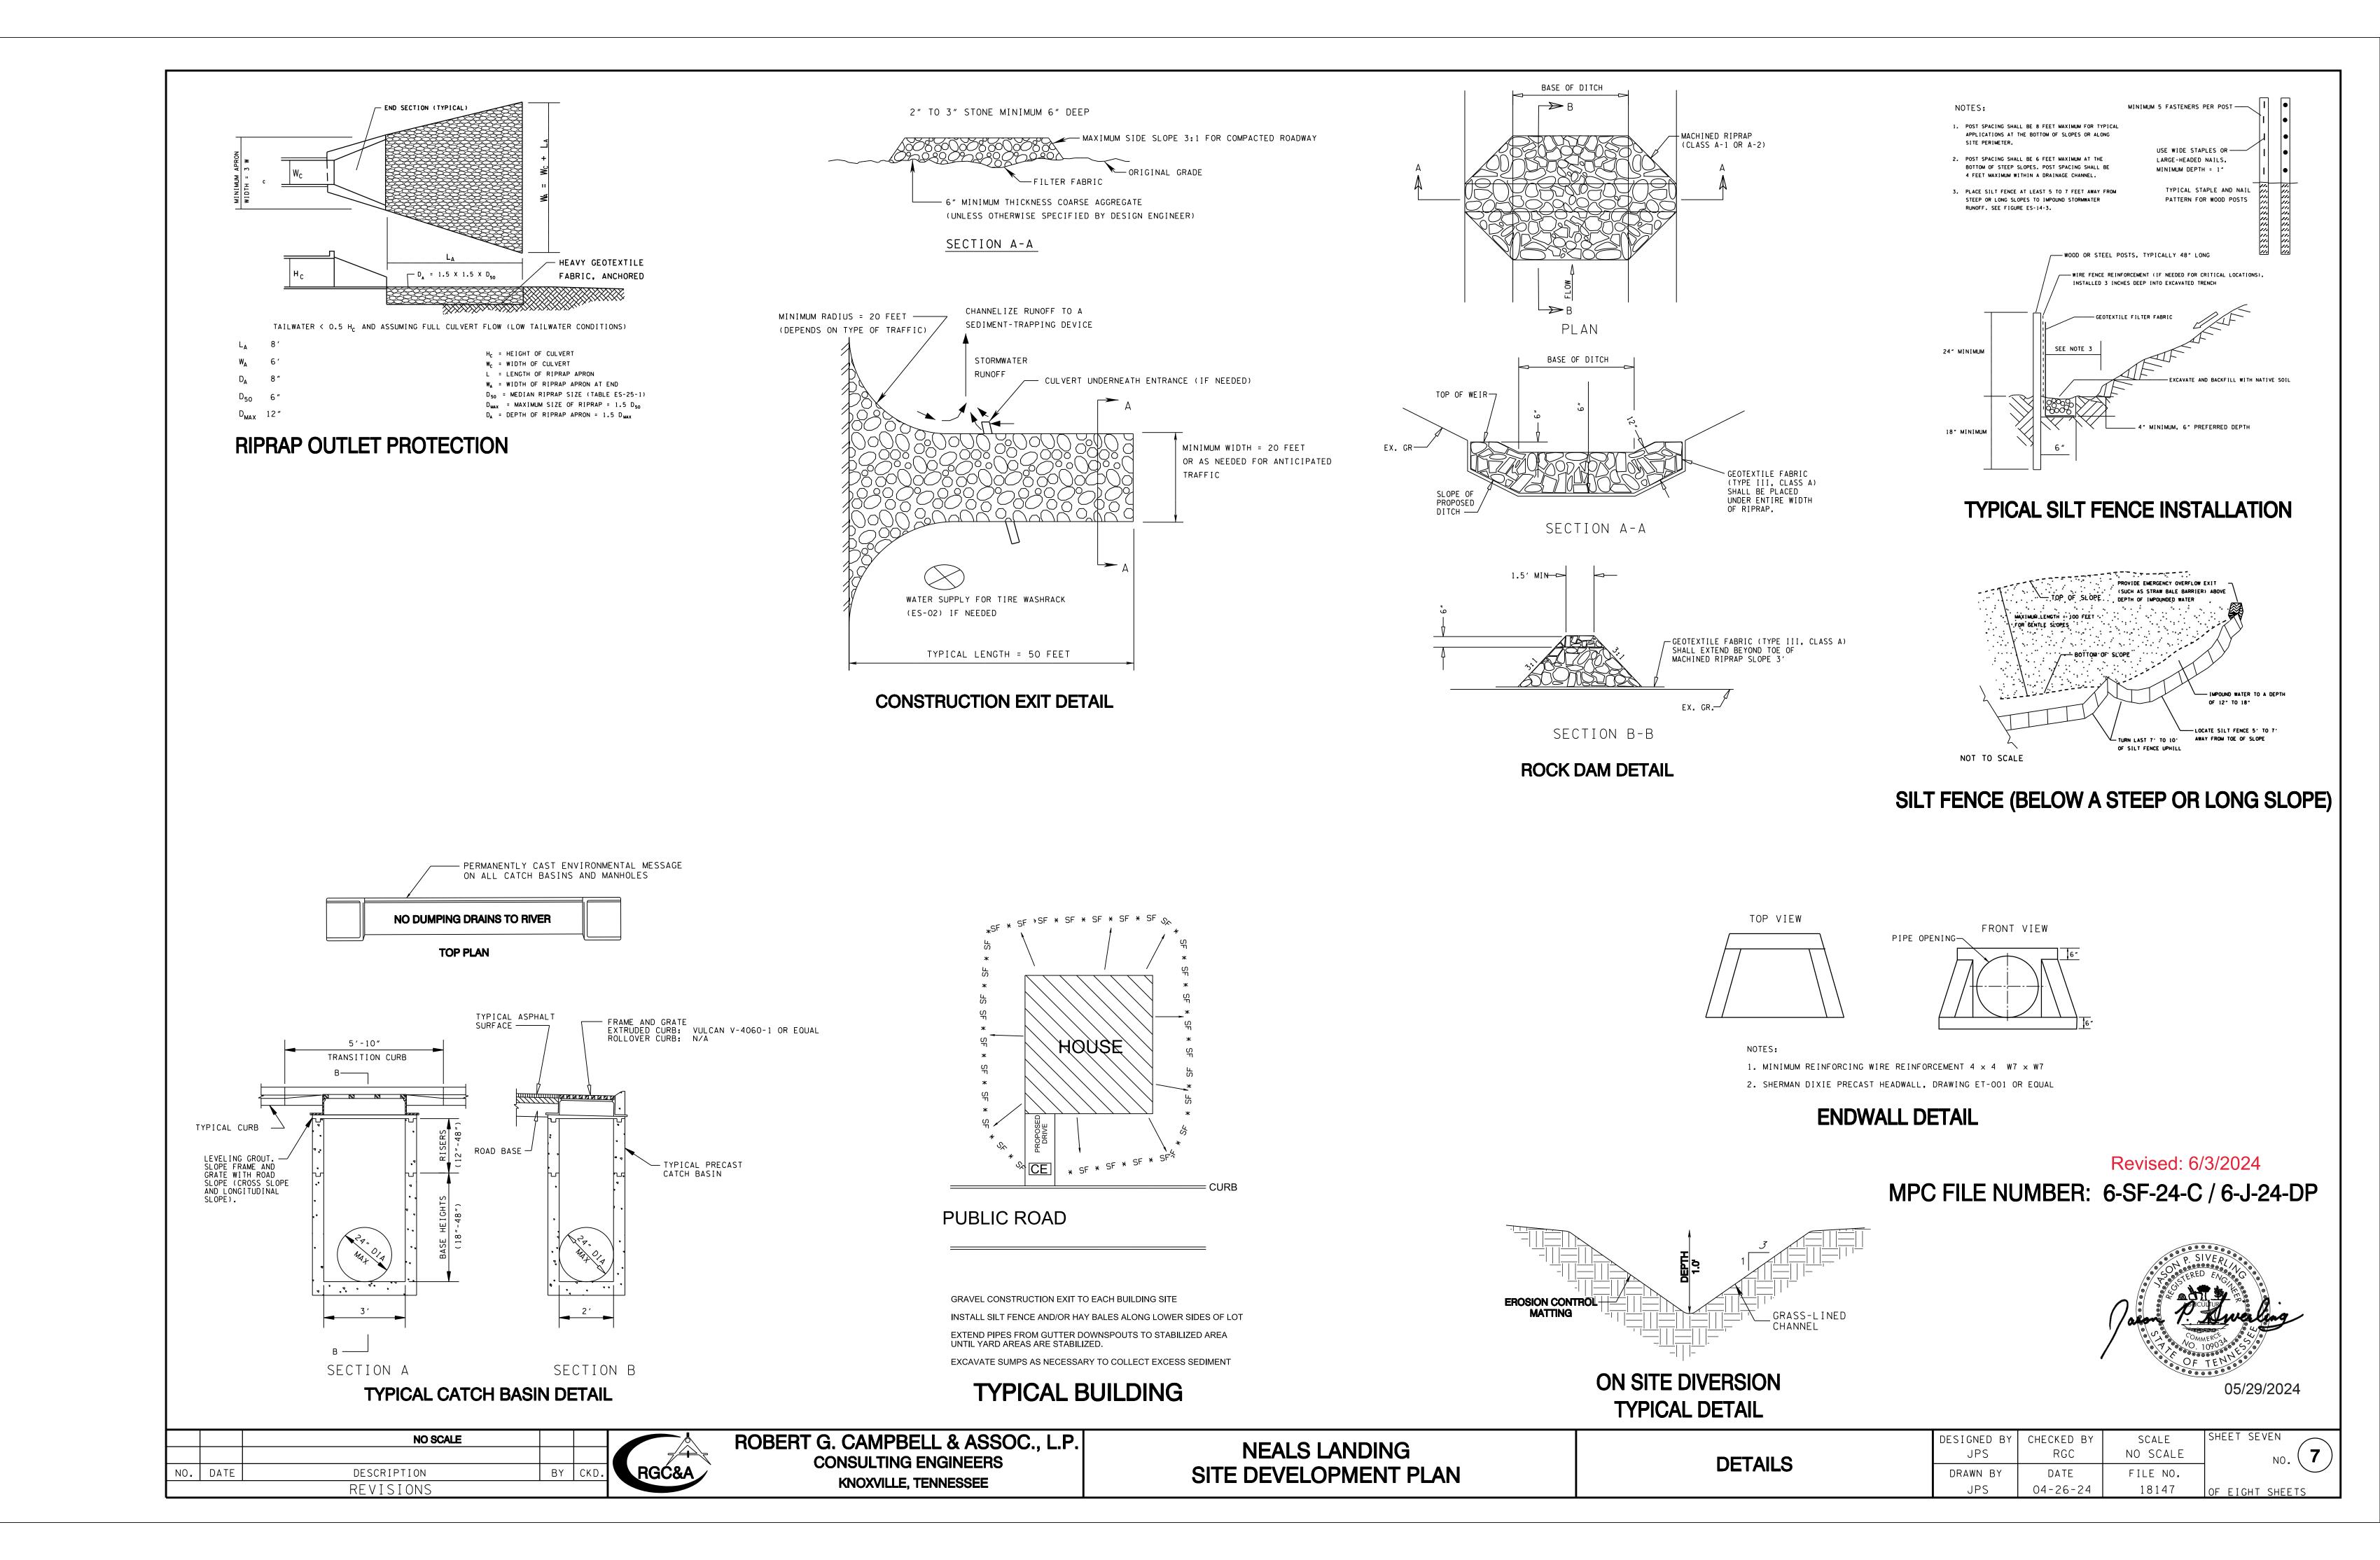

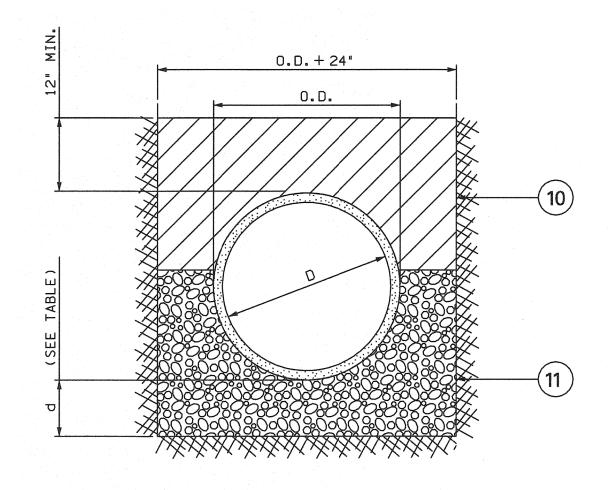



CLASS B

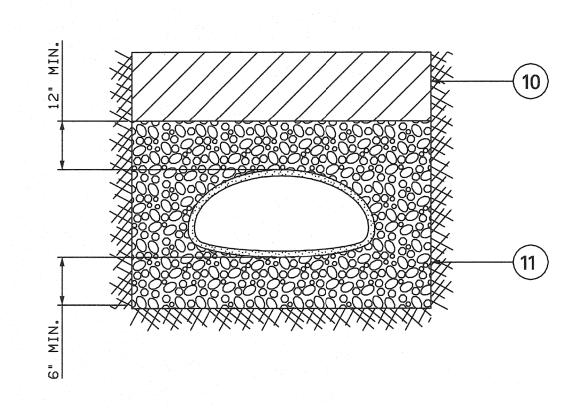


TRENCH BEDDING


CLASS B

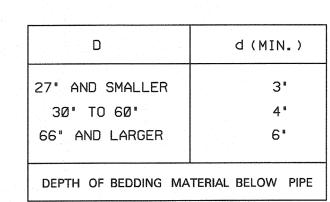

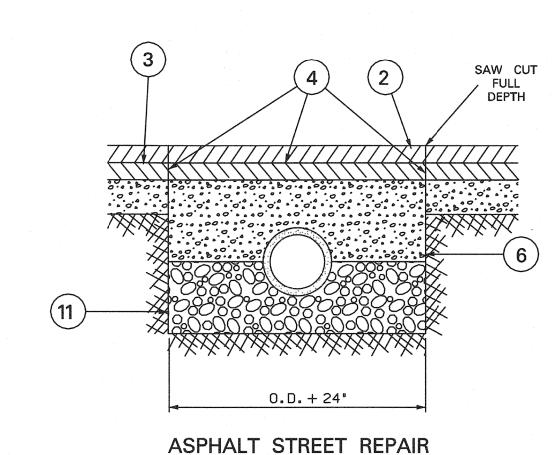


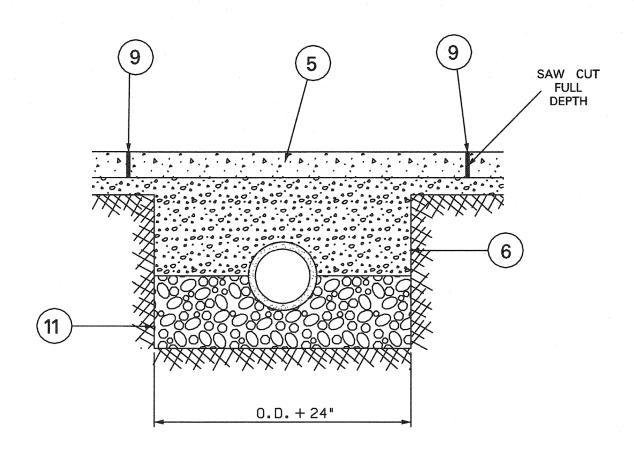

CONCRETE STREET REPAIR

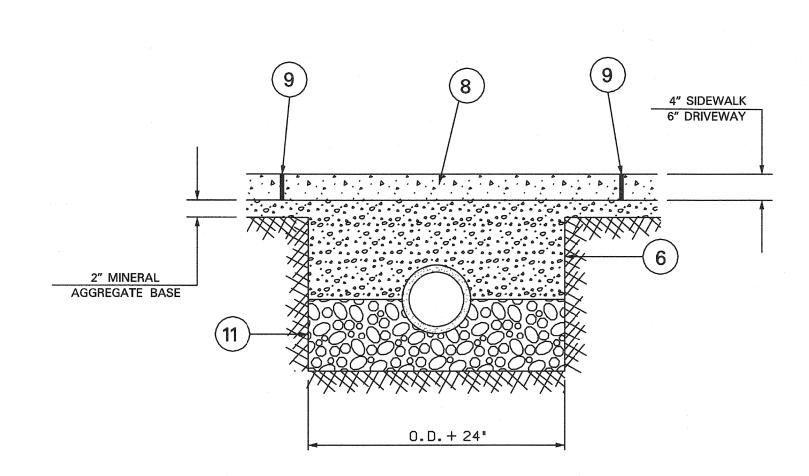

CONCRETE SIDEWALK / DRIVEWAY REPAIR

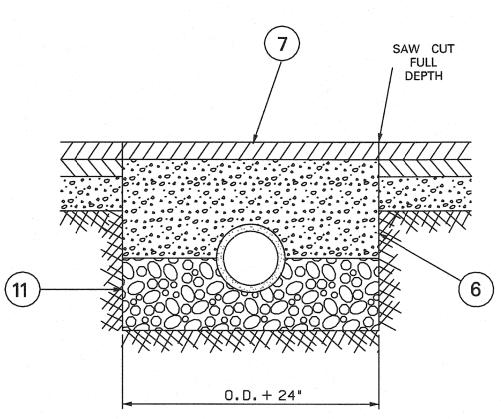


TEMPORARY ASPHALT STREET REPAIR

NOTES:

- 1. ALL SECTIONS NOTED BELOW REFERENCE THE CITY OF KNOXVILLE STANDARD SPECIFICATIONS UNLESS OTHERWISE SPECIFIED.
- 2. ASPHALTIC CONCRETE SURFACE, GRADING D, SECTION 10.0. MATCH EXISTING DEPTH OR MINIMUM THICKNESS OF ONE AND ONE-HALF (1.5)
- 3. BITUMINOUS PLANT MIX BASE, GRADING B, B-M, OR C, SECTION 9.0.
 MATCH EXISTING DEPTH OR MINIMUM THICKNESS OF TWO AND
 ONE-HALF (2.5) INCHES. THE ENTIRE FOUR (4) INCH MINIMUM DEPTH MAY
 BE ASPHALTIC CONCRETE SURFACE GRADING D, BUT SHALL
 BE COMPACTED IN TWO LIFTS.
- 4. TACK COAT, SECTION 7.0.
- 5. PORTLAND CEMENT CONCRETE PAVEMENT, SECTION 11.0. JOINTS SHALL BE DOWELED AS DETAILED IN SECTION 11.0.
- 6. MINERAL AGGREGATE BASE, CLASS A AGGREGATE GRADING D, SECTION 5.0, COMPACTED IN SIX (6) INCH LIFTS TO 100% OF THE STANDARD PROCTOR DENSITY AT 2% LESS THAN OPTIMUM MOISTURE CONTENT AS DETERMINED BY AASHTO T99, METHOD D, APPROXIMATELY 140 PCF FOR LIMESTONE.
- 7. WHEN A TEMPORARY ASPHALT PATCH IS USED, IT SHALL BE PLACED IMMEDIATELY AFTER THE MINERAL AGGREGATE BACKFILL. ALL TEMPORARY REPAIRS MUST BE REPLACED PERMANENTLY WITHIN 90 DAYS.
- 8. CONCRETE SIDEWALKS, DRIVEWAYS, AND MEDIAN STRIP, SECTION 13.0.
- 9. LIMITS OF REMOVAL SHALL BE FROM THE NEAREST EXPANSION OR CONTRACTION JOINT.
- 10. COMPACTED BACKFILL SHALL BE IN ACCORDANCE WITH SECTION 20.0.
 BACKFILL MATERIAL IN THE ROADWAY OR WITHIN FIVE (5) FEET OF THE ROADWAY,
 UNDER CURBS, GUTTERS, AND SIDEWALKS SHALL MEET THE REQUIREMENTS OF SECTION
 5.0 (MINERAL AGGREGATE BASE).
- 11. BEDDING MATERIAL, GRADING SIZE NO. 57 OR NO. 67, SHALL BE IN ACCORDANCE WITH SECTION 20.0.
- 12. EXISTING CONCRETE STREETS THAT HAVE BEEN OVERLAID WITH ASPHALT SHALL BE REPAIRED WITH ASPHALT. THE DEPTH OF THE ASPHALT REPLACING THE CONCRETE SHALL BE INCREASED 50% (PLUS ANY OVERLAY). THUS, THE TOTAL DEPTH SHALL BE 1.5 TIMES THE CONCRETE THICKNESS PLUS THE ASPHALT OVERLAY THICKNESS.

Revised: 6/3/2024

MPC FILE NUMBER: 6-SF-24-C / 6-J-24-DP

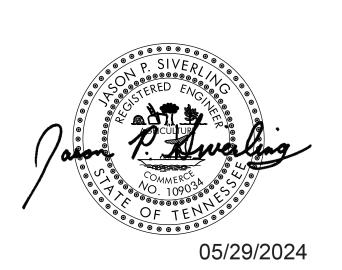

		NO SCALE				
NO.	DATE	DESCRIPTION	BY	CKD.		
REVISIONS						



ROBERT G. CAMPBELL & ASSOC., L.P. **CONSULTING ENGINEERS** KNOXVILLE, TENNESSEE

NEALS LANDING - UNIT 3

STANDARD DETAIL FOR PIPE BEDDING AND BACKFILL

GIGNED BY GMT	CHECKED BY RGC	SCALE NO SCALE
RAWN BY	DATE	FILE NO.
JPS	04-26-24	18147

NO. (8) OF EIGHT SHEETS