



ARCHITECTURAL CODE ANALYSIS AND UNIT MATRIX


APPLICABLE CODES:		UNIT AND BUILDING MATRIX
<u>CITY OF KNOXVILLE:</u> 2018 INTERNATIONAL BUILDING CODE 2018 INTERNATIONAL MECHANICAL COD 2018 INTERNATIONAL PLUMBING CODE 2017 NATIONAL ELECTRICAL CODE 2018 INTERNATIONAL FUEL GAS CODE 2018 INTERNATIONAL ENERGY CONSERV		BUILDING "A": LOWER LEVEL: UNIT TY A1 A1r B1 B1r
2018 INTERNATIONAL FIRE CODE* 2009 ICC/ANSI-117.1 ACCESSIBLE AND US CITY OF KNOXVILLE ZONING ORDINANCE		C1 C2 C2r LEVEL 1: UNIT TY
* WITH LOCAL AMENDMENTS		A1 A1r B1
CONSTRUCTION AND A FREESTANDING CONSTRUCTION. OF THE EIGHT TOTAL E BUILDING TYPES. BUILDING "A" IS A THRI BUILDING "B" IS A THREE/TWO SPLIT LEV	EE/FOUR SPLIT LEVEL BUILDING AND	B1r C1 C2 C2r LEVEL 2: UNIT TY A1 A1r B1 B1 B1r C1
OCCUPANCY TYPES:: IBC CHAPTER 3 BUILDING "A": GROUP R-2 (RESIDENT BUILDING "B": GROUP R-2 (RESIDENT LEASING: GROUP A-3 (ASSEMBLY	IAL)	C2 C2r LEVEL 3: UNIT TY A1 A1r B1
(KLERED IN ACCORDANCE WITH NFPA-13R. ILL BE FULLY SPRINKLERED IN ACCORDANCE	B1r C1 C2 C2r TOTAL:
STRUCTURAL FIRE RATINGS:: IBC TABLE EXTERIOR BEARING WALLS INTERIOR BEARING WALLS FLOORS	<u>601</u> 1-HOUR 1-HOUR 1-HOUR	(7
ROOF <u>FIRE SUPPRESSION SYSTEM:: IBC 903</u> FULLY SPRINKLERED (NFPA-13R AND NF	1-HOUR PA-13 FOR THE LEASING BUILDING)	RAJEBH K S ROJSKI R ZNEBO PARCEL ID: TOPODOT
HEIGHT AND AREA:: (ALLOWABLE PER IB	C TABLE 504.3, 504.4, 506.2)	
(R-2) OCCUPANCY TYPE (TYPE VA) AREA - STORIES - HEIGHT -	12,000 GSF 4 60'	
(A-3) OCCUPANCY TYPE (TYPE VA) AREA - STORIES - HEIGHT -	46,000 GSF 3 70'	
HEIGHT AND AREA:: (ACTUAL)		
BUILDING "A": (R-2) OCCUPANCY TYPE (AREA - LOWER LEVEL FIRST FLOOR SECOND FLOOR THIRD FLOOR STORIES - HEIGHT - 34' - 9	4,643 GSF	
	5,276 GSF 10,805 GSF 10,700 GSF 3 AT FRONT AND 2 AT REAR 34' - 10" AVERAGE BLDG. HEIGHT AT FRONT	
LEASING: (A-3) OCCUPANCY TYPE (TYPE AREA - STORIES - HEIGHT -	24'-3" AVERAGE BLDG. HEIGHT AT REAR E VA) 2,617 GSF 1 18' - 8" AVERAGE BLDG. HEIGHT	
FIRE SEPARATION DISTANCE RATINGS::	IBC TABLE 602	
BUILDING "A": GROUP R-2 OCCUPANCYFACADEDISTANCEREQUIREDNORTH30'+0SOUTH30'+0EAST20'-30'1WEST20'-30'1	PROVIDED 1 1 1	DAVID SAVIA PARCE
BUILDING "B": GROUP R-2 OCCUPANCY <u>FACADE DISTANCE REQUIRED</u> NORTH 30'+ 0 SOUTH 10'-30' 1	PROVIDED 1	
EAST15'1WEST15'1LEASING: GROUP A-3 OCCUPANCYFACADEDISTANCEREQUIRED	1 1 <u>PROVIDED</u>	STEPHEN D & DELANEYK WINSON
NORTH 30'+ 0 SOUTH 20'-30' 1 EAST 30'+ 0 WEST 20'-30' 1	1 1 1 1	PARCE
OPENING PROTECTION IS NOT REQUIRE OPENINGS WITHIN THE FIRE SEPARATIO DISTANCES IN IBC TABLE 705.8 SINCE TH IS FULLY SPRINKLERED PER NFPA 13R.	N	BRYANT K.S. HEATWERL GILLING PARCEL D. 1350000T
PROTECTED OPENING REQUIREMENTS:	BC TABLE 705.8	
DISTANCEALLOWED30'+NO LIMIT25'-30'NO LIMIT20'-25'NO LIMIT		JOAN B INFRIGAM PARCEL DI: 1500000
15'-20' 75% 10'-15' 45%		

1

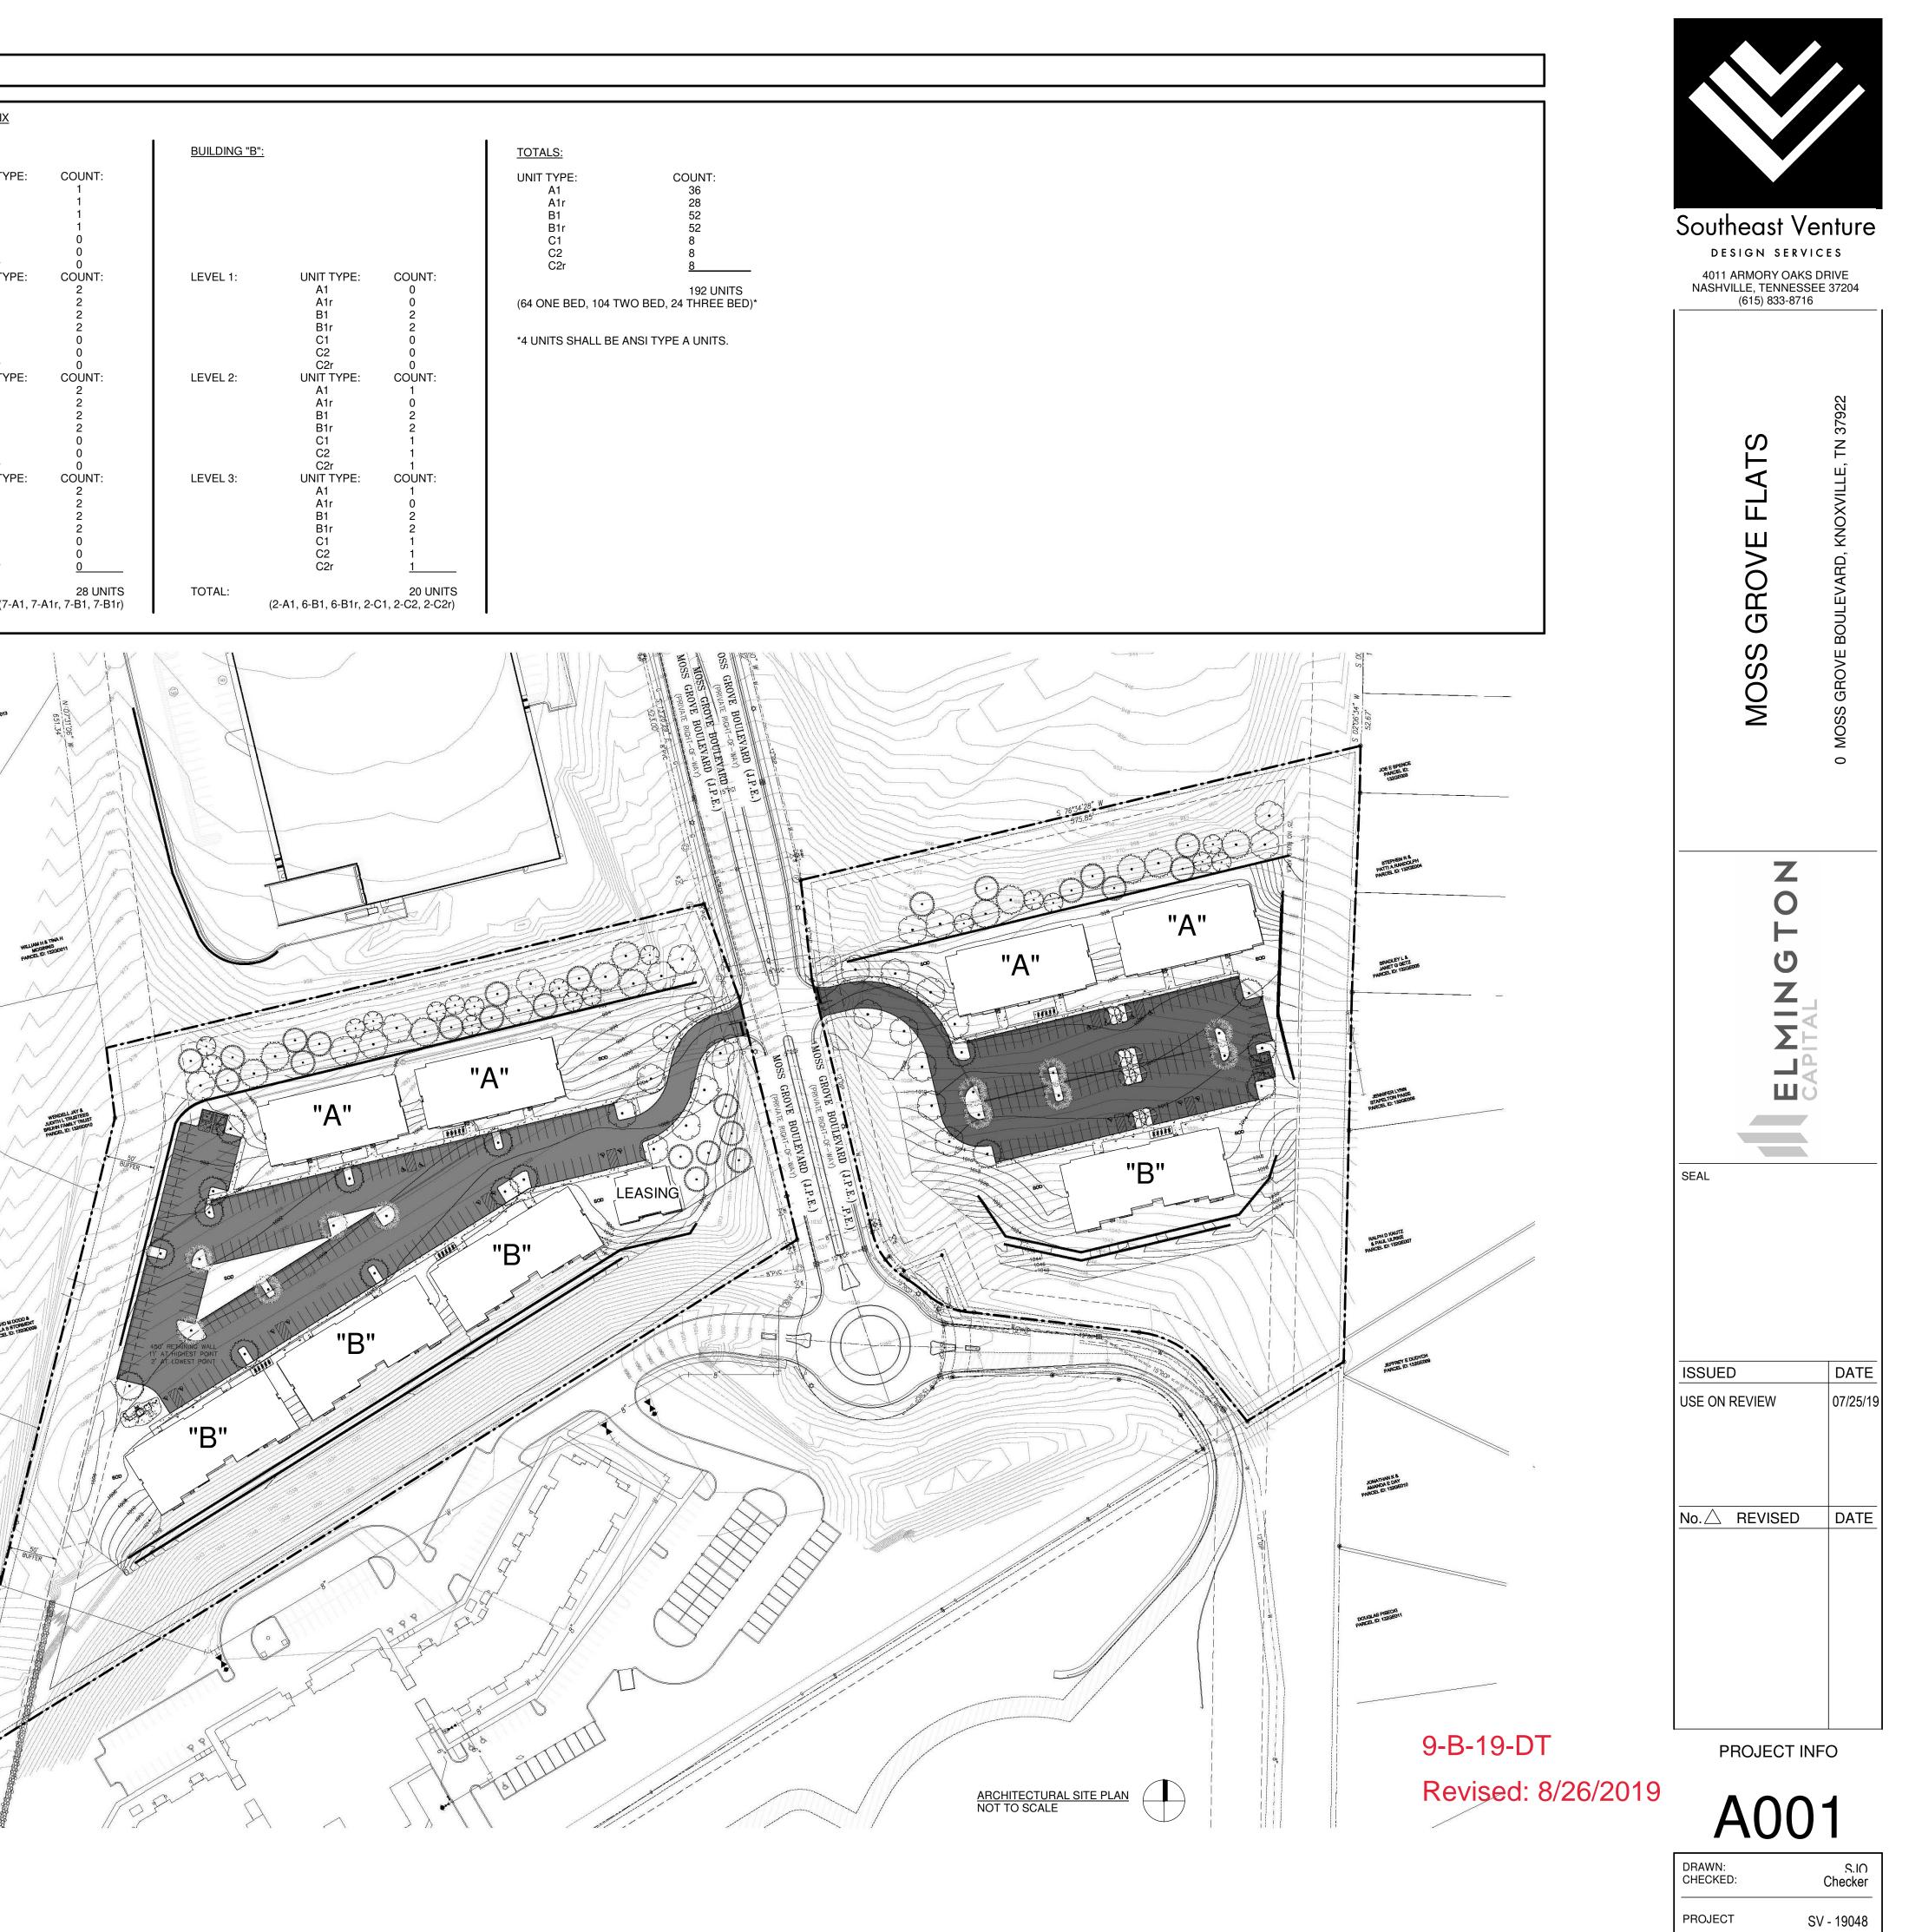


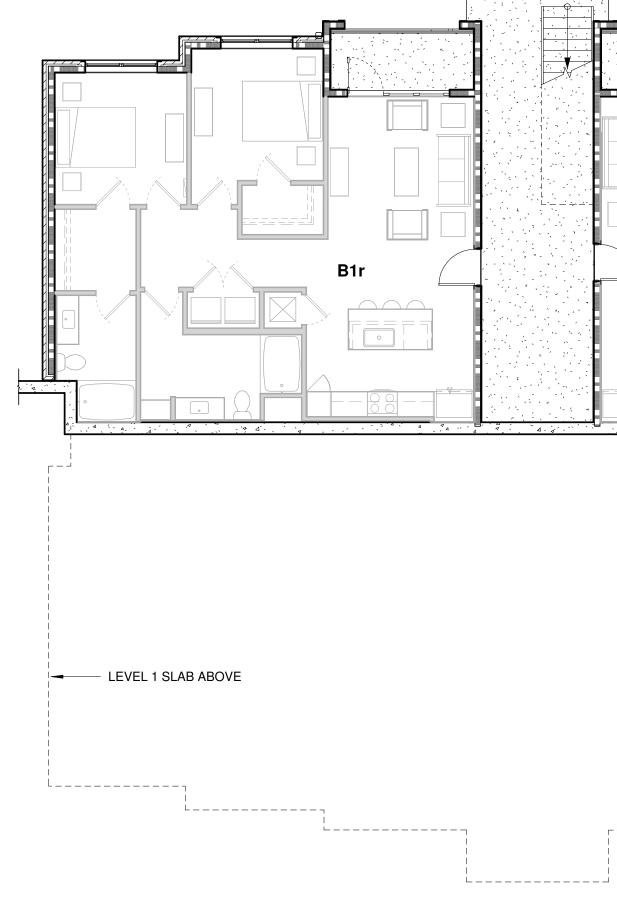

1/8" = 1'-0"

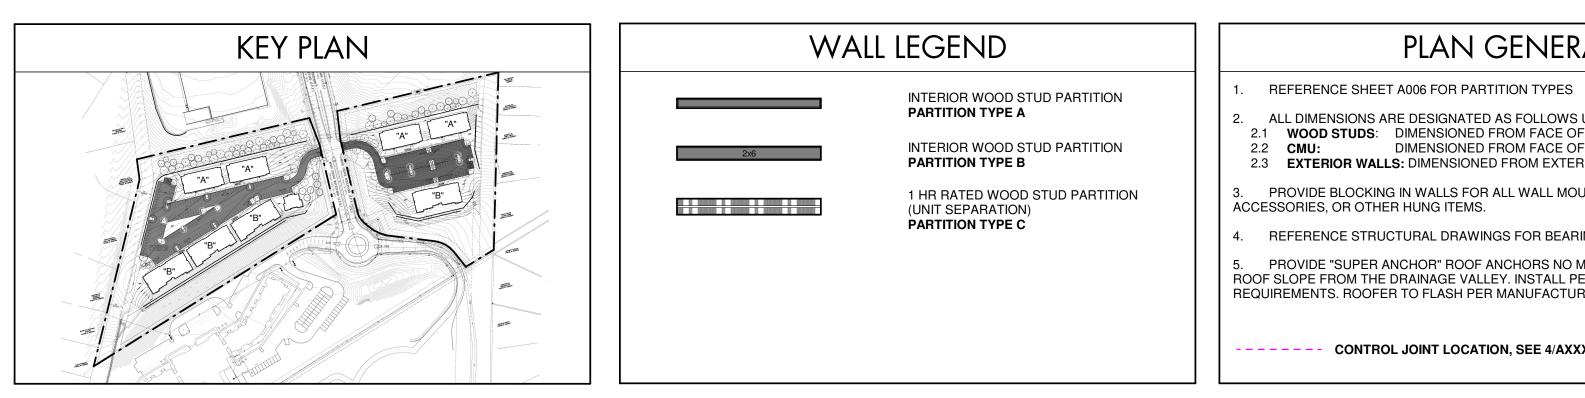



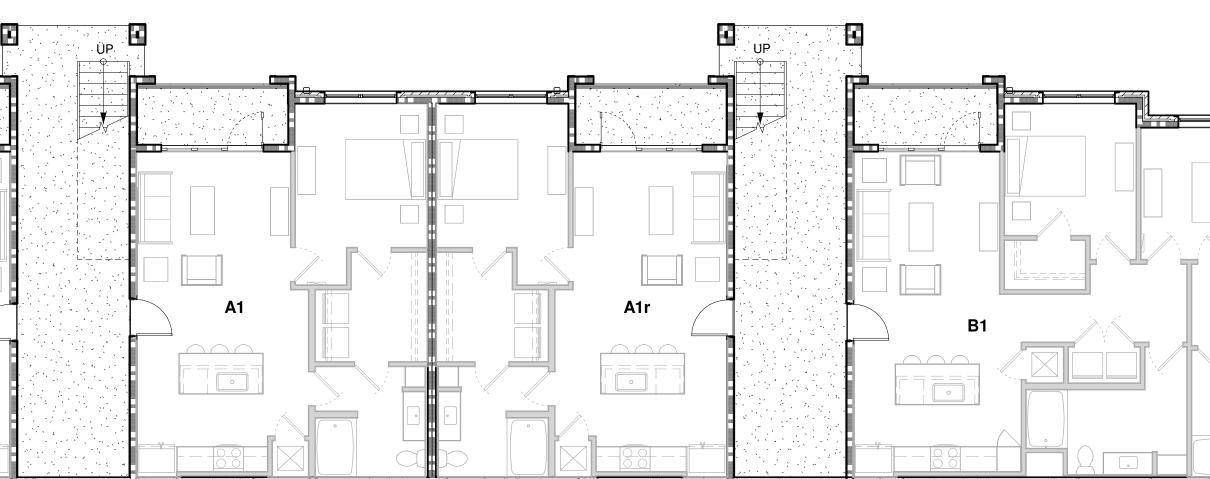


r------_____ L_____ _____

L_____

NORTH SIDE

1 A300

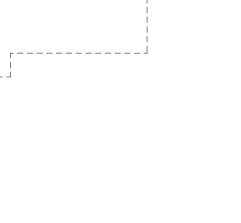

PLAN GENERAL NOTES

ALL DIMENSIONS ARE DESIGNATED AS FOLLOWS UNLESS SPECIFICALLY NOTED OTHERWISE:
2.1 WOOD STUDS: DIMENSIONED FROM FACE OF STUD TO FACE OF STUD
2.2 CMU: DIMENSIONED FROM FACE OF CMU BLOCK
2.3 EXTERIOR WALLS: DIMENSIONED FROM EXTERIOR FACE OF STUD

3. PROVIDE BLOCKING IN WALLS FOR ALL WALL MOUNTED HANDRAILS, CASEWORK, TOILET ACCESSORIES, OR OTHER HUNG ITEMS.

4. REFERENCE STRUCTURAL DRAWINGS FOR BEARING WALL CONDITIONS 5. PROVIDE "SUPER ANCHOR" ROOF ANCHORS NO MORE THAN 30'-0" O.C. AND HALF WAY UP THE ROOF SLOPE FROM THE DRAINAGE VALLEY. INSTALL PER MANUFACTURER'S AND OSHA REQUIREMENTS. ROOFER TO FLASH PER MANUFACTURER'S REQUIREMENTS.


---- CONTROL JOINT LOCATION, SEE 4/AXXX FOR DETAILS


9-B-19-DT Revised: 8/26/2019

Southeast V DESIGN SERV 4011 ARMORY OAKS NASHVILLE, TENNESS (615) 833-8716	I C E S DRIVE EE 37204
MOSS GROVE FLATS	0 MOSS GROVE BOULEVARD, KNOXVILLE, TN 37922
SEAL	
ISSUED USE ON REVIEW	DATE 07/25/1
No. A REVISED	DATE
BLDG. A - LO LEVEL FLOOR A20	PLAN

PROJECT

SV - 19048

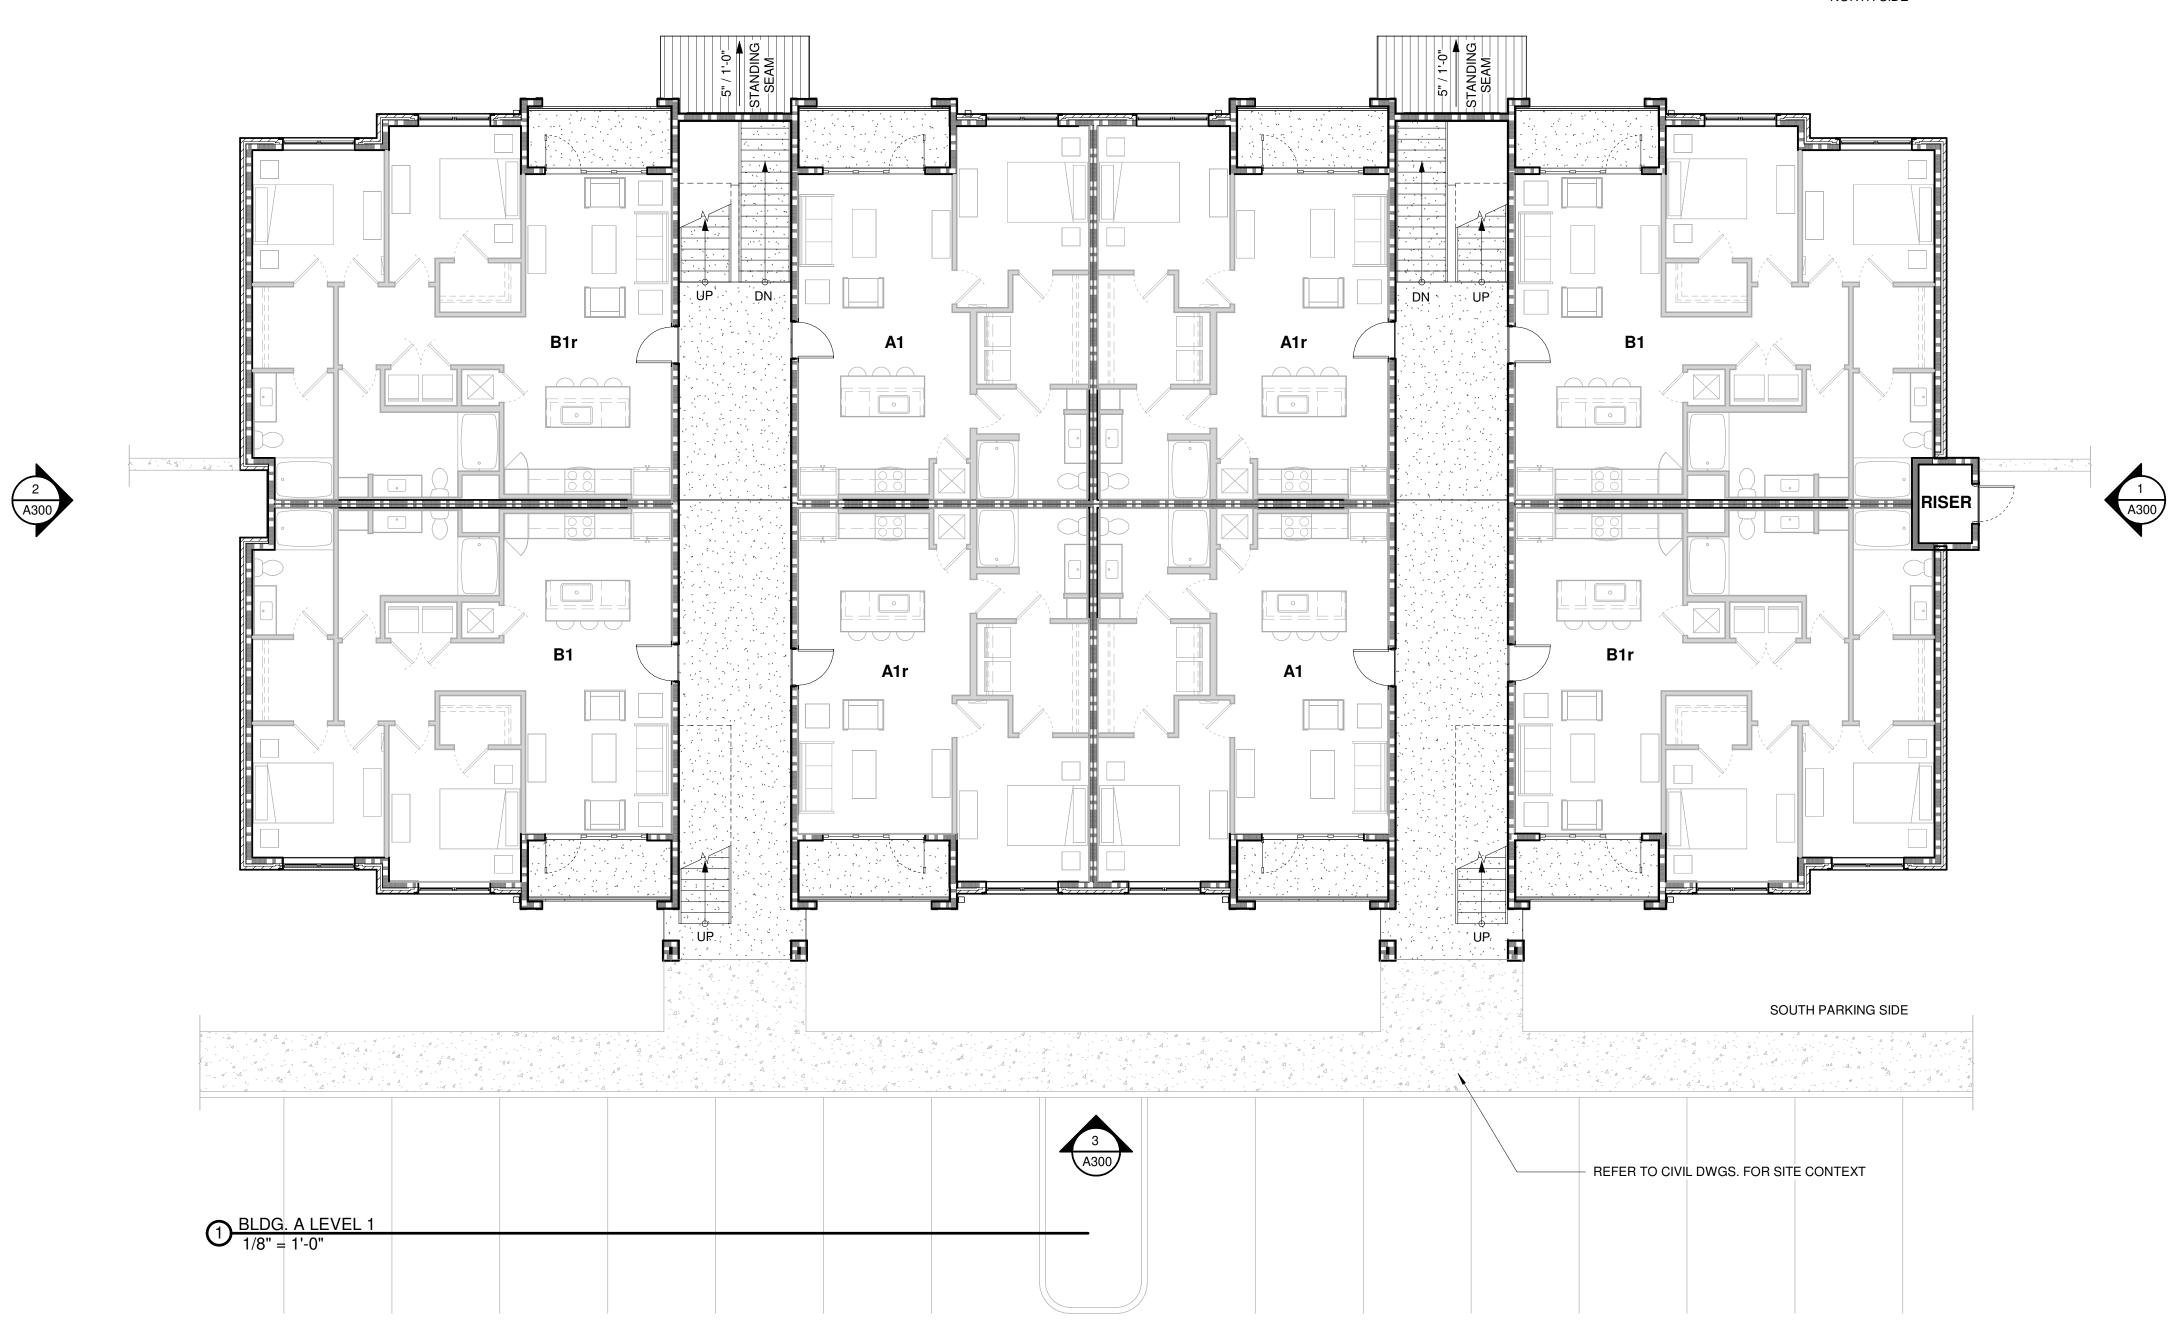

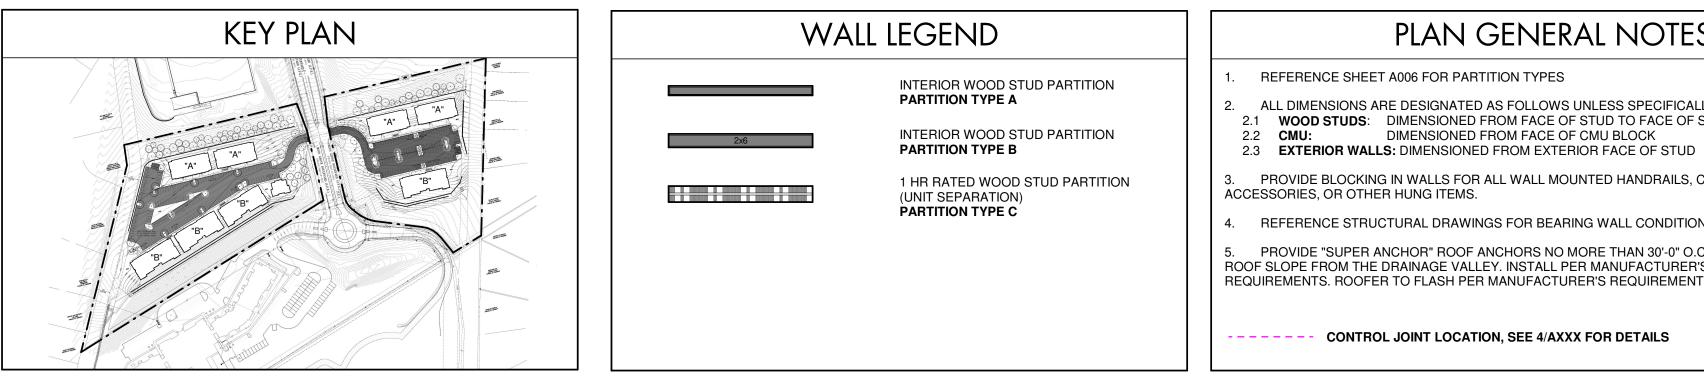

NORTH SIDE

PLAN GENERAL NOTES

ALL DIMENSIONS ARE DESIGNATED AS FOLLOWS UNLESS SPECIFICALLY NOTED OTHERWISE:
2.1 WOOD STUDS: DIMENSIONED FROM FACE OF STUD TO FACE OF STUD
2.2 CMU: DIMENSIONED FROM FACE OF CMU BLOCK

3. PROVIDE BLOCKING IN WALLS FOR ALL WALL MOUNTED HANDRAILS, CASEWORK, TOILET

4. REFERENCE STRUCTURAL DRAWINGS FOR BEARING WALL CONDITIONS

5. PROVIDE "SUPER ANCHOR" ROOF ANCHORS NO MORE THAN 30'-0" O.C. AND HALF WAY UP THE ROOF SLOPE FROM THE DRAINAGE VALLEY. INSTALL PER MANUFACTURER'S AND OSHA REQUIREMENTS. ROOFER TO FLASH PER MANUFACTURER'S REQUIREMENTS.


---- CONTROL JOINT LOCATION, SEE 4/AXXX FOR DETAILS

9-B-19-DT Revised: 8/26/2019

D E S 4011 A	ARMORY OAH (615) 833-87	(S DRIVE SEE 37204
	MOSS GROVE FLATS	0 MOSS GROVE BOULEVARD, KNOXVILLE, TN 37922
SEAL	ELMINGTON	CAPITAL
ISSUED USE ON F		DATE 07/25/1
No.	REVISED	DATE
BLDG.	A - FIRS PLAN	T FLOOR

PROJECT

SV - 19048

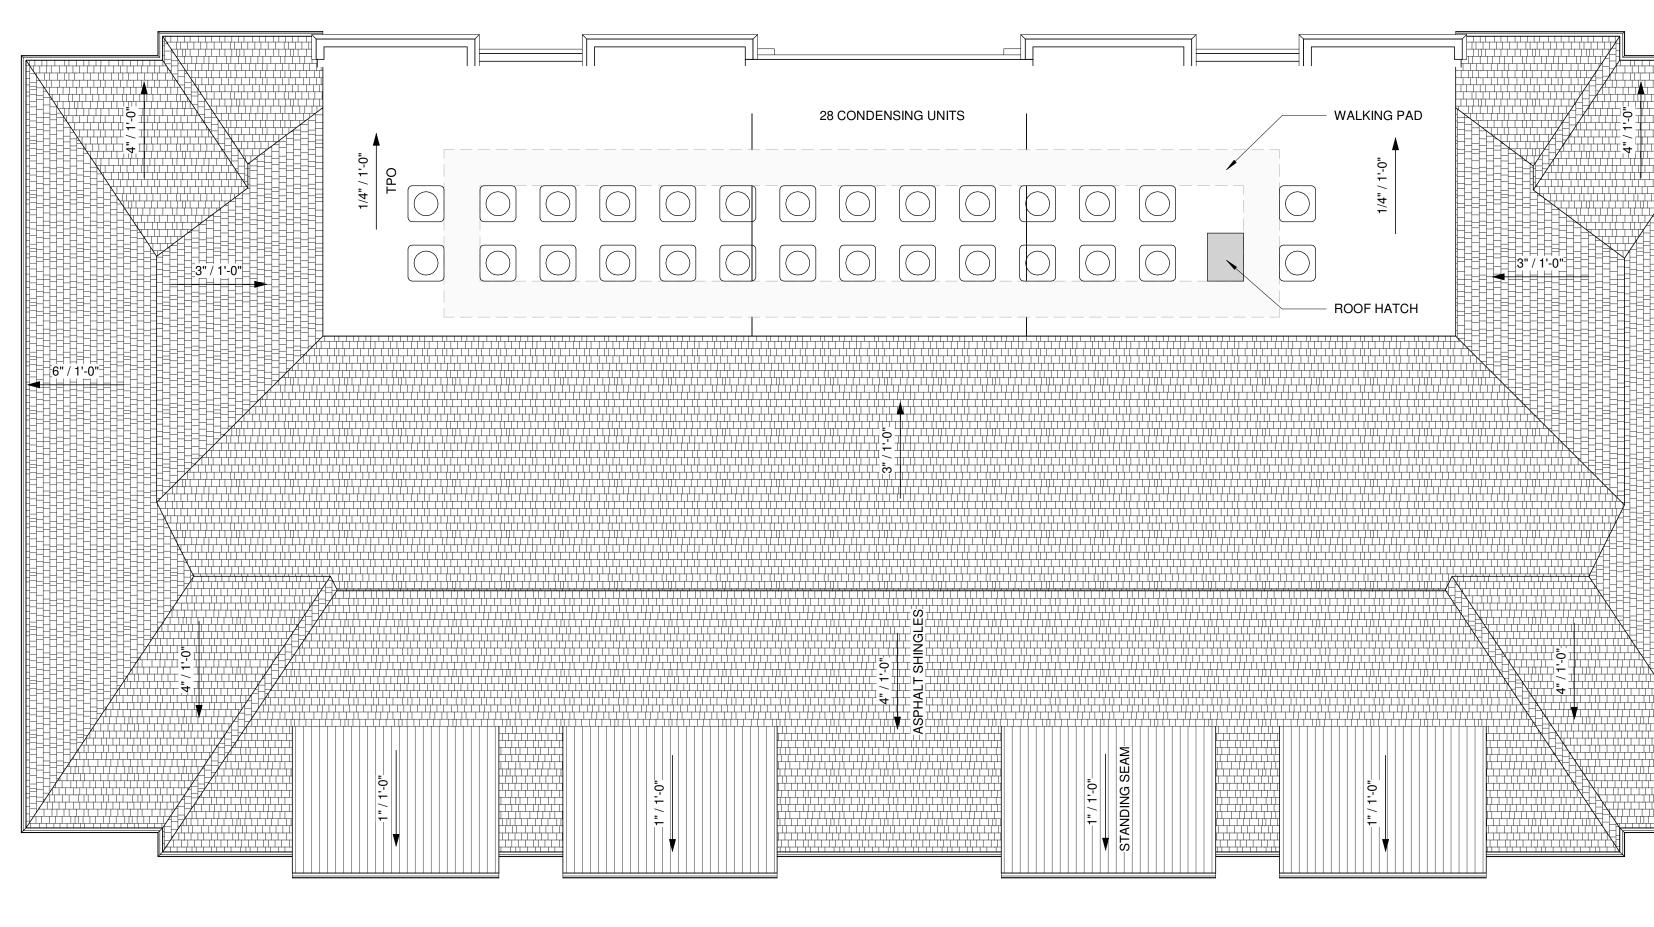


1 BLDG. A ROOF PLAN 1/8" = 1'-0"




SOUTH PARKING SIDE



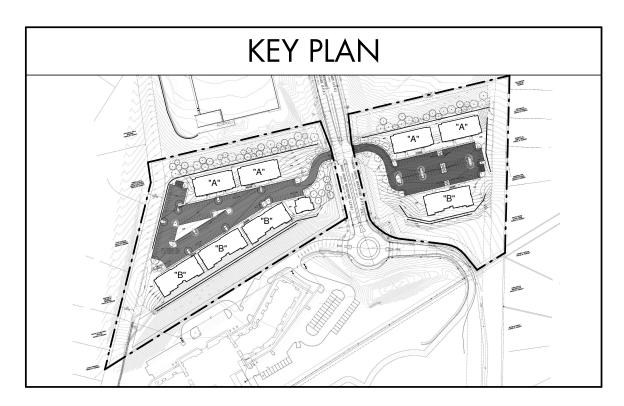



NORTH	SIDE

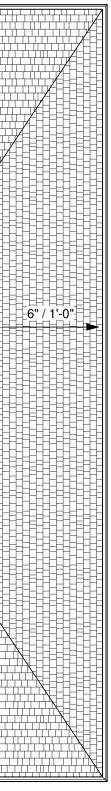



1 A300

9-B-19-DT Revised: 8/26/2019

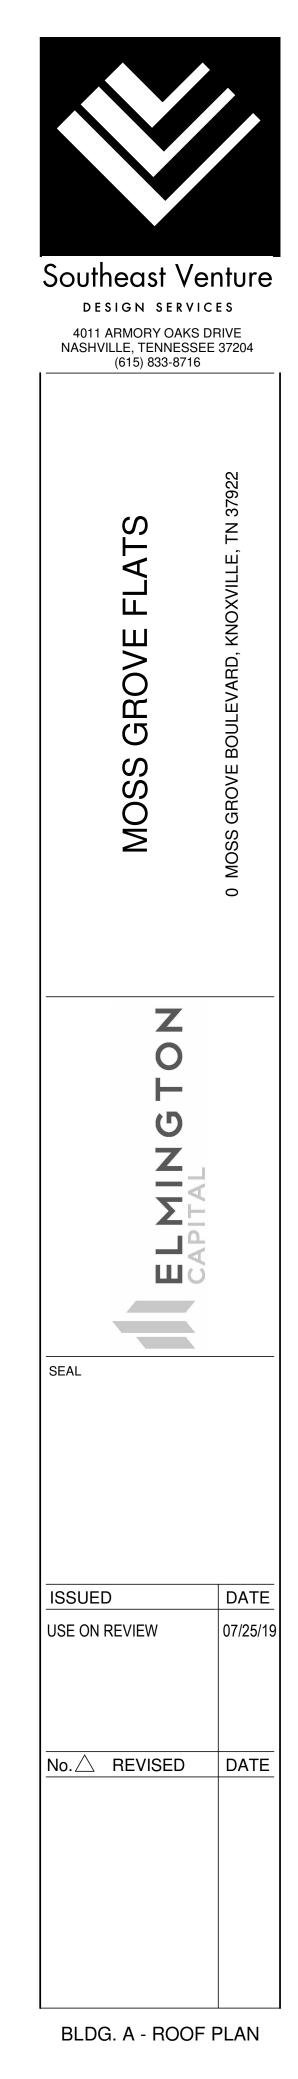

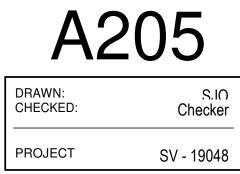

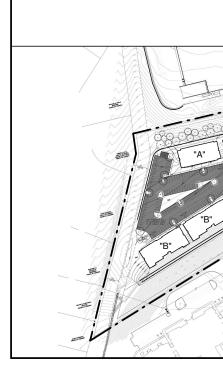


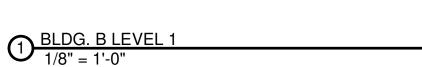



- LEVEL 2 SLAB ABOVE

L_____



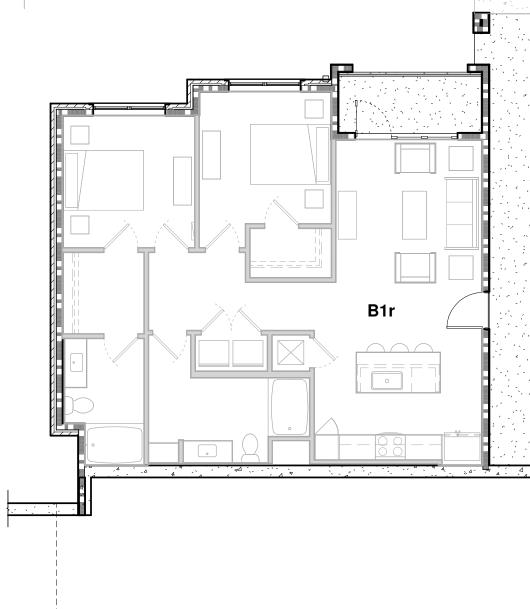

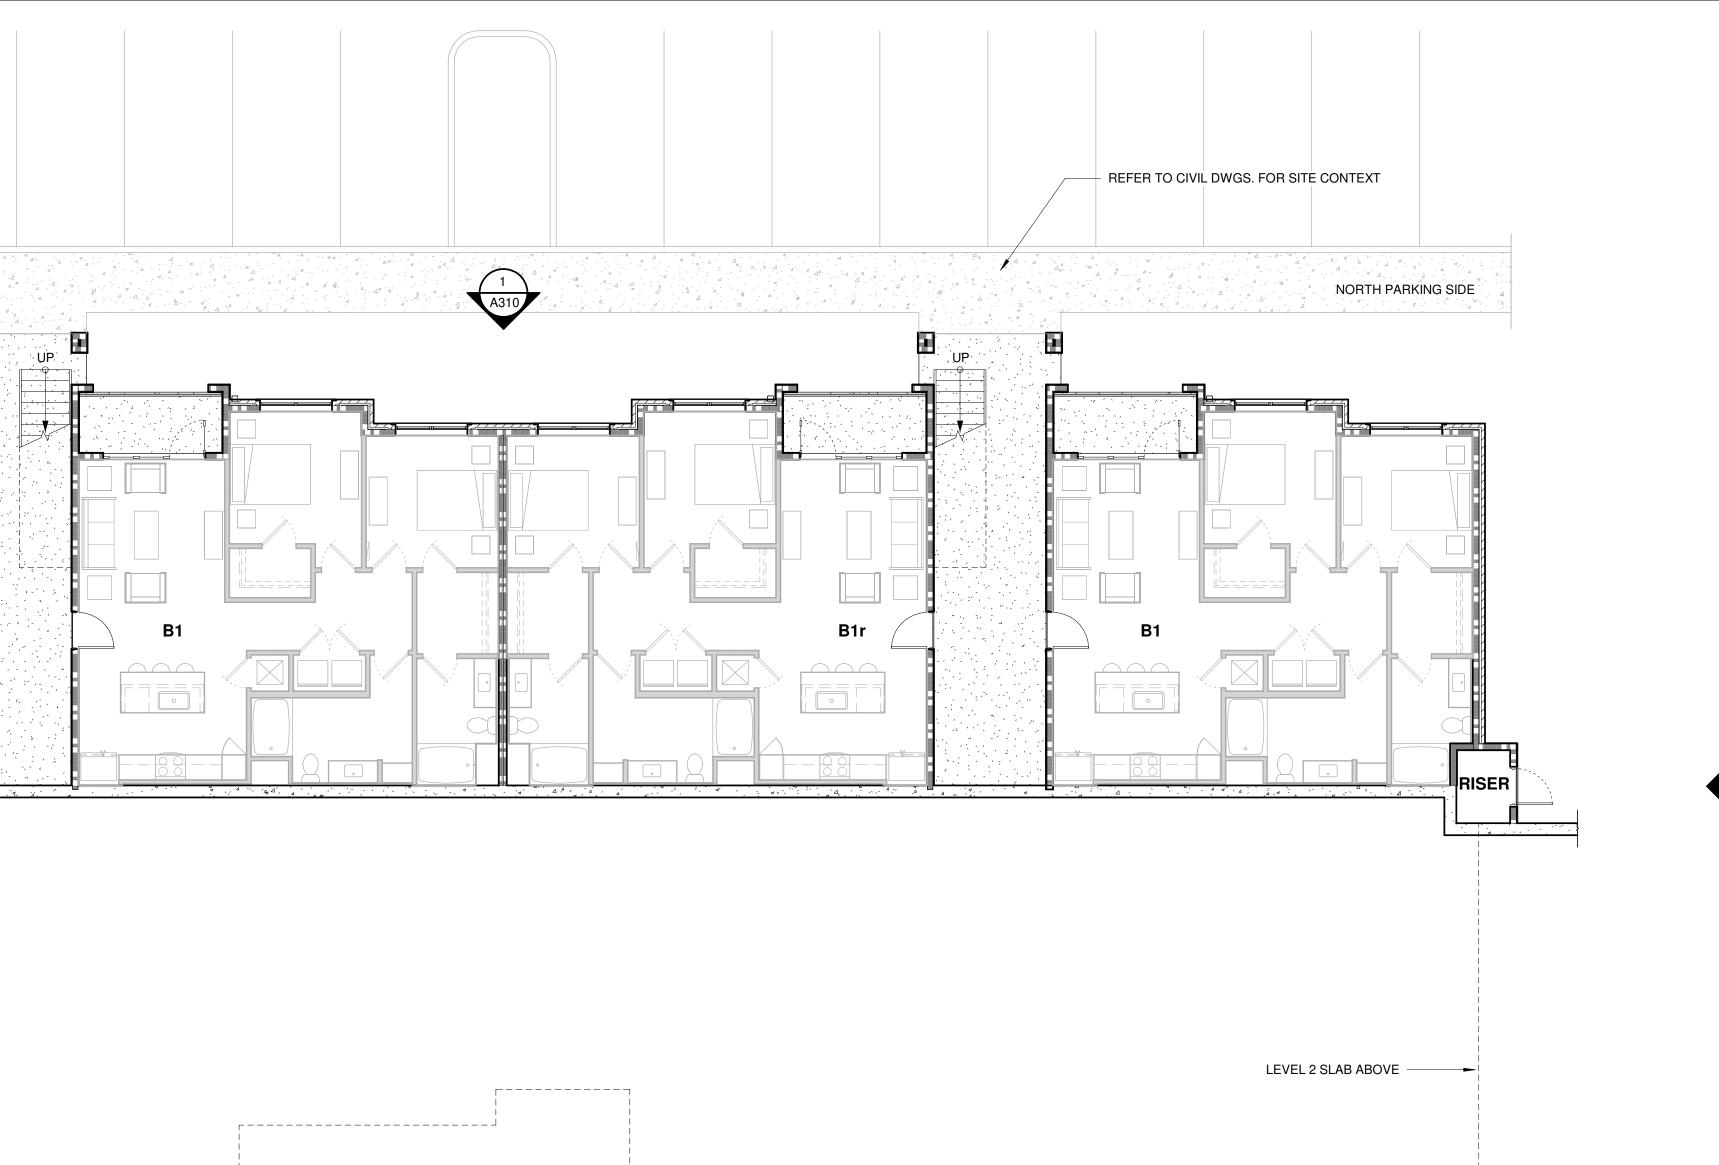

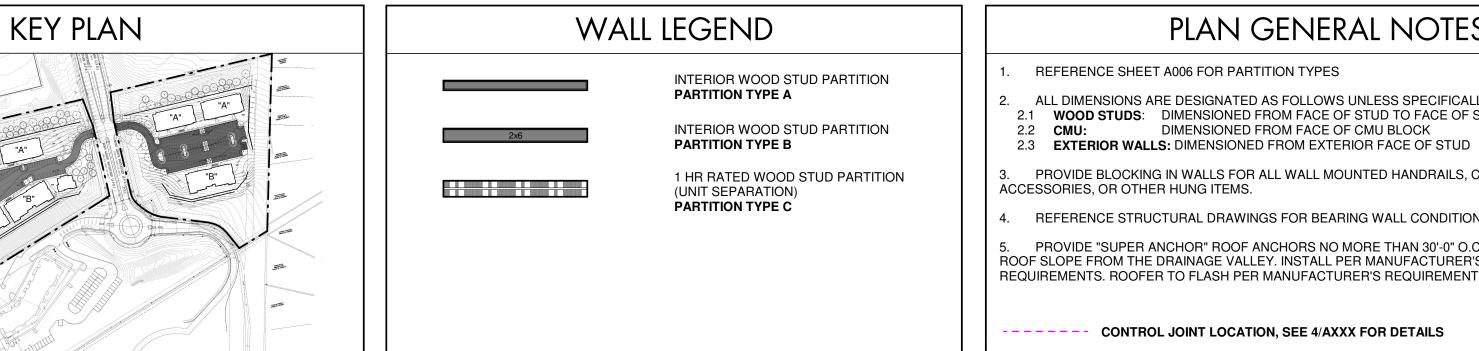

L_____



PLAN GENERAL NOTES

L_____

L_____

 ALL DIMENSIONS ARE DESIGNATED AS FOLLOWS UNLESS SPECIFICALLY NOTED OTHERWISE:
2.1 WOOD STUDS: DIMENSIONED FROM FACE OF STUD TO FACE OF STUD 2.2 CMU: DIMENSIONED FROM FACE OF CMU BLOCK


3. PROVIDE BLOCKING IN WALLS FOR ALL WALL MOUNTED HANDRAILS, CASEWORK, TOILET ACCESSORIES, OR OTHER HUNG ITEMS.

4. REFERENCE STRUCTURAL DRAWINGS FOR BEARING WALL CONDITIONS 5. PROVIDE "SUPER ANCHOR" ROOF ANCHORS NO MORE THAN 30'-0" O.C. AND HALF WAY UP THE ROOF SLOPE FROM THE DRAINAGE VALLEY. INSTALL PER MANUFACTURER'S AND OSHA REQUIREMENTS. ROOFER TO FLASH PER MANUFACTURER'S REQUIREMENTS.

---- CONTROL JOINT LOCATION, SEE 4/AXXX FOR DETAILS


9-B-19-DT Revised: 8/26/2019


3 A310

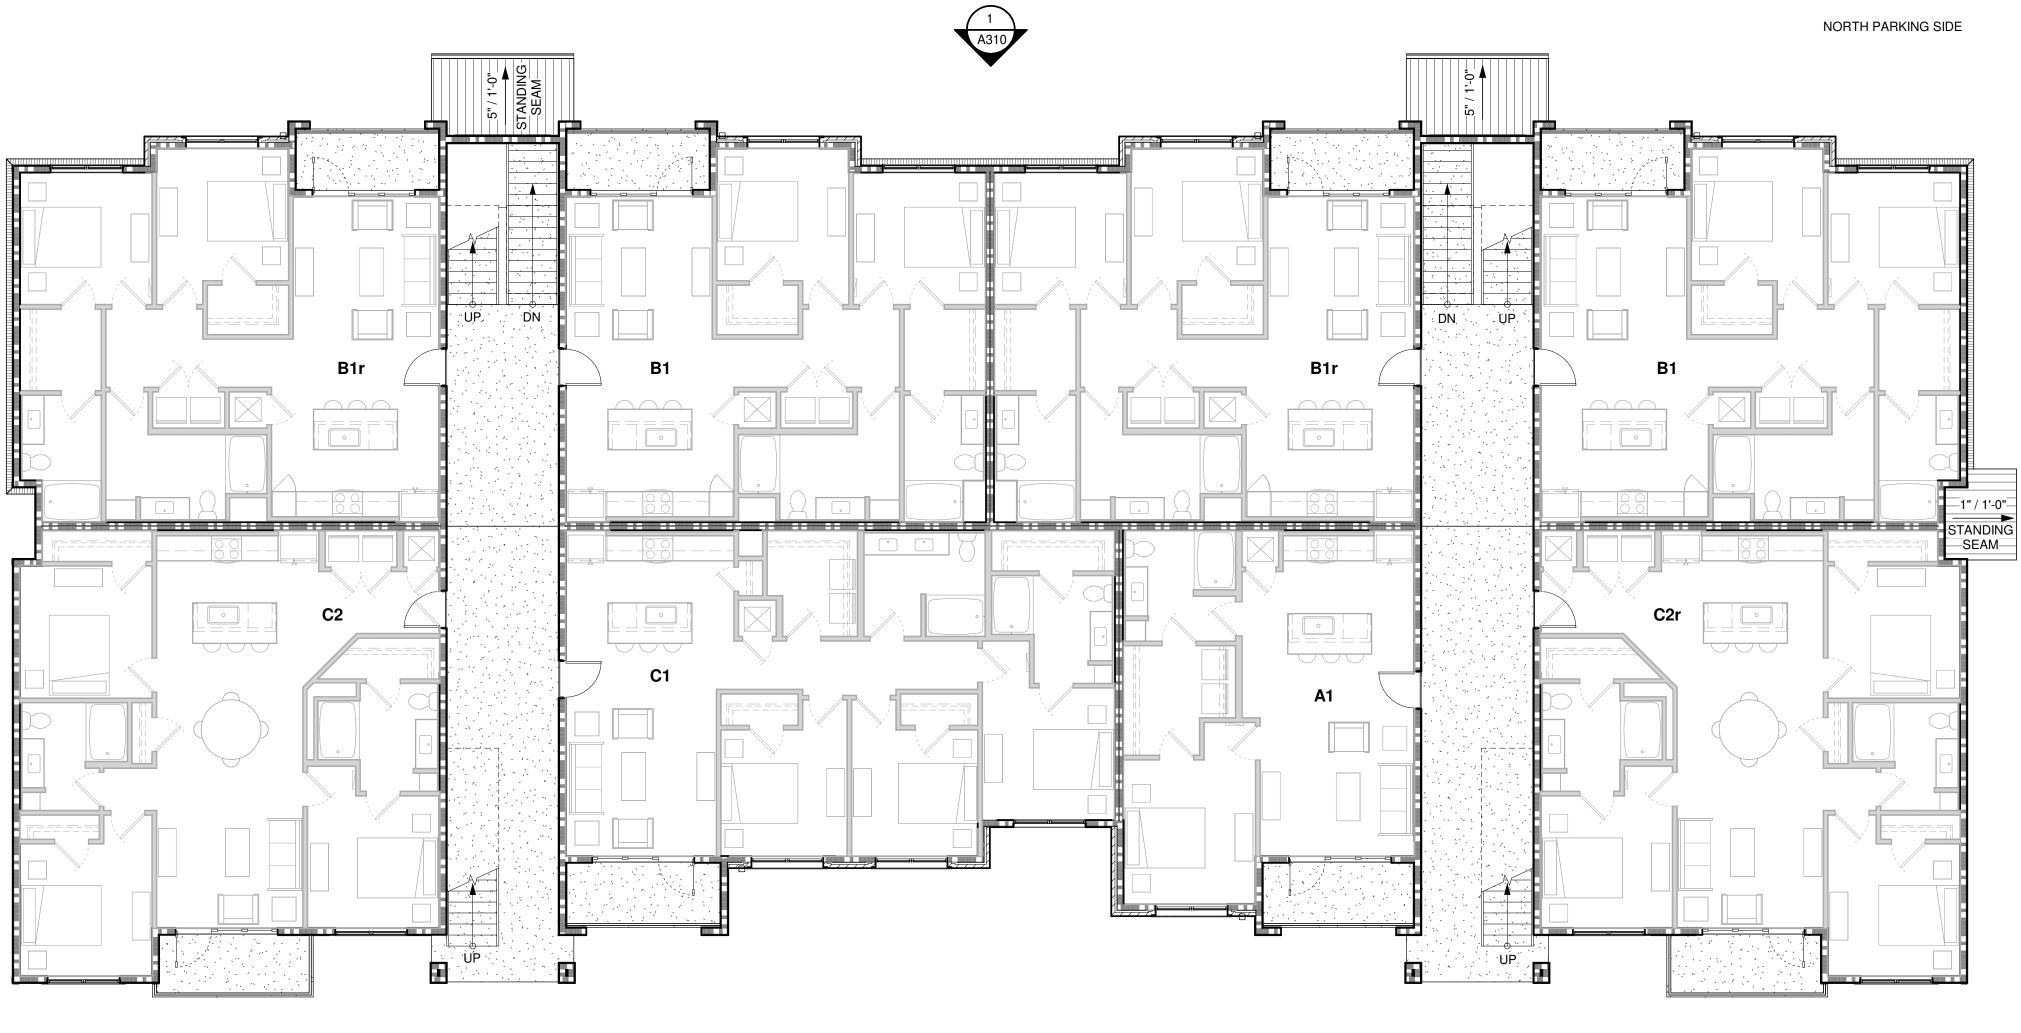



1/8" = 1'-0"

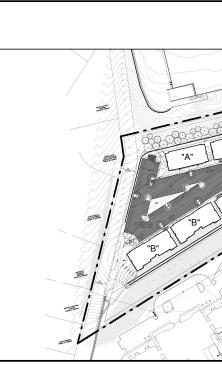

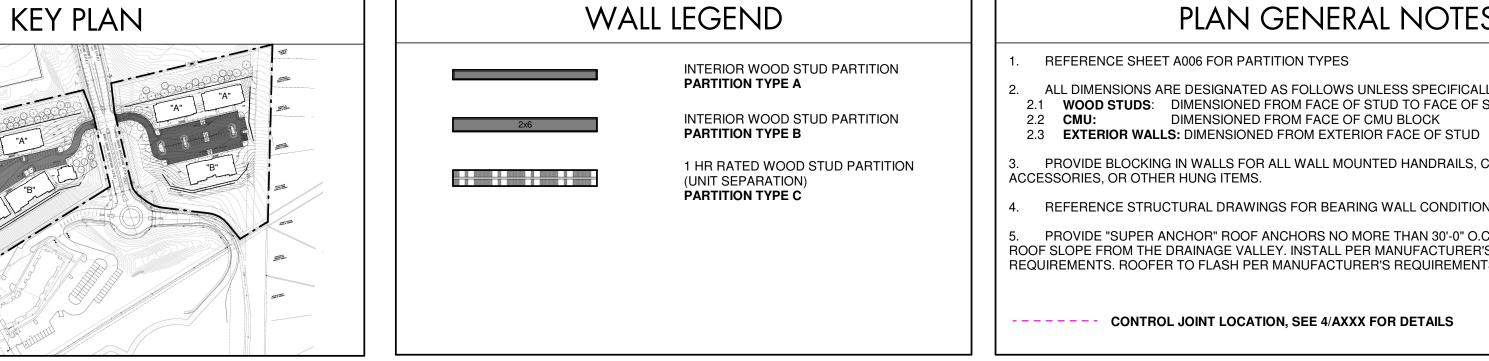

SOUTH SIDE

PLAN GENERAL NOTES

ALL DIMENSIONS ARE DESIGNATED AS FOLLOWS UNLESS SPECIFICALLY NOTED OTHERWISE:
2.1 WOOD STUDS: DIMENSIONED FROM FACE OF STUD TO FACE OF STUD
2.2 CMU: DIMENSIONED FROM FACE OF CMU BLOCK

3. PROVIDE BLOCKING IN WALLS FOR ALL WALL MOUNTED HANDRAILS, CASEWORK, TOILET ACCESSORIES, OR OTHER HUNG ITEMS.


4. REFERENCE STRUCTURAL DRAWINGS FOR BEARING WALL CONDITIONS 5. PROVIDE "SUPER ANCHOR" ROOF ANCHORS NO MORE THAN 30'-0" O.C. AND HALF WAY UP THE ROOF SLOPE FROM THE DRAINAGE VALLEY. INSTALL PER MANUFACTURER'S AND OSHA REQUIREMENTS. ROOFER TO FLASH PER MANUFACTURER'S REQUIREMENTS.

---- CONTROL JOINT LOCATION, SEE 4/AXXX FOR DETAILS

9-B-19-DT Revised: 8/26/2019

3 A310




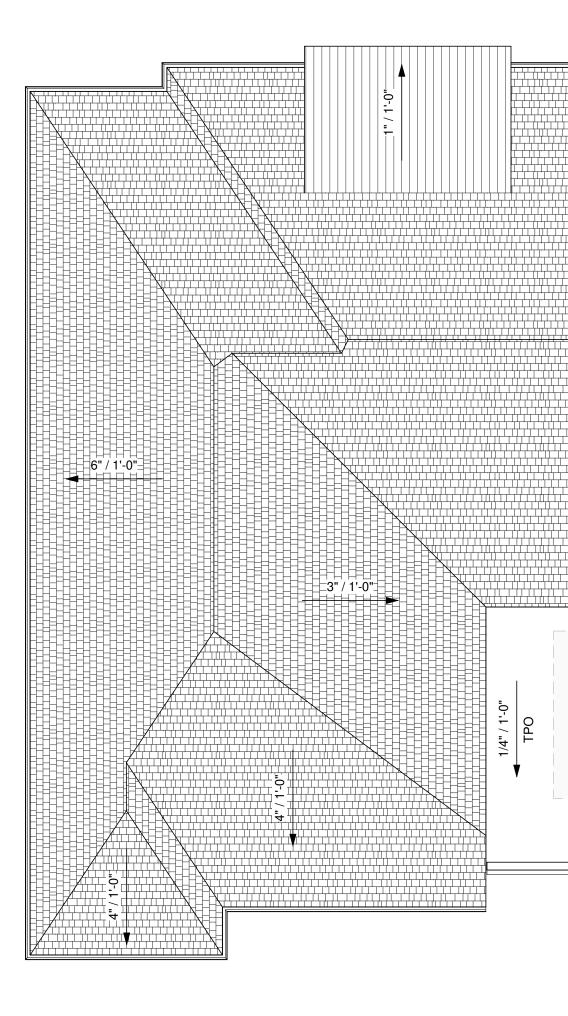



1/8" = 1'-0"







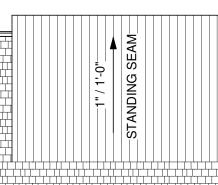

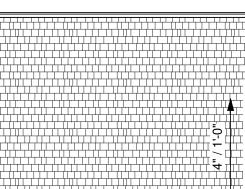

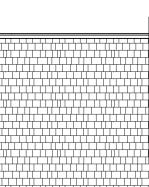


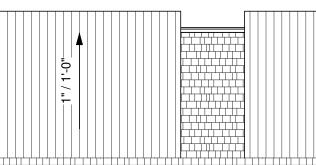


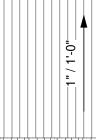

	ROOF HATCH	
20 CONDENSING UNITS	1/4" / 1'-0"	
WALKING PAD		



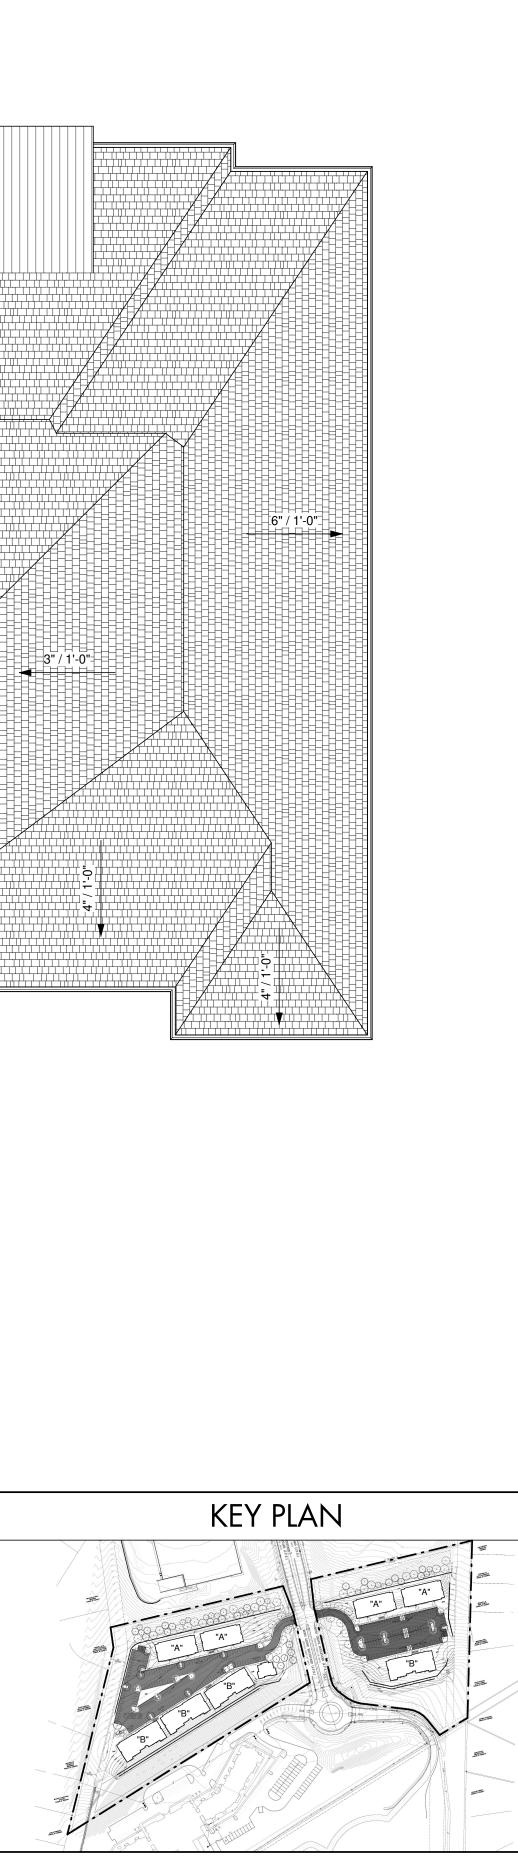

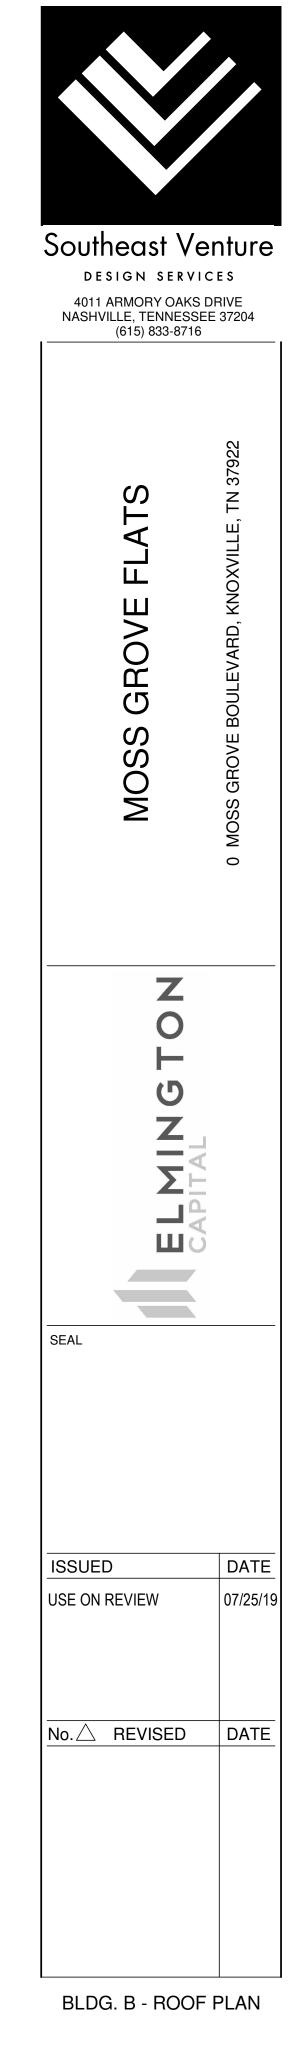


A214 DRAWN: CHECKED: S.IO Checker PROJECT SV - 19048




Revised: 8/26/2019

9-B-19-DT

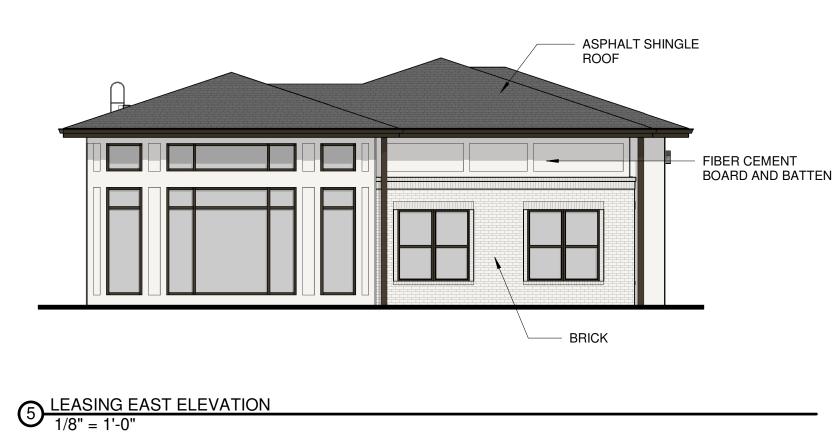



 $3 \frac{\text{LEASING SOUTH ELEVATION}}{1/8" = 1'-0"}$

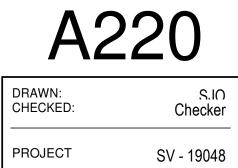

Revised: 8/26/2019







BLDG. A WEST ELEVATION 1/8" = 1'-0"

BLDG. A - ELEVATIONS

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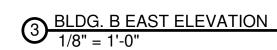
ELM CAPITAL


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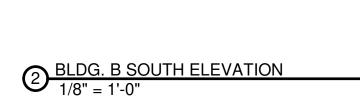
07/25/19

DATE

A300 DRAWN: CHECKED: S.IO Checker PROJECT SV - 19048





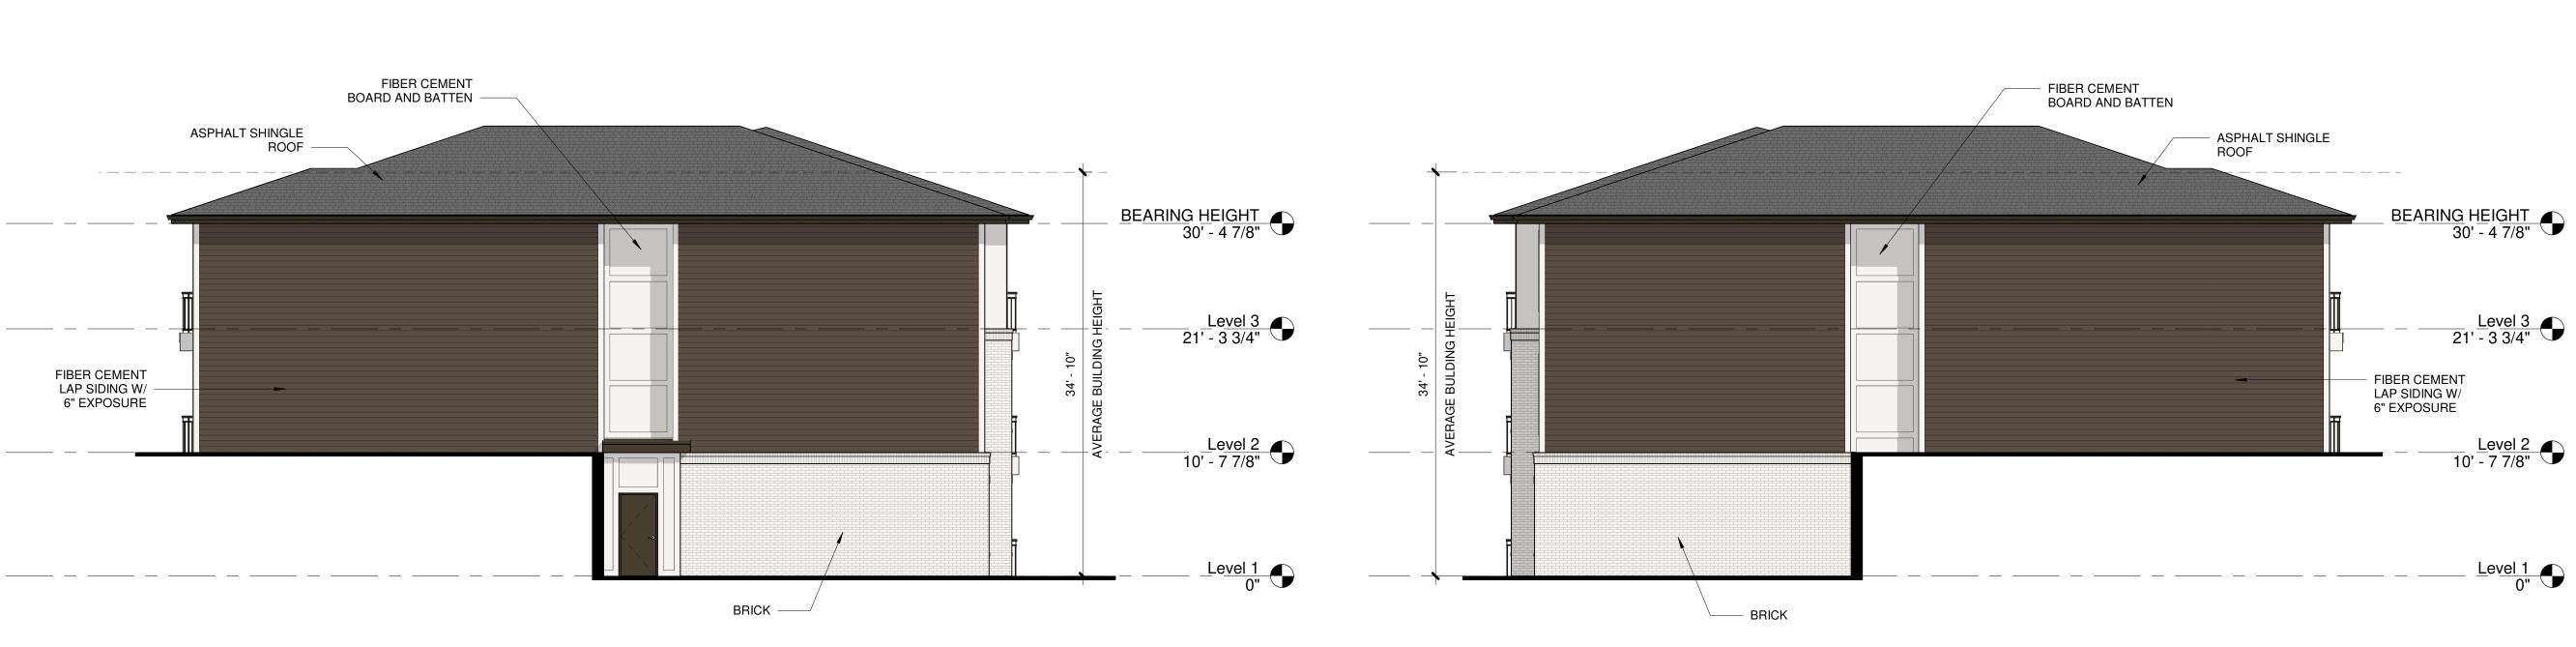







 $4 \frac{\text{BLDG. B WEST ELEVATION}}{1/8" = 1'-0"}$

9-B-19-DT Revised: 8/26/2019

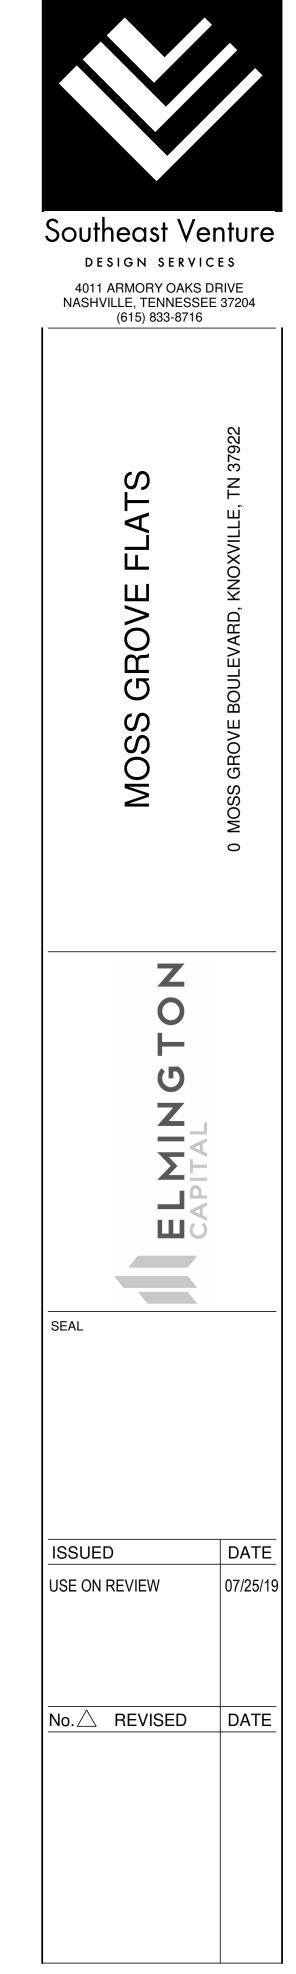

BLDG. B - ELEVATIONS

A310 DRAWN: CHECKED: S.IO Checker PROJECT SV - 19048 User Friendly Radius Edges 3-D Appearance Self Aligning Corners No Sawing At Corners Eliminates The Need To Stay On Bond Random Look Without Multiple Sizes Guaranteed Speedy Delivery And Service

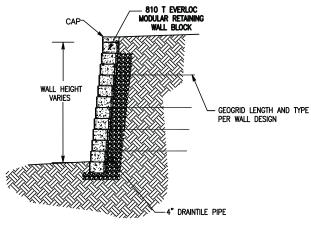

9-B-19-UR Revised: 8/26/2019

AVAILABLE COLORS






Sienna




Copper

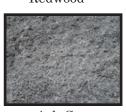

Ash Gray

810 T RETAINING WALL DETAIL N.T.S.

For reinforced walls, ask about Geogrid reinforcement. Geogrid can be purchased from E. Dillon & Company and delivered to your jobsite along with **EVERLOC**[®] units.

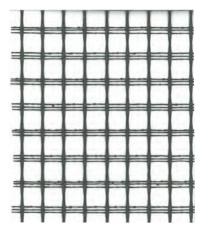

TO PLACE ORDERS OR TO INQUIRE ABOUT SHIPMENTS PLEASE CONTACT: EVERLOC® RETAINING WALLS CUSTOMER SERVICE CENTER P O BOX 160 SWORDS CREEK, VA 24649 PH: (877) 622-9255 FAX: (276) 873-5688 EMAIL - EVERLOC@EDILLON.COM

WEBSITE: WWW.EVERLOCRETAININGWALLS.COM



AN AMERICAN OWNED COMPANY SINCE 1868





WAL ETAI NIN G

WALL UNITS

833 Utility 8"h x 12"d x 6"l 72 block / cube 33 ft²

Corner 8"h x 9"d x 12"l setback 3/4" 45 block / cube 1.2 ft²

810T and 810F 8"h x 12"d x 18"l setback 3/4" 34 block / cube 1.0 ft²

Cap setback 3/8" 4"h x 12"d x 18"l 32 block / cube .5 ft²

.5 ft²

450T and 450F 425 Half 4"h x 12"d x 18"l 4"h x 12"d x 9"l setback 3/8" 64 block / cube 96 block / cube

417 Utility 4"h x 12"d x 6"l 17 ft²

-B-19-UR

evised: 8/26/2019

Half High Corner 4" h x 9" dx 12" l setback 3/8" 144 block / cube 90 block / cube 0.6 ft²

ERLOC EXPRESS™ UNITS WEATHERDOME™ UNITS

810T and 810F Everloc Express™ 8"h x 9"d x 18"l setback 3/4" 40 block / cube 1.0 ft²

850 Half

.5 ft²

8"h x 12"d x 9"l

48 block / cube

450T and 450F Everloc Express™ 4"h x 9"d x 18"l setback 3/8" 80 block / cube .5 ft²

WeatherDome™ Fence Cap 3-3/4"h x16-1/3"d x 9"l 48 block / cube .19 ft²x2

WeatherDome™ Column Cap 4-5/8"h x 23"d x 7-1/2"l 45 block / cube .16 ft²x2

WeatherDome[™] Wall Cap 3-3/4"h x 12"d x 9"l, 80 block / cube, .19ft²x2