

SITE DEVELOPMENT PLANS



FOR

CHICK-FIL-A, INC.

62 INDOOR SEATS PROVIDED

2187 GREENLAND WAY,


KNOXVILLE, TN 37932

Revision 8-30-2023 9-B-23-TOB / 9-C-23-DP

AUGUST 28, 2023


ACTIVITY SCHEDULE											
TASK DESCRIPTION:	MONTHS: (2019)										
	Start Date: June 1, 2019										
	JUNE	JULY	AUGUST	SEPTEMBER							
	1	2	3	4							
CONSTRUCTION EXIT AND PERIMETER SILT FENCE	X										
TEMPORARY SEDIMENT STORAGE FACILITIES	X										
CLEARING & GRUBBING	X										
ROUGH GRADING	X										
TEMPORARY STABILIZATION (GRASSING)		X									
CURB AND GUTTER		X	X								
GRAVEL SUBBASE FOR ROADS AND PARKING AREAS			X								
BUILDING CONSTRUCTION		X	X	X							
FINAL GRADING				X							
PAVING				X							

CONSTRUCTION NOTES:  
ANTICIPATED START PROJECT DATE XXXX  
ANTICIPATED COMPLETE PROJECT DATE XXX  
1. INSTALL EROSION CONTROL FENCE  
2. DEMOLITION  
3. CONSTRUCT STORM SYSTEM  
4. CONSTRUCT WATER AND SEWER SYSTEM  
5. FINE GRADE SITE  
6. INSTALL GRASSING AND MULCH (TEMPORARY VEGETATION)  
7. CONSTRUCT BUILDING  
8. INSTALL CURB AND GUTTER  
9. PAVE SITE  
10. FINAL STABILIZATION (PERMANENT VEGETATION), CLEAN STORM DRAIN SYSTEM  
11. MAINTAIN ALL EROSION AND SEDIMENT CONTROL MEASURES

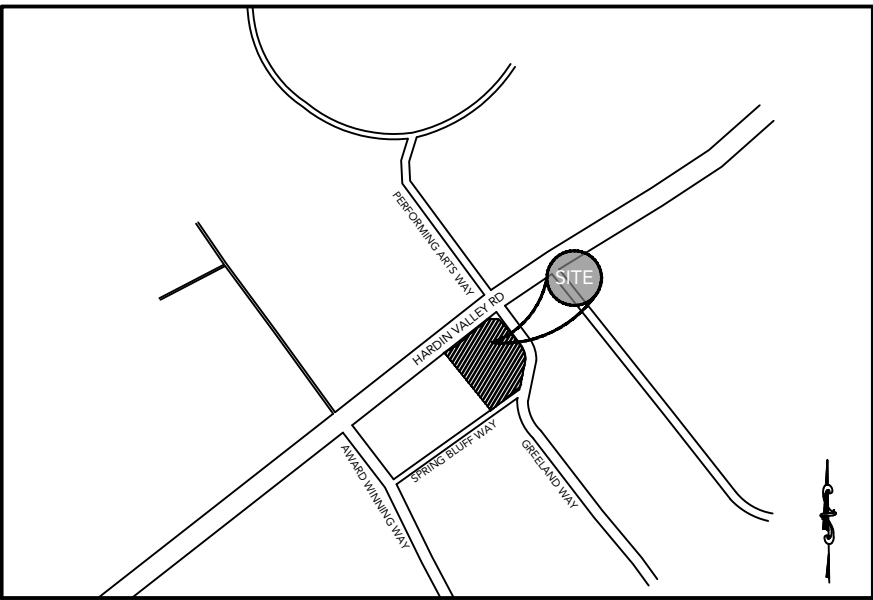

LOCATION MAP  
SCALE: N.T.S.

DESIGN BY:

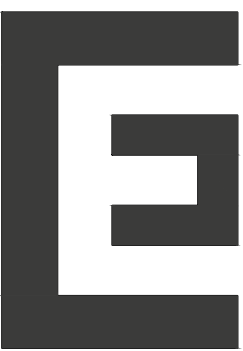

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\*\*\*CAUTION\*\*\*  
THE UTILITIES SHOWN HEREON ARE FOR THE CONTRACTORS CONVENIENCE ONLY. THERE MAY BE OTHER UTILITIES NOT SHOWN ON THESE PLANS. THE ENGINEER ASSUMES NO RESPONSIBILITY FOR THE LOCATIONS SHOWN AND IT SHALL BE THE CONTRACTOR'S RESPONSIBILITY TO VERIFY ALL UTILITIES WITHIN THE LIMITS OF THE WORK. ALL DAMAGE MADE TO EXISTING UTILITIES BY THE CONTRACTOR SHALL BE SOLE RESPONSIBILITY OF THE CONTRACTOR.

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GENERAL PLAN SET NOTES

1. THE ENGINEER IS NOT RESPONSIBLE FOR COST CHANGES DURING CONCEPTUAL, PRELIMINARY, OR DESIGN PHASE.
2. BIDS & QUOTES SHALL BE BASED ON PLAN SETS LABELED "ISSUE FOR BID" ON THE REVISION BLOCK.
3. BIDS & QUOTES SHALL BE REVISED BASED ON PLANS LABELED "ISSUE FOR CONSTRUCTION" ON THE REVISION BLOCK.
4. IF DISCREPANCIES ARE ENCOUNTERED DURING CONSTRUCTION THAT REQUIRE DEVIATION FROM THIS PLAN SET, THE ENGINEER SHOULD BE NOTIFIED FOR UPDATED PLANS AND/ OR FIELD CHANGES.
5. THE ENGINEER IS NOT RESPONSIBLE FOR DESIGN OR CONSTRUCTION COST ASSOCIATED WITH FIELD CHANGES OR DEVIATION FROM THIS PLAN SET DUE TO UNFORESEEN SITE CONDITIONS, CLIENT MODIFICATION REQUEST AND/ OR CONTRACTOR CHANGES.
6. THE ENGINEER IS NOT RESPONSIBLE FOR THE EFFICACY OF FIELD CHANGES OR DEVIATION FROM THIS PLAN SET IN ANYWAY, UNLESS CHANGES ARE DIRECTED BY THE ENGINEER.

DEVELOPMENT DATA:

-OWNER: CHICK-FIL-A, INC.

-OWNER ADDRESS: 5200 BUFFINGTON RD., ATLANTA GA 30349

-DEVELOPER: CHICK-FIL-A, INC.

-DEVELOPER ADDRESS: 5200 BUFFINGTON RD, ATLANTA GA 30349

-SITE ADDRESS: 2187 GREENLAND WAY, KNOXVILLE, TN 37932

-ALL IMPROVEMENTS TO CONFORM WITH THE CITY OF CHARLOTTE, NC AND THE MECKLENBURG COUNTY CONSTRUCTION STANDARDS AND SPECIFICATIONS, LATEST EDITION.

-ENGINEER: CARTER ENGINEERING CONSULTANTS, Inc.

-ZONING: PC

-SITE ACREAGE: 1.75 - DISTURBED AREA: 1.75

5200 Buffington Rd.  
Atlanta Georgia,  
30349-2998

REVISION BLOCK:	REVISION	DATE	INITIAL REVIEW	PCR	TTODA SUBMITTAL	REVISED PER TTODA COMMENTS
REV. #	A	06/02/2023				
	B	06/06/2023				
	C	07/25/2023				
	D	08/28/2023				

CARTER ENGINEERING

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HARDIN VALLEY FSU  
STORE # 05442  
9-B-23-TOB / 9-C-23-DP

2187 GREENLAND WAY,  
KNOXVILLE, TN 37932

SHEET TITLE

COVER

REVISION 4-2023

Job No. : 23043CFA  
Store : 05442  
Date : 08/28/23

Sheet

C-1.0

ISSUE FOR PERMIT



CONSTRUCTION NOTES

1. THE DRAWINGS AND SPECIFICATIONS ARE INTENDED TO COVER A COMPLETE PROJECT, READY TO USE, AND ALL ITEMS NECESSARY FOR A COMPLETE AND WORKABLE JOB SHALL BE FURNISHED AND INSTALLED. ANY DISCREPANCY SHALL BE IMMEDIATELY REPORTED TO THE OWNER OR HIS REPRESENTATIVE.
2. NOTIFY THE INSPECTOR OF THE LOCAL GOVERNING AUTHORITY 24 HOURS BEFORE EVERY PHASE OF CONSTRUCTION.
3. ALL WORK SHALL COMPLY WITH ALL APPLICABLE LOCAL, STATE, AND FEDERAL CODES. ALL NECESSARY LICENSES AND PERMITS SHALL BE OBTAINED BY THE CONTRACTOR, AT HIS EXPENSE, UNLESS ALREADY OBTAINED BY THE OWNER.
4. THE CONTRACTOR SHALL COORDINATE LOCATION AND INSTALLATION OF ALL UNDERGROUND UTILITIES AND APPURTENANCES TO MINIMIZE DISTURBING CURBING, PAVING, AND ALL OTHER UTILITIES.
5. THE EXISTING UTILITIES SHOWN ARE FOR THE CONTRACTOR'S CONVENIENCE ONLY. THERE MAY BE OTHER UTILITIES NOT SHOWN ON THESE DRAWINGS. THE UTILITIES SHOWN ARE THOSE LOCATED BY THE SURVEYOR OF RECORD. THE ENGINEER ASSUMES NO RESPONSIBILITY FOR THE LOCATION OF THE UTILITIES SHOWN. IT SHALL BE THE CONTRACTOR'S RESPONSIBILITY TO VERIFY THE LOCATIONS OF ALL UTILITIES WITHIN THE LIMITS OF WORK. ALL DAMAGE MADE TO EXISTING UTILITIES BY THE CONTRACTOR SHALL BE THE SOLE RESPONSIBILITY OF THE CONTRACTOR.
6. DEVIATIONS FROM THESE PLANS AND SPECIFICATIONS WITHOUT PRIOR CONSENT OF THE ENGINEER AND THE MUNICIPALITY MAY CAUSE FOR THE WORK TO BE UNACCEPTABLE.
7. ALL MATERIALS SHALL BE NEW UNLESS USED OR SALVAGED MATERIALS ARE AUTHORIZED BY THE OWNER.
8. THE CONTRACTOR SHALL FURNISH AND MAINTAIN ALL NECESSARY BARRICADES AROUND THE WORK AND SHALL PROVIDE PROTECTION AGAINST WATER DAMAGE AND SOIL EROSION.
9. ALL WORK SHALL BE PERFORMED IN A FINISHED AND WORKMANLIKE MANNER TO THE ENTIRE SATISFACTION OF THE OWNER, AND IN ACCORDANCE WITH THE BEST RECOGNIZED TRADE PRACTICES.
10. THE CONTRACTOR SHALL PROVIDE SHEETING AND SHORING FOR ALL TRENCH CONSTRUCTION IN ACCORDANCE WITH OSHA GUIDELINES.
11. ALL PIPE LENGTHS SHOWN ARE TO THE CENTERLINE OF THE STRUCTURES UNLESS SPECIFICALLY NOTED.
12. PIPES (STORM AND SANITARY SEWER) SHALL BE LAID ON SMOOTH, CONTINUOUS GRADES WITH NO VISIBLE BENDS AT THE JOINTS.
13. BEDDING REQUIREMENTS SPECIFIED HEREIN ARE TO BE CONSIDERED AS MINIMUM REQUIRED FOR RELATIVELY DRY STABLE EARTH CONDITIONS. ADDITIONAL BEDDING SHALL BE REQUIRED FOR ROCK TRENCHES TO PROVIDE SUCH ADDITIONAL BEDDING AS REQUIRED TO PROPERLY CONSTRUCT WORK.
14. ALL STORM DRAINAGE INLET STRUCTURES SHALL HAVE METAL RING AND COVER FOR ACCESS.
15. ALL ANGLES SHOWN ARE 90 DEGREES UNLESS SHOWN OTHERWISE.
16. ALL GRADES SHOWN ARE FINISHED GRADES. CONTRACTOR SHALL VERIFY DIMENSIONS, GRADES, AND EXISTING ELEVATIONS PRIOR TO CONSTRUCTION.
17. CONCRETE CURBS SHALL BE CONSTRUCTED IN ACCORDANCE WITH THE DETAILS SHOWN ON PLANS. MATERIALS, EQUIPMENT, METHODS OF CONSTRUCTION AND WORKMANSHIP SHALL CONFORM TO STATE D.O.T. STANDARD SPECIFICATIONS.
18. ALL CONCRETE SHALL HAVE 3000 PSI COMPRESSIVE STRENGTH AFTER 28 DAYS, WITH A MAXIMUM SLUMP OF FOUR (4) INCHES, UNLESS SPECIFIED OTHERWISE.
19. ALL EXPOSED CONCRETE SHALL HAVE A FINE HAIR BROOMED FINISH.
20. PARKING AND DRIVEWAY BASE COURSE AND ASPHALTIC CONCRETE SURFACE AND PRIME MATERIALS, EQUIPMENT, METHODS FOR CONSTRUCTION AND WORKMANSHIP SHALL CONFORM TO STATE D.O.T. STANDARD SPECIFICATIONS.
21. CONTRACTOR TO FIELD VERIFY ALL STORM, SANITARY, WATER AND OTHER UTILITIES LOCATIONS AND INVERTS PRIOR TO INSTALLATION OF ANY UTILITIES. NOTIFY ENGINEER PRIOR TO PROCEEDING WITH ANY WORK IF DISCREPANCIES FOUND.
22. THE USE OF CONCRETE THRUST BLOCKS FOR THE INSTALLATION OF WATER MAINS IS STRICTLY PROHIBITED. PRESSURE PIPE FITTINGS AND OTHER ITEMS REQUIRING RESTRAINT SHALL BE RESTRAINED USING METHODS SPECIFIED AND APPROVED BY COUNTY/CITY TECHNICAL STANDARDS, SPECIFICATIONS AND REGULATIONS. THE PREFERRED METHOD OF RESTRAINT IS THROUGH THE USE OF "MEGA-LUGS" OR "MJR" DEVICES.
23. ALL DIMENSIONS ARE MEASURED TO THE BACK OF CURB UNLESS OTHERWISE NOTED.

EARTHWORK SPECIFICATIONS

CLEARING AND GRUBBING

1. CLEARING AND GRUBBING SHALL CONSIST OF CLEARING THE SURFACE OF THE GROUND OF THE DESIGNATED AREAS OF ALL TREES, LOGS, SNAGS, BRUSH, UNDERGROWTH, HEAVY GROWTH OF GRASS, WEEDS, FENCE STRUCTURES, DEBRIS AND RUBBISH OF ANY NATURE. NATURAL OBSTRUCTIONS SUCH AS OBJECTIONABLE SOIL MATERIAL UNSATISFACTORY FOR FOUNDATIONS. IT SHALL ALSO CONSIST OF GRUBBING OF STUMPS, ROOTS FOUNDATIONS AND DISPOSAL OF ALL SUCH MATERIAL. ALL HOLES REMAINING AFTER THE GRUBBING OPERATION IN EMBANKMENT AREAS AND IN EXCAVATION AREAS LESS THAN TWO (2) FEET IN DEPTH, SHALL HAVE SIDES BROKEN DOWN AND LEVELED IF NECESSARY TO FLATTEN OUT SLOPES, REFILLED WITH ACCEPTABLE MATERIAL THAT IS PROPERLY COMPACTED IN LAYERS BY TAMPERS, ROLLERS OR CONSTRUCTION EQUIPMENT.
2. BURNING ON SITE IS NOT PERMITTED WITHOUT WRITTEN APPROVAL OF THE LOCAL GOVERNING AUTHORITIES HAVING JURISDICTION.

EXISTING TREES OUTSIDE OF GRADING LIMITS LINE:

1. TREES AND VEGETATION TO BE SAVED SHALL BE PROTECTED FROM DAMAGE BY A FENCE BARRICADE PRIOR TO, OR DURING, CLEARING OPERATIONS. TREES TO BE REMOVED FROM THE AREA OUTSIDE THE LIMITS OF GRADING OR FROM SPECIFICALLY DESIGNATED AREAS WITHIN THE CONSTRUCTION AREAS. IF, IN THE OPINION OF THE ENGINEER, A CONTRACTOR DAMAGES A TREE NOT TO BE REMOVED, THE CONTRACTOR WILL BE FINED A PREDETERMINED AMOUNT FOR EACH DAMAGED TREE. THE CONTRACT SHALL ALSO BE RESPONSIBLE FOR ALL COSTS ASSOCIATED IN REMOVING THE DAMAGED TREE FROM THE SITE.

FILL:

1. ALL VEGETATION SUCH AS ROOTS, BRUSH, HEAVY GROWTH OF GRASS, TOPSOIL, ALL DECAYED VEGETABLE MATTER, RUBBISH, AND OTHER UNSUITABLE MATERIAL WITHIN THE AREA UPON WHICH FILL IS TO BE PLACED SHALL BE STRIPPED OR BE OTHERWISE REMOVED BEFORE THE FILL OPERATION IS STARTED. IN NO CASE SHALL UNSUITABLE MATERIAL REMAIN IN OR UNDER THE FILL AREA. SLOPED GROUND SURFACE STEEPER THAN ON VERTICAL TO FOUR HORIZONTAL, ON WHICH FILL IS TO BE PLACED, SHALL BE PLACED, STEPPED OR BENCHED IN SUCH A MANNER THAT THE FILL TO BE PLACED SHALL BE 97 PERCENT OF THE MAXIMUM LABORATORY DRY DENSITY ACCORDING TO STANDARD PROCTOR (AASHTO 199, ASTM D-698, MOISTURE CONTENT SHALL BE WITHIN 3 PERCENT OF THE OPTIMUM MOISTURE CONTENT. PROOF ROLL THE AREAS TO BE FILLED OR ON WHICH STRUCTURES ARE TO BE PLACED. A LOADED DUMP TRUCK OR OTHER RUBBER Tired EQUIPMENT SHALL BE USED FOR PROOF ROLLING. OVERLAPPING PASSES OF A VEHICLES SHOULD BE MADE ACROSS THE SITE IN ONE DIRECTION AND THEN PERPENDICULAR TO THE ORIGINAL DIRECTION OF ROLLING.
2. ANY YIELDING, PUMPING OR SOFT AREAS SHOULD BE CUT OUT AND REPLACED WITH FILL COMPACTED AS DESCRIBED HEREIN.
3. THE PROPOSED FILL SHOULD BE LIMITED TO SOILS CLASSIFIED IN ACCORDANCE WITH ASTM D-2487 AS GM, GC, SW, SM, SC, ML AND CL. SOIL CLASSIFIED AS PT, OH, OL, CH AND MH ARE NOT SATISFACTORY AS COMPACTED FILL.
4. FILLS AND EMBANKMENTS SHALL BE CONSTRUCTED AT THE LACTATIONS AND TO THE LINES AND GRADES INDICATED ON CONSTRUCTION PLANS. THE SLOPE SHALL NOT EXCEED 2 FOOT HORIZONTAL TO 1 FOOT VERTICAL (3 FOOT HORIZONTAL TO 1 FOOT VERTICAL IN THE PUBLIC RIGHT OF WAY). THE COMPLETED FILL SHALL CORRESPOND TO THE SHAPE OF THE TYPICAL SECTIONS INDICATED ON THE CONSTRUCTION PLANS. MATERIAL REMOVED FROM THE EXCAVATION SHALL BE USED IN FORMING THE FILL. FILL MATERIAL SHALL BE REASONABLY FREE FROM ROOTS, OTHER ORGANIC MATERIAL, TRASH AND STONES HAVING MAXIMUM DIMENSIONS GREATER THAN 6 INCHES (4 INCHES IN TRENCHES FOR UTILITIES). NO FROZEN MATERIAL WILL BE PERMITTED IN THE FILL. STONES HAVING A MAXIMUM DIMENSION OF 4 INCHES WILL NOT BE PERMITTED IN THE UPPER SIX INCHES OF FILL OR EMBANKMENT OR UTILITY TRENCH. THE MATERIAL SHALL BE PLACED IN SUCCESSIVE HORIZONTAL LAYERS NOT MORE THAN 8 INCHES THICK, UNLESS OTHERWISE NOTED, IN LOOSE DEPTH FOR THE WIDTH OF THE CROSS-SECTION AND SHALL BE COMPACTED TO AT LEAST 97 PERCENT OF THE MAXIMUM LABORATORY DRY DENSITY ACCORDING TO STANDARD PROCTOR (ASTM D-698, AASHTO 199). MOISTURE SHALL BE WITHIN 3 PERCENT OF THE OPTIMUM MOISTURE CONTENT. THE TOP 12 INCHES OF THE PAVING, PARKING AND/OR ROADWAY SUB-GRADE SHALL BE COMPACTED TO 97 PERCENT OF THE MAXIMUM DRY DENSITY (STANDARD PROCTOR). EACH LIFT SHALL BE ROLLED WITH A VIBRATORY ROLLER, A SHEEPSFOOT ROLLER, OR A LOADED RUBBER Tired DUMP TRUCK, SCRAPER OR LOADER. IF THE SOIL IS TOO DRY, A WATER TRUCK WITH SPREADER BAR OR SPRAY HOSE SHALL BE USED TO BRING THE SOIL TO THE PROPER MOISTURE RANGE. THE WATER SHALL BE THOROUGHLY AND PROPERLY MIXED WITH THE SOIL PRIOR TO COMPACTION.
5. STORM DRAIN PIPES SHALL BE PLACED ON FIRM BOTTOM AND HAND TAMPED TO SAFE UP THE PIPE. A CUSHION OF SOIL SHALL BE TAMPED ABOVE THE CROWN OF THE PIPE IN ACCORDANCE WITH THE PIPE MANUFACTURER'S RECOMMENDATIONS SO THAT THE HEAVIER COMPACTION EQUIPMENT CAN THEN BE USED TO BRING THE SOIL TO A DENSITY AS DESCRIBED ABOVE FOR FILL AREAS.
6. IF SOILS INVESTIGATION REPORT IS PROVIDED, THEN FOLLOW THE RECOMMENDATIONS OF THE REPORT IF THEY EXCEED THE RECOMMENDATIONS OF THESE SPECIFICATIONS.

TOPSOIL:

1. UNLESS OTHERWISE SPECIFIED, AREAS DESIGNATED FOR GRADING OPERATIONS THAT CONTAIN A BLANKET OF TOPSOIL SHALL BE STRIPPED AND PLACED IN CONVENIENT STOCKPILES FOR LATER USE AS A TOPSOIL BLANKET ON THE NEW GRADED AREAS SPECIFIED HEREIN, OR AS DESIGNATED. TOPSOIL SHALL BE STRIPPED FROM ALL AREAS DESIGNATED TO RECEIVE FILL. THE STRIPPING OF MATERIAL FOR TOPSOIL SHALL BE CAREFULLY DETERMINED AND ONLY THE QUANTITY REQUIRED SHALL BE STOCKPILED. MATERIAL STOCKPILED SHALL BE STORED IN A SATISFACTORY MANNER TO AFFORD PROPER DRAINAGE WHEN GRADING OPERATIONS PERMIT. INSTEAD OF STOCKPILING, THE TOPSOIL SHALL BE HAULED AND SPREAD DIRECTLY ON THE AREAS DESIGNATED TO RECEIVE TOPSOIL.

ROCK EXCAVATION:

1. IF ROCK IS ENCOUNTERED, CLEAR AWAY EARTH TO EXPOSE MATERIAL. NOTIFY OWNER AND RECEIVE WRITTEN INSTRUCTIONS PRIOR TO EXCAVATION. REMOVE ROCK TO A DEPTH OF 6 INCHES BELOW AND 8 INCHES ON EACH SIDE OF PIPES IN TRENCHES. A MEASUREMENT OF EXTENT OF ROCK TO BE REMOVED SHALL BE MADE. ROCK EXCAVATION SHALL BE PAID FOR IN ACCORDANCE WITH AGREEMENT WITH THE OWNER.

DEMOLITION NOTES

EXISTING STRUCTURES & FACILITIES:

1. THE LOCATIONS OF ALL EXISTING FACILITIES SHOWN ON THIS PLAN HAVE BEEN DETERMINED FROM THE BEST INFORMATION AVAILABLE AND ARE GIVEN FOR THE CONVENIENCE OF THE CONTRACTOR. THE ENGINEER / LANDSCAPE ARCHITECT ASSUMES NO RESPONSIBILITY FOR THEIR ACCURACY. PRIOR TO THE START OF ANY DEMOLITION ACTIVITY, THE CONTRACTOR SHALL NOTIFY THE UTILITY COMPANIES FOR ON-SITE LOCATIONS OF EXISTING UTILITIES.
2. THE CONTRACTOR SHALL FURNISH ALL MATERIALS, LABOR, SUPERVISION AND EQUIPMENT REQUIRED FOR THE ORDERLY DEMOLITION AND REMOVAL OF EXISTING STRUCTURES, PAVEMENT, AND UTILITIES AS SHOWN ON THE DRAWINGS AND DESCRIBED HEREIN.
3. THE CONTRACTOR IS REQUIRED TO FAMILIARIZE HIM/HERSELF WITH THE STRUCTURES TO BE DEMOLISHED. A BRIEF DESCRIPTION OF THE STRUCTURES PROPOSED TO BE INSTALLED AND DEMOLISHED ARE INCLUDED FOR THE CONTRACTOR'S CONVENIENCE ONLY.
4. THE FOLLOWING LIST OF STRUCTURES REQUIRING DEMOLITION IS INCLUDED FOR THE CONTRACTOR'S CONVENIENCE ONLY. THE DRAWINGS INDICATE THE SCOPE OF THE DEMOLITION WHERE DEMOLITION IS REQUIRED (SEE CORRESPONDING PLANS):
  - 4.1. DEMOLITION AND REMOVAL OF EXISTING ON-SITE ASPHALT, CONCRETE, PAVING, AND CURBING TO LIMITS OF DISTURBANCE/DEMOLITION AS SHOWN ON THE CORRESPONDING PLANS. CONTRACTOR TO VERIFY AND COORDINATE ANY DISCREPANCIES AND/OR CONCERNS WITH ENGINEER/LANDSCAPE ARCHITECT ACCORDINGLY.
5. ALL ON-SITE UNDERGROUND STRUCTURES AND PIPING MUST BE COMPLETELY REMOVED AND OVER-EXCAVATED BY A MINIMUM OF 12" BENEATH THE STRUCTURES. CONTRACTOR SHALL USE APPROVED FILLING MATERIAL FOR FILLING THESE AREAS. FILL SHALL BE CLEAN WITH LESS THAN 50% PASSING THE #200 SIEVE, PLASTICITY INDEX LESS THAN 10, WITH MAXIMUM PARTICLE SIZE OF 1.25 INCHES, AND SHALL BE PLACED IN LOOSE LIFTS NOT EXCEEDING 8 INCHES IN THICKNESS AND COMPACTED TO AT LEAST 98% OF THE MODIFIED PROCTOR MAXIMUM DRY DENSITY (AASHTO 199).
6. ALL EXISTING STRUCTURES, PAVEMENTS, SLABS, FOUNDATIONS, STEPS AND OTHER EXISTING FEATURES INDICATED ON THE DRAWINGS TO BE REMOVED SHALL BE DEMOLISHED AND REMOVED BY THE CONTRACTOR. REMOVE NO STRUCTURE SUBSTANTIALLY AS A WHOLE. DEMOLISH COMPLETELY ON THE PREMISES.
7. ALL EXISTING SEWERS, PIPING, UTILITIES SHOWN ARE NOT TO BE INTERPRETED AS THE EXACT LOCATION, OR AS THE ONLY OBSTACLES THAT MAY OCCUR ON THE SITE. CONTRACTOR SHALL VERIFY EXISTING CONDITIONS AND PROCEED WITH CAUTION AROUND ANY ANTICIPATED FEATURES. CONTRACTOR SHALL GIVE NOTICE TO ALL UTILITY COMPANIES REGARDING DESTRUCTION AND REMOVAL OF ALL SERVICE LINES AND CAP ALL LINES BEFORE PROCEEDING WITH THE WORK.
8. CONTRACTOR SHALL PROVIDE ADEQUATE PROTECTION FOR PERSON AND PROPERTY AT ALL TIMES. HE OR SHE SHALL EXECUTE THE WORK IN A MANNER THAT AVOIDS HAZARDS TO PERSONS AND PROPERTY AND THAT PREVENTS INTERFERENCE WITH THE USE AND ACCESS TO ADJACENT PROPERTIES, BUILDINGS, AND ADJACENT STREETS. STREETS AND SIDEWALKS SHALL NOT BE BLOCKED BY DEBRIS AND EQUIPMENT.
9. CONTRACTOR MUST STOP OPERATION AND NOTIFY THE OWNER FOR PROPER DIRECTION IF ANY ENVIRONMENTAL OR HEALTH RELATED CONTAMINATE IS ENCOUNTERED DURING THE DEMOLITION AND/OR EXCAVATION PROCESS.

DISPOSAL:

10. REMOVE AND LEGALLY DISPOSE OF ALL OTHER RUBBISH, RUBBLE, AND DEBRIS. ALL REFUSE AND MISCELLANEOUS ITEMS TO BE REMOVED, THAT ARE NOT TO BE STOCKPILED FOR LATER USE ON THE PROJECT OR DELIVERED TO THE OWNER, SHALL BE LEGALLY DISPOSED OF OFF-SITE BY THE CONTRACTOR IN ACCORDANCE WITH ANY AND ALL APPLICABLE LAWS, STANDARDS, AND REGULATIONS SET FORTH BY LOCAL, STATE, AND FEDERAL OFFICIALS THAT GOVERN THE DISPOSAL OF WASTE AND DEBRIS.

PAVEMENT REMOVAL:

11. WHERE EXISTING PAVEMENT IS TO BE REMOVED, CONTRACTOR SHALL SAW-CUT THE SURFACING LEAVING A UNIFORM AND STRAIGHT EDGE WITH THE MINIMAL DISTURBANCE POSSIBLE TO THE REMAINING ADJACENT SURFACING. IF CONSTRUCTION RESULTS IN RAVELING OF THE SAW-CUT SURFACE, RECUT BACK FROM THE RAVELED EDGE PRIOR TO RESTORATION.
12. WHERE EXISTING PAVEMENT, CURB, CURB AND GUTTER, SIDEWALK, DRIVEWAY OR VALLEY GUTTER IS TO BE REMOVED FOR THE PURPOSE OF CONSTRUCTION OR REPAIRING BOX CULVERTS, PIPE, INLETS, MANHOLES, APPURTENANCES, FACILITIES OR STRUCTURES, SAID PAVEMENT, ETC., THE SAID OR PROPOSED STRUCTURE SHALL BE REPLACED AND RESTORED IN EQUAL OR BETTER CONDITION THAN THE ORIGINAL. THE CONTRACTOR SHALL PROVIDE ALL NECESSARY LABOR, MATERIALS, EQUIPMENT, TOOLS, SUPPLIES, AND ANY OTHER NECESSARY EQUIPMENT AS REQUIRED BY PROJECT AND SITE REQUIREMENTS.

ACCESS:

13. CONTINUOUS ACCESS SHALL BE MAINTAINED FOR THE SURROUNDING PROPERTIES AT ALL TIMES DURING THE DEMOLITION PROCESS OF THE EXISTING FACILITIES AND SITE.

PERMITTING:

14. IT IS THE CONTRACTOR'S RESPONSIBILITY TO OBTAIN ANY REQUIRED PERMITTING FOR DEMOLITION FROM THE RESPONSIBLE AUTHORITIES AND REGULATIONS AND FULLY ACKNOWLEDGE AND COMPLY WITH ALL REQUIREMENTS PRIOR TO COMMENCING OF DEMOTION WORK.
15. IT IS THE CONTRACTOR'S SOLE RESPONSIBILITY TO DETERMINE THE EXTENT OF DEMOLITION REQUIRED IN ORDER TO PERFORM THE CONTRACT WORK FOR THIS PROJECT. THE CONTRACTOR SHALL CONDUCT SITE VISITS AND SHALL EXAMINE ALL OF THE INFORMATION WITHIN THESE DOCUMENTS AND ALL DISCREPANCIES AND/OR OMISSIONS SHALL BE BROUGHT TO THE ATTENTION OF THE LEAD ENGINEER/ARCHITECT PRIOR TO BID SUBMITTAL.
16. CONTRACTOR SHALL LIMIT ALL DEMOLITION ACTIVITY TO THAT AREA DELINEATED IN THE DRAWING AND APPROVED BY OFFICIALS.
17. ALL OTHER EXISTING UTILITIES INCLUDING BUT NOT LIMITED TO STORM DRAINAGE, GAS, ELECTRIC, TELEPHONE, AND WATER & SEWER SHALL BE PRESERVED AND PROTECTED AT ALL TIMES AS NEEDED AND AS REQUIRED.

STAKING AND SURVEYING NOTES

STAKING:

1. THE CONTRACTOR SHALL PERFORM ALL CONSTRUCTION STAKING AND CONSTRUCTION ACTIVITIES BASED ON THE LATEST APPROVED DESIGN PLANS AND/OR DESIGN FILE(S) AS PROVIDED AND AS WARRANTED BY CLIENT AND PROJECT NEEDS.
2. PRIOR TO COMMENCING CONSTRUCTION STAKING OR CONSTRUCTION ACTIVITIES, THE CONTRACTOR AND/OR STAKING SURVEYOR SHALL CONFIRM WITH THE PROJECT LEAD ENGINEER/ARCHITECT, WHO'S RESPONSIBLE FOR THIS PROJECT, THAT THE LATEST PLANS AND/OR DESIGN FILE(S) ARE BEING UTILIZED.
3. THE ENGINEER/LANDSCAPE ARCHITECT IS NOT RESPONSIBLE FOR OWNERS, CONTRACTORS OR SURVEYORS STAKING OR PERFORMING CONSTRUCTION ACTIVITIES BASED ON OUT-OF-DATE DESIGN PLANS AND/OR DESIGN FILES.
4. CONSTRUCTION STAKING SHALL ADHERE TO THE HORIZONTAL AND VERTICAL DATUM LISTED IN THIS CONSTRUCTION SET AND AS PROVIDED IN THE CORRESPONDING FILES, NOTES, AND/OR DRAWINGS.

TOLERANCES & DISCREPANCIES:

5. IF, DURING CONSTRUCTION STAKING OR CONSTRUCTION ACTIVITIES, SURVEY DISCREPANCIES ARE ENCOUNTERED WITH REGARD TO THE DESIGN PLANS OR DESIGN FILE, WORK SHOULD CEASE AND THE LEAD ENGINEER/LANDSCAPE ARCHITECT SHOULD BE NOTIFIED IMMEDIATELY TO RESOLVE THE ISSUE OR ISSUES. THE ENGINEER / LANDSCAPE ARCHITECT CAN NOT BE HELD RESPONSIBLE OR LIABLE FOR ISSUES THAT THEY HAVE NOT RECEIVED NOTIFICATION.
6. THE CONSTRUCTION TOLERANCES SHOWN IN THE CORRESPONDING DRAWINGS, NOTES, AND/OR FILES, IN GENERAL, REPRESENT INDUSTRY STANDARDS. HOWEVER, EXCEPTIONS CAN BE MADE IF IT IS DETERMINED THAT CERTAIN DEVIATED CONSTRUCTION ACTIVITIES DO NOT ADVERSELY AFFECT THE DESIGN REQUIREMENTS OR FUNCTIONALITY. THE LEAD ENGINEER/LANDSCAPE ARCHITECT WILL EVALUATE CONSTRUCTION ACTIVITIES THAT DEVIATE FROM THE DESIGN PLANS ON A CASE-BY-CASE BASIS. IF IT IS DETERMINED THAT THE CERTAIN DEVIATED CONSTRUCTION ACTIVITIES DO ADVERSELY AFFECT THE DESIGN REQUIREMENTS, FUNCTIONALITY, AND INTENT OF THE PROJECT, THE CONTRACTOR SHALL BE RESPONSIBLE FOR REPLACING OR REPAIRING ALL ITEMS TO THE PLANS AND SPECIFICATIONS AS DETERMINED AND REQUIRED BY DESIGN PROFESSIONAL, AT THE CONTRACTOR'S EXPENSE.

CIVIL ENGINEERING DESIGN TOLERANCES FOR PROJECT:

GENERAL GRADING:	±0.10 FEET	RETAINING WALLS:	±0.05 FEET
ALL PIPE/CONDUITS:	±0.05 FEET	SITE FEATURES (SPOT ELEV., ETC.)	±0.05 FEET
DRAINAGE STRUCTURES:	±0.05 FEET	UTILITY ELEVATIONS:	±0.10 FEET
SANITARY SEWER STRUCTURES:	±0.05 FEET	EROSION CONTROL BMPs:	±0.05 FEET
STORMWATER POND FEATURES:	±0.05 FEET		

AS-BUILT & SPECIFICATIONS:

7. THE ENGINEER/LANDSCAPE ARCHITECT SHOULD BE PROVIDED WITH AN AS-BUILT SURVEY OF THE PROJECT FOR REVIEW AND APPROVAL AFTER THE PROJECT IS COMPLETE. CONTRACTOR IS RESPONSIBLE FOR COORDINATING EFFORTS WITHIN DESIGN PROFESSIONAL DESIGN PROFESSIONAL'S DESIGN.
8. SEE THE PROJECT SPECIFICATIONS FOR ADDITIONAL SITE SPECIFIC REQUIREMENTS REGARDING CONSTRUCTION, MATERIALS, TESTING, AND CERTIFICATIONS.

PROJECT GEOGRAPHICAL INFORMATION

PROJECT PROJECTION & DATUM:

HORIZONTAL DATUM:	NAD83 TENNESSEE STATE PLANE ZONE, US FOOT
VERTICAL DATUM:	NORTH AMERICAN VERTICAL DATUM OF 1988 (NAVD88)

BOUNDARY SURVEY:

SURVEYOR FIRM:	YOUNG - HOBBS AND ASSOCIATES
SURVEYOR NAME:	XXX
SURVEYOR CONTACT:	(931) 645-2524
DATE OF SURVEY:	2/15/23
TRACT OR PARCEL:	103MA004
HORIZONTAL DATUM:	NAD83 TENNESSEE STATE PLANE ZONE, US FOOT
VERTICAL DATUM:	NORTH AMERICAN VERTICAL DATUM OF 1988 (NAVD88)

TOPOGRAPHIC SURVEY:

SURVEYOR FIRM:	YOUNG - HOBBS AND ASSOCIATES
SURVEYOR NAME:	XXX
SURVEYOR CONTACT:	(931) 645-2524
DATE OF SURVEY:	2/15/23
TRACT OR PARCEL:	103MA004
HORIZONTAL DATUM:	NAD83 TENNESSEE STATE PLANE ZONE, US FOOT
VERTICAL DATUM:	NORTH AMERICAN VERTICAL DATUM OF 1988 (NAVD88)

GEOGRAPHICAL INFORMATION SYSTEMS (GIS) DATA UTILIZED:

TOPOGRAPHIC DATA:	N/A
PARCEL DATA:	N/A
ADDITIONAL DATA:	N/A


NOTE:

THE TOPOGRAPHIC AND ELEVATION DATA SHOWN HEREON WAS OBTAINED FROM YOUNG - HOBBS AND ASSOCIATES AND IS NOT CERTIFIED AS CORRECT BY THIS ENGINEER. USERS OF THIS DATA DO SO AT THEIR OWN RISK.



5200 Buffington Rd.  
Atlanta Georgia,  
30349-2998

REVISION BLOCK:			
REV. #	DATE	REVISION	
A	06/02/2023	INITIAL REVIEW	
B	06/06/2023	PCR	
C	07/25/2023	ITCDA SUBMITTAL	
D	08/28/2023	REVISED PER ITCDA COMMENTS	

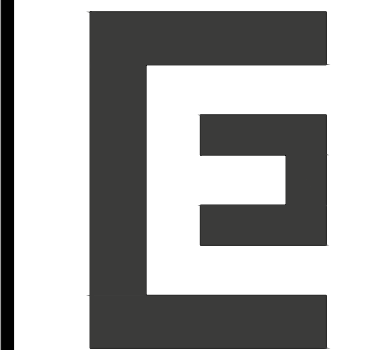

**CARTER**  
ENGINEERING

CARTER ENGINEERING  
1010 COMMERCE DRIVE,  
BOGART, GA 30622

P: 770.725.1200  
F: 770.725.1204  
www.carterengineering.com

HARDIN VALLEY FSU  
STORE # 05442  
9-B-23-TO8 / 9-C-23-DP

2187 GREENLAND WAY,  
KNOXVILLE, TN 37932

SHEET TITLE

GENERAL  
NOTES

REVISION 4-2023

Job No. : 23043CFA

Store : 05442

Date : 08/28/23

Sheet

C-1.1



SITE UTILITIES

**SEWER**  
Agency: West Knox Utility District  
Address: 2328 Lovell Road, Knoxville, TN 37932  
Contact: Mr. Christian Kidd, P.E.  
Phone: 865-690-2521  
Email: ckidd@wkud.com


**STORM**  
Agency: Knox County Land Development Services  
Address: 205 West Baxter Avenue, Knoxville, TN 37917  
Contact: Mr. Martin Pleasant  
Phone: 865-215-5859  
Email: Martin.Pleasant@knoxcounty.org

**WATER**  
Agency: West Knox Utility District  
Address: 2328 Lovell Road, Knoxville, TN 37932  
Contact: Mr. Christian Kidd, P.E.  
Phone: 865-690-2521  
Email: ckidd@wkud.com

**ELECTRIC**  
Agency: LCLUB – Lenoir City Utilities Board  
Address: 7698 Creekwood Park Blvd., Lenoir City, TN 37772  
Contact: Mr. Jay Hines  
Phone: 865-886-0730  
Email: jhines@lclub.com

**TELEPHONE**  
Agency: AT&T  
Address:  
Contact: Customer Service  
Phone: 877-625-9103  
Email:

**GAS**  
Agency: Knoxville Utilities Board (KUB)  
Address: 4428 Western Ave, Knoxville, TN 37921  
Contact: New Construction  
Phone: 865-558-2955  
Email:

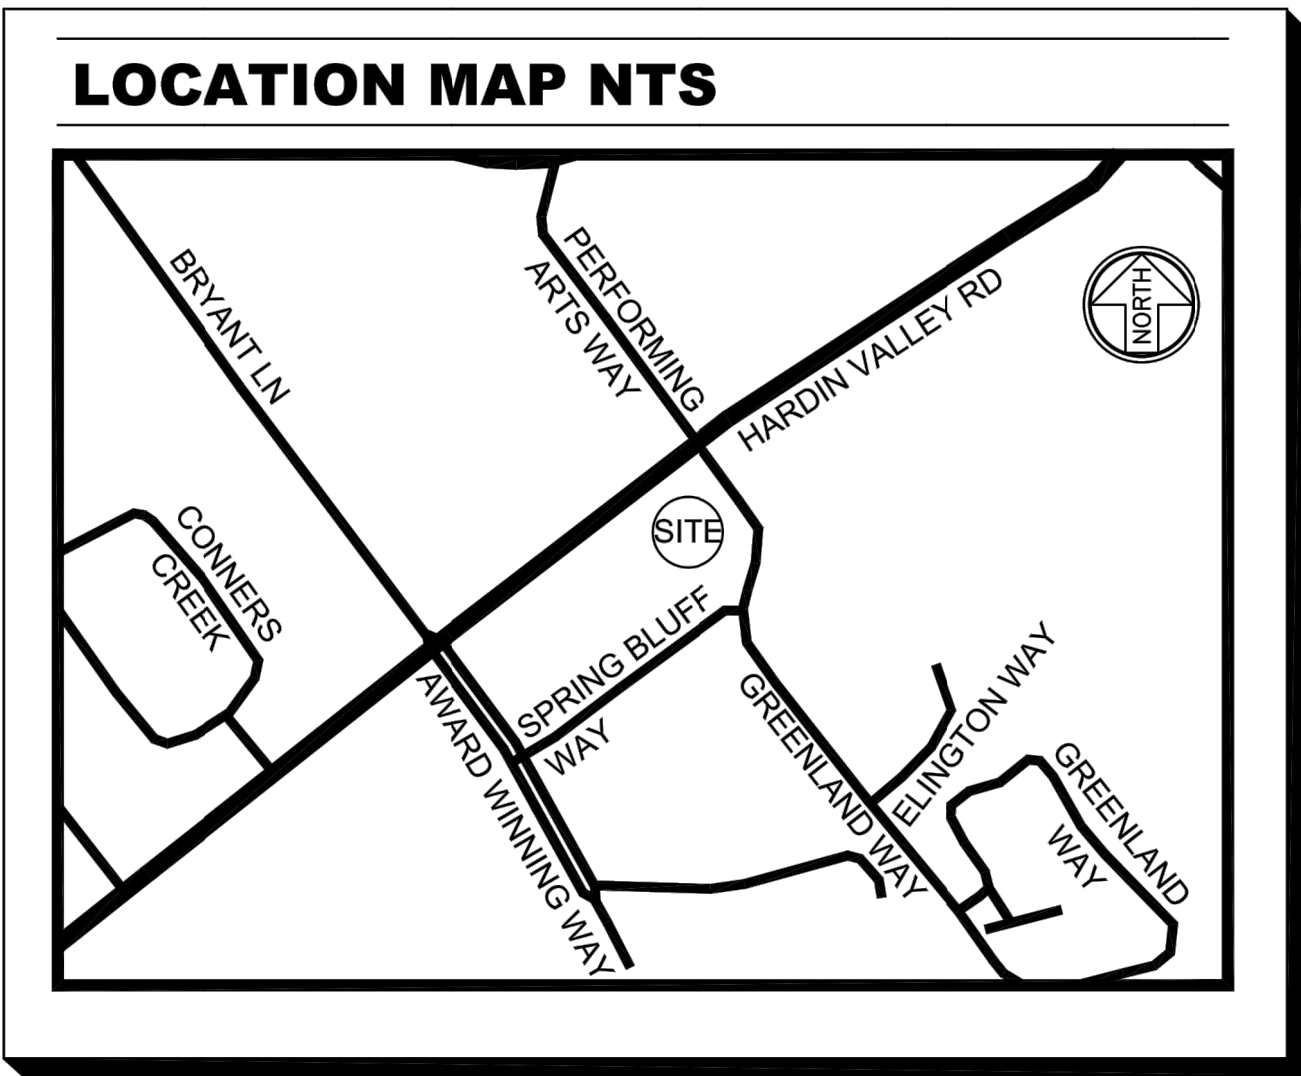

SITE ADDRESS

2187 GREENLAND WAY  
KNOXVILLE, TN 37932

PARKING COUNT

REGULAR - 0  
HANDICAP - 0

CLIENT INFORMATION

CHICK-FIL-A  
5200 BUFFINTON ROAD  
ATLANTA, GA 3034-32998

OWNER INFORMATION

OKR, GP  
INST. NO. 201806040071672;  
PLAT OF LOT 4R, THE VILLAGE AT  
HARDIN VALLEY  
PLAT BOOK 200807170003887  
PARCEL ID 103MA004  
CITY OF KNOXVILLE,  
KNOX COUNTY, TN

LAND DESCRIPTION (PER TITLE COMMITMENT):

PARCEL 1:  
A CERTAIN TRACT OR PARCEL OF LAND IN KNOX COUNTY, STATE OF TENNESSEE, DESCRIBED AS FOLLOWS,  
TO-WIT:  
SITUATED IN DISTRICT NUMBER SIX (6) OF KNOX COUNTY, TENNESSEE, AND WITHOUT THE CORPORATE LIMITS  
OF THE CITY OF KNOXVILLE, TENNESSEE, AND BEING KNOWN AS ALL OF LOT NUMBER 1R, IN THE REVISED  
FINAL PLAT OF LOTS 1, 2, 3, 5, 7, & 8, OF THE VILLAGE AT HARDIN VALLEY SUBDIVISION, AS THE SAME APPEARS  
OF RECORD IN INSTRUMENT NO. 201008160009832 IN THE REGISTER'S OFFICE FOR KNOX COUNTY, TENNESSEE,  
TO WHICH SPECIFIC REFERENCE IS HEREBY MADE FOR A MORE PARTICULAR DESCRIPTION.

LESS AND EXCEPT: QUIT CLAIM DEED RECORDED FEBRUARY 10, 2017, IN INSTRUMENT NO. 201702100049663, IN  
THE REGISTER'S OFFICE OF KNOX COUNTY, TENNESSEE. BEING THE SAME PROPERTY CONVEYED TO OKR GP,  
A TENNESSEE GENERAL PARTNERSHIP (BY VIRTUE OF WARRANTY DEED FROM KNOXVILLE TVA EMPLOYEES  
CREDIT UNION, DATED MAY 23, 2016, RECORDED JUNE 6, 2016, IN INSTRUMENT NO. 20160600070861, IN THE  
REGISTER'S OFFICE OF KNOX COUNTY, TENNESSEE).

PARCELS 2, 3 AND 5:  
A CERTAIN TRACT OR PARCEL OF LAND IN KNOX COUNTY, STATE OF TENNESSEE, DESCRIBED AS FOLLOWS,  
TO-WIT:  
SITUATED IN THE SIXTH (6TH) CIVIL DISTRICT OF KNOX COUNTY, TENNESSEE, AND BEING LOTS 2R, 3R AND 5 OF  
THE REVISED FINAL PLAT OF LOTS 1, 2, 3, 5, 7, & 8 OF THE VILLAGE AT HARDIN VALLEY, AS SHOWN ON PLAT OF  
RECORD IN INSTRUMENT NO. 201008160009832 IN THE REGISTER'S OFFICE FOR KNOX COUNTY, TENNESSEE, TO  
WHICH PLAT SPECIFIC REFERENCE IS HEREBY MADE FOR A MORE PARTICULAR DESCRIPTION. BEING THE SAME  
PROPERTY CONVEYED TO OKR GP, A TENNESSEE GENERAL PARTNERSHIP (BY VIRTUE OF WARRANTY DEED  
FROM BURR, LLC, A TENNESSEE LIMITED LIABILITY COMPANY, DATED MAY 23, 2016, RECORDED MAY 26, 2016, IN  
INSTRUMENT NO. 201605260008745, KNOX COUNTY, TENNESSEE).

PARCEL 4:  
ALL THAT TRACT OR PARCEL OF LAND LYING AND BEING LOCATED ON CLT MAP 103 AND BEING SITUATED  
WITHIN THE SIXTH CIVIL DISTRICT OF KNOX COUNTY, TENNESSEE BEING LOT 4 OF THE VILLAGE AT HARDIN  
VALLEY SUBDIVISION AS SHOWN ON THAT CERTAIN FINAL PLAT OF THE VILLAGE AT HARDIN VALLEY, OF  
RECORD AS INSTRUMENT NUMBER 20071002-0027968 IN THE OFFICE OF THE REGISTER OF DEEDS FOR KNOX  
COUNTY, TENNESSEE, AS AMENDED BY THAT CERTAIN FINAL PLAT OF LOT 4, THE VILLAGE AT HARDIN VALLEY,  
OF RECORD AS INSTRUMENT NUMBER 20080717-003867 IN THE OFFICE OF THE REGISTER OF DEEDS FOR KNOX  
COUNTY TENNESSEE.

LESS AND EXCEPT:  
THE FOLLOWING PORTION OF THE ABOVE-DESCRIBED PROPERTY THAT WAS CONVEYED BY GRANTOR TO  
KNOX COUNTY, TENNESSEE: COMMENCING AT THE POINT OF BEGINNING, POINT BEING 68.22 FEET RIGHT OF  
THE CENTERLINE STA. 186+54.83; THENCE SOUTH 50 DEGREES, 41 MINUTES, 12 SECONDS WEST, A DISTANCE  
OF 29.86 FEET; THEN NORTH 39 DEGREES, 18 MINUTES, 48 SECONDS WEST, A DISTANCE OF 19.45 FEET TO THE  
ENDING POINT BEING 49.22 FEET RIGHT OF STA. 186+23.71, CONTAINING 378 SQUARE FEET, MORE OR LESS, IN  
THE ABOVE-DESCRIBED PARCEL.

BEING THE SAME PROPERTY CONVEYED TO OKR GP, A TENNESSEE GENERAL PARTNERSHIP (BY VIRTUE OF  
SPECIAL WARRANTY DEED FROM SUNTRUST BANK, A GEORGIA BANKING CORPORATION, DATED MAY 29, 2018,  
RECORDED JUNE 4, 2018, IN INSTRUMENT NO. 201806040071672, KNOX COUNTY, TENNESSEE).

PARCEL 6:  
SITUATED WITHIN THE SIXTH (6TH) CIVIL DISTRICT OF KNOX COUNTY, TENNESSEE, WITHOUT THE CORPORATE  
LIMITS OF THE CITY OF KNOXVILLE, TENNESSEE, BEING LOT 6 OF THE FINAL PLAT OF THE VILLAGE AT HARDIN  
VALLEY, AS SHOWN ON MAP FILED FOR RECORD AS INSTRUMENT NO. 200710020027968 IN THE KNOX COUNTY  
REGISTER OF DEEDS OFFICE, TO WHICH MAP SPECIFIC REFERENCE IS HEREBY MADE FOR A MORE  
PARTICULAR DESCRIPTION OF SAID LOT, BEING THE SAME PROPERTY CONVEYED TO OKR GP, A TENNESSEE  
GENERAL PARTNERSHIP (BY VIRTUE OF WARRANTY DEED FROM ORNL FEDERAL CREDIT UNION, DATED MAY 23,  
2016, RECORDED JUNE 9, 2015, IN INSTRUMENT NO. 201506090067733, KNOX COUNTY, TENNESSEE).

ZONING: PER SITE INVESTIGATION REPORT

THE FOLLOWING ZONING INFORMATION WAS TAKEN FROM THE SITE INVESTIGATION REPORT.

THE SUBJECT PARCEL IS ZONED (PC), PLANNED COMMERCIAL ZONE, AND (TO), TECHNOLOGY OVERLAY.

BUILDING SETBACK	BUILDING	PARKING	LANDSCAPING
FRONT (HARDIN VALLEY RD)	50'	20'	20'
REAR (SPRING BLUFF WAY)	50'	0'	0'
LEFT SIDE (GREENLAND WAY)	50'	0'	0'
RIGHT SIDE (UNDEVELOPED/PARKING LOT)	20'	0'	0'

MAXIMUM BUILDING HEIGHT: EXCEPT IN HILLSIDE AND RIDGETOP PROTECTION AREAS, THE MAXIMUM ALLOWABLE  
HEIGHT OF A STRUCTURE IS SET AT NINETY (90) FEET, MEASURED FROM THE FINISHED GRADE..

BUILDING FLOOR AREA RATIO: SHALL NOT EXCEED 30% EXCEPT WHERE A PROPOSED BUILDING INCLUDES AN  
UNDER-BUILDING PARKING STRUCTURE, IN WHICH CASE THE FLOOR AREA RATION MAY NOT EXCEED 40%.

SURVEYOR'S CERTIFICATION:

To: CHICK-FIL-A, INC A GEORGIA CORPORATION, DESIGNEE OF HILLIARD CREWS PARTNERSHIP, A  
TENNESSEE GENERAL PARTNERSHIP AND FIDELITY NATIONAL TITLE INSURANCE COMPANY.

THIS IS TO CERTIFY THAT THIS MAP OR PLAT AND THE SURVEY ON WHICH IT IS BASED WERE  
MADE IN ACCORDANCE WITH THE 2021 MINIMUM STANDARD DETAIL REQUIREMENTS FOR  
ALTA/NSPS LAND TITLE SURVEYS, JOINTLY ESTABLISHED AND ADOPTED BY ALTA AND NSPS, AND  
INCLUDES ITEMS 1, 2, 3, 4, 5, 6(a), 7(a), 7(b)(1), 7(c), 8, 9, 10(a), 11, 13, 14, 16, 17, 18, AND 19 OF TABLE  
A THEREOF. THE FIELD WORK WAS COMPLETED ON MARCH 11, 2022.

DATE OF PLAT OR MAP: FEBRUARY 15, 2023.

PRELIMINARY

KENNETH A. BAU, RLS 2019  
kenny@younghobbs.com

LAND DESCRIPTION (AS SURVEYED):

ALL THAT TRACT OR PARCEL OF LAND LYING AND BEING LOCATED ON CLT MAP 103 AND BEING SITUATED  
WITHIN THE SIXTH CIVIL DISTRICT OF KNOX COUNTY, TENNESSEE BEING LOT 4R OF THE FINAL PLAT OF LOT 4,  
THE VILLAGE AT HARDIN VALLEY, OF RECORD AS INSTRUMENT NUMBER 20080717-003867 IN THE OFFICE OF THE  
REGISTER OF DEEDS FOR KNOX COUNTY TENNESSEE.

LESS AND EXCEPT:  
THE FOLLOWING PORTION OF THE ABOVE-DESCRIBED PROPERTY THAT WAS CONVEYED BY GRANTOR TO  
KNOX COUNTY, TENNESSEE: COMMENCING AT THE POINT OF BEGINNING, POINT BEING 68.22 FEET RIGHT OF  
THE CENTERLINE STA. 186+54.83; THENCE SOUTH 50 DEGREES, 41 MINUTES, 12 SECONDS WEST, A DISTANCE  
OF 29.86 FEET; THEN NORTH 39 DEGREES, 18 MINUTES, 48 SECONDS WEST, A DISTANCE OF 19.45 FEET TO THE  
ENDING POINT BEING 49.22 FEET RIGHT OF STA. 186+23.71, CONTAINING 378 SQUARE FEET, MORE OR LESS, IN  
THE ABOVE-DESCRIBED PARCEL.

BEING THE SAME PROPERTY CONVEYED TO OKR GP, A TENNESSEE GENERAL PARTNERSHIP (BY VIRTUE OF  
SPECIAL WARRANTY DEED FROM SUNTRUST BANK, A GEORGIA BANKING CORPORATION, DATED MAY 29, 2018,  
RECORDED JUNE 4, 2018, IN INSTRUMENT NO. 201806040071672, KNOX COUNTY, TENNESSEE).

AS DESCRIBED AS FOLLOWS:

BEGINNING AT 5/8" IRON PIN FOUND IN THE SOUTHEAST RIGHT OF WAY LINE OF HARDIN VALLEY ROAD, SAID  
IRON PIN BEING THE NORTH CORNER OF LOT 2R, AS SHOWN IN INSTR. NO. 201008160009832; THENCE WITH  
SAID RIGHT OF WAY LINE, AS FOLLOWS: N 62°02'14" E A DISTANCE OF 48.37 FEET TO A 5/8" IRON PIN FOUND;  
THENCE N 50°37'39" E A DISTANCE OF 179.32 FEET TO A PK NAIL SET; THENCE S 39°18'48" E A DISTANCE OF  
19.45 FEET TO A 1/2" IRON PIN SET; THENCE N 50°41'12" E A DISTANCE OF 29.84 FEET TO A 1/2" IRON PIN SET;  
THENCE WITH THE SOUTHWEST RIGHT OF WAY LINE OF GREENLAND WAY, AS FOLLOWS: S 84°19'41" E A  
DISTANCE OF 6.34 FEET TO A 5/8" IRON PIN SET; THENCE WITH A CURVE TURNING TO THE RIGHT WITH AN  
ARC LENGTH OF 19.93 FEET WITH A RADIUS OF 25.00 FEET WITH A CHORD BEARING OF S 61°29'32" E, WITH A  
CHORD LENGTH OF 19.40 FEET TO A 5/8" IRON PIN FOUND; THENCE S 38°42'21" E A DISTANCE OF 129.74 FEET  
TO A 5/8" IRON PIN FOUND; THENCE WITH A CURVE TURNING TO THE RIGHT WITH AN ARC LENGTH OF 81.59  
FEET WITH A RADIUS OF 93.50 FEET WITH A CHORD BEARING OF S 13°39'29" E, WITH A CHORD LENGTH OF  
79.02 FEET TO A 5/8" IRON PIN FOUND; THENCE S 11°20'49" W A DISTANCE OF 90.28 FEET TO A 5/8" IRON PIN  
FOUND; THENCE WITH A CURVE TURNING TO THE RIGHT WITH AN ARC LENGTH OF 17.39 FEET WITH A RADIUS  
OF 25.00 FEET WITH A CHORD BEARING OF S 31°07'34" W, WITH A CHORD LENGTH OF 17.04 FEET TO A 5/8"  
IRON PIN FOUND; THENCE WITH THE NORTHWEST RIGHT OF WAY LINE OF SPRING BLUFF WAY S 51°04'58" W A  
DISTANCE OF 150.37 FEET TO A 5/8" IRON PIN FOUND; THENCE LEAVING SAID RIGHT OF WAY LINE WITH LOTS  
2R & 3R, AS SHOWN IN INSTR. NO. 201008160009832 N 38°41'12" W A DISTANCE OF 314.12 FEET TO THE POINT  
OF BEGINNING, HAVING AN AREA OF 76,244 SQUARE FEET, 1.750 ACRES, MORE OR LESS.

NOTES CORRESPONDING TO  
SCHEDULE B SECTION II:

FIDELITY NATIONAL TITLE INSURANCE COMPANY  
COMMITMENT DATE: NOVEMBER 1, 2022 @ 8:00 A.M.  
COMMITMENT NO.: TN252210100J223586ATL  
ITEMS 1-9 ARE STANDARD EXCEPTIONS AND/OR NOT SURVEYING RELATED.

THE TITLE COMMITMENT PROVIDED TO THE SURVEYOR IS FOR MULTIPLE PARCELS. THE  
SURVEYOR REVIEW THE TITLE COMMITMENT AS TO HOW THE ITEMS WOULD AFFECT LOT 4R OF  
INSTRUMENT NUMBER 200807170003867.

10. EASEMENT AGREEMENT AND TERMINATION OF EASEMENT RECORDED JUNE 12, 1990, IN  
BOOK 2011, PAGE 89, AFOSAID RECORDS. DOES NOT AFFECT. (DOES NOT AFFECT EASEMENT  
PARCEL)  
11. UTILITY EASEMENT RECORDED JUNE 13, 2002, IN INSTRUMENT NO. 200206130102985,  
AFOSAID RECORDS. DOES NOT AFFECT. (DOES NOT AFFECT EASEMENT PARCEL)

12. EASEMENT CONTAINED IN WARRANTY DEED RECORDED JUNE 19, 2002, IN INSTRUMENT NO.  
200206190104399, AFOSAID RECORDS. DOES NOT AFFECT.

13. TERMS AND CONDITIONS OF AGREED FINAL ORDER RECORDED AUGUST 21, 2007, IN  
INSTRUMENT NO. 200708270018101, AFOSAID RECORDS. (AFFECTS PARCEL 1, 3, 5 AND 6) DOES  
NOT AFFECT.

14. ACCESS AND CONSTRUCTION EASEMENT AGREEMENT RECORDED APRIL 19, 2011, IN  
INSTRUMENT NO. 201104190061661, AFOSAID RECORDS.

PARCELS 1, 2, 3, 5 AND 6: DOES NOT AFFECT.

15. RESTRICTIONS CONTAINED IN SPECIAL WARRANTY DEED RECORDED JUNE 4, 2018, IN  
INSTRUMENT NO. 201806040071672, AFOSAID RECORDS. AFFECTS, NOT PLOTTABLE. (EXPIRE ON  
JUNE 3, 2023)

16. TERMS AND CONDITIONS OF DECLARATION OF COVENANTS CONDITIONS AND  
RESTRICTIONS (THE VILLAGE AT HARDIN VALLEY) RECORDED OCTOBER 1, 2007, IN INSTRUMENT  
NO. 200710010027935; AS AFFECTED BY THAT PARTIAL RELEASE AS TO EASEMENT AREA  
RECORDED MARCH 8, 2013, IN INSTRUMENT NO. 201303080058732; AS AMENDED BY THAT  
AMENDED DECLARATION OF COVENANTS, CONDITIONS AND RESTRICTIONS RECORDED APRIL 19,  
2011, IN INSTRUMENT NO. 201104190061662; AS AFFECTED BY THAT PARTIAL RELEASE AS TO  
EASEMENT AREA RECORDED MARCH 8, 2013, IN INSTRUMENT NO. 201303080058734, AFOSAID  
RECORDS. AFFECTS, NO PLOTTABLE EASEMENTS.

17. EASEMENT CONTAINED IN WARRANTY DEED RECORDED NOVEMBER 20, 2001, IN  
INSTRUMENT NO. 20011120040361, AFOSAID RECORDS. DOES NOT AFFECT.

18. EASEMENT CONTAINED IN SPECIAL WARRANTY DEED RECORDED SEPTEMBER 11, 2015, IN  
INSTRUMENT NO. 201509110016843, AFOSAID RECORDS.

PARCELS 1, 2, 3, 4, 5 AND 6: AF FECTS VESTED TITLE ONLY, NO PLOTTABLE EASEMENT.

19. UTILITY EASEMENT IN FAVOR OF WEST KNOX UTILITY DISTRICT RECORDED FEBRUARY 13,  
2002, IN INSTRUMENT NO. 200202130066934, AFOSAID RECORDS. DOES NOT AFFECT. (DOES  
NOT AFFECT EASEMENT PARCEL)

20. COVENANTS FOR PERMANENT MAINTENANCE OF STORMWATER FACILITIES  
RECORDED AUGUST 31, 2007, IN INSTRUMENT NO. 200708310019574, AFOSAID RECORDS.  
AFFECTS, NO PLOTTABLE EASEMENTS.

21. UTILITY EASEMENT AGREEMENT RECORDED JULY 18, 2008, IN INSTRUMENT NO.  
20080718000449 AND INSTRUMENT NO. 200807180004495, INSTRUMENT NO. 200807180004496,  
AFOSAID RECORDS. AFFECTS, NO NEW EASEMENTS CREATED.

22. DECLARATION OF ACCESS EASEMENTS RECORDED AUGUST 16, 2010, IN INSTRUMENT  
NO. 201008160009831, AFOSAID RECORDS. DOES NOT AFFECT. (DOES NOT AFFECT  
EASEMENT PARCEL)

23. RECIPROCAL EASEMENT AGREEMENT AND AMENDMENT OF RESTRICTIONS RECORDED  
FEBRUARY 28, 2011, IN INSTRUMENT NO. 201102280051664; AS AFFECTED BY THAT PARTIAL  
RELEASE AS TO EASEMENT AREA RECORDED MARCH 8, 2013, IN INSTRUMENT NO.  
201303080058732; AS AFFECTED BY THAT PARTIAL RELEASE AS TO EASEMENT AREA  
RECORDED MARCH 8, 2013, IN INSTRUMENT NO. 201303080058734, AFOSAID RECORDS.  
AFFECTS, NO PLOTTABLE EASEMENTS.

24. EASEMENTS, RIGHTS OF WAY, BOUNDARY LINES AND IMPROVEMENTS AS SHOWN ON  
PLAT RECORDED IN INSTRUMENT NO. 200710020027968; INSTRUMENT NO. 200807170003867,  
INSTRUMENT NO. 201008160009832, AFOSAID RECORDS. AFFECTS, AS SHOWN.

25. TERMS AND CONDITIONS OF CONSENT AGREEMENT BY ORNL FEDERAL CREDIT UNION  
RECORDED APRIL 1, 2011, IN INSTRUMENT NO. 201104010058566, AFOSAID RECORDS.  
PARCEL 4: DOES NOT AFFECT. (DOES NOT AFFECT EASEMENT PARCEL)

26. GRANT OF TRANSMISSION LINE EASEMENT RECORDED IN BOOK 1243, PAGE 68,  
AFOSAID RECORDS. DOES NOT AFFECT.

TABLE A NOTES:

ITEM 2: SITE ADDRESS SHOWN IS PER KNOX COUNTY, TN TAX RECORD.  
ITEM 3: THIS PROPERTY IS LOCATED WITHIN AN AREA HAVING ZONE  
DESIGNATIONS OF ZONE "X" BY THE SECRETARY OF HOUSING  
AND URBAN DEVELOPMENT, ON FLOOD INSURANCE RATE MAP  
NO. 47060C0233G, WITH AN EFFECTIVE DATE OF AUGUST 5, 2013,  
IN KNOX COUNTY UNINCORPORATED AREAS, STATE OF  
TENNESSEE, WHICH IS THE CURRENT FLOOD INSURANCE RATE  
MAP FOR THE COMMUNITY IN WHICH SAID PROPERTY IS  
SITUATED.\*  
ITEM 5: CONTOURS WERE DERIVED FROM RANDOM SHOTS AND CROSS  
SECTIONS AND ARE SHOWN AT ONE FOOT INTERVALS.  
ELEVATIONS SHOWN HEREON ARE BASED ON GPS OBSERVATIONS  
TOGETHER WITH AN OPLUS SOLUTION, DATED 02/21/2023 (NAVDO8,  
GEOID12B).  
ITEM 6A: NO ZONING LETTER SENT TO THIS SURVEYOR.  
ITEM 16: THERE WAS NO EVIDENCE OF RECENT EARTH MOVING, BUILDING  
CONSTRUCTION, OR BUILDING ADDITIONS OBSERVED IN THE  
PROCESS OF CONDUCTING THE FIELDWORK.  
ITEM 17: THERE WAS NO EVIDENCE OF RECENT CHANGES IN STREET  
RIGHT OF WAY LINES. THERE WAS NO EVIDENCE OF RECENT OR  
STREET SIDEWALK CONSTRUCTION OR REPAIRS OBSERVED IN  
THE PROCESS OF CONDUCTING THE FIELDWORK.

SURVEY NOTES:

INFORMATION REGARDING THE PRESENCE, SIZE AND LOCATION OF  
UNDERGROUND UTILITIES IS SHOWN HEREON. THIS INFORMATION HAS BEEN  
SHOWN BASED ON THE LOCATION OF ABOVE GROUND APPURTENANCES,  
AVAILABLE DESIGN PLANS, AND FLAGS AND PAINT PLACED BY THE  
UNDERGROUND PROTECTION SERVICE. NO CERTIFICATION IS MADE AS TO THE  
ACCURACY OF THOROUGHNESS OF THE INFORMATION CONCERNING  
UNDERGROUND UTILITIES AND STRUCTURES SHOWN HEREON. (TENNESSEE  
ONE CALL 811 - T8NN811.COM) (TICKET NUMBER 220681406).

NO PRIVATE UTILITY LOCATE WAS PERFORMED ON THIS SITE AT THE TIME OF  
THIS SURVEY.

CONTACT PROPER AUTHORITIES BEFORE BUILDING NEAR UTILITY LINES, FOR  
EASEMENT WIDTH AND RESTRICTIONS. UTILITIES ARE APPROXIMATE AND  
SHOULD BE VERIFIED PRIOR TO ANY CONSTRUCTION.

THIS SURVEY HAS BEEN PREPARED FOR THE EXCLUSIVE USE OF THE PERSON  
OR ENTITIES NAMED HEREON. NO EXPRESS OR IMPLIED WARRANTIES WITH  
RESPECT TO THE INFORMATION SHOWN HEREON IS TO BE EXTENDED TO ANY  
PERSONS OR ENTITIES OTHER THAN THOSE SHOWN HEREON.

LIST OF ENCROACHMENTS: NONE NOTED

THERE ARE NO BUILDINGS ON SITE AT THE TIME OF THIS SURVEY

THE SURVEY SHOWN HEREON WAS MADE IN ACCORDANCE WITH CHAPTER  
0603-3, STANDARDS OF PRACTICE AS ADOPTED BY THE TENNESSEE STATE  
BOARD OF EXAMINERS FOR LAND SURVEYORS

GROUND MEASUREMENTS ARE USED AS THE BASIS FOR LOCATION OF ALL  
FEATURES OF THE SUBJECT PROPERTY.


UNLESS STATED OTHERWISE, ANY MONUMENT REFERRED TO HEREIN AS AN  
"IRON PIN SET" IS A SET 1/2" DIAMETER REBAR, 18" IN LENGTH, WITH A YELLOW  
PLASTIC CAP STAMPED "YOUNG HOBBS" OR A PK NAIL SET WITH A 1-1/2"  
ALUMINUM DISK STAMPED "YOUNG HOBBS".

ALL MATTERS SHOWN ON RECORDED PLATS ARE SHOWN ON SURVEY.

I HEREBY CERTIFY THAT THIS SURVEY HAS BEEN MADE USING THE RECORDED  
INFORMATION SHOWN, AND THAT THIS SURVEY IS CORRECT TO THE BEST OF MY  
KNOWLEDGE AND BELIEF. I HEREBY CERTIFY THAT THIS IS A CATEGORY 1  
SURVEY AND THAT THE RATIO OF PRECISION OF THE UNADJUSTED TRAVERSE IS  
BETTER THAN 1:10,000 AS SHOWN HEREON.



Chick-fil-A  
5200 Buffington Road  
Atlanta, Georgia 30349-2998

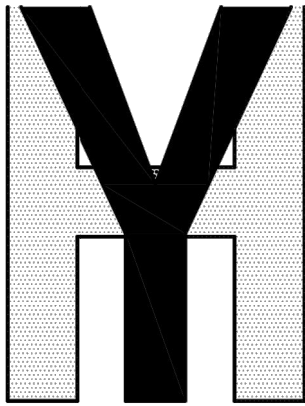

YOUNG - HOBBS  
AND  
ASSOCIATES

1202 Crossland Ave.  
Clarksville, TN 37040  
Phone 931-645-2524  
Fax 931-645-2768

PRELIMINARY,  
NOT FOR RECORDING  
OR TRANSFER

CHICK-FIL-A

HARDIN VALLEY  
KNOXVILLE, TENNESSEE

FSU# 5442


REVISION SCHEDULE		DESCRIPTION
NO.	DATE	TOL COMMENTS
1	5/19/23	
2		

YHA PROJECT #	026-23
DATE (FIELD)	2/15/23
DATE (OFFICE)	2/21/23
CHECKED BY	CTH

ALTA/NSPS LAND  
TITLE SURVEY  
SHEET 1 OF 2  
SHEET NUMBER

C-1.2



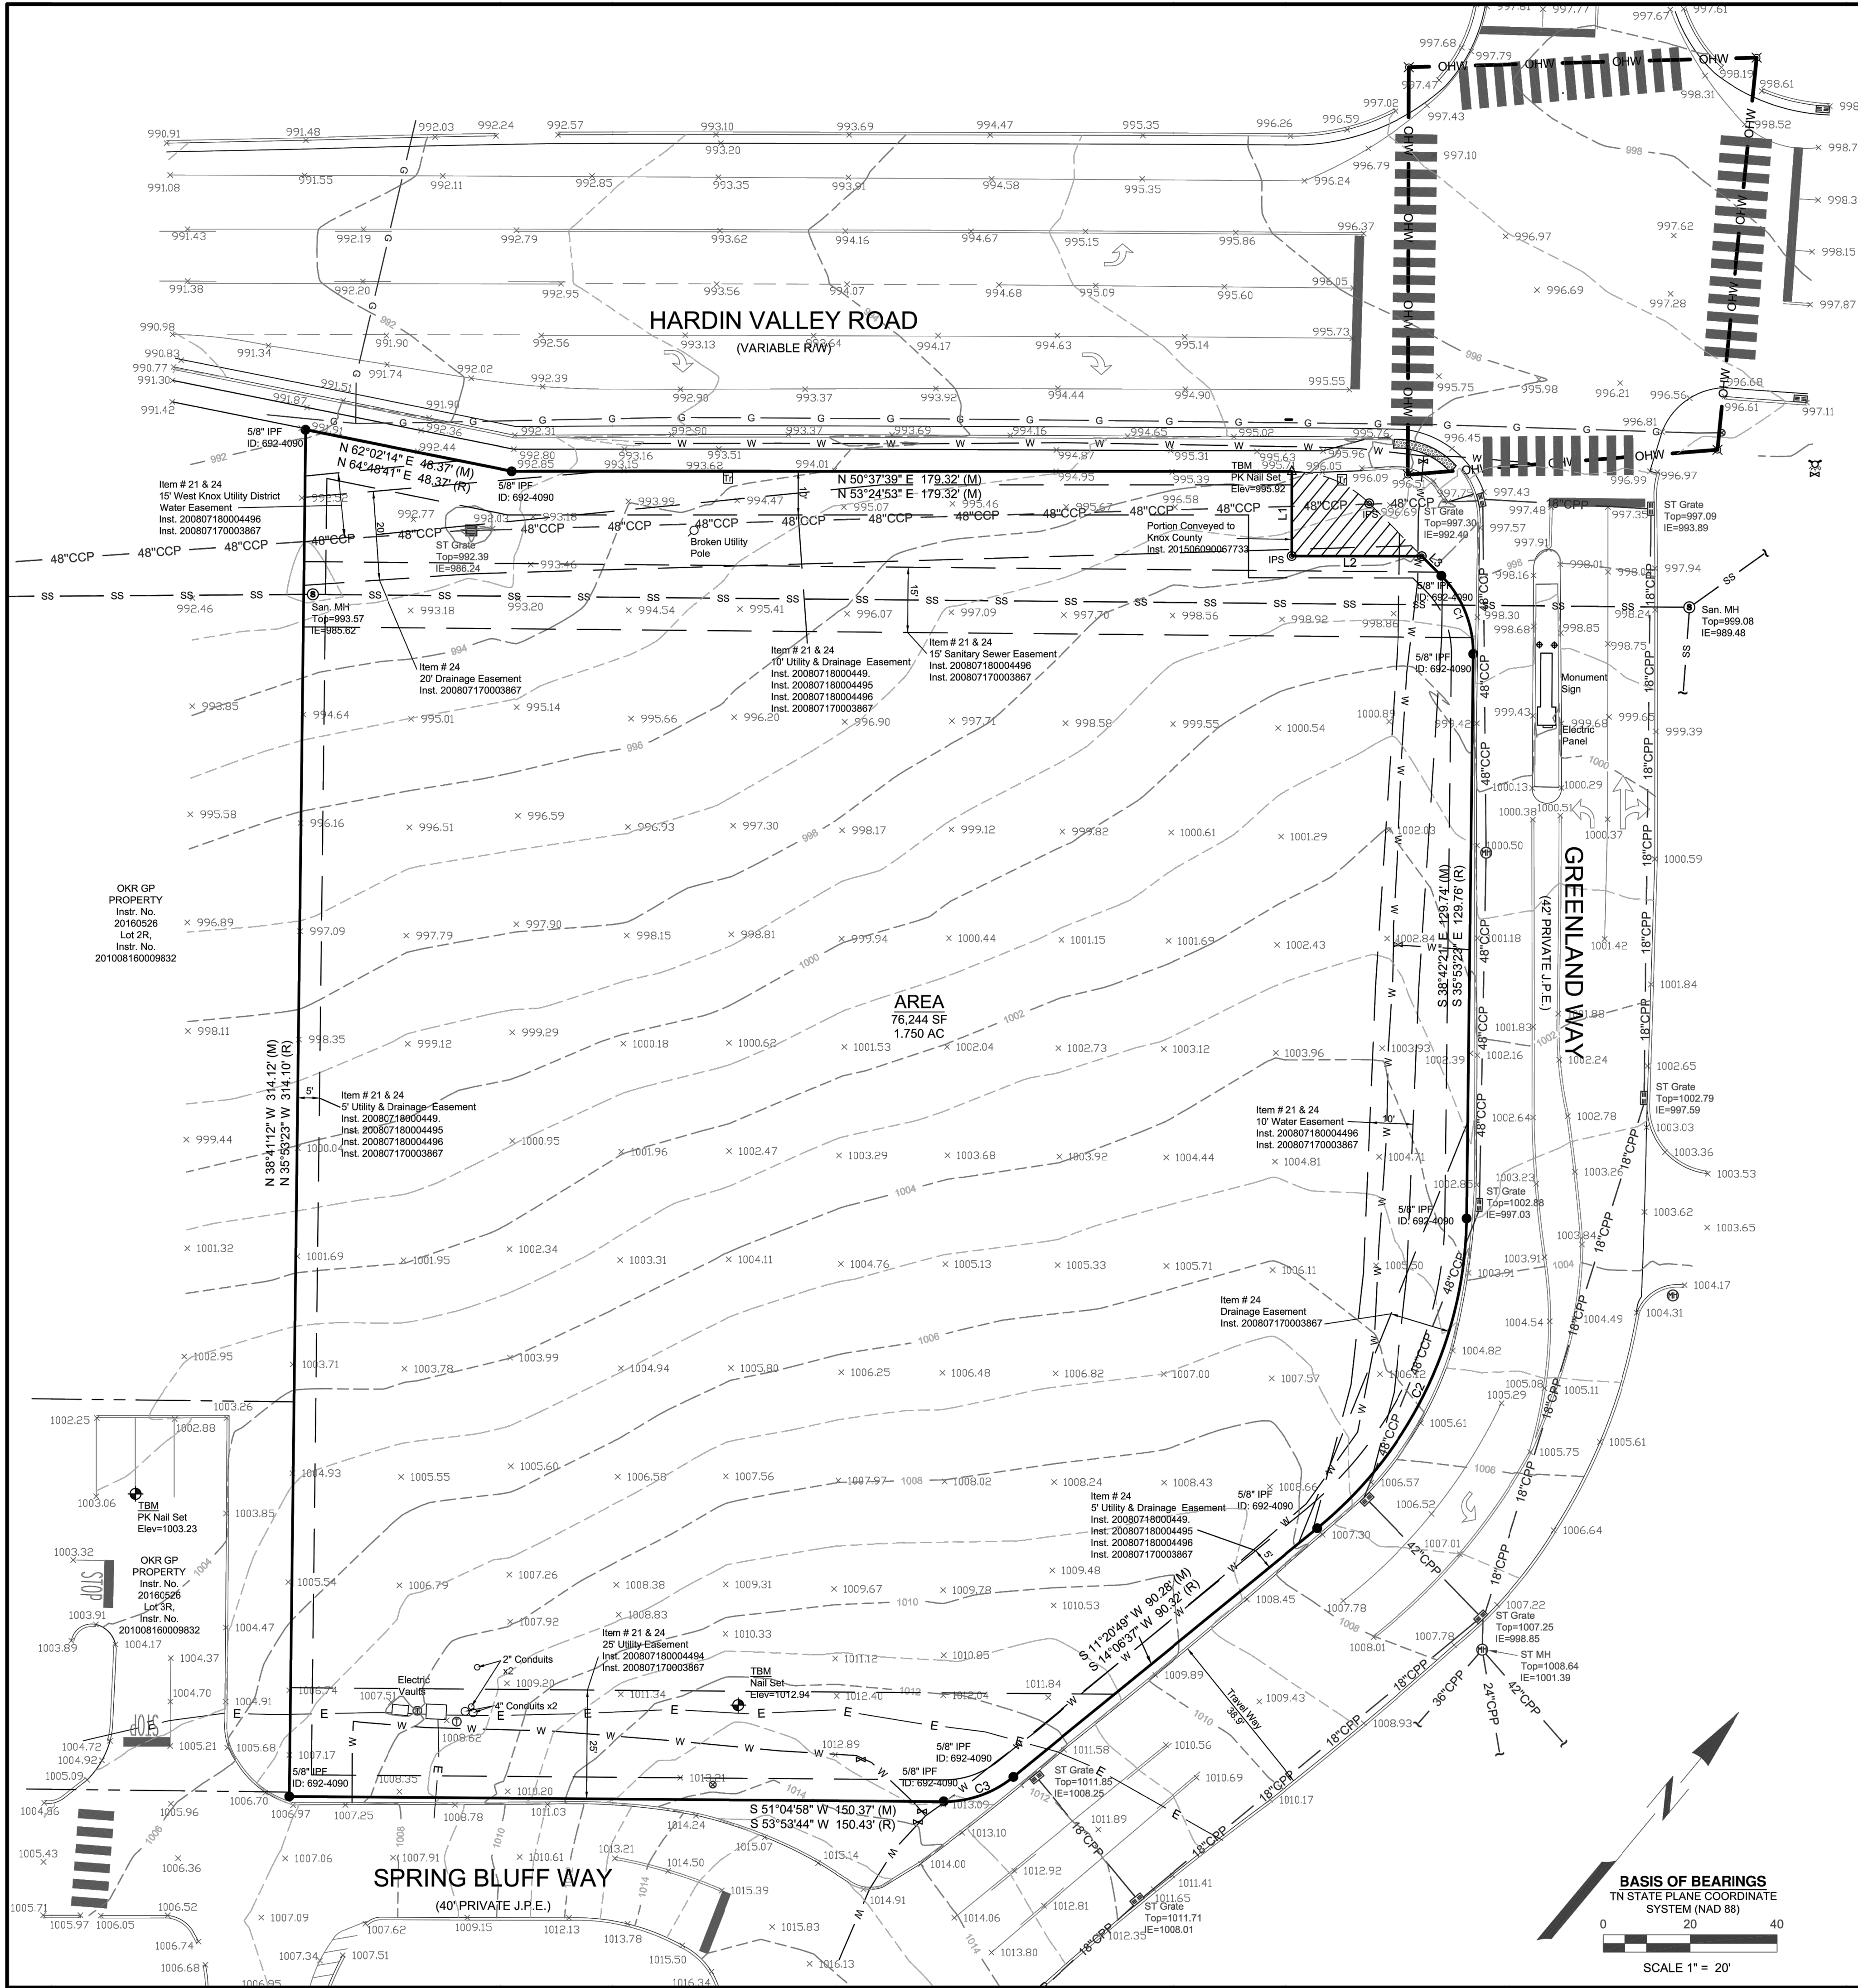

SITE ADDRESS

2187 GREENLAND WAY  
KNOXVILLE, TN 37932

PARKING COUNT

REGULAR - 0  
HANDICAP - 0

CLIENT INFORMATION

CHICK-FIL-A  
5200 BUFFINGTON ROAD  
ATLANTA, GEORGIA 30349-2998

OWNER INFORMATION

OKR, GP  
INST. NO. 201806040071672;  
PLAT OF LOT 4R, THE VILLAGE AT  
HARDIN VALLEY,  
PLAT BOOK 200807170003867  
PARCEL ID 103MA004  
CITY OF KNOXVILLE,  
KNOX COUNTY, TN

Item # 24  
PLAT NOTE: (INSTR. NO. 200807170003867)  
1. JOINT PERMANENT EASEMENT (J.P.E.) ARE NOT A PUBLIC  
ROADS AND WILL NOT BE MAINTAINED BY KNOX COUNTY.  
2. JOINT PERMANENT EASEMENT WILL ALSO FUNCTION AS A  
UTILITY EASEMENT.  
3. THE GRADE OF THE JPE IS 12% OR LESS.  
4. THE DECLARATION OF MAINTENANCE AGREEMENT FOR  
THE JPE IS OF RECORD IN INSTRUMENT #200708310019574  
OF SAID REGISTERS OFFICE.  
5. THE HOMEOWNERS ASSOCIATION HAS BEEN  
ESTABLISHED TO BE RESPONSIBLE FOR THE MAINTENANCE  
OF THE DETENTION BASIN AND COMMON AREAS AND IS OF  
RECORD IN INSTRUMENT #200708310019574 OF SAID  
REGISTERS OFFICE.  
6. ALL LOTS WILL HAVE ACCESS TO INTERIOR STREET  
SYSTEM ONLY.

CURVE	RADIUS	ARC LENGTH	CHORD LENGTH	CHORD BEARING	DELTA ANGLE
C1 M	25.00'	19.93'	19.40'	S 61°29'32" E	45°40'07"
C1 R	25.00'	19.94'	19.41'	S 58°44'15" E	N/A
C2 M	93.50'	81.59'	79.02'	S 13°39'29" E	49°59'47"
C2 R	93.50'	81.59'	79.03'	S 10°53'23" E	N/A
C3 M	25.00'	17.39'	17.04'	S 31°07'34" W	39°50'40"
C3 R	25.00'	17.36'	17.01'	S 34°00'11" W	N/A

LINE	BEARING	DISTANCE
L1 M	S 39°18'48" E	19.45'
L1 R	S 39°18'48" E	19.45'
L2 M	N 50°41'12" E	29.84'
L2 R	N 50°41'12" E	29.86'
L3 M	S 84°19'41" E	6.34'
L3 R	S 84°19'41" E	6.34'

LEGEND

- IRON PIN SET (IPS)
- IRON PIN FOUND, AS NOTED
- BOLLARD
- SEWER MANHOLE
- FIRE HYDRANT
- WATER VALVE
- UTILITY POLE
- TRAFFIC VAULT
- TRAFFIC POLE
- GAS VALVE
- TELEPHONE BOX
- CURB INLET
- GRATE INLET
- STORM MANHOLE
- EASEMENT LINE
- SETBACK LINES
- OHW
- OVERHEAD TRAFFIC WIRE
- UNDERGROUND ELECTRIC
- GAS LINE, AS NOTED
- WATER LINE, AS NOTED
- SANITARY SEWER, AS NOTED
- ST
- STORM SEWER PIPE, AS NOTED

BASIS OF BEARINGS  
TN STATE PLANE COORDINATE  
SYSTEM (NAD 83)


0 20 40

SCALE 1" = 20'



Chick-fil-A

Chick-fil-A  
5200 Buffington Road  
Atlanta, Georgia 30349-2998

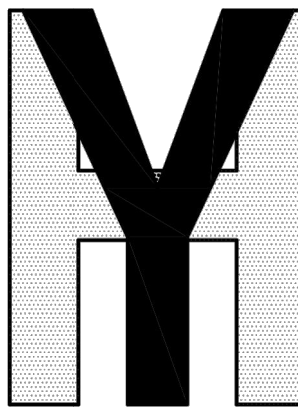

YOUNG - HOBBS  
AND  
ASSOCIATES

1202 CROSSLAND AVE.  
CLARKSVILLE, TN 37040  
PHONE 931-645-2524  
FAX 931-645-2768

PRELIMINARY, NOT  
FOR RECORDING  
OR TRANSFER

CHICK-FIL-A  
HARDIN VALLEY  
KNOXVILLE, TENNESSEE

FSU# 5442

REVISION SCHEDULE	NO.	DATE	DESCRIPTION
1	5/19/23		TOL COMMENTS
2			

YHA PROJECT # 026-23  
DATE (FIELD) 2/15/23  
DATE (OFFICE) 2/2/23  
CHECKED BY CTH

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authorized project representatives.

SHEET

ALTA/NSPS LAND  
TITLE SURVEY  
SHEET 2 OF 2  
SHEET NUMBER



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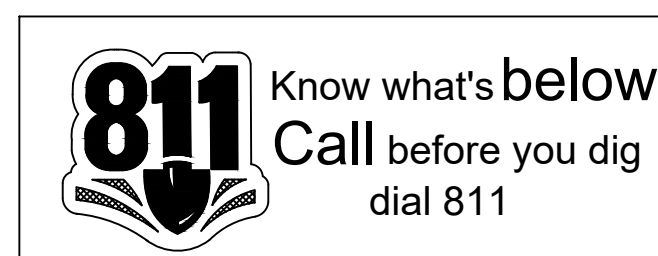
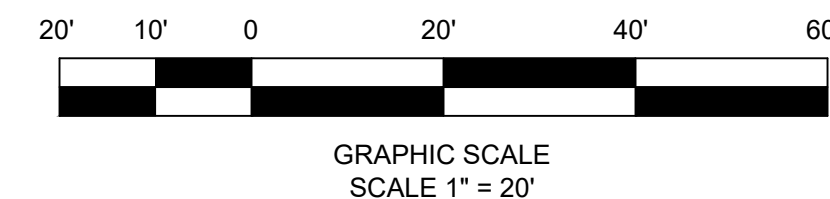
Know what's below.  
Call before you dig.



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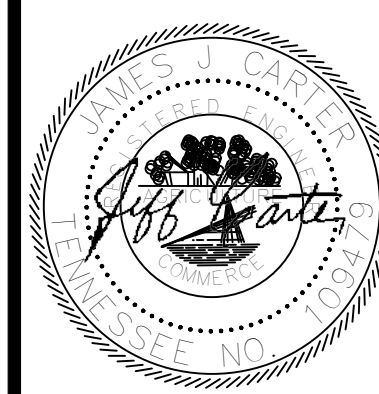


LOCATION MAP  
SCALE: N.T.S.

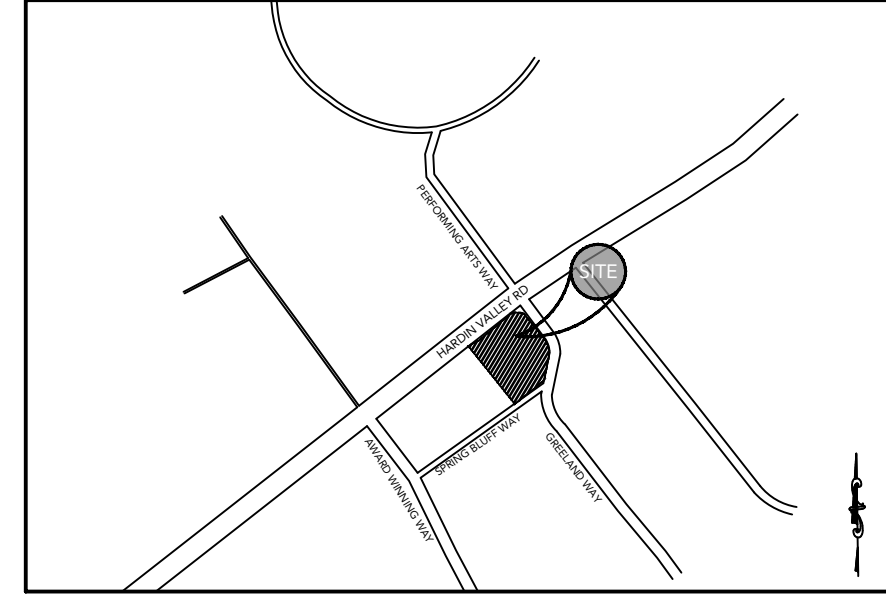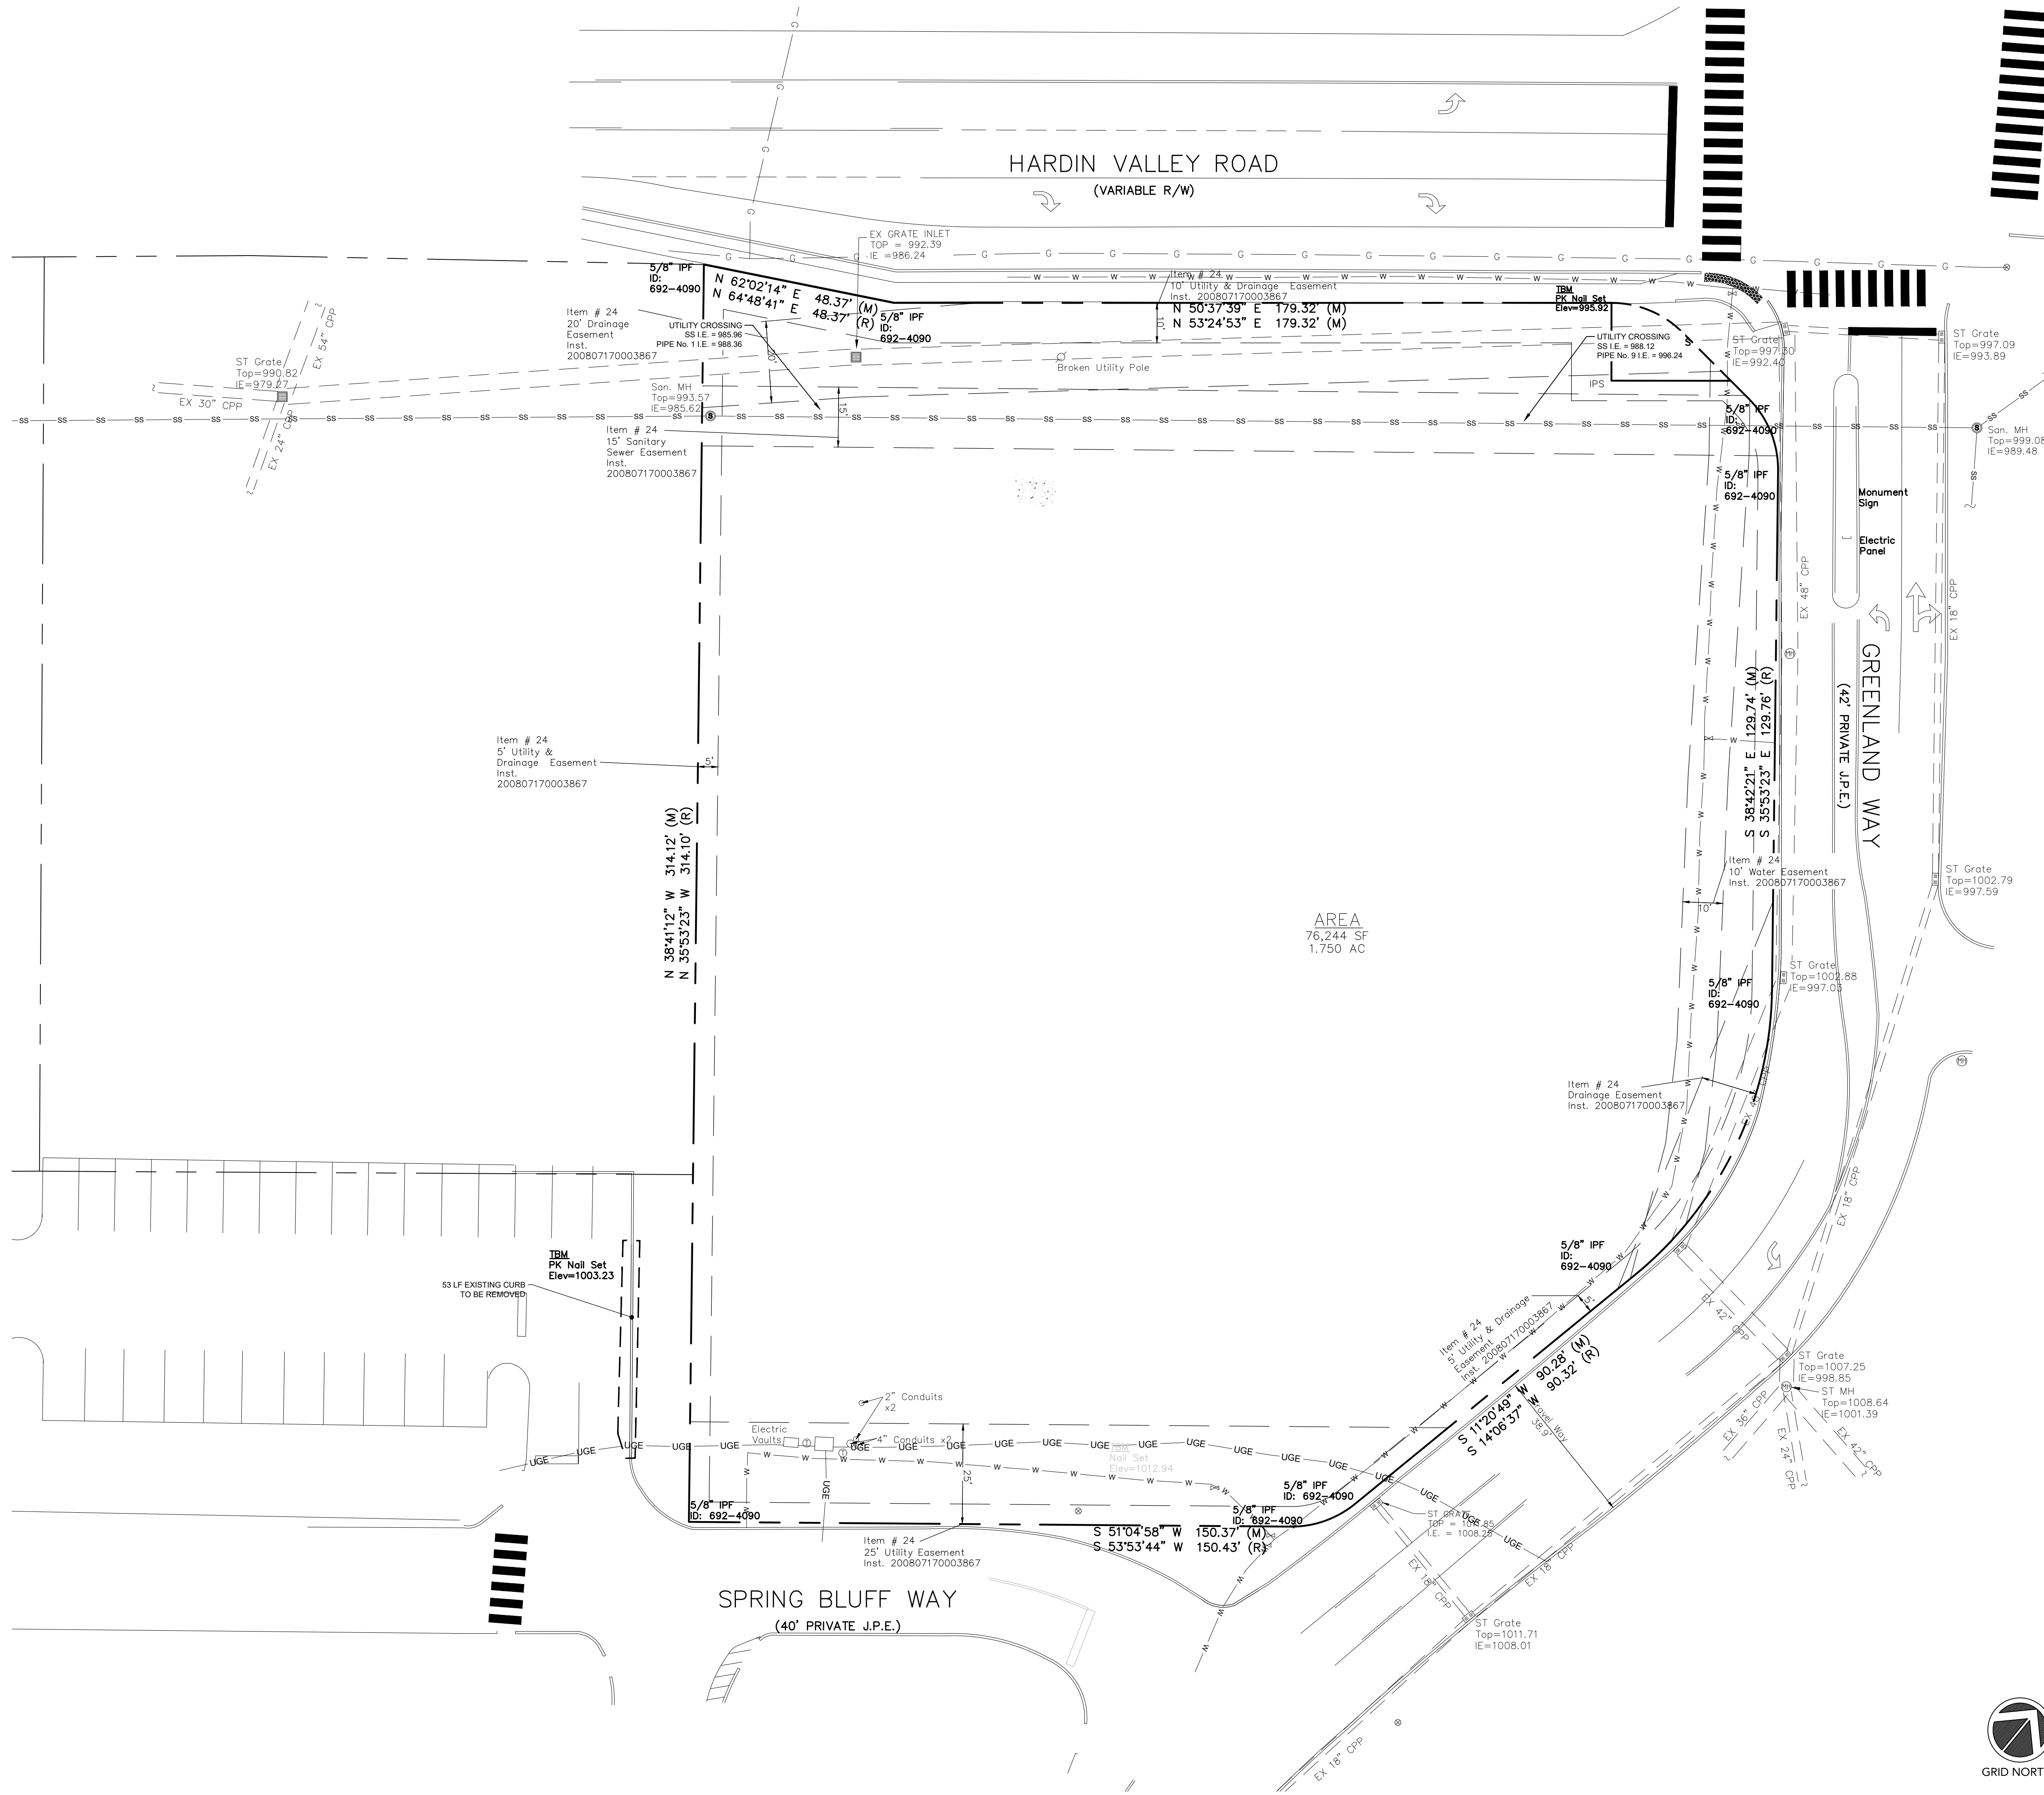

5200 Buffington Rd.  
Atlanta Georgia,  
30349-2998

REVISION BLOCK:				
REV. #	DATE	REVISION	INITIAL REVIEW	PCR
A	06/02/2023	INITIAL REVIEW		
B	06/06/2023	PCR		
C	07/25/2023	TTODA SUBMITTAL		
D	08/28/2023	REVISED PER TTODA COMMENTS		



CARTER ENGINEERING  
1010 COMMERCE DRIVE,  
BOGART, GA 30622

P: 770.725.1200  
F: 770.725.1204  
www.carterengineering.com

HARDIN VALLEY FSU  
STORE # 05442  
9-B-23-TOB / 9-C-23-DP

2187 GREENLAND WAY,  
KNOXVILLE, TN 37932

SHEET TITLE

DEMOLITION  
PLAN

REVISION 4-2023

Job No. : 23043CFA

Store : 05442

Date : 08/28/23

Sheet

C-1.4

ISSUE FOR PERMIT



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SITE PLAN DESIGN NOTES & KEY PLAN

- 1 PAINTED DIRECTIONAL ARROW
- 2 PAINTED DRIVE-THRU GRAPHICS
- 3 PAINTED STOP LINE GRAPHIC
- 4 PAINTED HANDICAP PARKING SYMBOL
- 5 ACCESSIBLE PARKING STALL
- 6B 90' PARKING STALL @ 9' x 18.5' (OR 9'x18')
- 6C BIYCLE PARKING
- 6D DIRECTIONAL SIGNAGE (SEE SIGNAGE PACKAGE)
- 6E "STOP" SIGN (SEE SIGNAGE PACKAGE)
- 6F "ACCESSIBLE PARKING" SIGN (SEE SIGNAGE PACKAGE)
- 6G "SINGLE BUILDING FOR DRIVE-THRU SERVICE" (SEE SIGNAGE PACKAGE)
- 6H "RIGHT TURN ONLY" SIGN (SEE SIGNAGE PACKAGE)
- 6I "ONE WAY" SIGN (USE APPLICABLE DIRECTION) (SEE SIGNAGE PACKAGE)
- 6J "LEFT TURN ONLY" SIGN (SEE SIGNAGE PACKAGE)
- 6K "PEDESTRIAN CROSSWALK" SIGN (SEE SIGNAGE PACKAGE)
- 6L "DO NOT ENTER" SIGN (SEE SIGNAGE PACKAGE)
- 6M TWO PARKING SIGN (SEE SIGNAGE PACKAGE)
- 6N TWO ORDER LANE SIGN (SEE SIGNAGE PACKAGE)
- 6O LANE MERGE SIGN (SEE SIGNAGE PACKAGE)
- 7 SIDEWALK ACCESSIBLE RAMP
- 8 CURB RAMP WITH FLARED SIDES
- 8A CURB RAMP WITH SHORT FLARED SIDES
- 8B RETURNED CURB ACCESSIBLE RAMP
- 10 TRUNCATED DOMES - CAST IN PLACE (ONLY IF REQUIRED)
- 11 TYPICAL CONCRETE SIDEWALK (SEE DETAIL FOR REVISIONS)
- 11A TYPICAL CONCRETE SIDEWALK SECTION WITH ADDED BLACK TINT MIX FOR AREAS WITH A CROSS SLOPE TO STEEP FOR PEDESTRIAN ACCESS
- 12 SIDEWALK WITH CURB & GUTTER SECTION (SEE DETAIL FOR REVISIONS)
- 13 DRIVE-THRU PLAN
- 14 DRIVE-THRU ISOMETRIC
- 15 CONCRETE WHEEL STOP
- 16 LANDSCAPE & IRRIGATION PROTECTOR
- 17 24" CONCRETE CURB & GUTTER
- 17A SPILLING 24" CONCRETE CURB & GUTTER
- 17B CATCHING 24" CONCRETE CURB & GUTTER
- 17C CURB HEIGHT TO MATCH CONC. PAVEMENT AT DRIVE-THRU DOOR
- 17D TRANSITION CURB HEIGHT W/ RAMPED CONC. PAVEMENT TO MATCH LEVEL PAVEMENT AT DRIVE-THRU DOOR
- 18 ROLL-OVER MOUNTABLE CURB
- 19 SCREENED REFUSE ENCLOSURE
- 19A SCREENED REFUSE ENCLOSURE - STAGGERED
- 19B SCREENED REFUSE ENCLOSURE - ALTERNATE DRAINAGE
- 20 CONCRETE BOLLARD
- 21A TYPICAL PAVEMENT SECTION - MEDIUM DUTY
- 21B TYPICAL PAVEMENT SECTION - HEAVY DUTY
- 21C LIGHT DUTY PAVEMENT RESURFACE
- 22 TRANSVERSE & LONGITUDINAL CONTRACTION JOINT
- 23 TRANSVERSE & LONGITUDINAL DOWELED CONSTRUCTION JOINT
- 24 CONCRETE APRON @ TRASH ENCLOSURE
- 25 CONCRETE PAVING
- 26 ALUMINUM HANDRAIL
- 27 TYPICAL ADA RAMP AND HANDRAIL
- 28 CONTRACTION JOINT
- 29 KEVED CONSTRUCTION JOINT
- 30 LONGITUDINAL BUTT JOINT
- 31 EXPANSION JOINT
- 32 MULTILANE DIRECTIONAL GRAPHICS
- 33 PAINTED CROSS WALK
- 34 MENU BOARD & CANOPY ORDERING STATION
- 35 MENU BOARD LOOP DETECTION SYSTEM
- 36 5'x5' LANDING AND ENTRY DOOR FROST SLAB
- 37 GREASE TRAP (SEE DRAINAGE PLAN)
- 38 ROOF DOWNSPOUT (TO CONNECT TO SITE DRAINAGE SYSTEM)
- 39 LANDSCAPED AREA (SEE LANDSCAPE PLAN)
- 40 CLEARANCE BAR (SEE SIGNAGE PACKAGE)
- 41 PAVEMENT STRIPING AREA
- 42 THICKENED SLAB EDGE AT RAILING CORE GRILLS
- 43 CONCRETE FLUME
- 44 EX. ASPHALT / PROP. CONCRETE INTERFACE
- 45 EX. PROP. ASPHALT INTERFACE
- 45A EX. PROP. CURB INTERFACE
- 46 EX. PROP. CONCRETE INTERFACE
- 47A SHORT TERM BIKE PARKING
- 47B LONG TERM BIKE PARKING
- 48 TRANSFORMER
- 49 CHICK-FIL-A PRIME SIGN (SEE SIGNAGE PACKAGE)
- 50 FLAGPOLE, 50' (SEE SIGNAGE PACKAGE)
- 51 RETAINING WALL WITH HANDRAIL ON TOP
- 52 TYPICAL LOCATION FOR THREE OUTDOOR TABLES WHEN MORE SPACE IS AVAILABLE, OUTDOOR SEATING MAY BE EXPANDED.
- 53 4" THICK CONCRETE STRIP BETWEEN BUILDING AND BACK OF CURB
- 54 6" THICK CONCRETE SIDEWALK BETWEEN DRIVE-THRU LANE AND BUILDING
- 55 4" WIDE PAINT STRIPE
- 56 STANDARD LIGHT POLE
- 57 DRIVEWAY DELIVERY SIGN (SEE SIGNAGE PACKAGE)
- 58 CONCRETE STRIPING AREA. CONCRETE TO BE PER CONCRETE PAVING DETAIL ON SHEET C-5.1
- 59 CONCRETE VALLEY BUTTER
- 60A 4" WIDE CONCRETE FLUME
- 60B 3" WIDE CONCRETE FLUME
- 61 GATERING & GARRY-OUT (SEE SIGNAGE PACKAGE)
- 62 CURBSIDE DELIVERY (SEE SIGNAGE PACKAGE)
- 63 2" WIDE 4" THICK CONCRETE LANDSCAPE PROTECTION STRIP



LOCATION MAP  
SCALE: N.T.S.

SITE DATA:

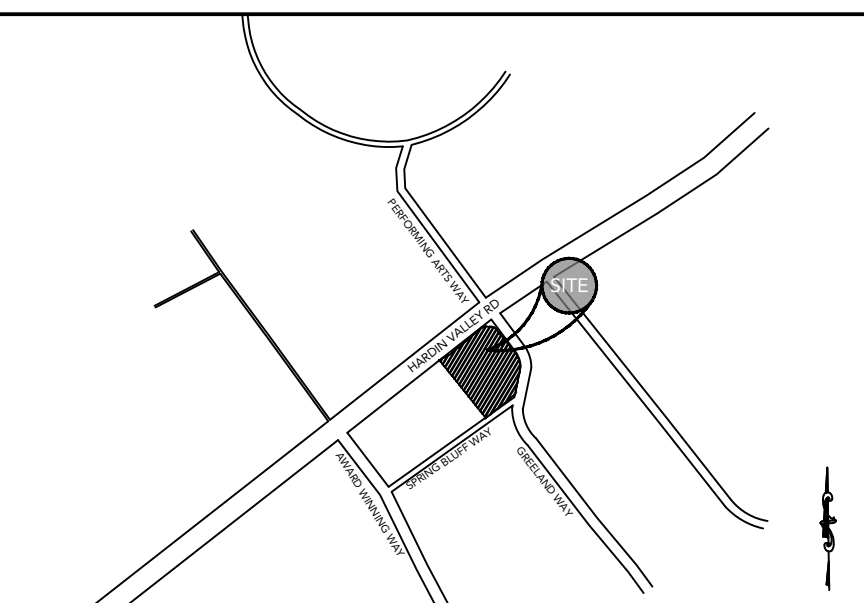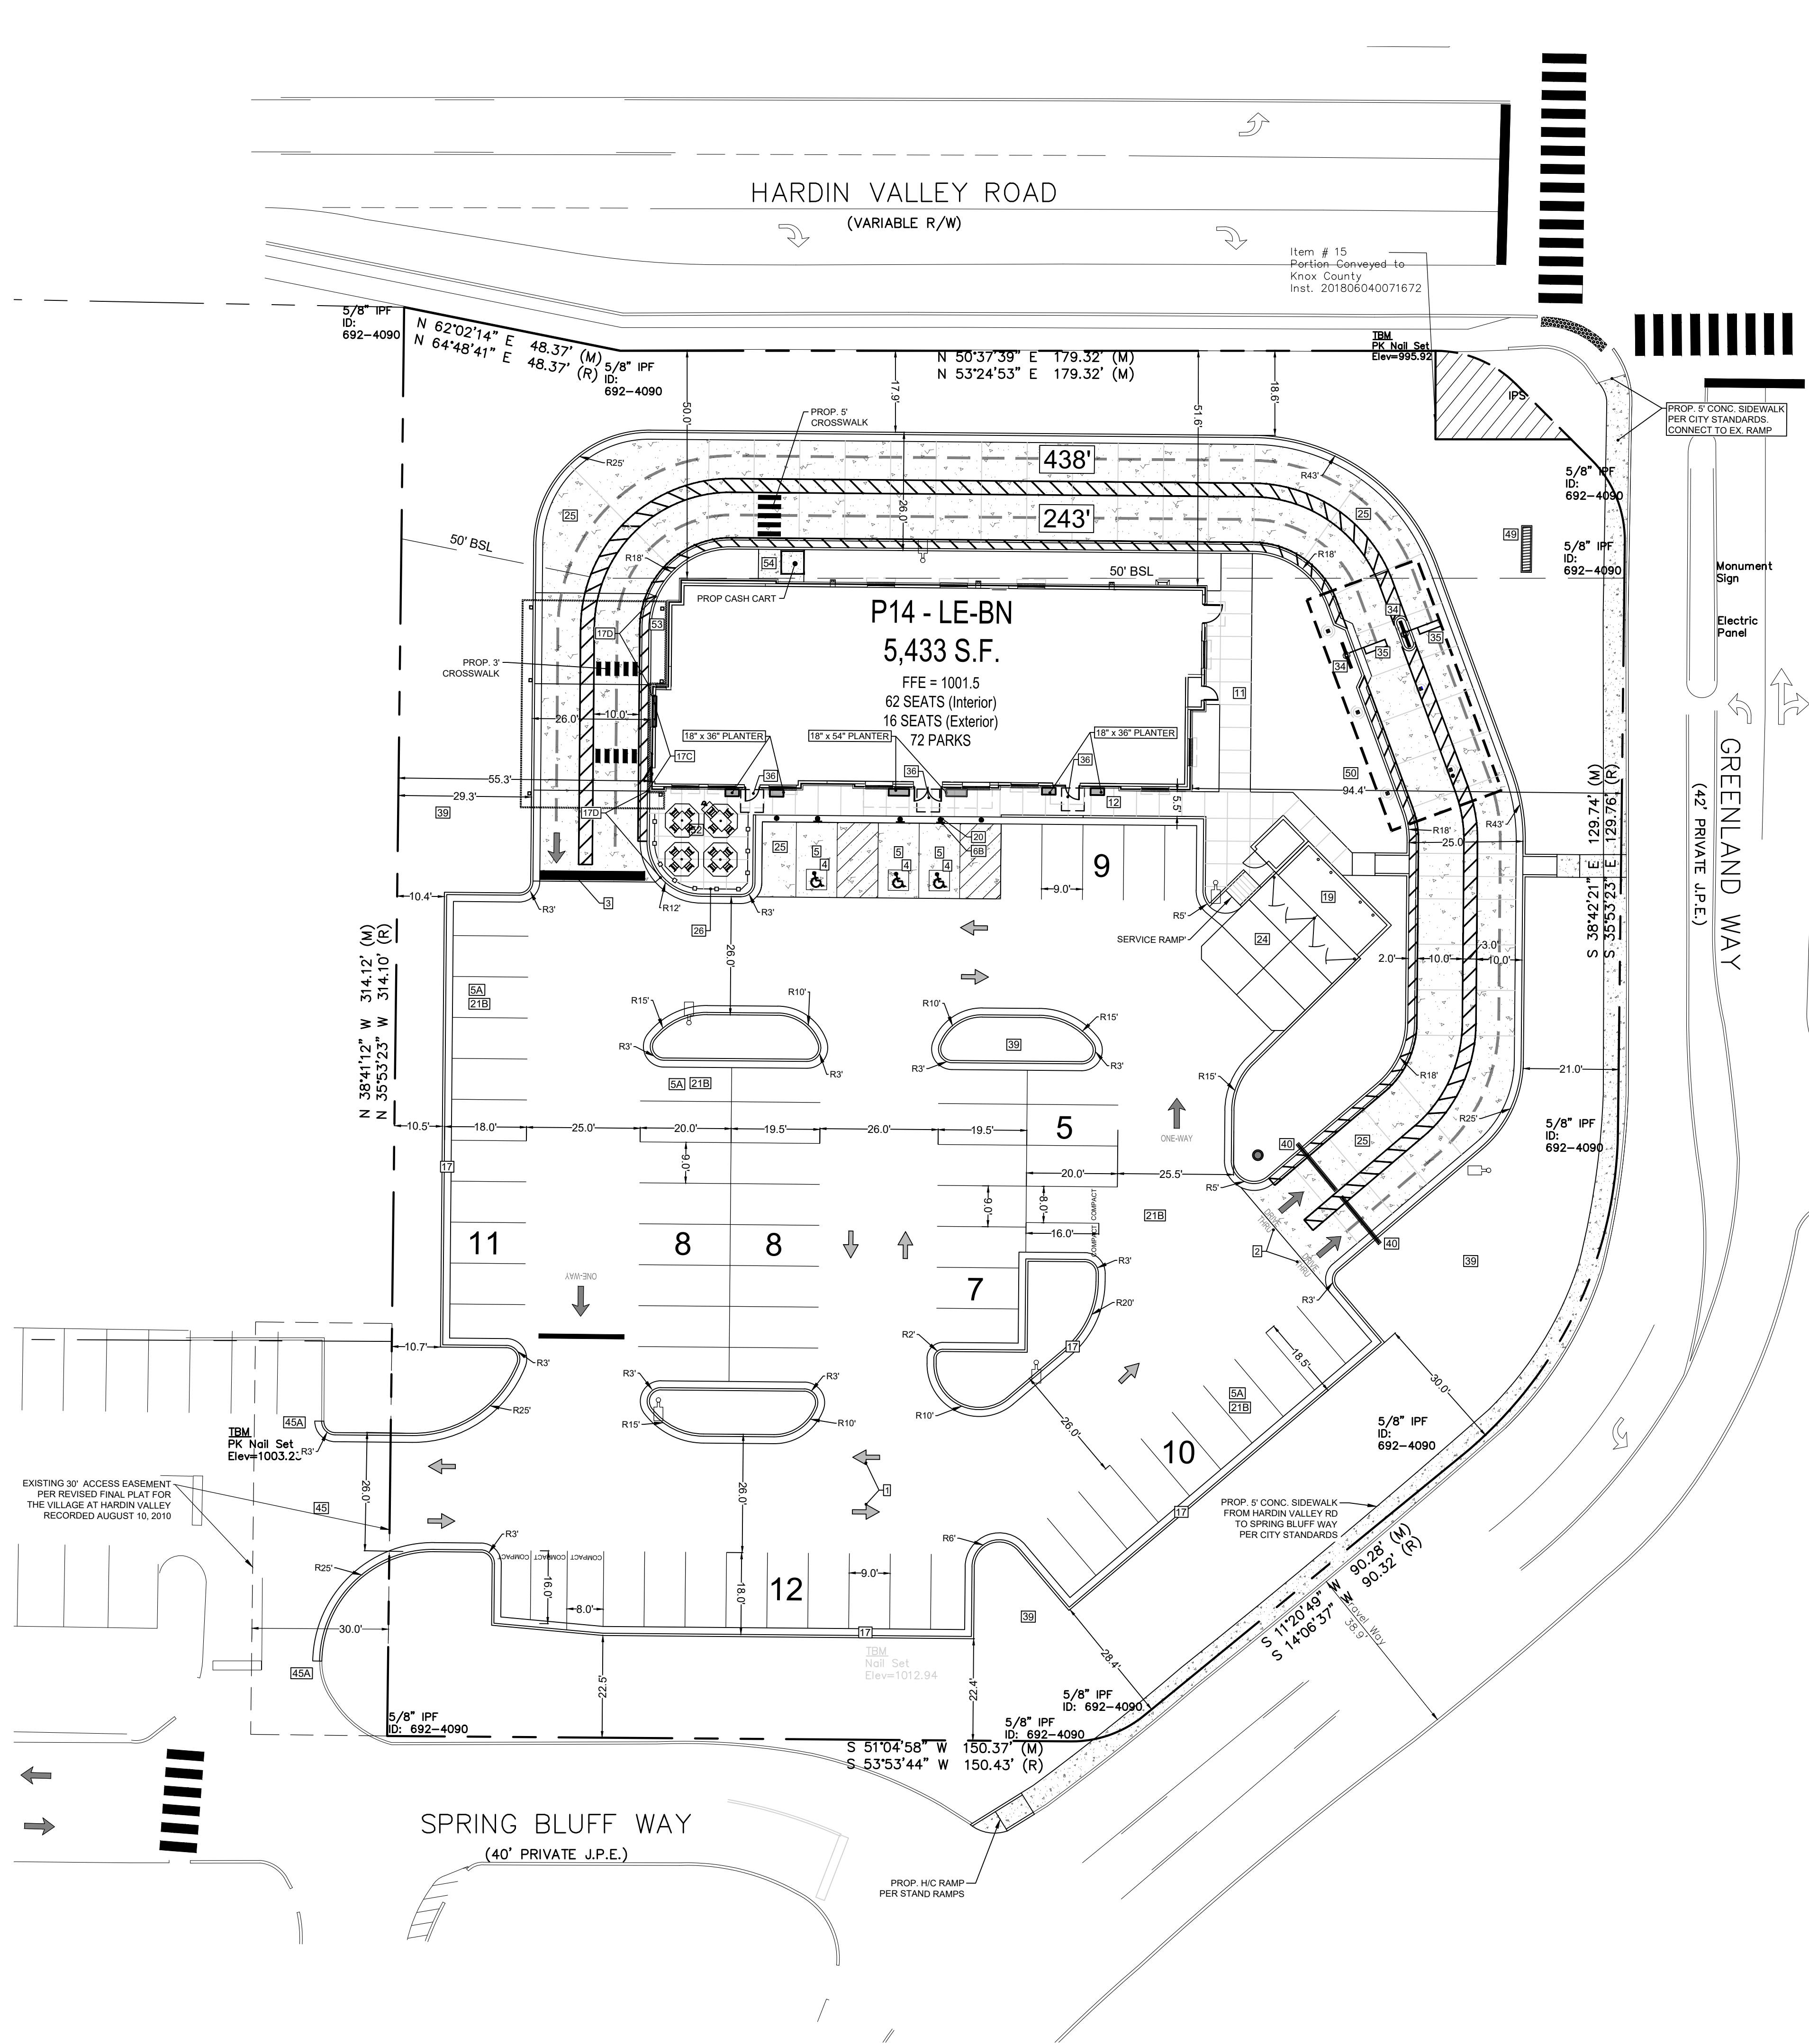TOTAL SITE AREA:	1.75
BUILDING AREA:	5,872 S.F.
PROP. IMPERVIOUS AREA:	1.14 ACRES
PROP. IMPERVIOUS COVERAGE:	65%
PROP. OPEN SPACE:	35%
DISTURBED AREA:	1.5 AC

5200 Buffington Rd.  
Atlanta Georgia,  
30349-2998

REVISION BLOCK:		REVISION	DATE	INITIAL REVIEW
REV. #	A	B	C	D
	06/02/2023	06/06/2023	07/25/2023	08/28/2023
	PCR	PCR	TTODA SUBMITTAL	REVISED PER TTODA COMMENTS



CARTER  
ENGINEERING

CARTER ENGINEERING  
1010 COMMERCE DRIVE,  
BOGART, GA 30622

P: 770.725.1200  
F: 770.725.1204  
www.carterengineering.com

HARDIN VALLEY FSU  
STORE # 05442  
9-B-23-TOB / 9-C-23-DP

2187 GREENLAND WAY,  
KNOXVILLE, TN 37932

SHEET TITLE


SITE PLAN

REVISION 4-2023

Job No. : 23043CFA  
Store : 05442  
Date : 08/28/23

Issue for Permit  
Sheet

C-2.0

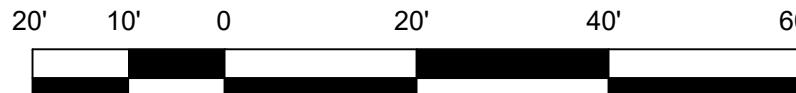

GRAPHIC SCALE  
SCALE 1" = 20'

ENGINEER/DESIGNER NOT RESPONSIBLE FOR COST CHANGES DURING PRELIMINARY PHASE. BIDS & QUOTES SHALL BE BASED ON PLANS SETS LABELED "ISSUE FOR BID". BIDS & QUOTES SHALL BE REVISED BASED ON PLANS LABELED "ISSUE FOR CONSTRUCTION".



LAYOUT NOTES

1. INSTALL 2" DOMESTIC WATER SERVICE CONNECTION PER WATER COMPANY'S SPECIFICATIONS AND REQUIREMENTS. WATER COMPANY TO MAKE TAP.
- 1A. INSTALL 4" IRRIGATION WATER SERVICE CONNECTION FROM FEED WATER COMPANY'S SPECIFICATIONS AND REQUIREMENTS. WATER COMPANY TO MAKE TAP.
- 1B. INSTALL 4" FIRE PROTECTION LINE CONNECTION TO INCLUDE MARKING TAP. (FIRE LINE BACKFLOW HAS TO BE A DCGA BACKFLOW. NO AMES BACKFLOW ALLOWED).

2. REDUCED PRESSURE ASSEMBLY

THE CONTRACTOR SHALL INSTALL A BACKFLOW PREVENTER (RBCO, OR APPROVED EQUAL) FOR SERVICE LINE INDICATED ON DRAWING. INSTALLATION SHALL INCLUDE BOX OR VAULT, AS APPLICABLE. THE CONTRACTOR SHALL COORDINATE WITH KNOXVILLE AND COUNTY FOR INSPECTION, TESTING, AND CERTIFICATION OF BACKFLOW PREVENTER. ALL BACKFLOW DEVICES SHALL BE INSTALLED IN ACCORDANCE WITH THE WATER DEPT. STANDARD SPECIFICATIONS. THE CONTRACTOR'S BID PRICE SHALL INCLUDE ALL COST ASSOCIATED WITH DEVICE INSTALLATION, INSPECTION, TESTING, CERTIFICATION, ETC. TO INCLUDE ANY FEES CHARGED BY THE WATER DEPARTMENT. TESTING OF BACKFLOW DEVICE SHALL BE COMPLETED BY A CERTIFIED BACKFLOW DEVICE TESTER. ALL TEST RESULTS SHALL BE SUBMITTED TO THE WATER DEPARTMENT.

2A. REDUCED PRESSURE ASSEMBLY

SEE NOTES ITEM # 2 ABOVE - INSPECTION, TESTING AND CERTIFICATION

3. INSTALL 2" TYPE K COPPER DOMESTIC WATER SERVICE PER WATER COMPANY'S SPECIFICATIONS AND REQUIREMENTS. SITE CONTRACTOR TO COORDINATE WITH BUILDING AND PLUMBING CONTRACTOR.
- 3A. UTILITY CROSSING: 4" TYPE K COPPER DRINKING WATER SERVICE PER WATER COMPANY'S SPECIFICATIONS AND REQUIREMENTS. SITE CONTRACTOR TO COORDINATE WITH BUILDING, PLUMBING AND FIRE PROTECTION CONTRACTOR.

- 3B. UTILITY CROSSING: 4" TYPE K COPPER DRINKING WATER SERVICE PER WATER COMPANY'S SPECIFICATIONS AND REQUIREMENTS. SITE CONTRACTOR TO COORDINATE WITH BUILDING, PLUMBING AND FIRE PROTECTION CONTRACTOR.

4. INSTALL 4" ANWA C-800 WATER MAIN FOR FIRE PROTECTION PER WATER COMPANY'S SPECIFICATIONS AND REQUIREMENTS. SITE CONTRACTOR TO COORDINATE WITH BUILDING, PLUMBING AND FIRE PROTECTION CONTRACTOR.

- 4A. UTILITY CROSSING: 4" TYPE K COPPER DRINKING WATER SERVICE PER WATER COMPANY'S SPECIFICATIONS AND REQUIREMENTS. SITE CONTRACTOR TO COORDINATE WITH BUILDING, PLUMBING AND FIRE PROTECTION CONTRACTOR.

- 4B. UTILITY CROSSING: 4" TYPE K COPPER DRINKING WATER SERVICE PER WATER COMPANY'S SPECIFICATIONS AND REQUIREMENTS. SITE CONTRACTOR TO COORDINATE WITH BUILDING, PLUMBING AND FIRE PROTECTION CONTRACTOR.

- 4C. UTILITY CROSSING: 4" TYPE K COPPER DRINKING WATER SERVICE PER WATER COMPANY'S SPECIFICATIONS AND REQUIREMENTS. SITE CONTRACTOR TO COORDINATE WITH BUILDING, PLUMBING AND FIRE PROTECTION CONTRACTOR.

- 4D. UTILITY CROSSING: 4" TYPE K COPPER DRINKING WATER SERVICE PER WATER COMPANY'S SPECIFICATIONS AND REQUIREMENTS. SITE CONTRACTOR TO COORDINATE WITH BUILDING, PLUMBING AND FIRE PROTECTION CONTRACTOR.

- 4E. UTILITY CROSSING: 4" TYPE K COPPER DRINKING WATER SERVICE PER WATER COMPANY'S SPECIFICATIONS AND REQUIREMENTS. SITE CONTRACTOR TO COORDINATE WITH BUILDING, PLUMBING AND FIRE PROTECTION CONTRACTOR.

- 4F. UTILITY CROSSING: 4" TYPE K COPPER DRINKING WATER SERVICE PER WATER COMPANY'S SPECIFICATIONS AND REQUIREMENTS. SITE CONTRACTOR TO COORDINATE WITH BUILDING, PLUMBING AND FIRE PROTECTION CONTRACTOR.

- 4G. UTILITY CROSSING: 4" TYPE K COPPER DRINKING WATER SERVICE PER WATER COMPANY'S SPECIFICATIONS AND REQUIREMENTS. SITE CONTRACTOR TO COORDINATE WITH BUILDING, PLUMBING AND FIRE PROTECTION CONTRACTOR.

- 4H. UTILITY CROSSING: 4" TYPE K COPPER DRINKING WATER SERVICE PER WATER COMPANY'S SPECIFICATIONS AND REQUIREMENTS. SITE CONTRACTOR TO COORDINATE WITH BUILDING, PLUMBING AND FIRE PROTECTION CONTRACTOR.

- 4I. UTILITY CROSSING: 4" TYPE K COPPER DRINKING WATER SERVICE PER WATER COMPANY'S SPECIFICATIONS AND REQUIREMENTS. SITE CONTRACTOR TO COORDINATE WITH BUILDING, PLUMBING AND FIRE PROTECTION CONTRACTOR.

- 4J. UTILITY CROSSING: 4" TYPE K COPPER DRINKING WATER SERVICE PER WATER COMPANY'S SPECIFICATIONS AND REQUIREMENTS. SITE CONTRACTOR TO COORDINATE WITH BUILDING, PLUMBING AND FIRE PROTECTION CONTRACTOR.

- 4K. UTILITY CROSSING: 4" TYPE K COPPER DRINKING WATER SERVICE PER WATER COMPANY'S SPECIFICATIONS AND REQUIREMENTS. SITE CONTRACTOR TO COORDINATE WITH BUILDING, PLUMBING AND FIRE PROTECTION CONTRACTOR.

- 4L. UTILITY CROSSING: 4" TYPE K COPPER DRINKING WATER SERVICE PER WATER COMPANY'S SPECIFICATIONS AND REQUIREMENTS. SITE CONTRACTOR TO COORDINATE WITH BUILDING, PLUMBING AND FIRE PROTECTION CONTRACTOR.

- 4M. UTILITY CROSSING: 4" TYPE K COPPER DRINKING WATER SERVICE PER WATER COMPANY'S SPECIFICATIONS AND REQUIREMENTS. SITE CONTRACTOR TO COORDINATE WITH BUILDING, PLUMBING AND FIRE PROTECTION CONTRACTOR.

- 4N. UTILITY CROSSING: 4" TYPE K COPPER DRINKING WATER SERVICE PER WATER COMPANY'S SPECIFICATIONS AND REQUIREMENTS. SITE CONTRACTOR TO COORDINATE WITH BUILDING, PLUMBING AND FIRE PROTECTION CONTRACTOR.

- 4O. UTILITY CROSSING: 4" TYPE K COPPER DRINKING WATER SERVICE PER WATER COMPANY'S SPECIFICATIONS AND REQUIREMENTS. SITE CONTRACTOR TO COORDINATE WITH BUILDING, PLUMBING AND FIRE PROTECTION CONTRACTOR.

- 4P. UTILITY CROSSING: 4" TYPE K COPPER DRINKING WATER SERVICE PER WATER COMPANY'S SPECIFICATIONS AND REQUIREMENTS. SITE CONTRACTOR TO COORDINATE WITH BUILDING, PLUMBING AND FIRE PROTECTION CONTRACTOR.

- 4Q. UTILITY CROSSING: 4" TYPE K COPPER DRINKING WATER SERVICE PER WATER COMPANY'S SPECIFICATIONS AND REQUIREMENTS. SITE CONTRACTOR TO COORDINATE WITH BUILDING, PLUMBING AND FIRE PROTECTION CONTRACTOR.

- 4R. UTILITY CROSSING: 4" TYPE K COPPER DRINKING WATER SERVICE PER WATER COMPANY'S SPECIFICATIONS AND REQUIREMENTS. SITE CONTRACTOR TO COORDINATE WITH BUILDING, PLUMBING AND FIRE PROTECTION CONTRACTOR.

- 4S. UTILITY CROSSING: 4" TYPE K COPPER DRINKING WATER SERVICE PER WATER COMPANY'S SPECIFICATIONS AND REQUIREMENTS. SITE CONTRACTOR TO COORDINATE WITH BUILDING, PLUMBING AND FIRE PROTECTION CONTRACTOR.

- 4T. UTILITY CROSSING: 4" TYPE K COPPER DRINKING WATER SERVICE PER WATER COMPANY'S SPECIFICATIONS AND REQUIREMENTS. SITE CONTRACTOR TO COORDINATE WITH BUILDING, PLUMBING AND FIRE PROTECTION CONTRACTOR.

- 4U. UTILITY CROSSING: 4" TYPE K COPPER DRINKING WATER SERVICE PER WATER COMPANY'S SPECIFICATIONS AND REQUIREMENTS. SITE CONTRACTOR TO COORDINATE WITH BUILDING, PLUMBING AND FIRE PROTECTION CONTRACTOR.

- 4V. UTILITY CROSSING: 4" TYPE K COPPER DRINKING WATER SERVICE PER WATER COMPANY'S SPECIFICATIONS AND REQUIREMENTS. SITE CONTRACTOR TO COORDINATE WITH BUILDING, PLUMBING AND FIRE PROTECTION CONTRACTOR.

- 4W. UTILITY CROSSING: 4" TYPE K COPPER DRINKING WATER SERVICE PER WATER COMPANY'S SPECIFICATIONS AND REQUIREMENTS. SITE CONTRACTOR TO COORDINATE WITH BUILDING, PLUMBING AND FIRE PROTECTION CONTRACTOR.

- 4X. UTILITY CROSSING: 4" TYPE K COPPER DRINKING WATER SERVICE PER WATER COMPANY'S SPECIFICATIONS AND REQUIREMENTS. SITE CONTRACTOR TO COORDINATE WITH BUILDING, PLUMBING AND FIRE PROTECTION CONTRACTOR.

- 4Y. UTILITY CROSSING: 4" TYPE K COPPER DRINKING WATER SERVICE PER WATER COMPANY'S SPECIFICATIONS AND REQUIREMENTS. SITE CONTRACTOR TO COORDINATE WITH BUILDING, PLUMBING AND FIRE PROTECTION CONTRACTOR.

- 4Z. UTILITY CROSSING: 4" TYPE K COPPER DRINKING WATER SERVICE PER WATER COMPANY'S SPECIFICATIONS AND REQUIREMENTS. SITE CONTRACTOR TO COORDINATE WITH BUILDING, PLUMBING AND FIRE PROTECTION CONTRACTOR.

- 4AA. UTILITY CROSSING: 4" TYPE K COPPER DRINKING WATER SERVICE PER WATER COMPANY'S SPECIFICATIONS AND REQUIREMENTS. SITE CONTRACTOR TO COORDINATE WITH BUILDING, PLUMBING AND FIRE PROTECTION CONTRACTOR.

- 4AB. UTILITY CROSSING: 4" TYPE K COPPER DRINKING WATER SERVICE PER WATER COMPANY'S SPECIFICATIONS AND REQUIREMENTS. SITE CONTRACTOR TO COORDINATE WITH BUILDING, PLUMBING AND FIRE PROTECTION CONTRACTOR.

- 4AC. UTILITY CROSSING: 4" TYPE K COPPER DRINKING WATER SERVICE PER WATER COMPANY'S SPECIFICATIONS AND REQUIREMENTS. SITE CONTRACTOR TO COORDINATE WITH BUILDING, PLUMBING AND FIRE PROTECTION CONTRACTOR.

- 4AD. UTILITY CROSSING: 4" TYPE K COPPER DRINKING WATER SERVICE PER WATER COMPANY'S SPECIFICATIONS AND REQUIREMENTS. SITE CONTRACTOR TO COORDINATE WITH BUILDING, PLUMBING AND FIRE PROTECTION CONTRACTOR.

- 4AE. UTILITY CROSSING: 4" TYPE K COPPER DRINKING WATER SERVICE PER WATER COMPANY'S SPECIFICATIONS AND REQUIREMENTS. SITE CONTRACTOR TO COORDINATE WITH BUILDING, PLUMBING AND FIRE PROTECTION CONTRACTOR.

- 4AF. UTILITY CROSSING: 4" TYPE K COPPER DRINKING WATER SERVICE PER WATER COMPANY'S SPECIFICATIONS AND REQUIREMENTS. SITE CONTRACTOR TO COORDINATE WITH BUILDING, PLUMBING AND FIRE PROTECTION CONTRACTOR.

- 4AG. UTILITY CROSSING: 4" TYPE K COPPER DRINKING WATER SERVICE PER WATER COMPANY'S SPECIFICATIONS AND REQUIREMENTS. SITE CONTRACTOR TO COORDINATE WITH BUILDING, PLUMBING AND FIRE PROTECTION CONTRACTOR.

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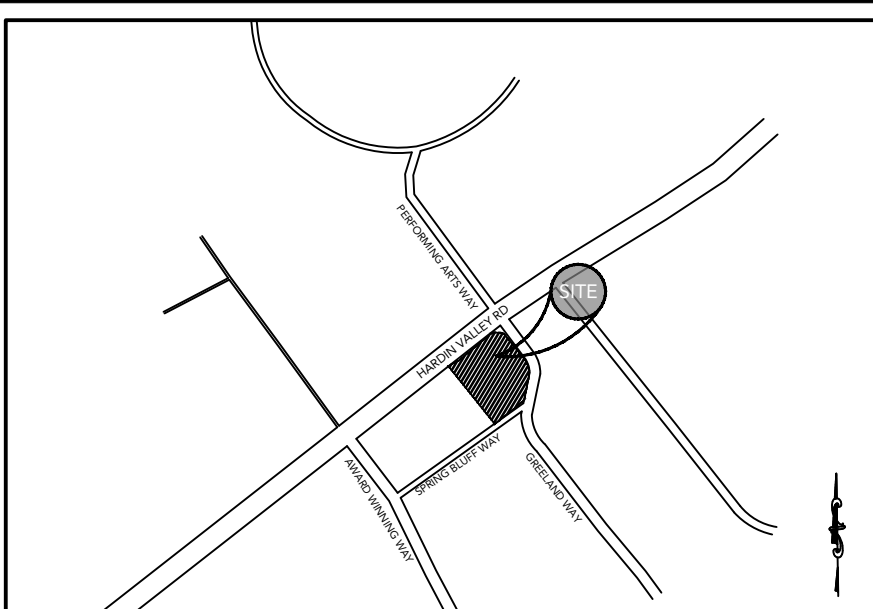
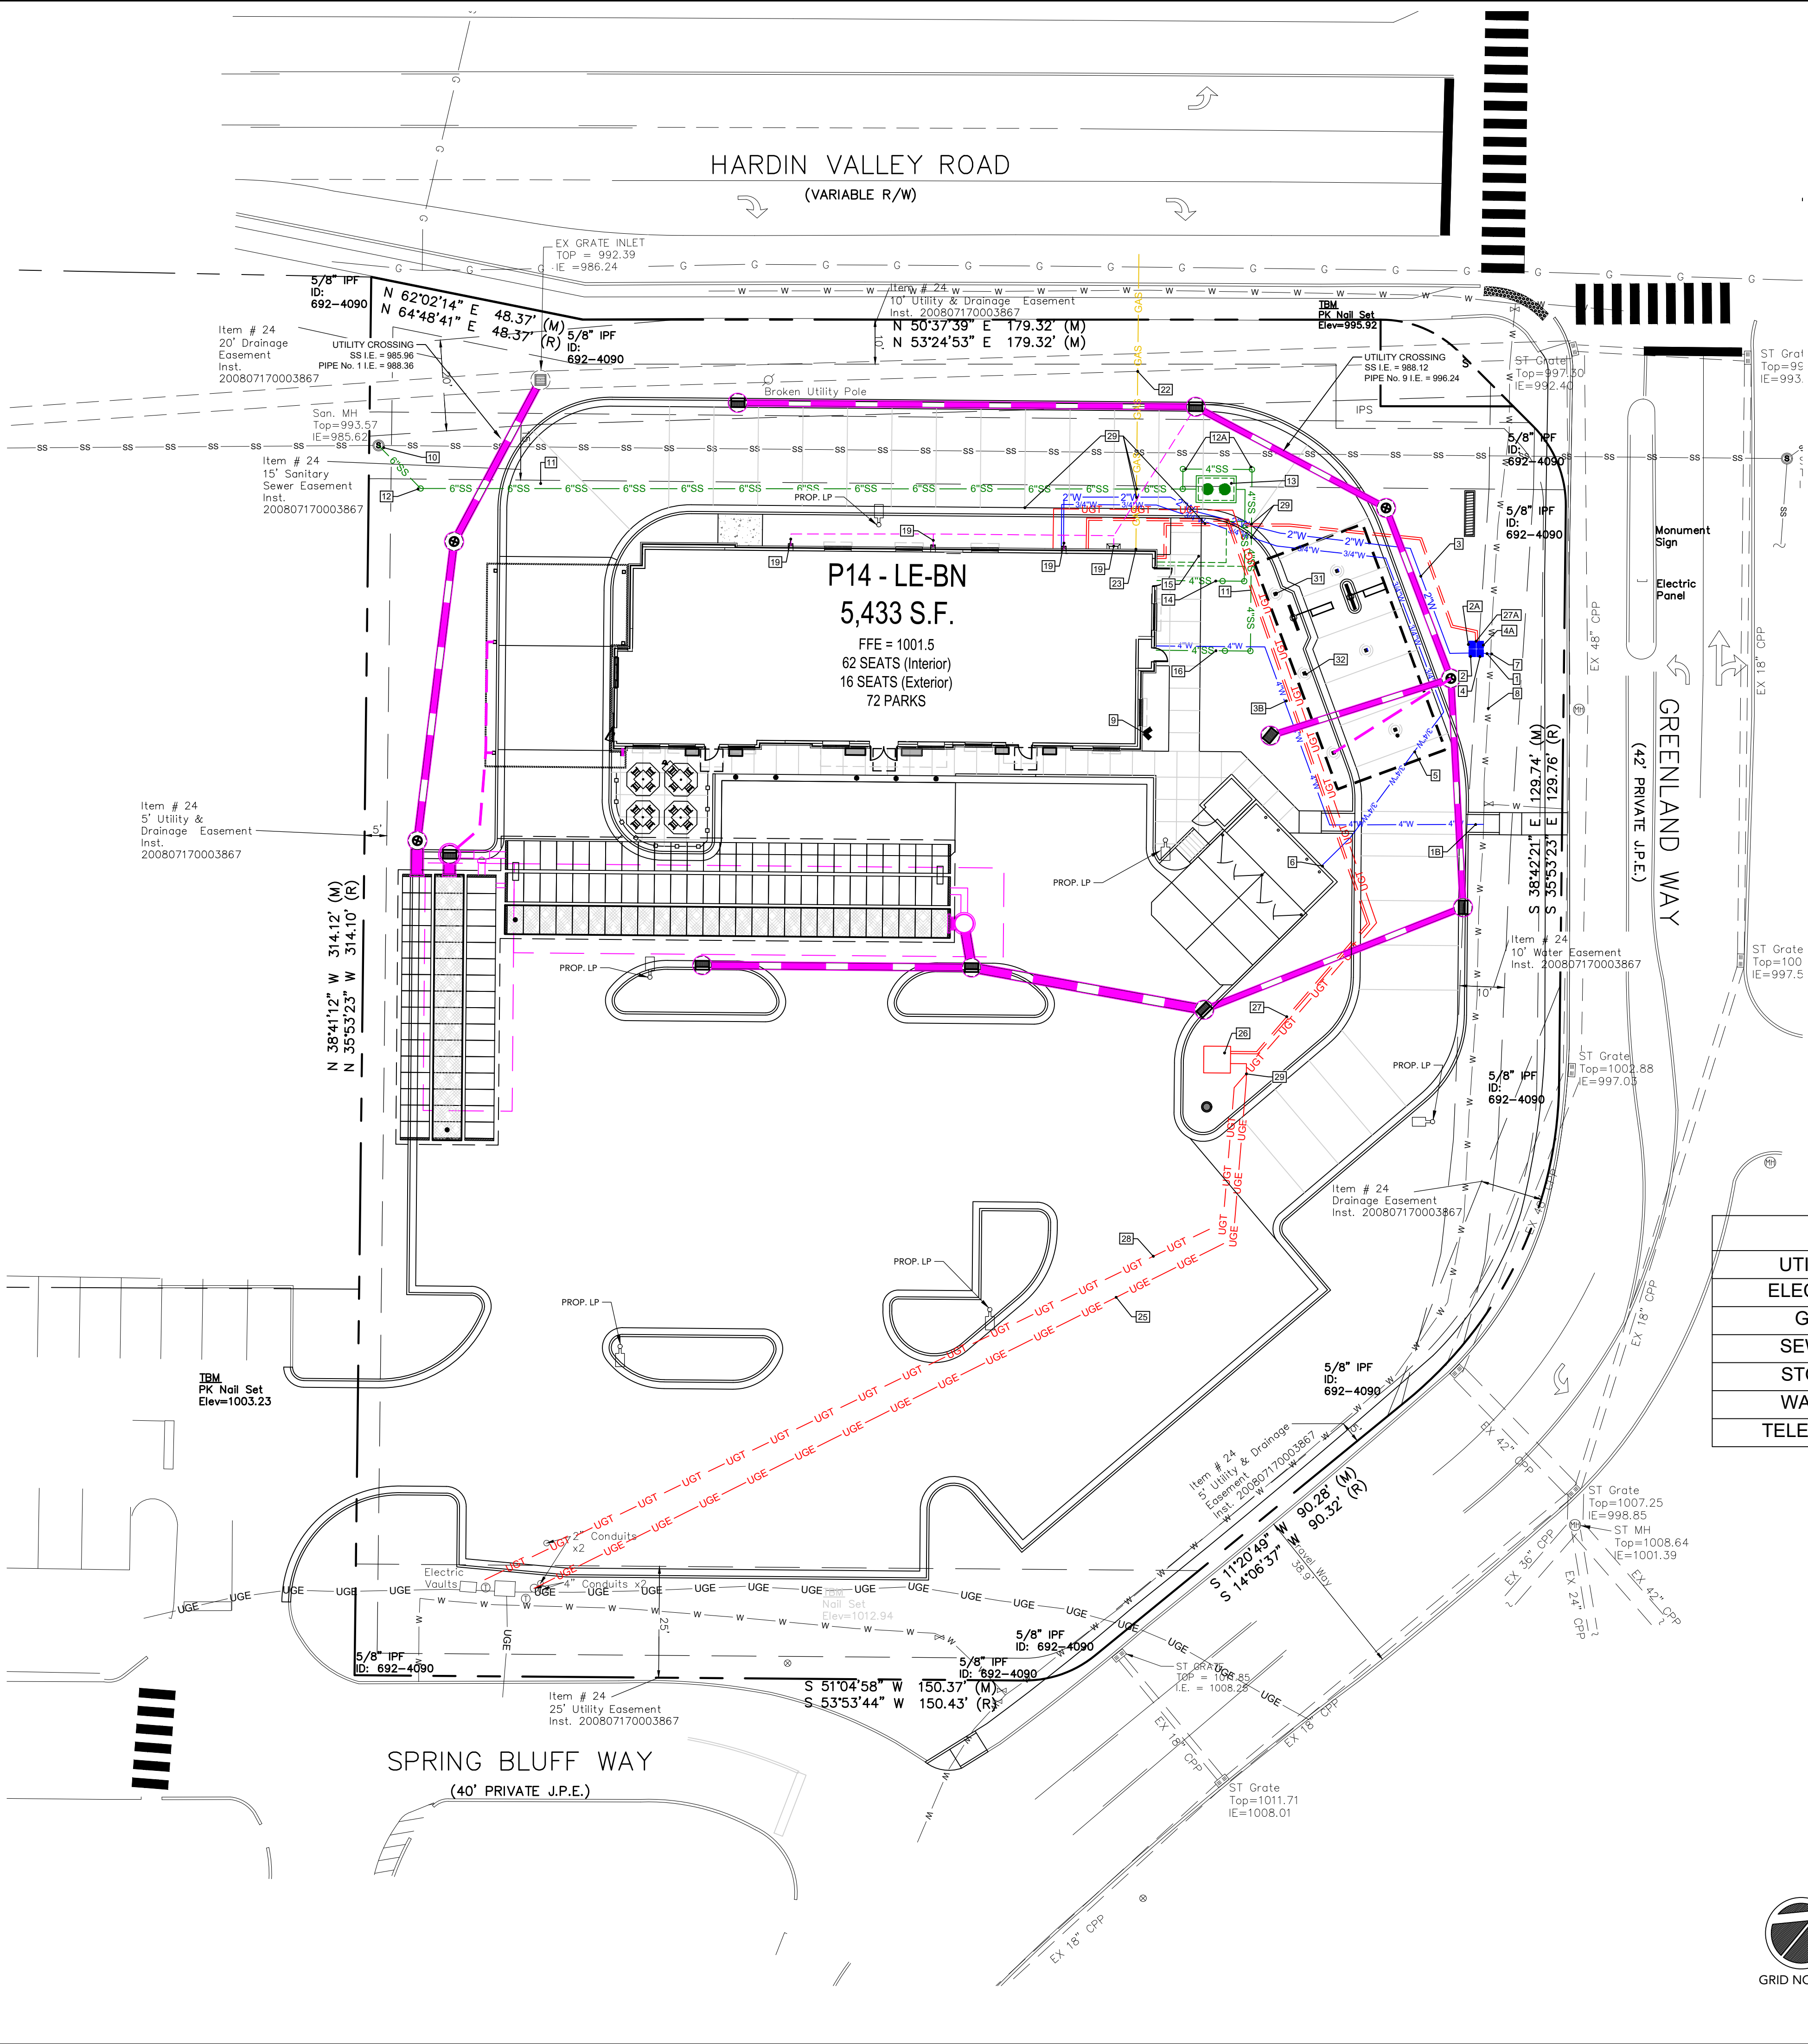
- 4AP. UTILITY CROSSING: 4" TYPE K COPPER DRINKING WATER SERVICE PER WATER COMPANY'S SPECIFICATIONS AND REQUIREMENTS. SITE CONTRACTOR TO COORDINATE WITH BUILDING, PLUMBING AND FIRE PROTECTION CONTRACTOR.

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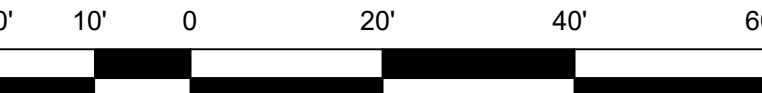
- 4AS. UTILITY CROSSING: 4" TYPE K COPPER DRINKING WATER SERVICE PER WATER COMPANY'S SPECIFICATIONS AND REQUIREMENTS. SITE CONTRACTOR TO COORDINATE WITH BUILDING, PLUMBING AND FIRE PROTECTION CONTRACTOR.

- 4AT. UTILITY CROSSING: 4" TYPE K COPPER DRINKING WATER SERVICE PER WATER COMPANY'S SPECIFICATIONS AND REQUIREMENTS. SITE CONTRACTOR TO COORDINATE WITH BUILDING, PLUMBING AND FIRE PROTECTION CONTRACTOR.



LOCATION MAP  
SCALE: N.T.S.

UTILITY LEGEND	
UTILITY	KEY
ELECTRIC	—ELEC—ELEC—ELEC—
GAS	—GAS—GAS—GAS—
SEWER	—SS—SS—SS—
STORM	—W—W—W—
WATER	—W—W—W—
TELECOMM	—UGT—UGT—UGT—



GRAPHIC SCALE  
SCALE 1" = 20'



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STORE # 05442  
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KNOXVILLE, TN 37932

SHEET TITLE

UTILITY PLAN

REVISION 4-2023

Job No. : 23043CFA

Store : 05442



Date : 08/28/23

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C-3.0

ISSUE FOR PERMIT



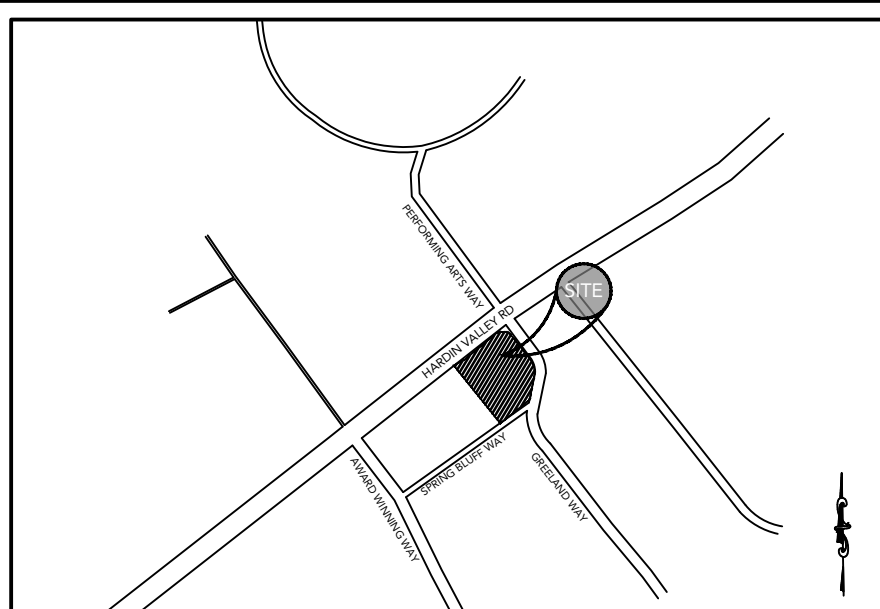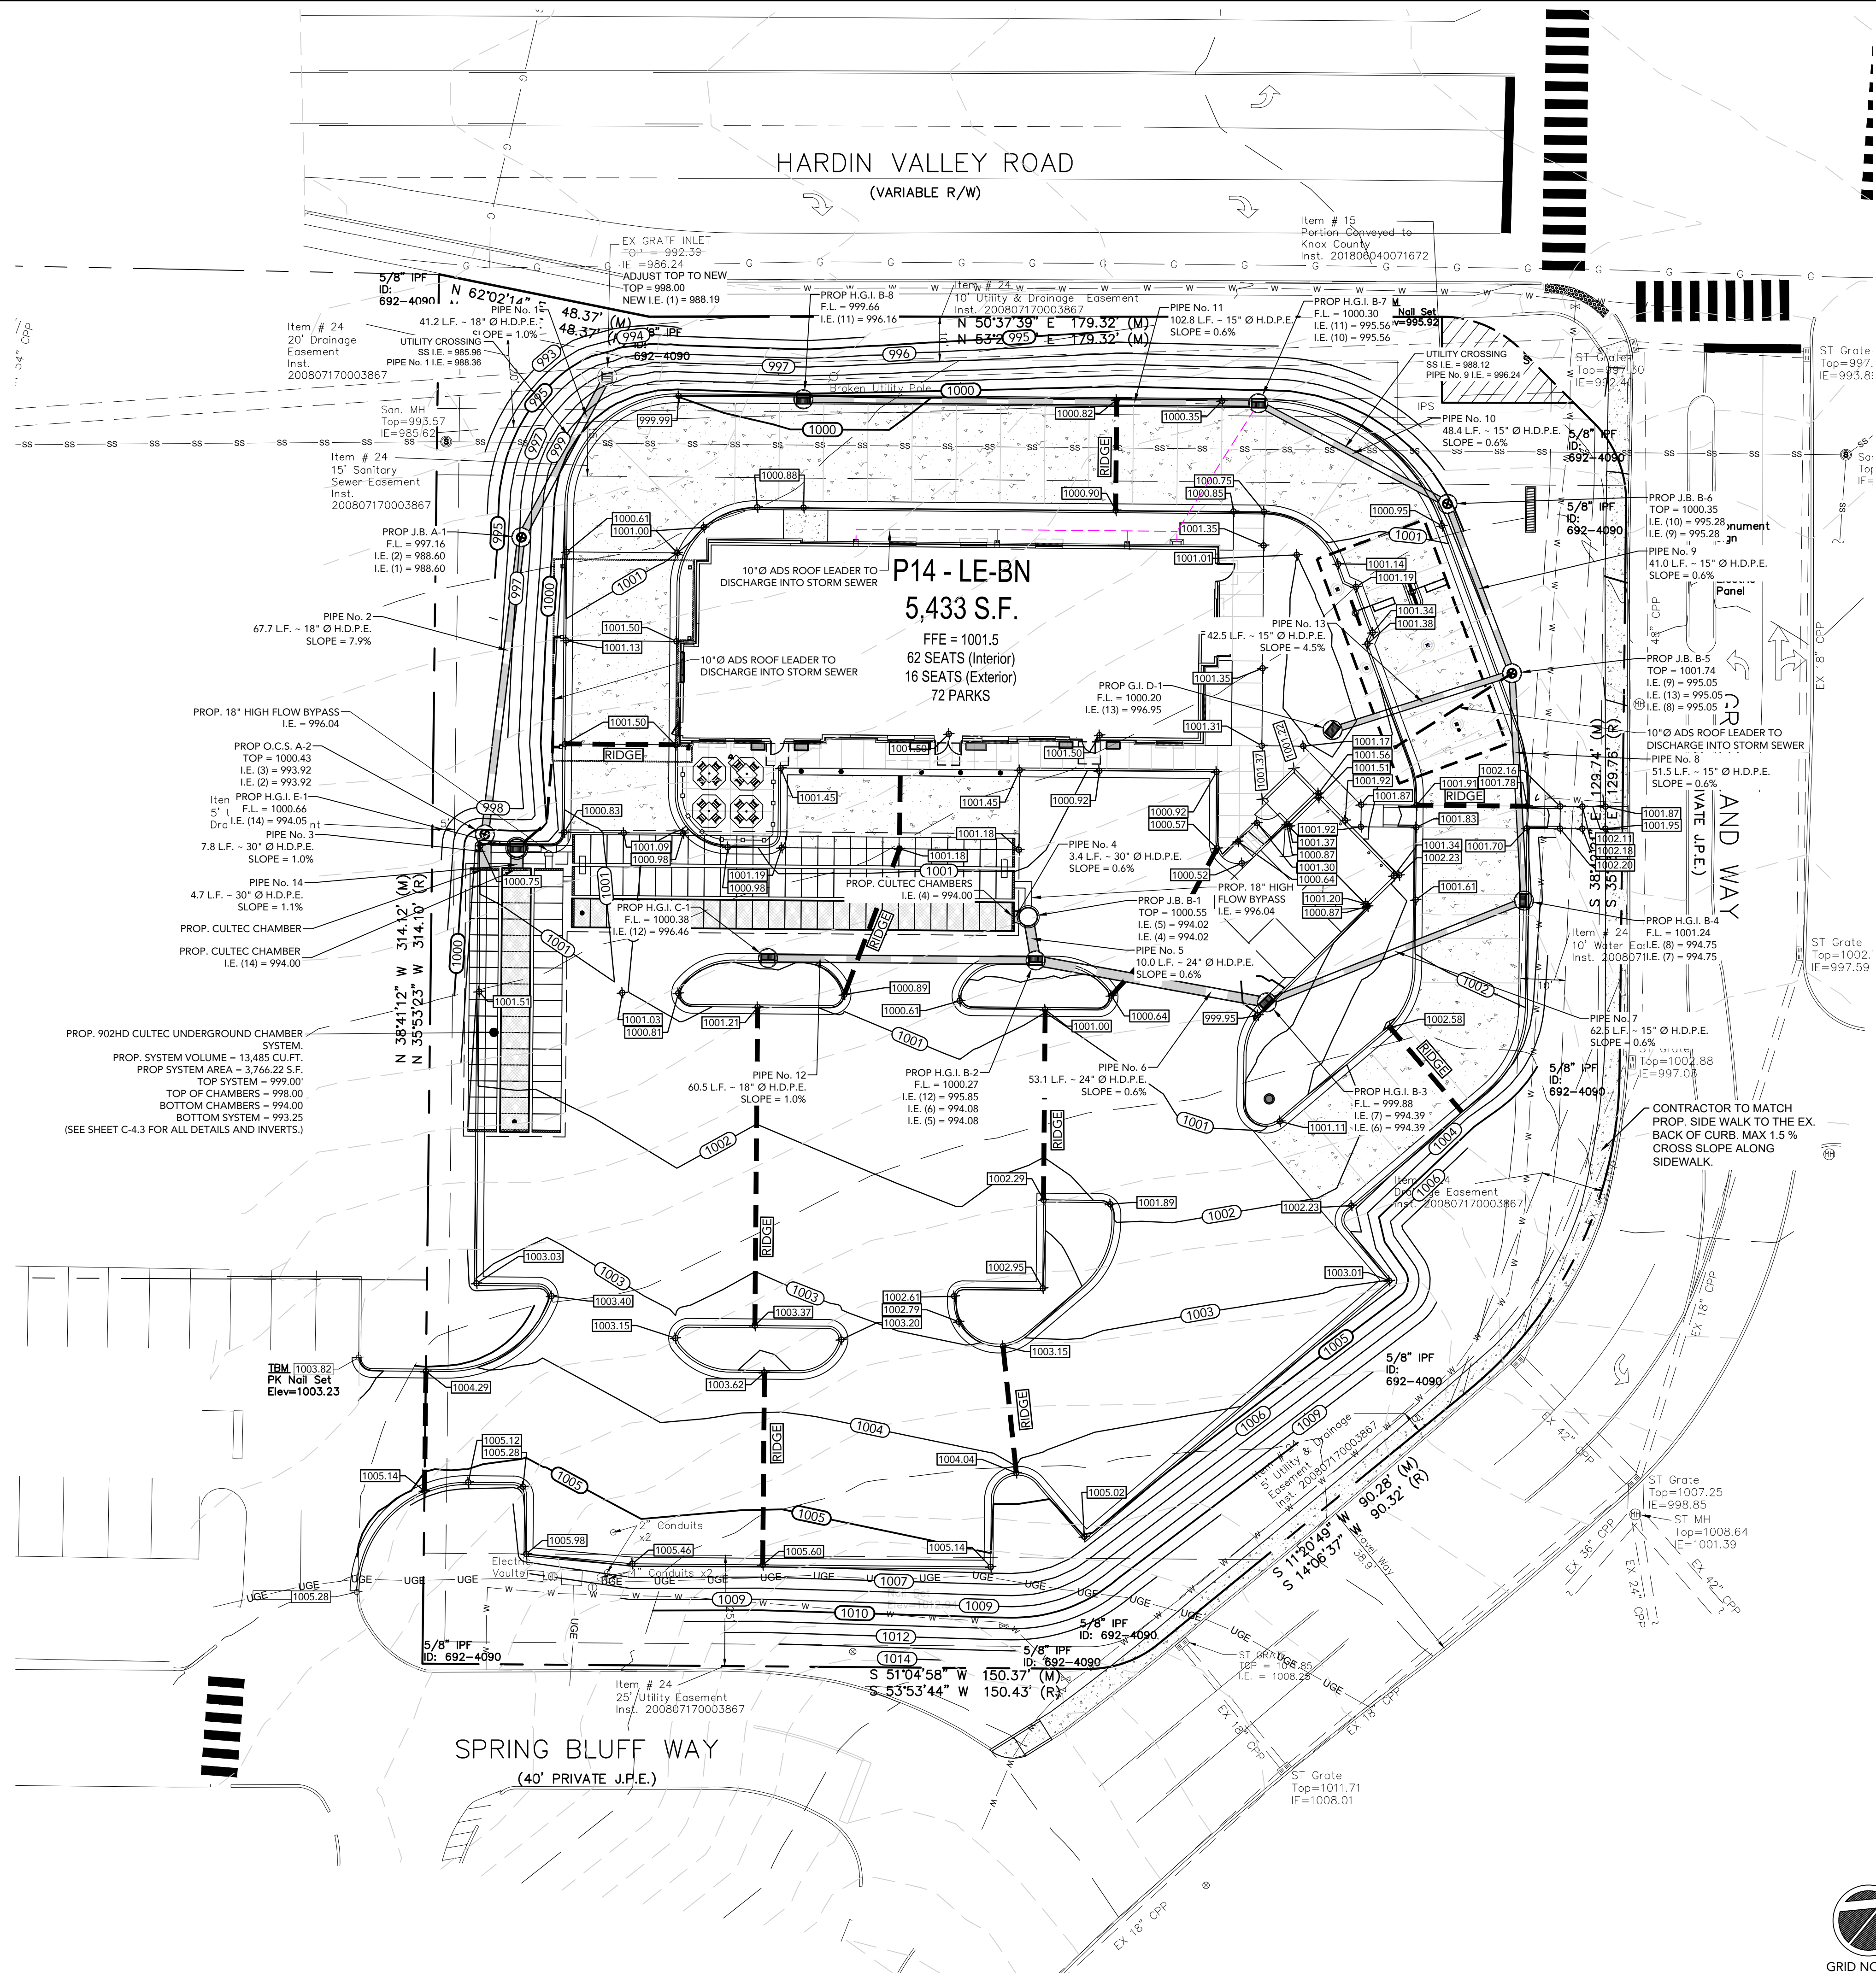

LOCATION MAP  
SCALE: N.T.S.

- GRADING NOTE:**
- ALL SPOTS SHOWN ON THIS PLAN ARE FLOW LINE ELEVATIONS UNLESS OTHERWISE STATED.
  - CONTRACTOR SHALL MATCH EXISTING PAVEMENT AT PROPOSED DRIVEWAY LOCATIONS.
  - DUMPSTER ENCLOSURES SHALL HAVE A 4 TO 6 INCH KEY ALONG THE FACE OF THE DUMPSTER. (SEE PLAN FOR ELEVATIONS.)

**STORMWATER NOTE:**

THE PROPOSED SITE WILL DRAIN TO THE PROPOSED STORMWATER NETWORK. THE NETWORK WILL DISCHARGE TO AN UNDERGROUND STORMWATER MANAGEMENT FACILITY. THE FACILITY WILL PROVIDE TREATMENT OF THE FIRST 1.1" RAINFALL BY INFILTRATING THE VOLUME THROUGH THE BOTTOM OF THE SYSTEM. THE FACILITY WILL ALSO PROVIDE DETENTION OF POST DEVELOPED STORM EVENTS BELOW EXISTING STORM EVENTS PER THE HYDROLOGY REPORT DATED JULY 27, 2023.

  
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SHEET TITLE

**GRADING &  
DRAINAGE PLAN**



REVISION 4-2023

Job No. : 23043CFA  
Store : 05442  
Date : 08/28/23

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ISSUE FOR PERMIT



GRAPHIC SCALE  
SCALE 1" = 20'

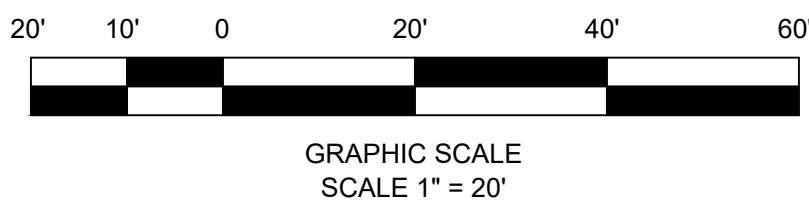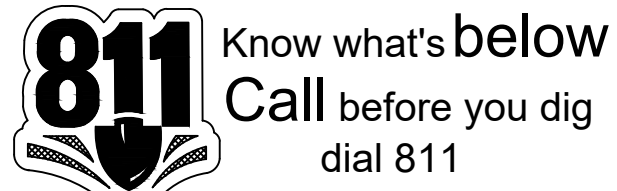

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SHEET TITLE

PIPE PROFILES

REVISION 4-2023

Job No. : 23043CFA

Store : 05442






Date : 08/28/23

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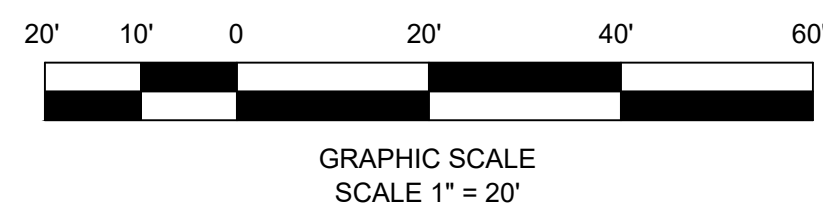
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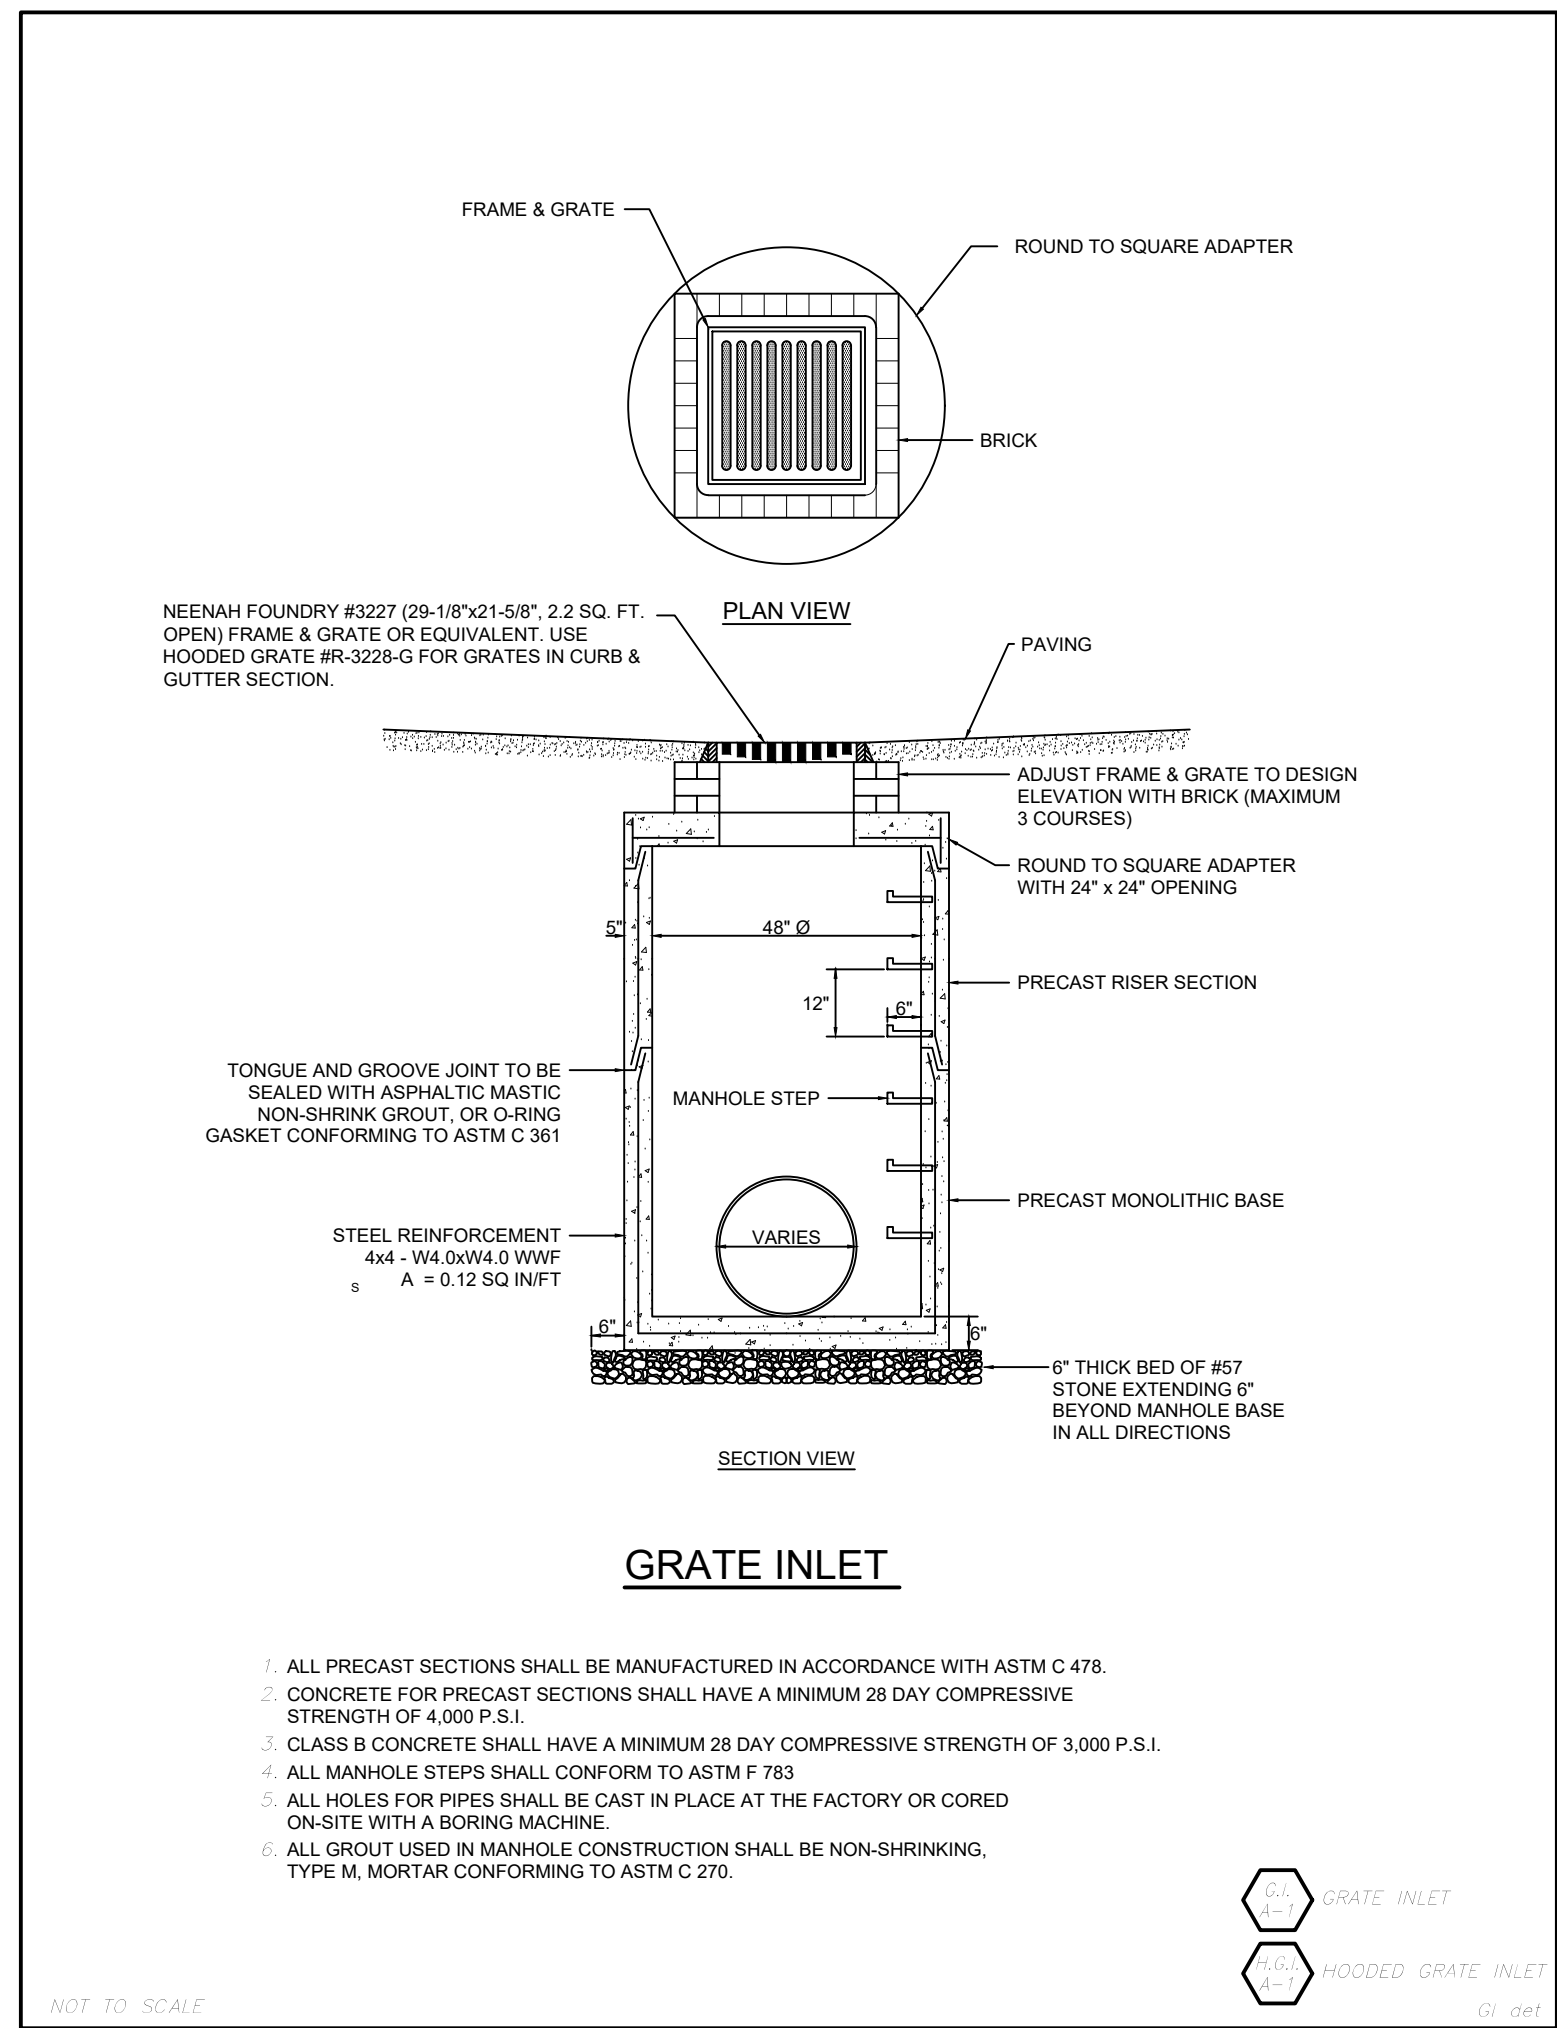
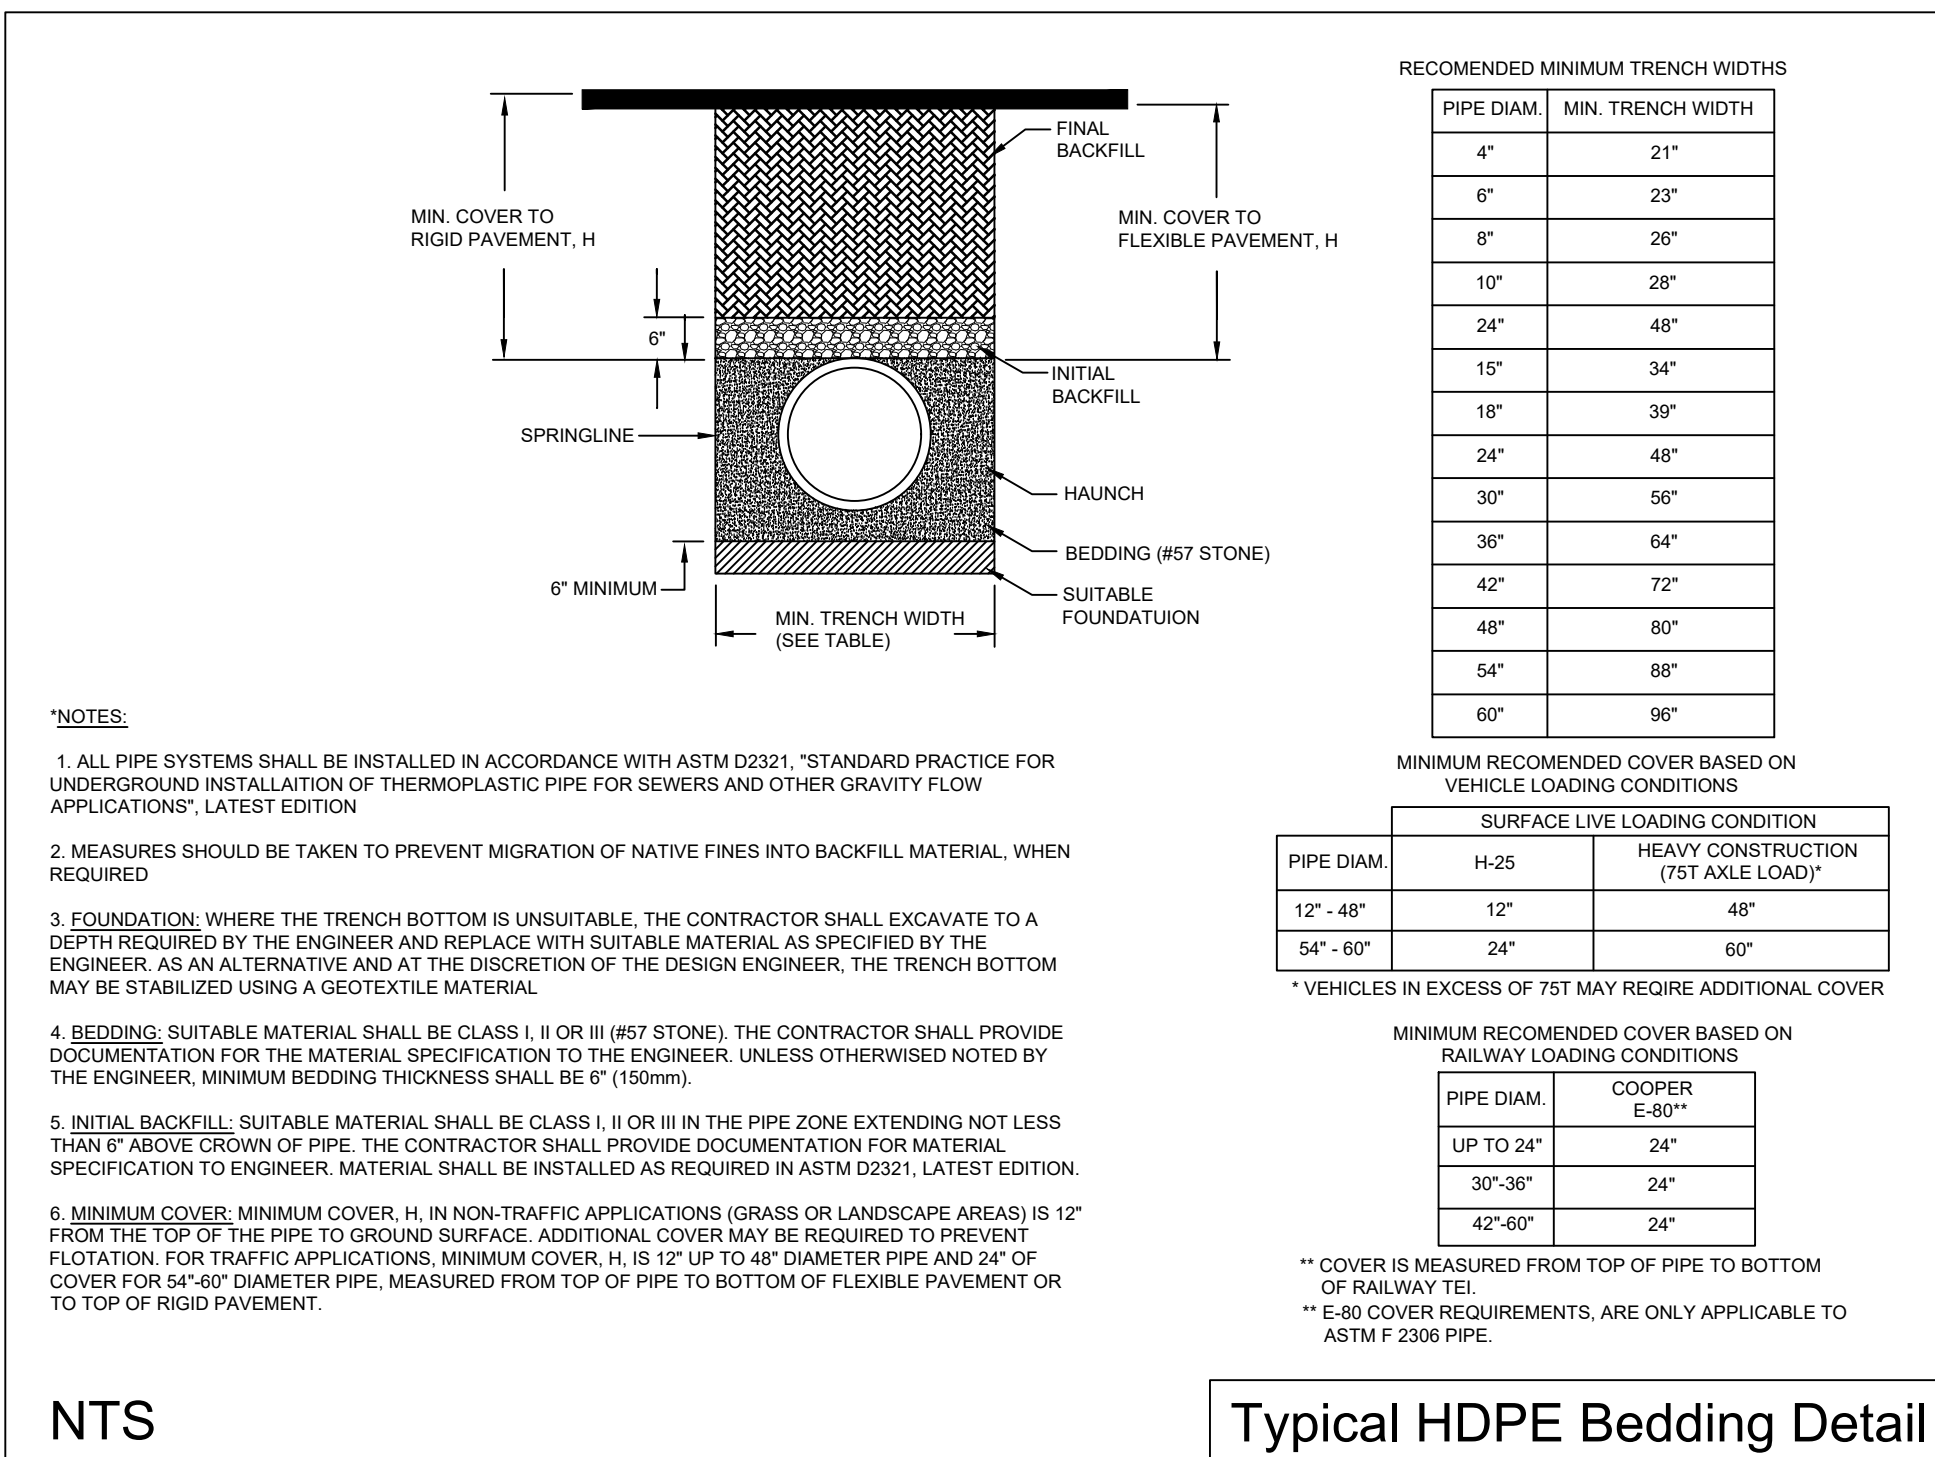
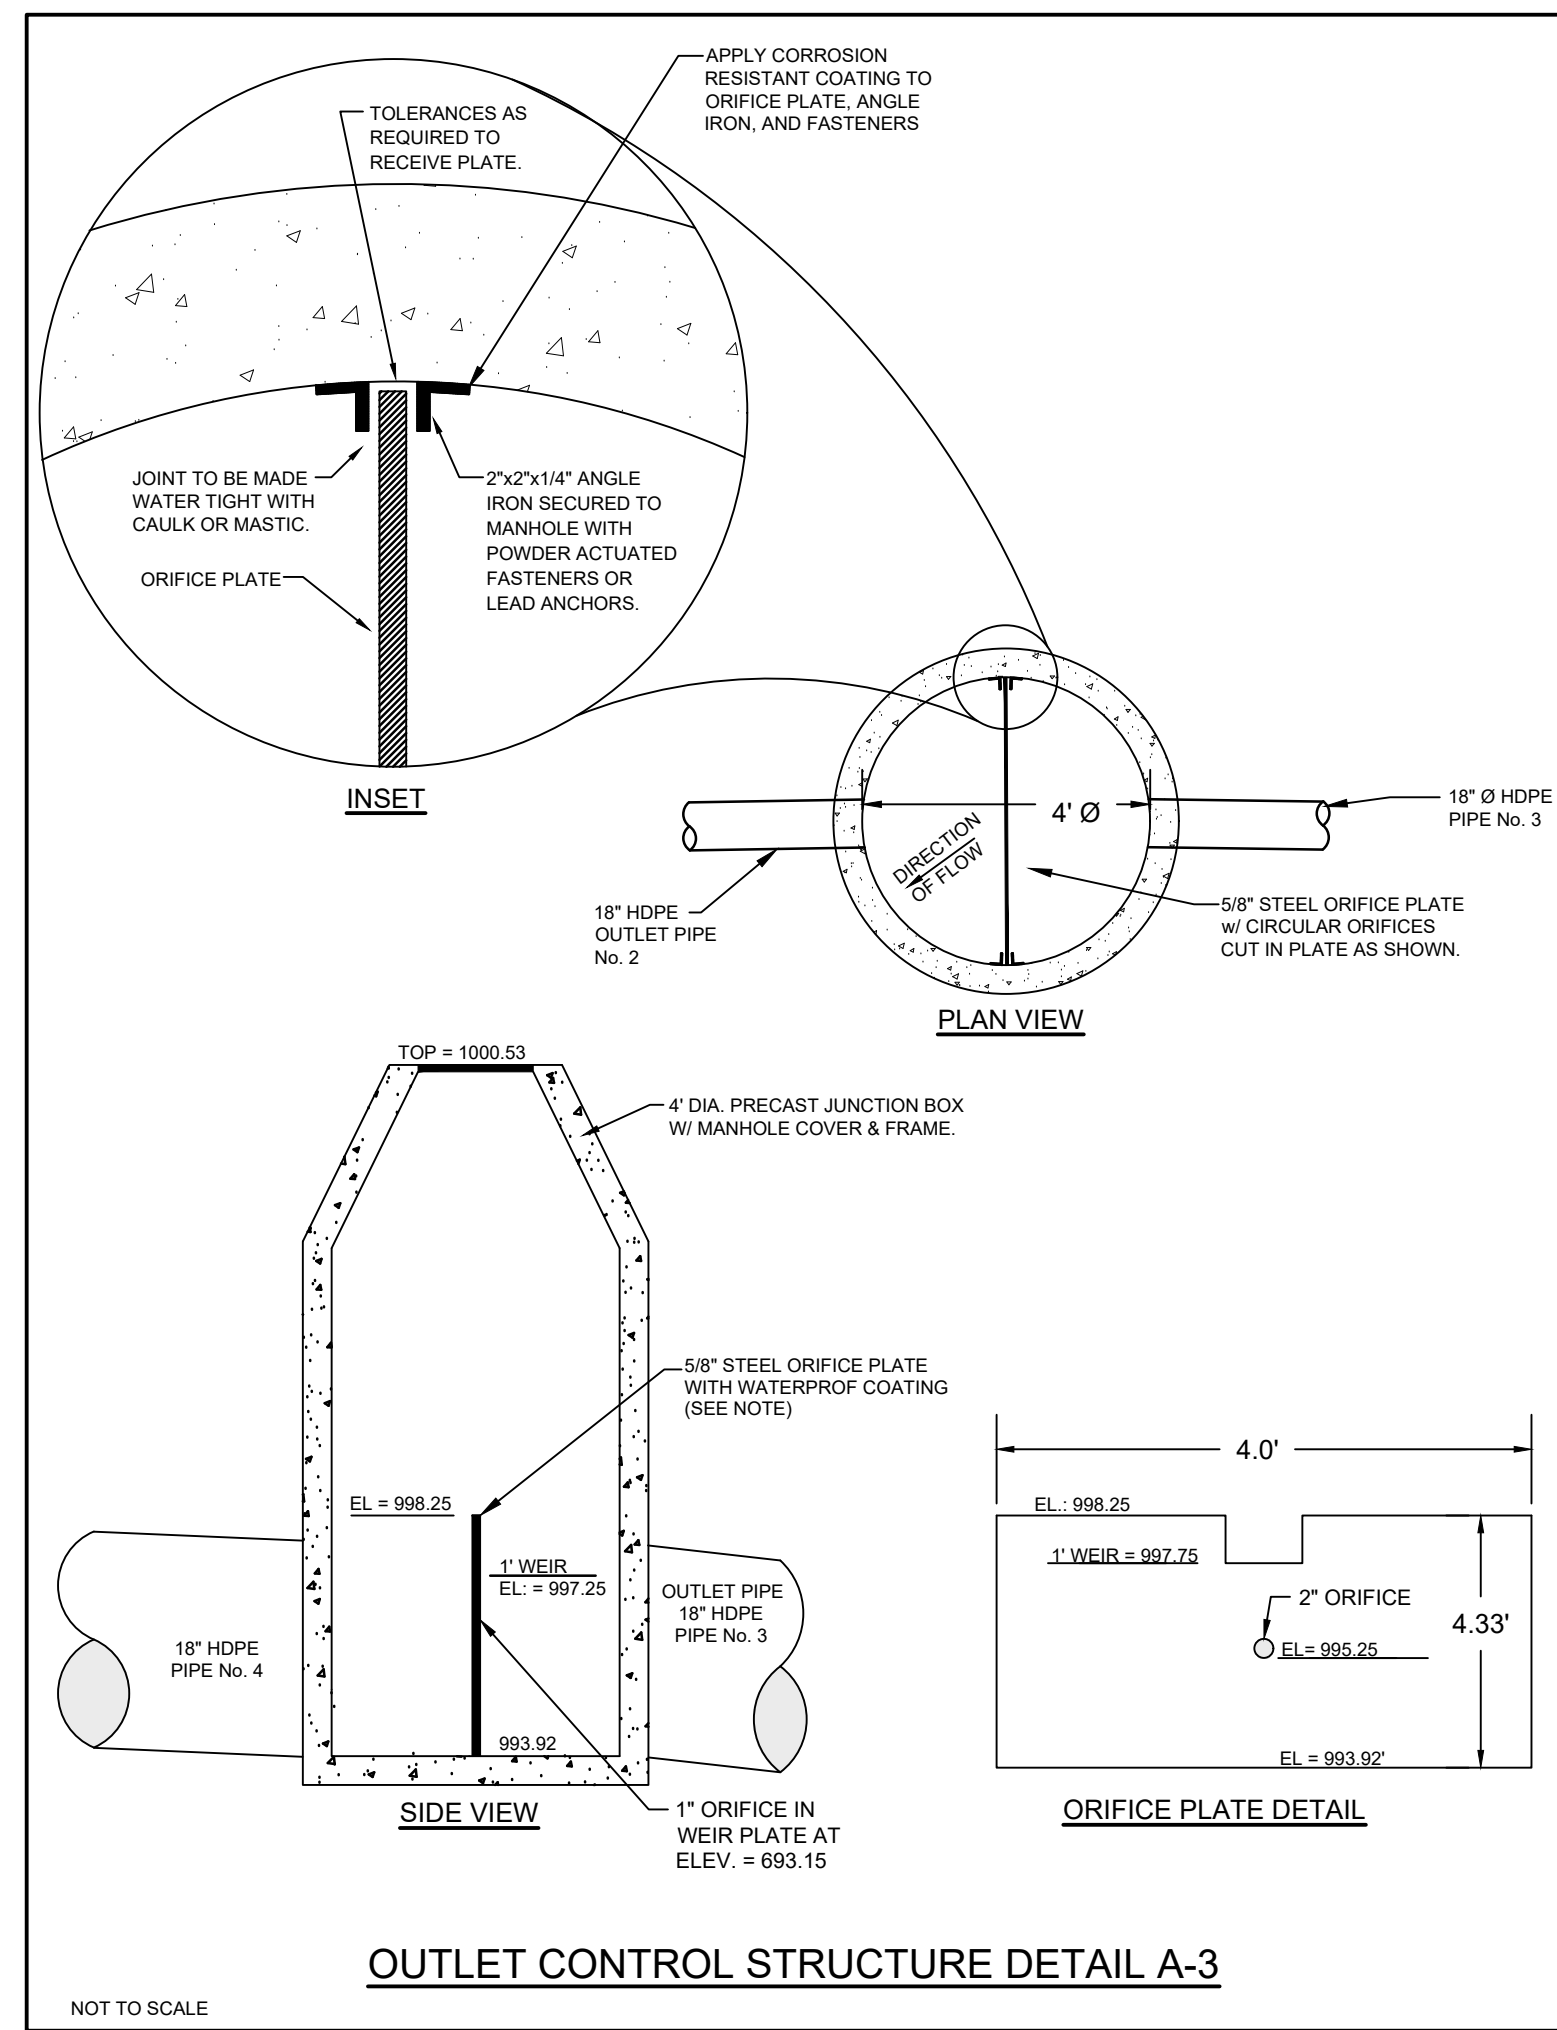
ENGINEER/DISIGNER NOT RESPONSIBLE FOR COST CHANGES DURING PRELIMINARY PHASE. BIDS & QUOTES SHALL BE BASED ON PLANS SETS LABELED "ISSUE FOR CONSTRUCTION".



25- YR STORM SEWER PROFILES										
SCALE: 1(in) = 20 (ft) H, 1(in) = 10(ft) V										
Pipe No.	Flow (cfs)	Size (in)	Mat'l	Length (ft)	I.E. Down (ft)	I.E. Up (ft)	Slope (%)	HGL Down (ft)	HGL Up (ft)	Velocity (ft/s)
1	1.06	18	HDPE	41.2	988.19	988.60	1.0	988.57	988.98	2.97
2	1.06	18	HDPE	67.7	988.60	993.92	7.9	988.98	994.30	2.97
3	1.06	30	HDPE	7.8	993.92	994.00	1.0	994.30	994.33	2.47
4	5.18	30	HDPE	3.4	994.00	994.02	0.6	994.75	994.77	4.18
5	5.19	24	HDPE	10.0	994.02	994.08	0.6	994.77	994.88	4.61
6	2.37	24	HDPE	53.1	994.08	994.39	0.6	994.88	994.92	2.76
7	1.64	15	HDPE	62.5	994.39	994.75	0.6	994.92	995.26	3.39
8	1.21	15	HDPE	51.5	994.75	995.05	0.6	995.26	995.48	2.90
9	1.62	15	HDPE	41.0	995.05	995.28	0.6	995.53	995.78	3.63
10	1.65	15	HDPE	48.2	995.28	995.56	0.6	995.78	996.07	3.54
11	0.96	15	HDPE	102.8	995.56	996.16	0.6	996.07	996.54	2.52
12	2.12	18	HDPE	60.5	995.85	996.46	1.0	996.29	997.01	4.28
13	0.07	15	HDPE	42.5	995.05	996.95	4.5	995.48	997.05	0.82
14	0.21	30	HDPE	4.8	994.00	994.05	1.1	994.15	994.20	1.78



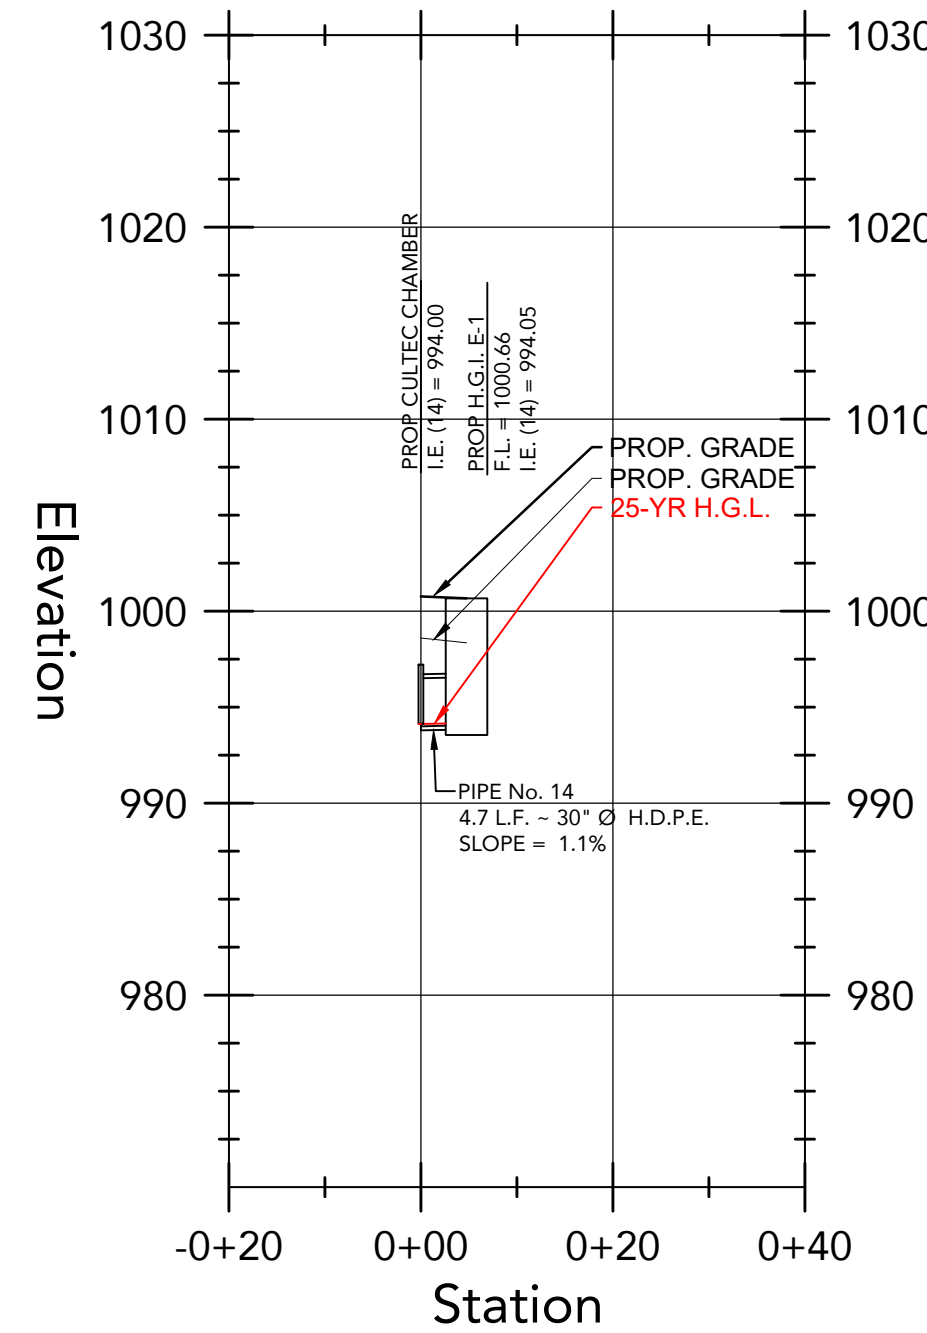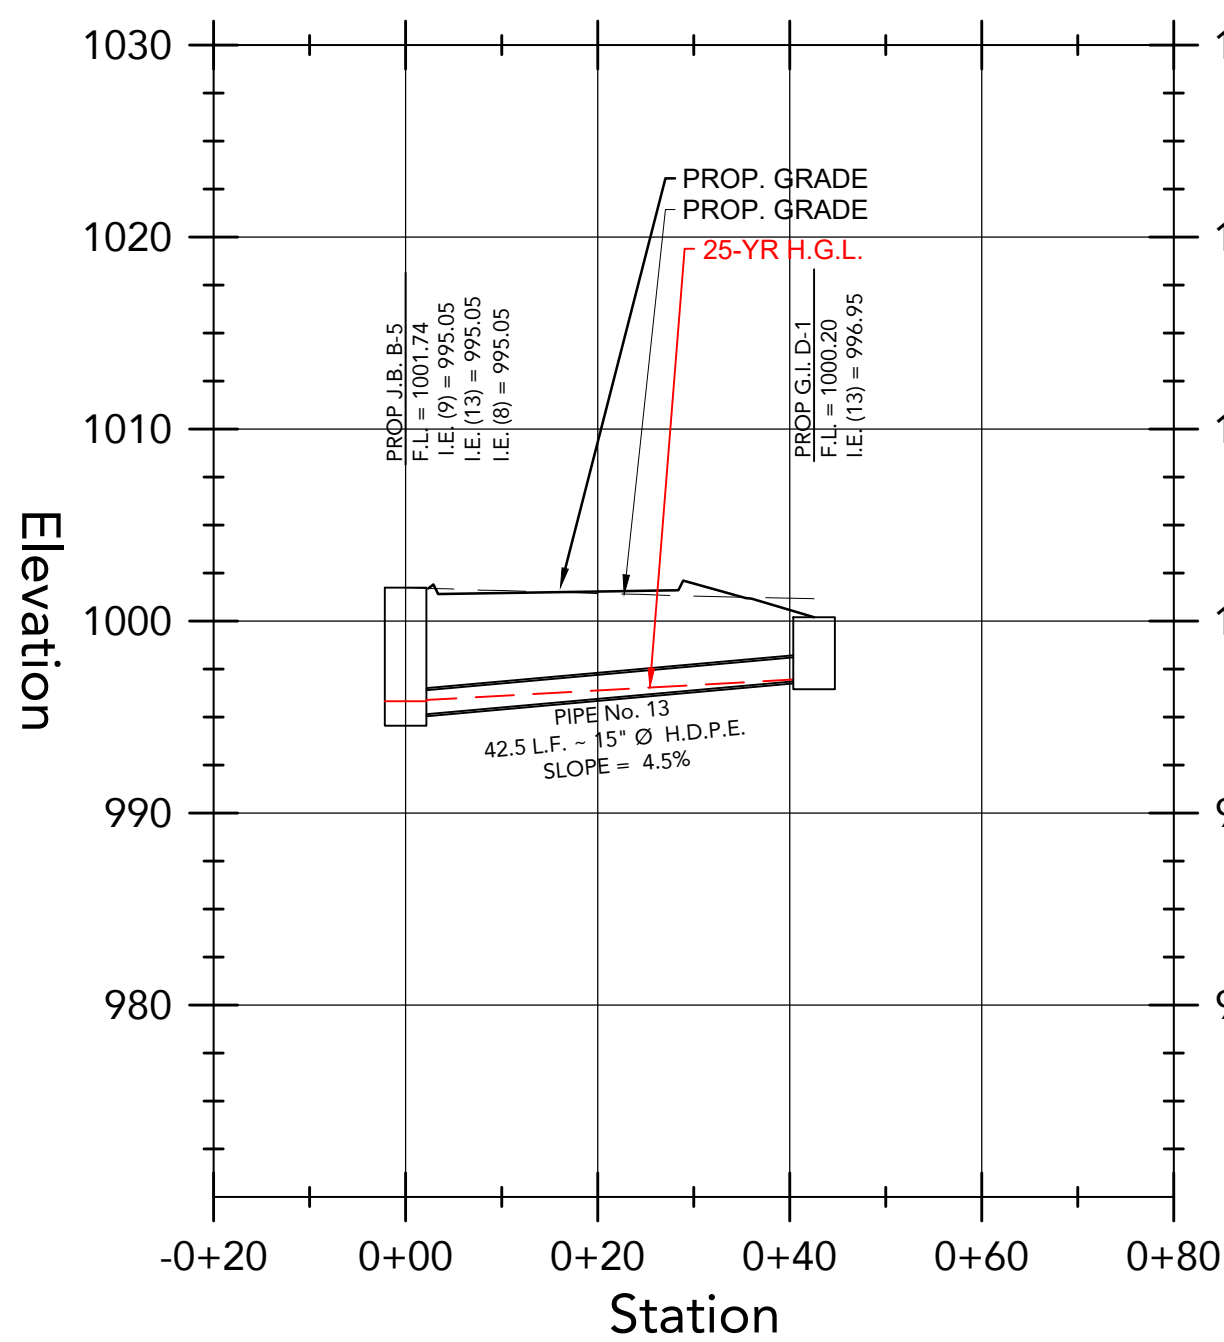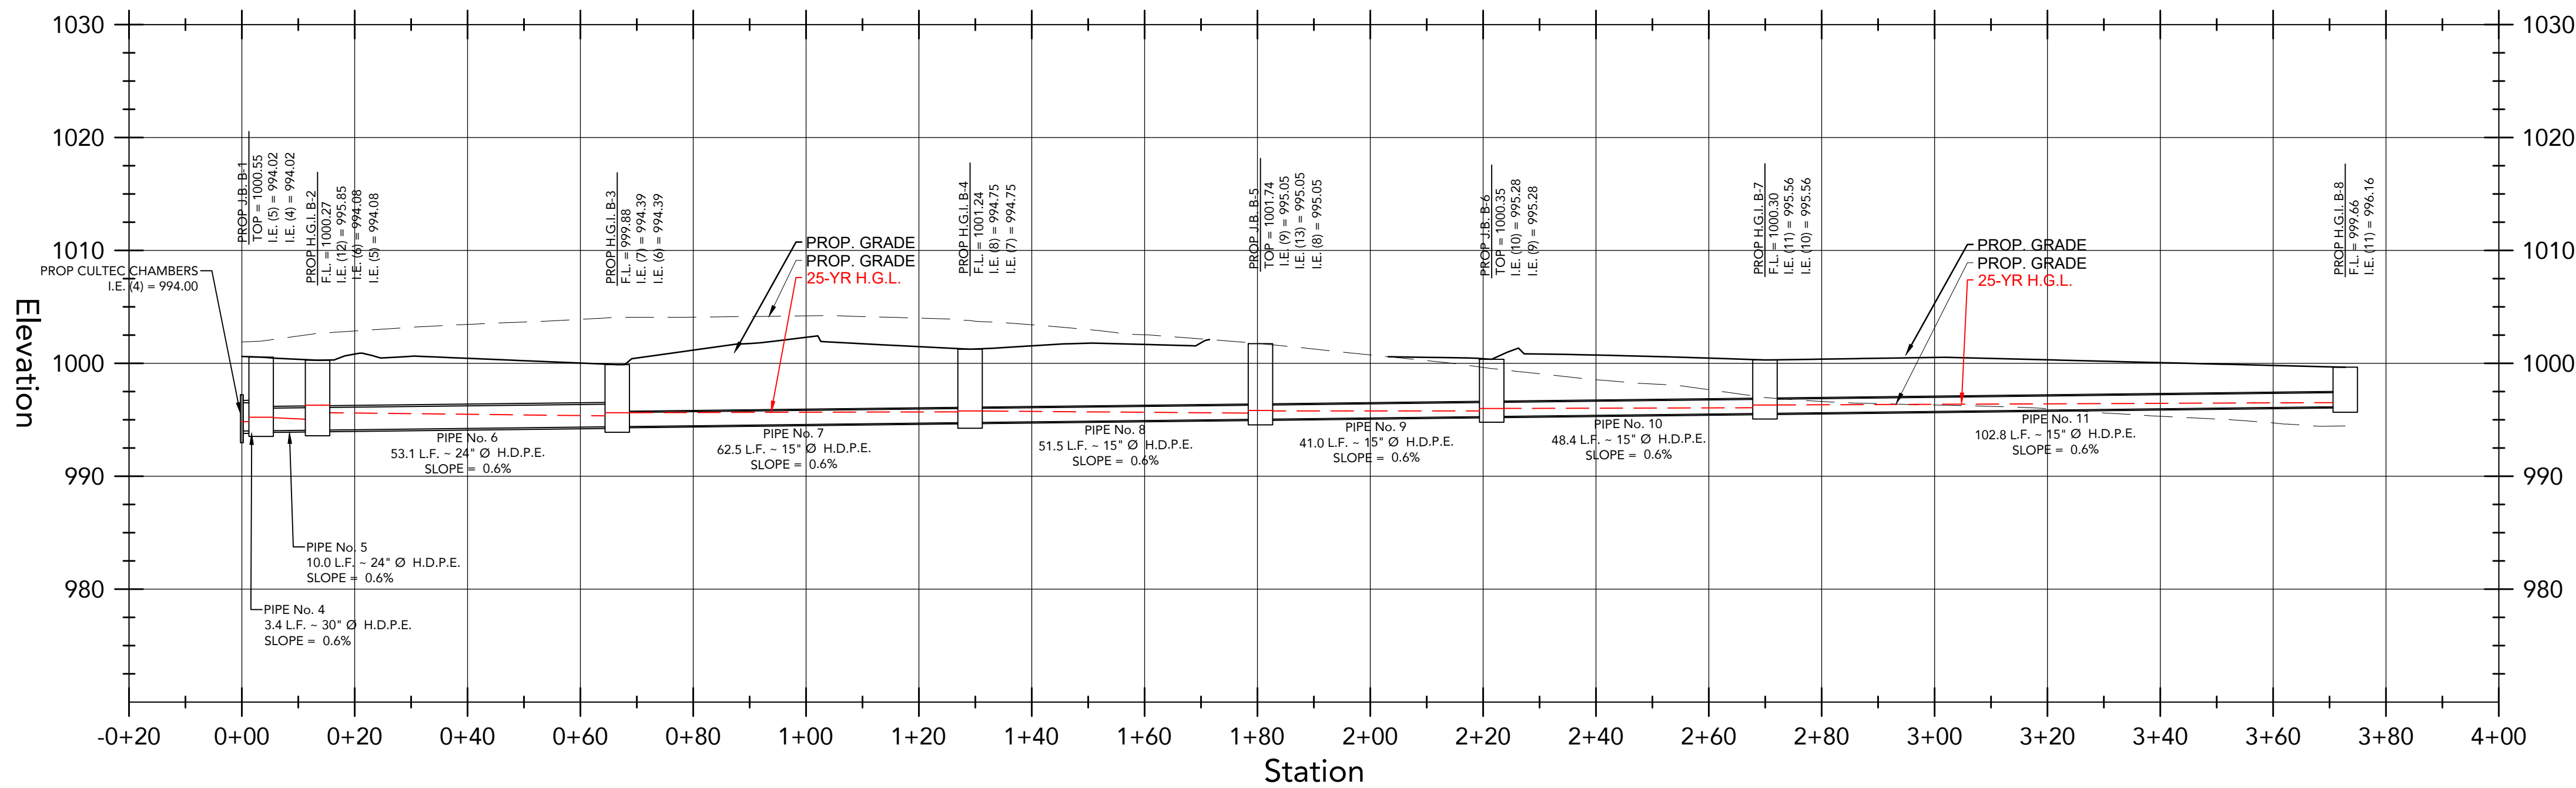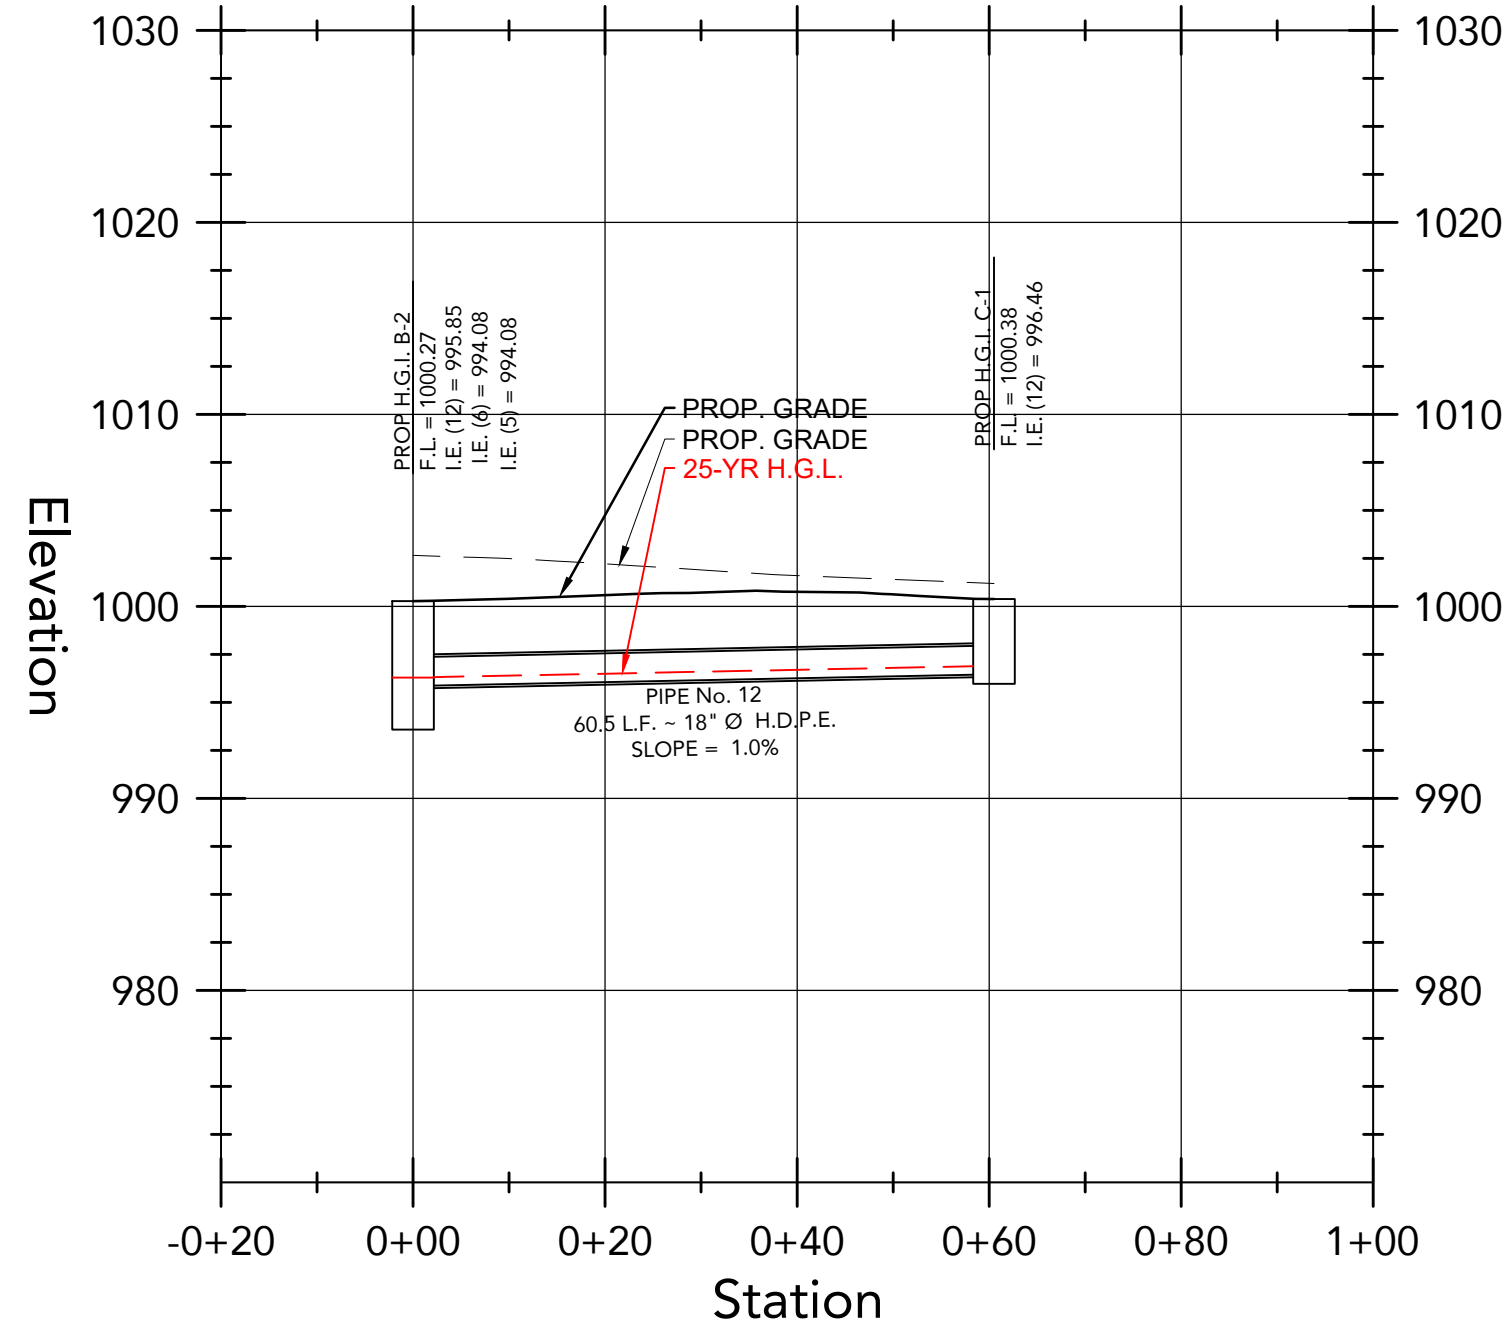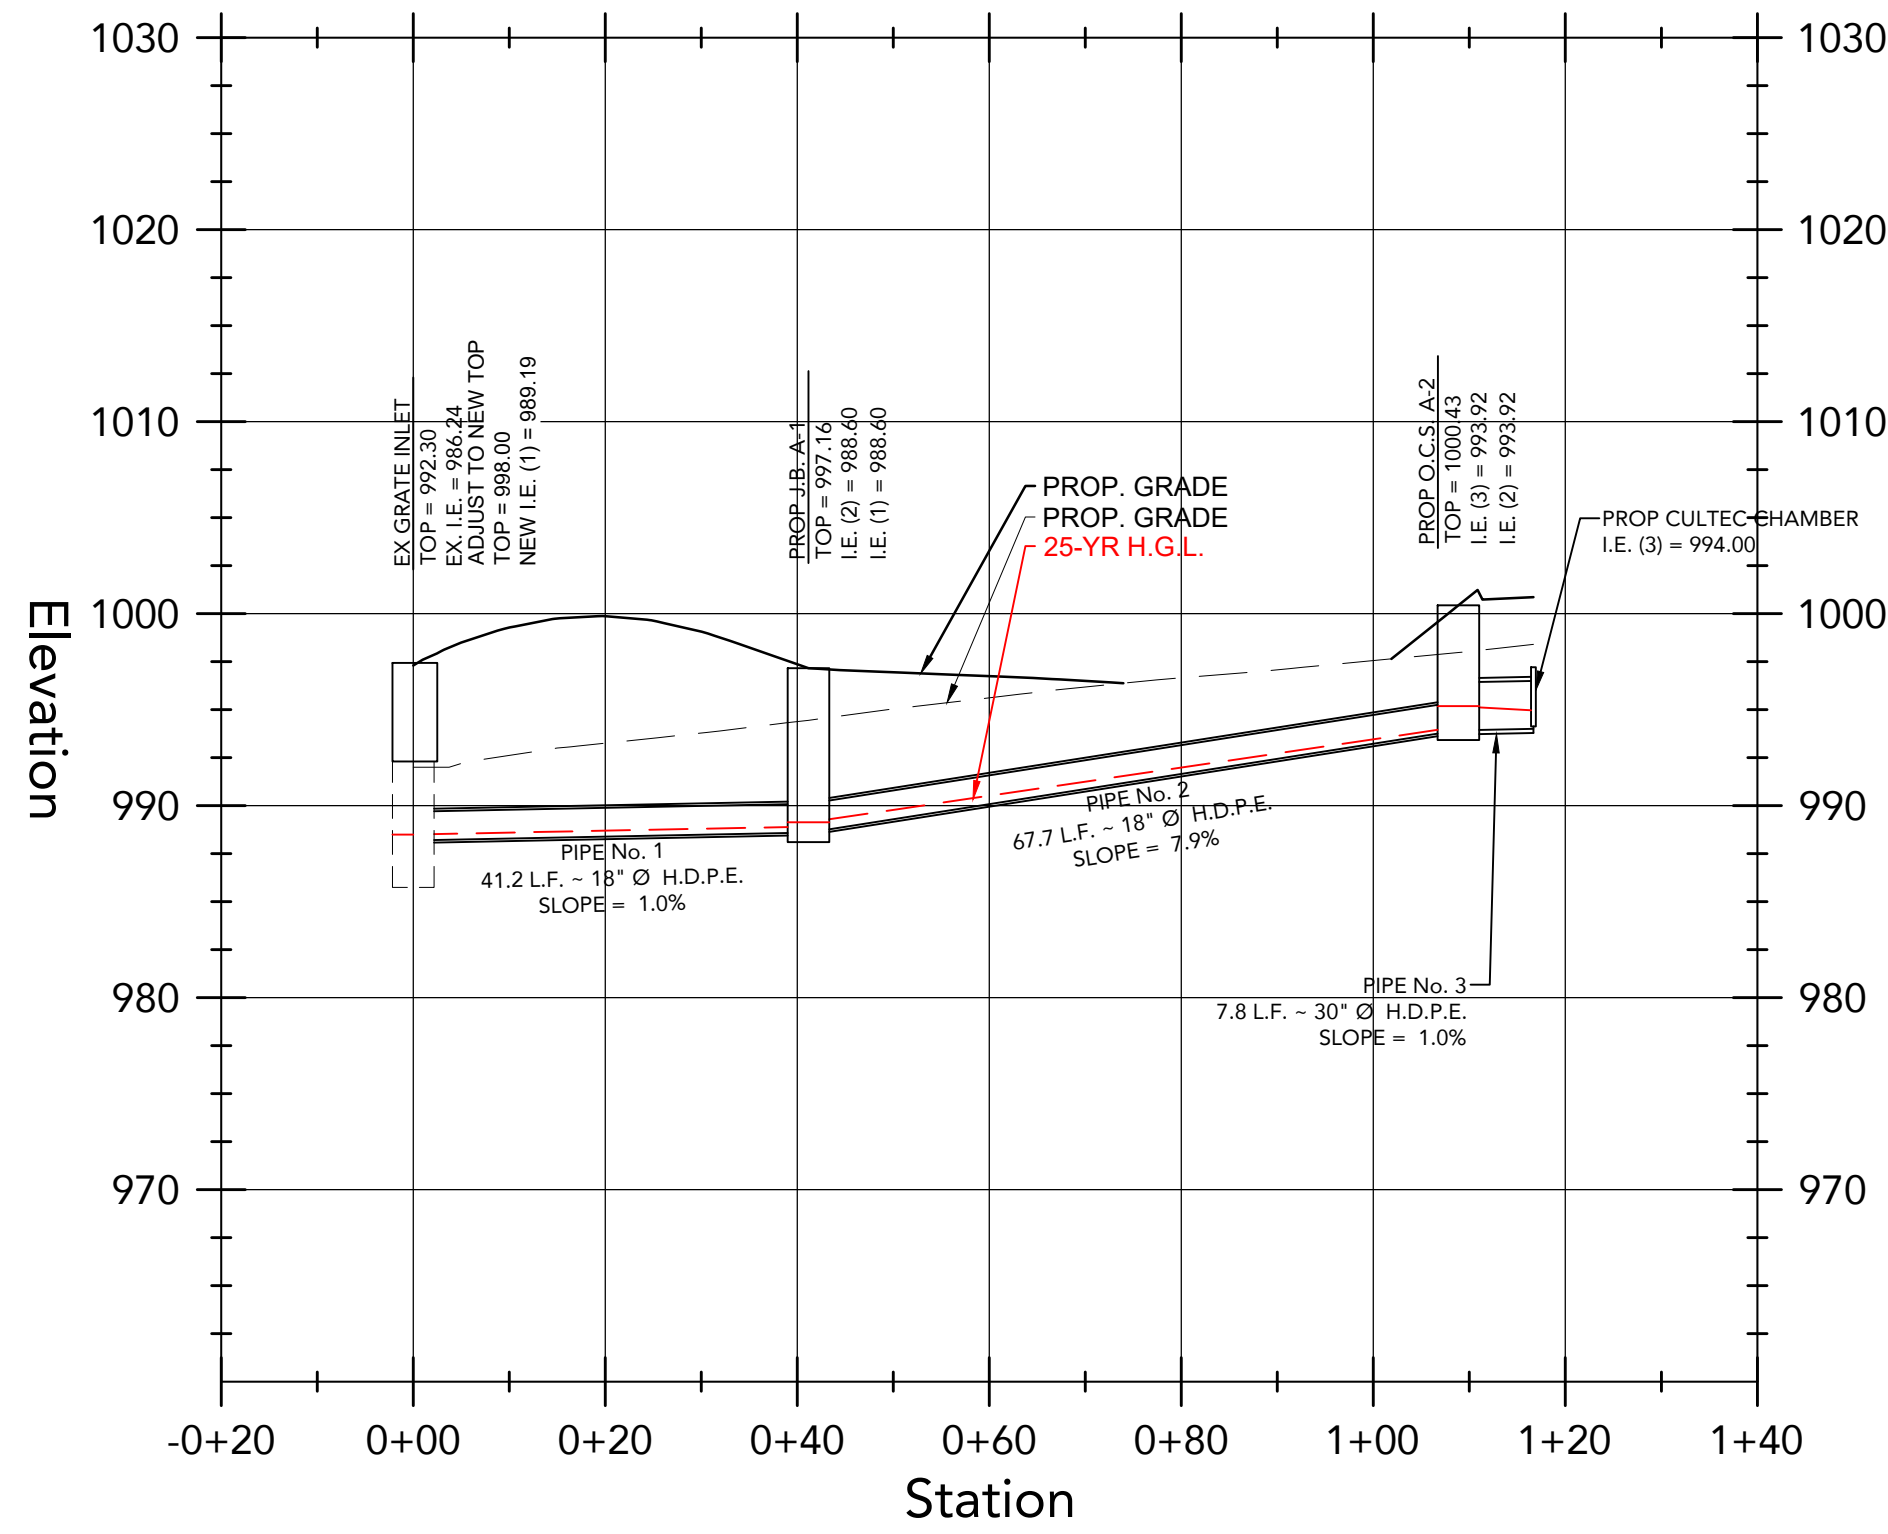











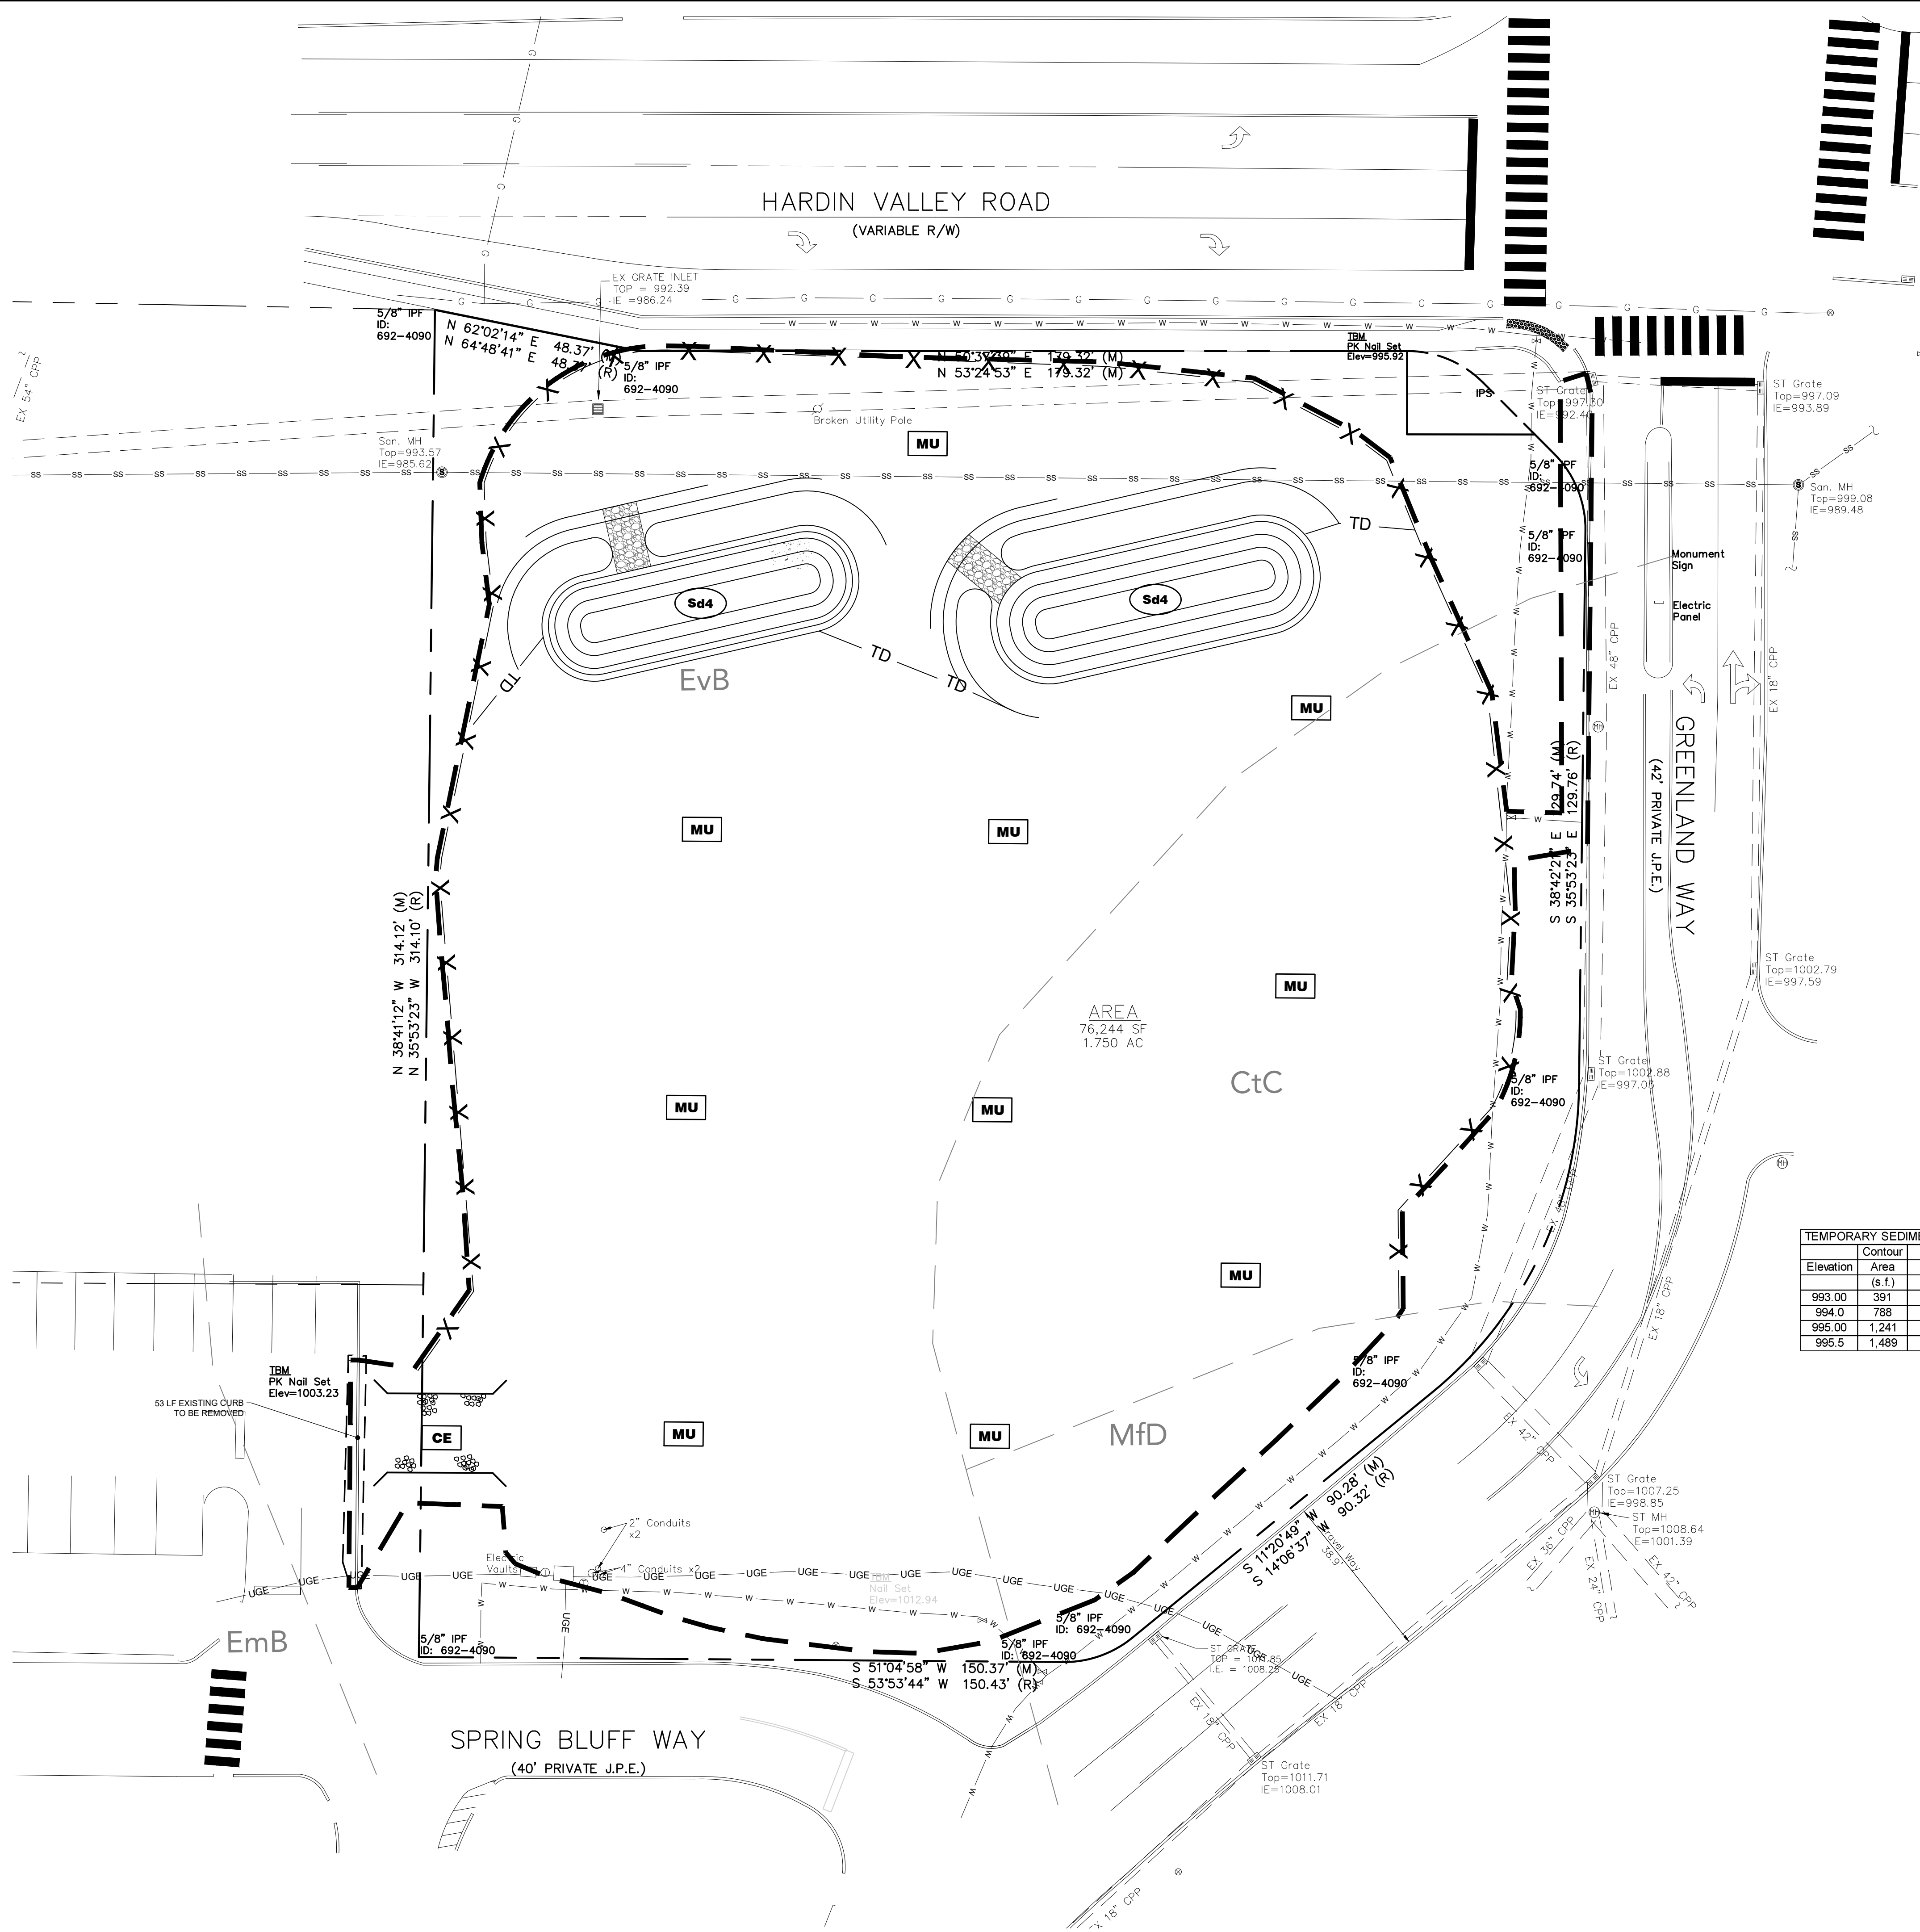


- EROSION CONTROL NOTES:**
1. DEVELOPER/OWNER: CHICK-FIL-A, INC. 5200 BUFFINGTON RD., ATLANTA GA 30349, (678) 758-4513
  2. NAME AND PHONE NUMBER OF THE 24-HOUR CONTACT PERSON FOR EROSION, SEDIMENTATION AND POLLUTION CONTROLS IS: TODD WILLIAMS (678) 758-4513
  3. TOTAL PROJECT AREA = 1.75
  4. TOTAL DISTURBED AREA = 1.5 AC
  5. THE ESCAPE OF SEDIMENT FROM THE SITE SHALL BE PREVENTED BY THE INSTALLATION OF EROSION AND SEDIMENT CONTROL MEASURES AND PRACTICES PRIOR TO LAND DISTURBING ACTIVITIES
  6. EROSION AND SEDIMENTATION CONTROL MEASURES AND PRACTICES SHALL BE MAINTAINED AT ALL TIMES. IF FULL IMPLEMENTATION OF THE APPROVED PLAN DOES NOT PROVIDE FOR EFFECTIVE EROSION AND SEDIMENT CONTROL, ADDITIONAL EROSION AND SEDIMENT CONTROL MEASURES SHALL BE IMPLEMENTED TO CONTROL OR TREAT THE SEDIMENT SOURCE.
  7. SEDIMENT STORAGE MAINTENANCE INDICATORS MUST BE INSTALLED IN SEDIMENT STORAGE STRUCTURES, INDICATING THE FULL VOLUME.
  8. MAINTENANCE OF ALL SOIL EROSION AND SEDIMENTATION CONTROL MEASURES AND PRACTICES, WHETHER TEMPORARY OR PERMANENT, SHALL AT ALL TIMES BE THE RESPONSIBILITY OF THE PROPERTY OWNER
  9. ANY DISTURBED AREA LEFT EXPOSED FOR A PERIOD GREATER THAN 14 DAYS SHALL BE STABILIZED WITH MULCH OR TEMPORARY SEEDING.
  10. ALL FILL SLOPES SHALL HAVE SILT FENCE PLACED AT THE SLOPE'S TOE.
  11. CONCENTRATED FLOW AREAS AND ALL SLOPES STEEPER THAN 2.5:1 WITH A HEIGHT OF TEN FEET OR GREATER SHALL BE STABILIZED WITH APPROPRIATE EROSION CONTROL MATTING OR BLANKET.
  12. THE PROFESSIONAL WHO SEALS THIS PLAN CERTIFIES UNDER PENALTY OF LAW THAT THIS PLAN WAS PREPARED AFTER A SITE VISIT TO THE LOCATIONS DESCRIBED HEREIN BY THE PROFESSIONAL OR THE PROFESSIONAL'S AUTHORIZED AGENT, UNDER THE PROFESSIONAL'S DIRECT SUPERVISION.
  13. UPON NOTIFICATION AND AUTHORIZATION OF THE OWNER, THE DESIGN PROFESSIONAL WHO PREPARED THE ES&PC PLAN IS RESPONSIBLE FOR INSPECTING THE INSTALLATION OF THE BMP'S WITHIN 7 DAYS AFTER INITIAL CONSTRUCTION ACTIVITIES BEGINS.
  14. THE RECEIVING WATER(S) IS UNNAMED TRIBUTARY TO TOBY CREEK.
  15. AMENDMENTS/REVISIONS TO THE ES&PC PLAN WHICH HAVE SIGNIFICANT EFFECT ON BMP'S WITH HYDRAULIC COMPONENT MUST BE CERTIFIED BY THE DESIGN PROFESSIONAL.
  16. MAINTENANCE OF ALL EROSION CONTROL MEASURES, WEATHER TEMPORARY OR PERMANENT, SHALL AT ALL TIME BE THE RESPONSIBILITY OF THE OWNER.

TEMPORARY SEDIMENT TRAP A			TEMPORARY SEDIMENT TRAP B		
Elevation	Contour	Calculated	Elevation	Contour	Calculated
	Area	Storage		Area	Storage
	(s.f.)	(c.y.)		(s.f.)	(c.y.)
993.00	391	0.00	996.00	391	0.00
994.0	788	21.83	997.0	788	21.83
995.0	1,241	59.41	998.00	1,241	59.41
995.5	1,489	84.69	998.5	1,489	84.69

LEGEND	
<b>MU</b>	TEMPORARY MULCHING
<b>SOD</b>	SOD - PERMANENT GROUND COVER
<b>MB</b>	MATting BLANKET
<b>IP</b>	INLET PROTECTION
<b>IP-B</b>	SILT SACK
<b>PS</b>	PERMANENT SEEDING
<b>CE</b>	CONSTRUCTION ENTRANCE
<b>SF</b>	SILT FENCE
<b>SD3</b>	TEMPORARY SEDIMENT TRAP
TEMPORARY DIVERSION <b>TD</b>	
LIMITS OF DISTURBANCE <b>---</b>	


NOTE: \* INLET SEDIMENT TRAP SD2-F SHALL BE USED IN NON PAVED AREAS UNTIL PAVING IS COMPLETE. WHILE SD2-SS SHALL BE USED IN AREAS THAT IS PAVED.

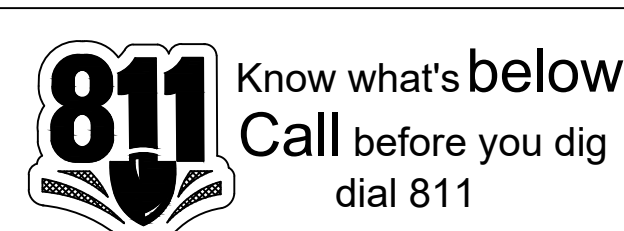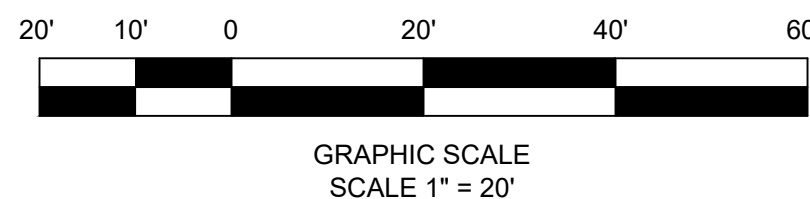

**Chick-fil-A**

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Atlanta Georgia,  
30349-2998

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SHEET TITLE  
**E&SC PLAN  
PHASE I**  
REVISION 4-2023

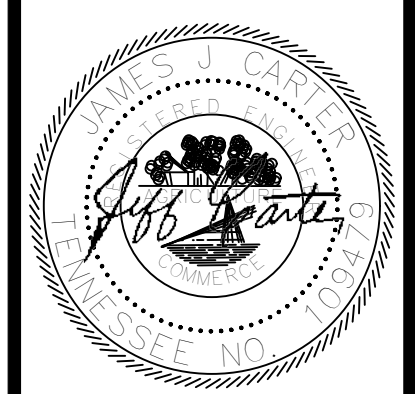Job No. : 23043CFA  
Store : 05442  
Date : 08/28/23

Sheet  
**C-5.0**

ISSUE FOR PERMIT






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STORE # 05442  
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KNOXVILLE, TN 37932

SHEET TITLE

E&SC PLAN  
PHASE II

REVISION 4-2023

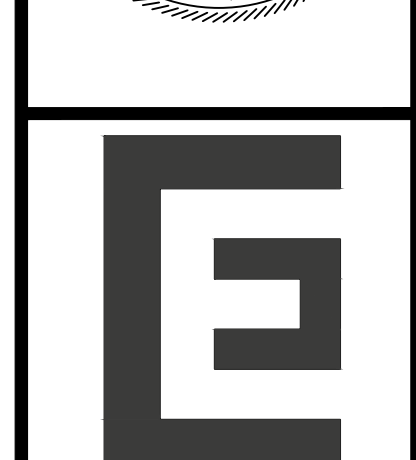Job No. : 23043CFA


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C-5.1

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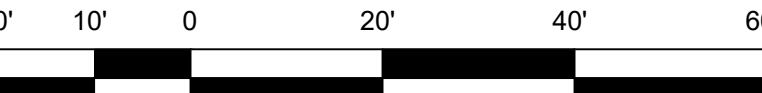


LOCATION MAP  
SCALE: N.T.S.

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  13. UPON NOTIFICATION AND AUTHORIZATION OF THE OWNER, THE DESIGN PROFESSIONAL WHO PREPARED THE ES&PC PLAN IS RESPONSIBLE FOR INSPECTING THE INSTALLATION OF THE BMP'S WITHIN 7 DAYS AFTER INITIAL CONSTRUCTION ACTIVITIES BEGINS.
  14. THE RECEIVING WATER(S) IS UNNAMED TRIBUTARY TO TOBY CREEK.
  15. AMENDMENTS/REVISIONS TO THE ES&PC PLAN WHICH HAVE SIGNIFICANT EFFECT ON BMP'S WITH HYDRAULIC COMPONENT MUST BE CERTIFIED BY THE DESIGN PROFESSIONAL.
  16. MAINTENANCE OF ALL EROSION CONTROL MEASURES, WEATHER TEMPORARY OR PERMANENT, SHALL AT ALL TIME BE THE RESPONSIBILITY OF THE OWNER.

LEGEND	
MU	TEMPORARY MULCHING
SOD	SOD - PERMANENT GROUND COVER
MB	MATting BLANKET
IP	INLET PROTECTION
IP-B	SILT SACK
PS	PERMANENT SEEDING
CE	CONSTRUCTION ENTRANCE
SF	SILT FENCE
SD3	TEMPORARY SEDIMENT TRAP
TEMPORARY DIVERSION TD	
LIMITS OF DISTURBANCE	

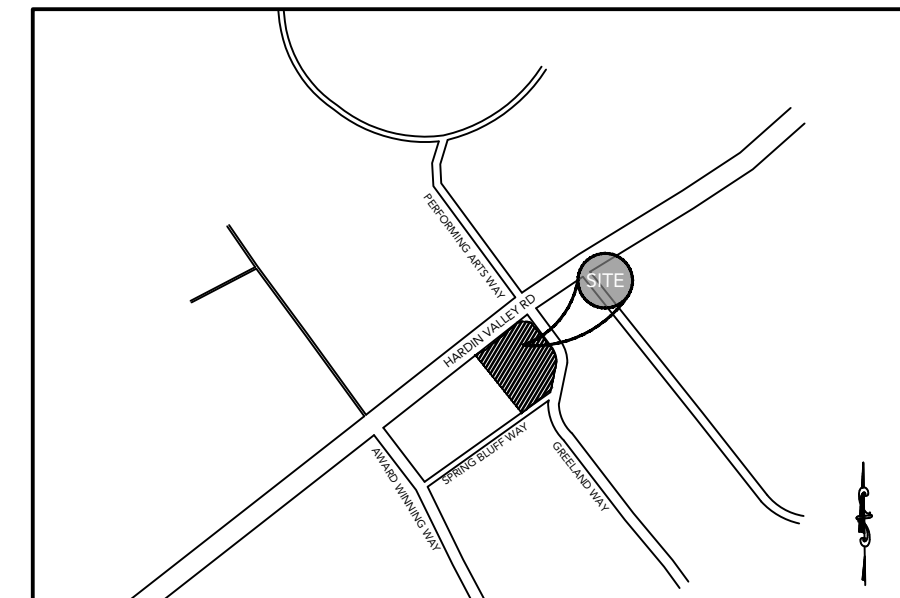
NOTE: \* INLET SEDIMENT TRAP SD2-F SHALL BE USED IN NON PAVED AREAS UNTIL PAVING IS COMPLETE. WHILE SD2-SS SHALL BE USED IN AREAS THAT IS PAVED.



GRAPHIC SCALE  
SCALE 1" = 20'

Phase II & III Inlet Sediment Trap Calculations								
Structure ID	B-1	B-3	B-4	B-7	B-8	C-1	D-1	E-1
Drainage Area (acres)	0.41	0.23	0.16	0.13	0.13	0.33	0.02	0.03
Volume Required (cu. Ft.)	742	416	289	235	235	597	36	54
Excavated Depth (ft.)	2.5	2.5	1.5	1.5	1.5	2.5	1.5	1.5
Required Excav. Diameter (ft.)	20.0	15.0	16.0	15.0	15.0	18.0	6.0	7.0
Volume Provided (cu. Ft.)	785	442	302	265	265	636	42	58
								TOTAL
								2059 C.F.
								76.26 C.Y.D.

IE=1008.01

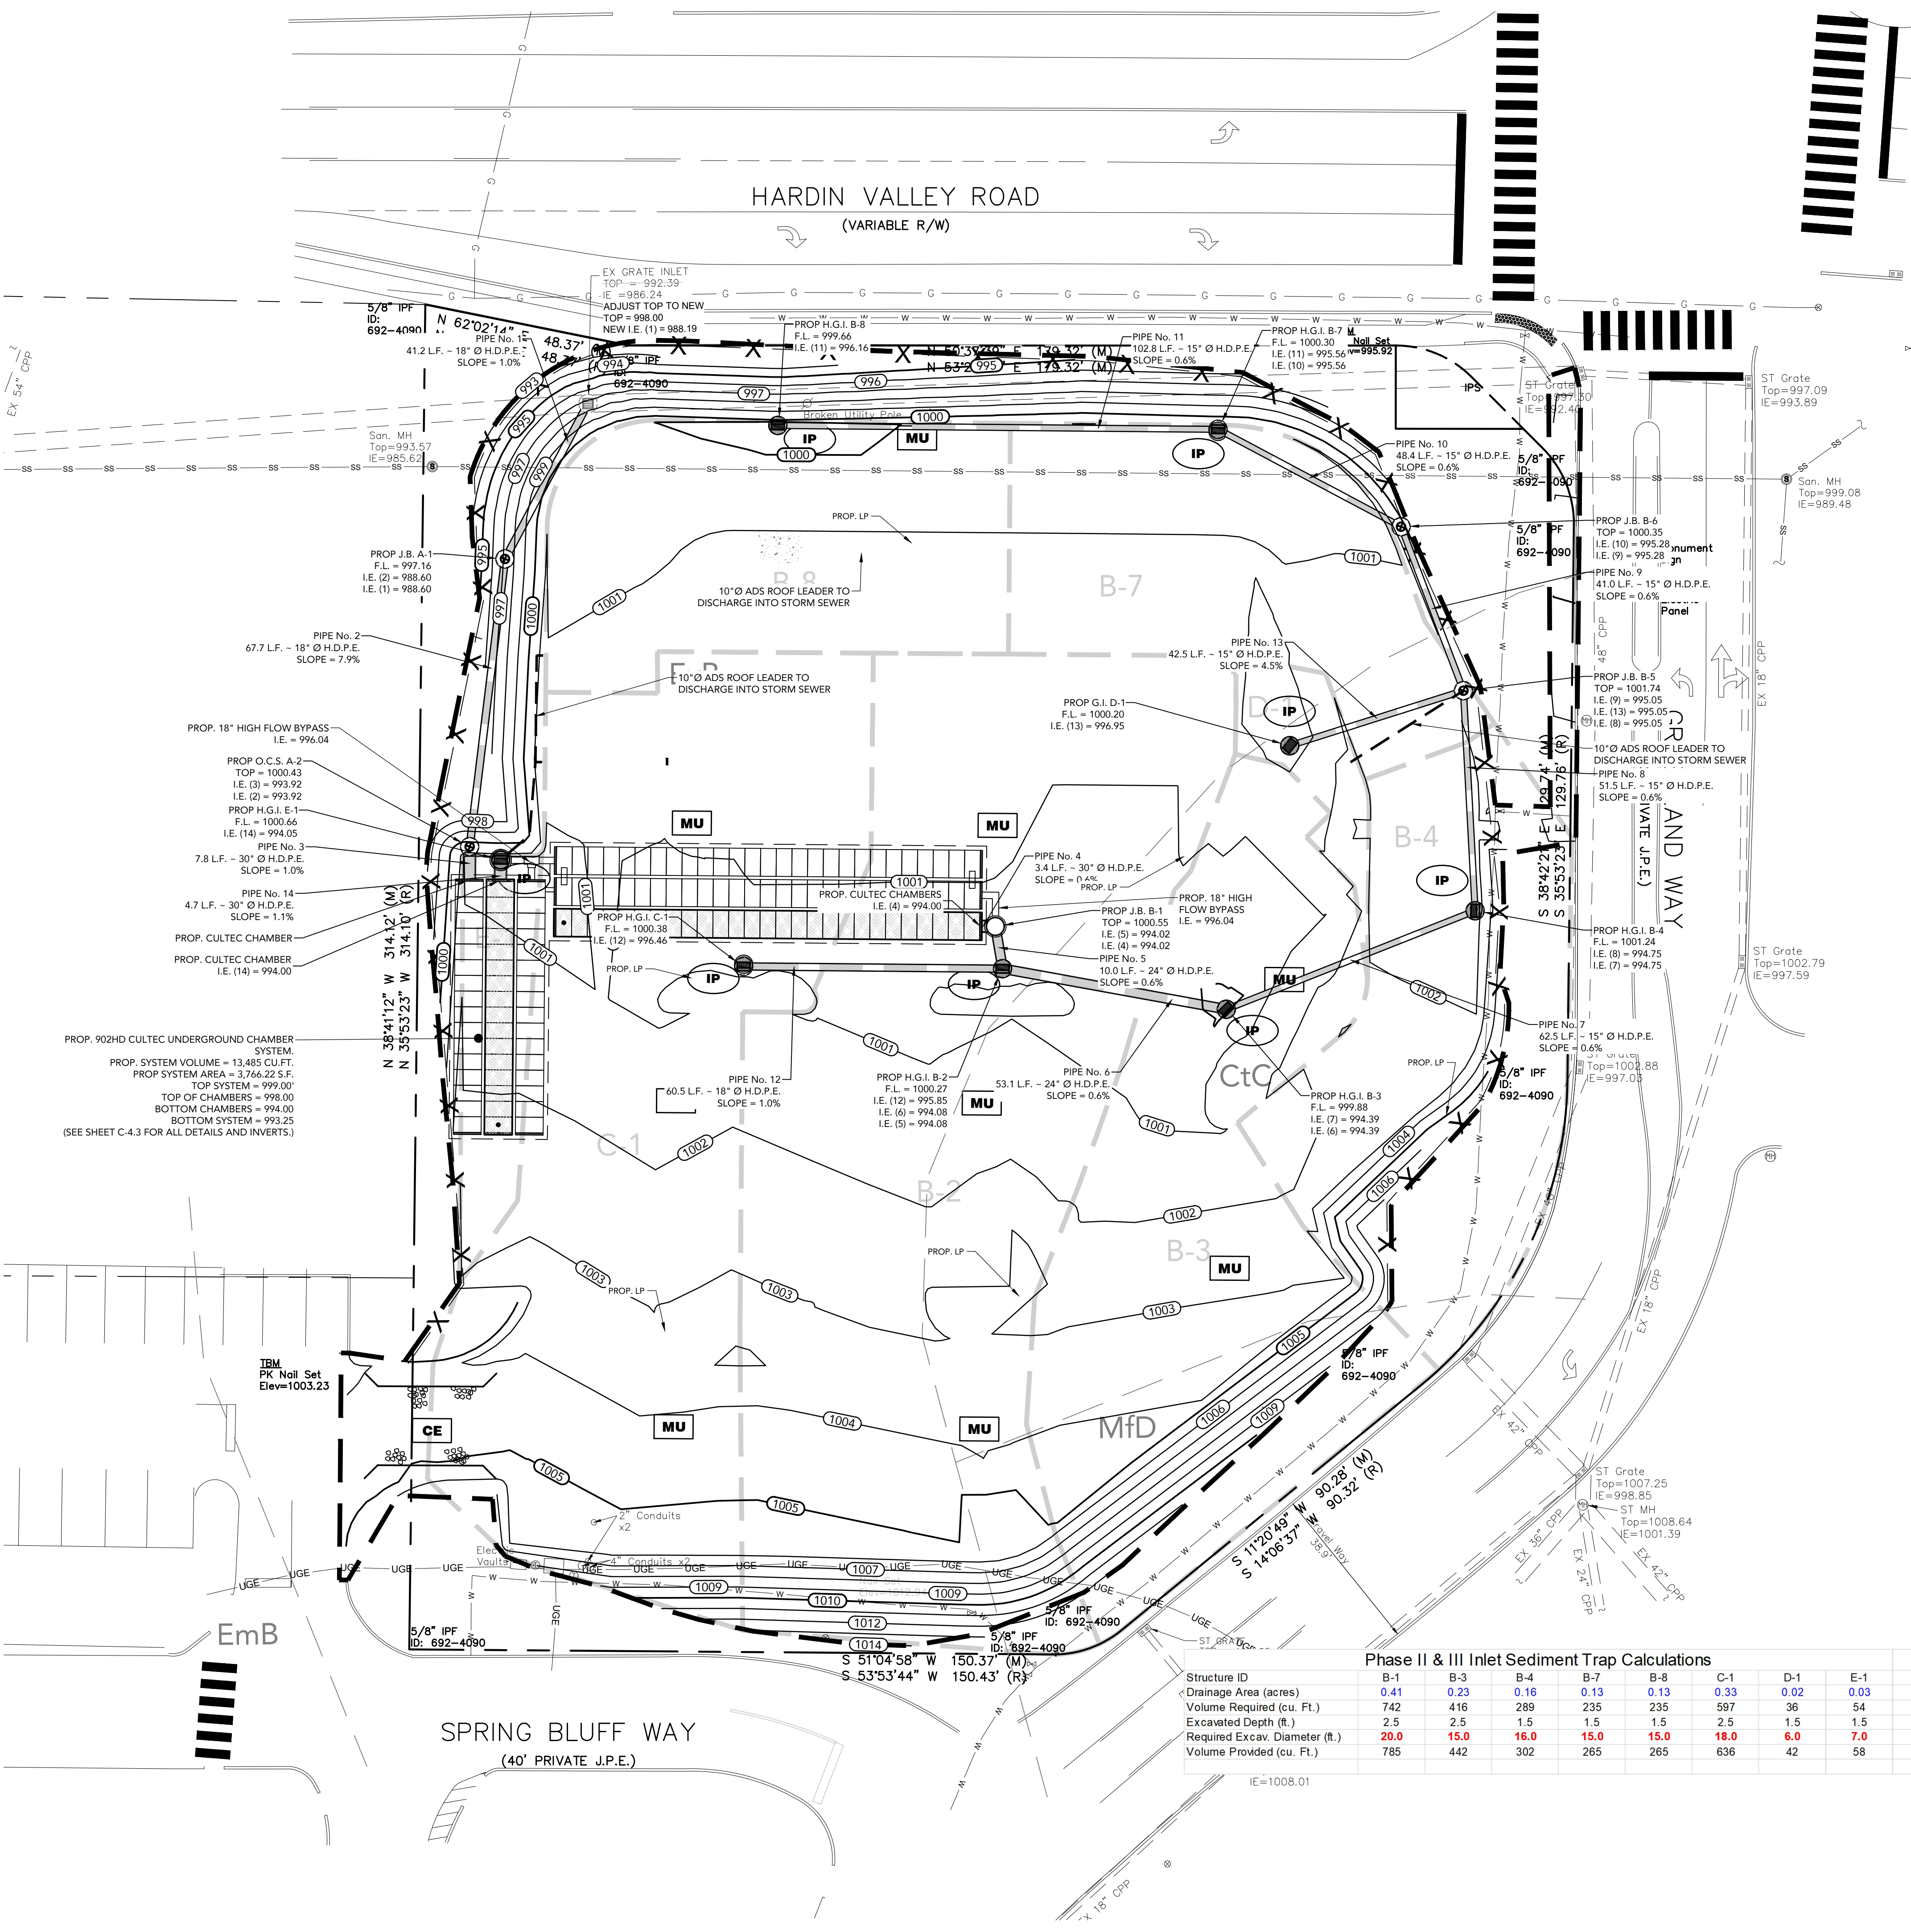






REV. #	DATE	REVISION
A	06/02/2023	INITIAL REVIEW
B	06/06/2023	PCR
C	07/25/2023	TTCTA SUBMITTAL
D	08/28/2023	REVISED PER TTCTA COMMENTS
-	-	-
-	-	-




Sheet

C-5.2

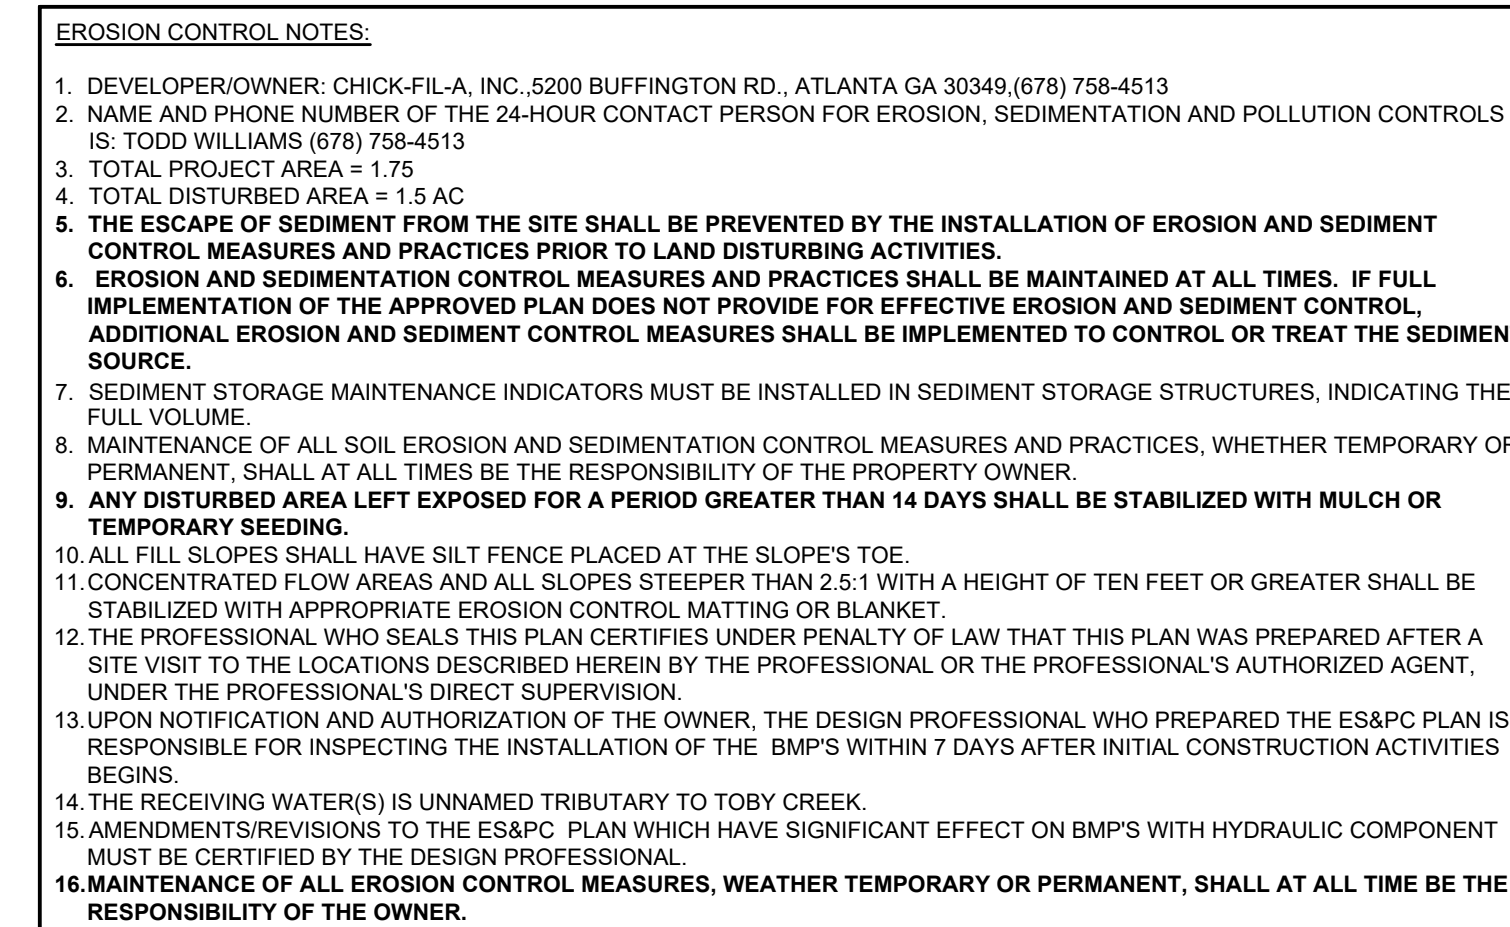

 Know what's **below**  
**Call** before you dig  
dial 811

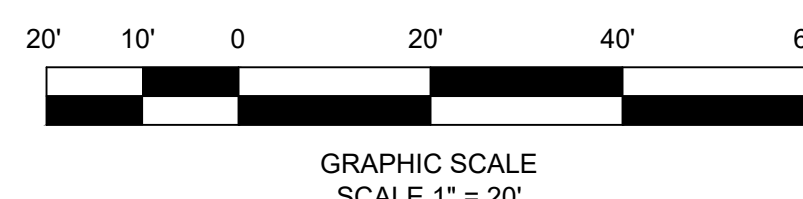

	Phase II & III Inlet Sediment Trap Calculations								
Structure ID	B-1	B-3	B-4	B-7	B-8	C-1	D-1	E-1	
Drainage Area (acres)	0.41	0.23	0.16	0.13	0.13	0.33	0.02	0.03	
Volume Required (cu. Ft.)	742	416	289	235	235	597	54	36	
Excavated Depth (ft.)	2.5	2.5	1.5	1.5	1.5	2.5	1.5	1.5	
Required Excav. Diameter (ft.)	2.0	1.5	1.0	1.5	1.0	1.8	0.6	0.7	TOTAL
Volume Provided (cu. Ft.)	785	442	302	265	265	636	42	58	2059 C.F. 76.26 C.Y.D.

# SSUE FOR PERMIT



PS Permanent Cover Seeding Mixtures

Seeding Dates	Grass Seed	Percentages
February 1 to July 1	Kentucky 31 Fescue	80%
	Korean Lespedeza	15%
	English Rye	5%
June 1 to August 15	Kentucky 31 Fescue	55%
	English Rye	20%
	Korean Lespedeza	15%
	German Millet	10%
April 15 to August 15	Bermudagrass (hulled)	70%
	Annual Lespedeza	30%
August 1 to December 1	Kentucky 31 Fescue	70%
	English Rye	20%
	White Clover	10%
February 1 to December 1	Kentucky 31 Fescue	70%
	Crown Vetch	25%
	English Rye	5%

Source: TDOT Standard Specifications

Table 1

TS



**Topsoil:** Topsoil should be friable and loamy, free of debris, objectionable weeds and stones, and contain no toxic substances that may be harmful to plant growth. When replacing topsoil on disturbed areas, maintain needed erosion and sediment control practices such as diversions, boms, sediment basins, etc. Grades containing these structures should be maintained after the topsoil is applied.

Topsoil should be handled only when it is dry enough to work without damaging soil structure. A uniform application of 5 inches (unsettled) is recommended, but may be adjusted at the discretion of the engineer or landscape architect. See Table 2 for additional information about the volume of topsoil to achieve various depths.

**Seedbed Preparation:** When conventional seeding is to be used, topsoil should be applied to any area where the disturbance results in subsoil being the final grade surface.

Broadcast plantings

- Seedbed preparation may not be required where hydraulic seeding equipment is to be used.
- Tillage, at a minimum, shall adequately loosen the soil to a depth of 4 to 6 inches; alleviate compaction; incorporate topsoil, lime, and fertilizer; smooth and firm the soil; allow for the proper placement of seed, sprigs, or plants; and allow for the anchoring of straw or hay mulch if a crimper is to be used.
- Tillage may be done with any suitable equipment.
- Tillage should be done parallel to the contour where feasible.
- On slopes too steep for the safe operation of tillage equipment, the soil surface shall be pitted or trenched across the slope with appropriate hand tools to provide consecutive beds 6 to 8 inches apart, in which seed may

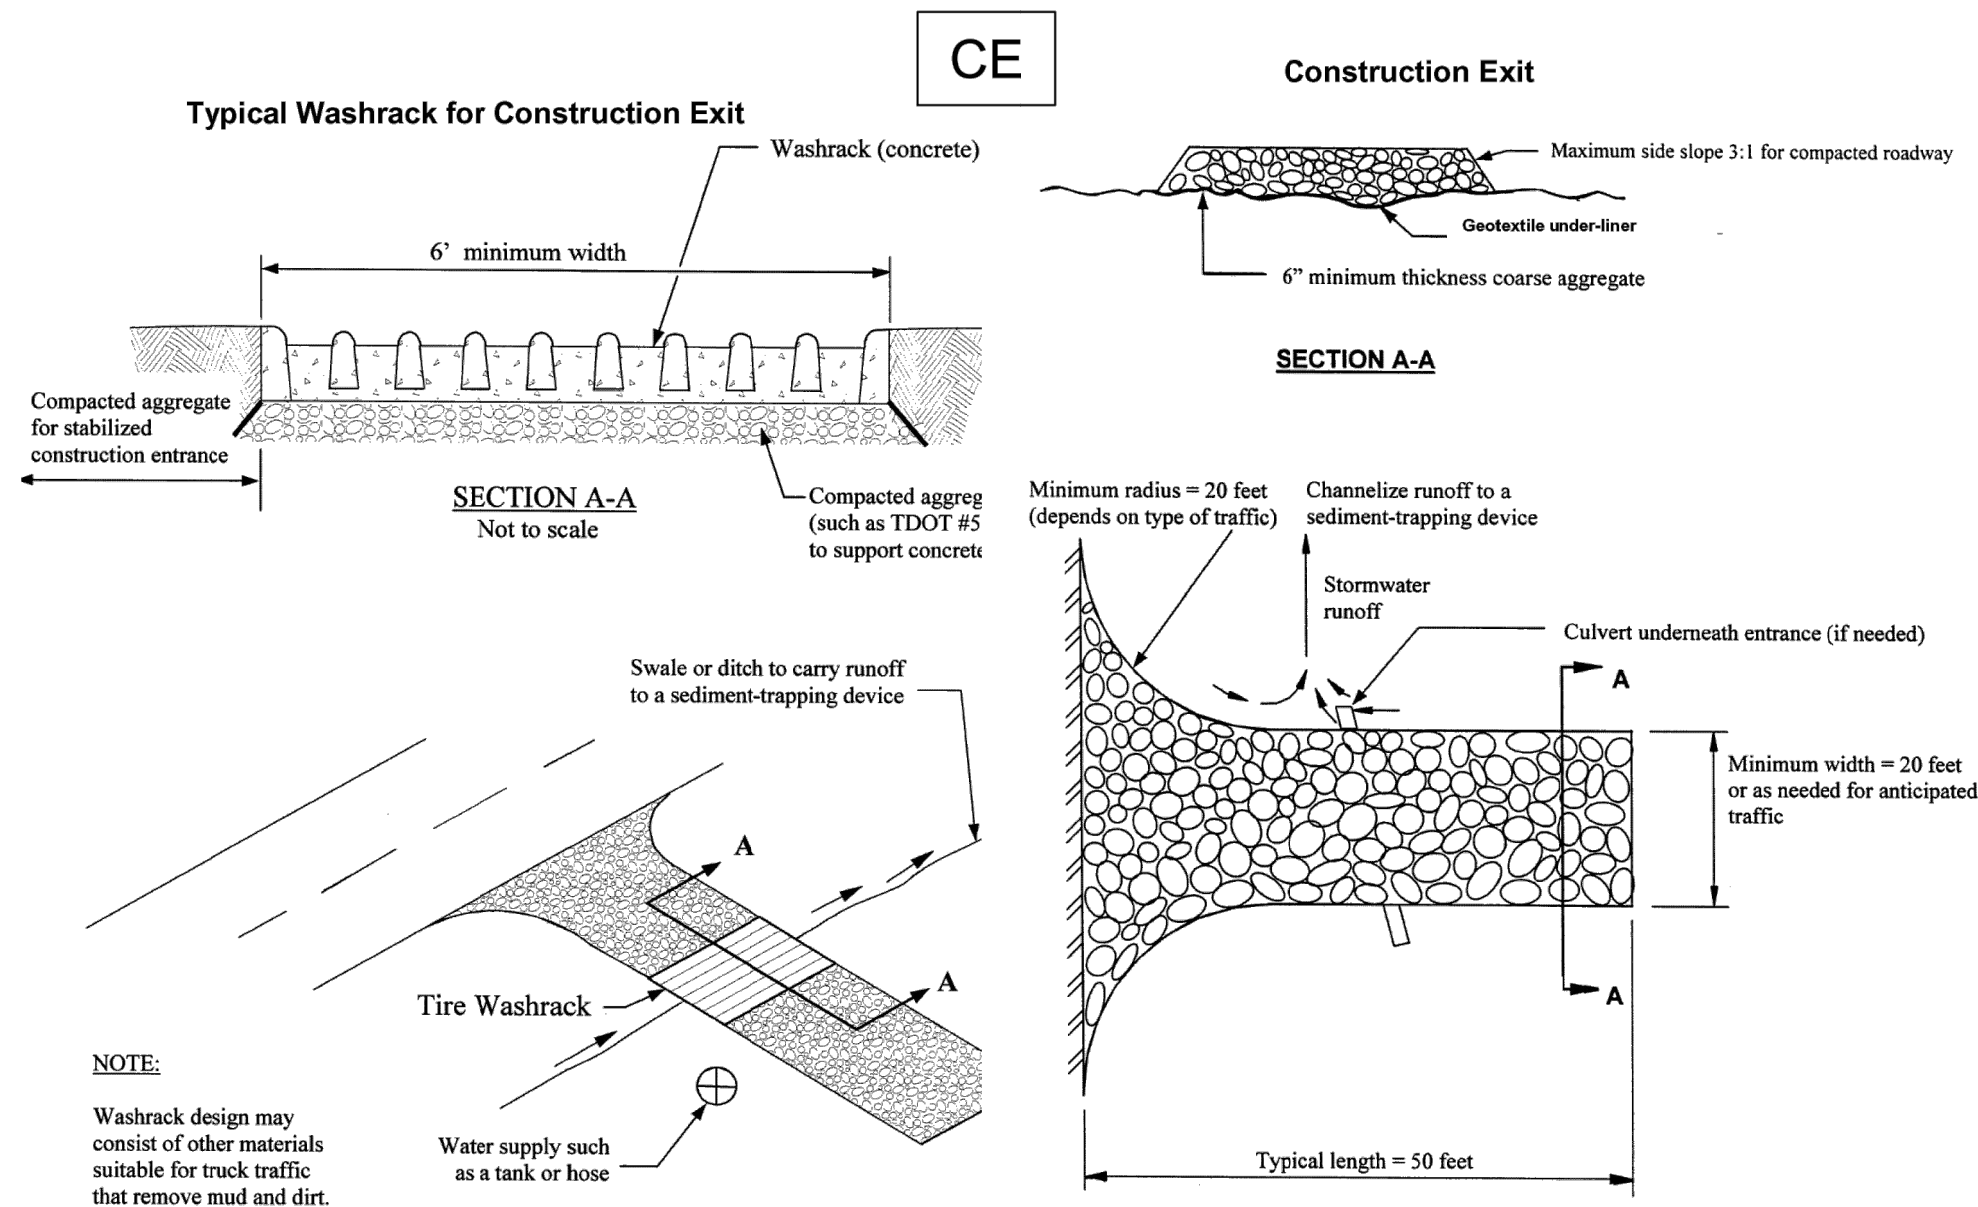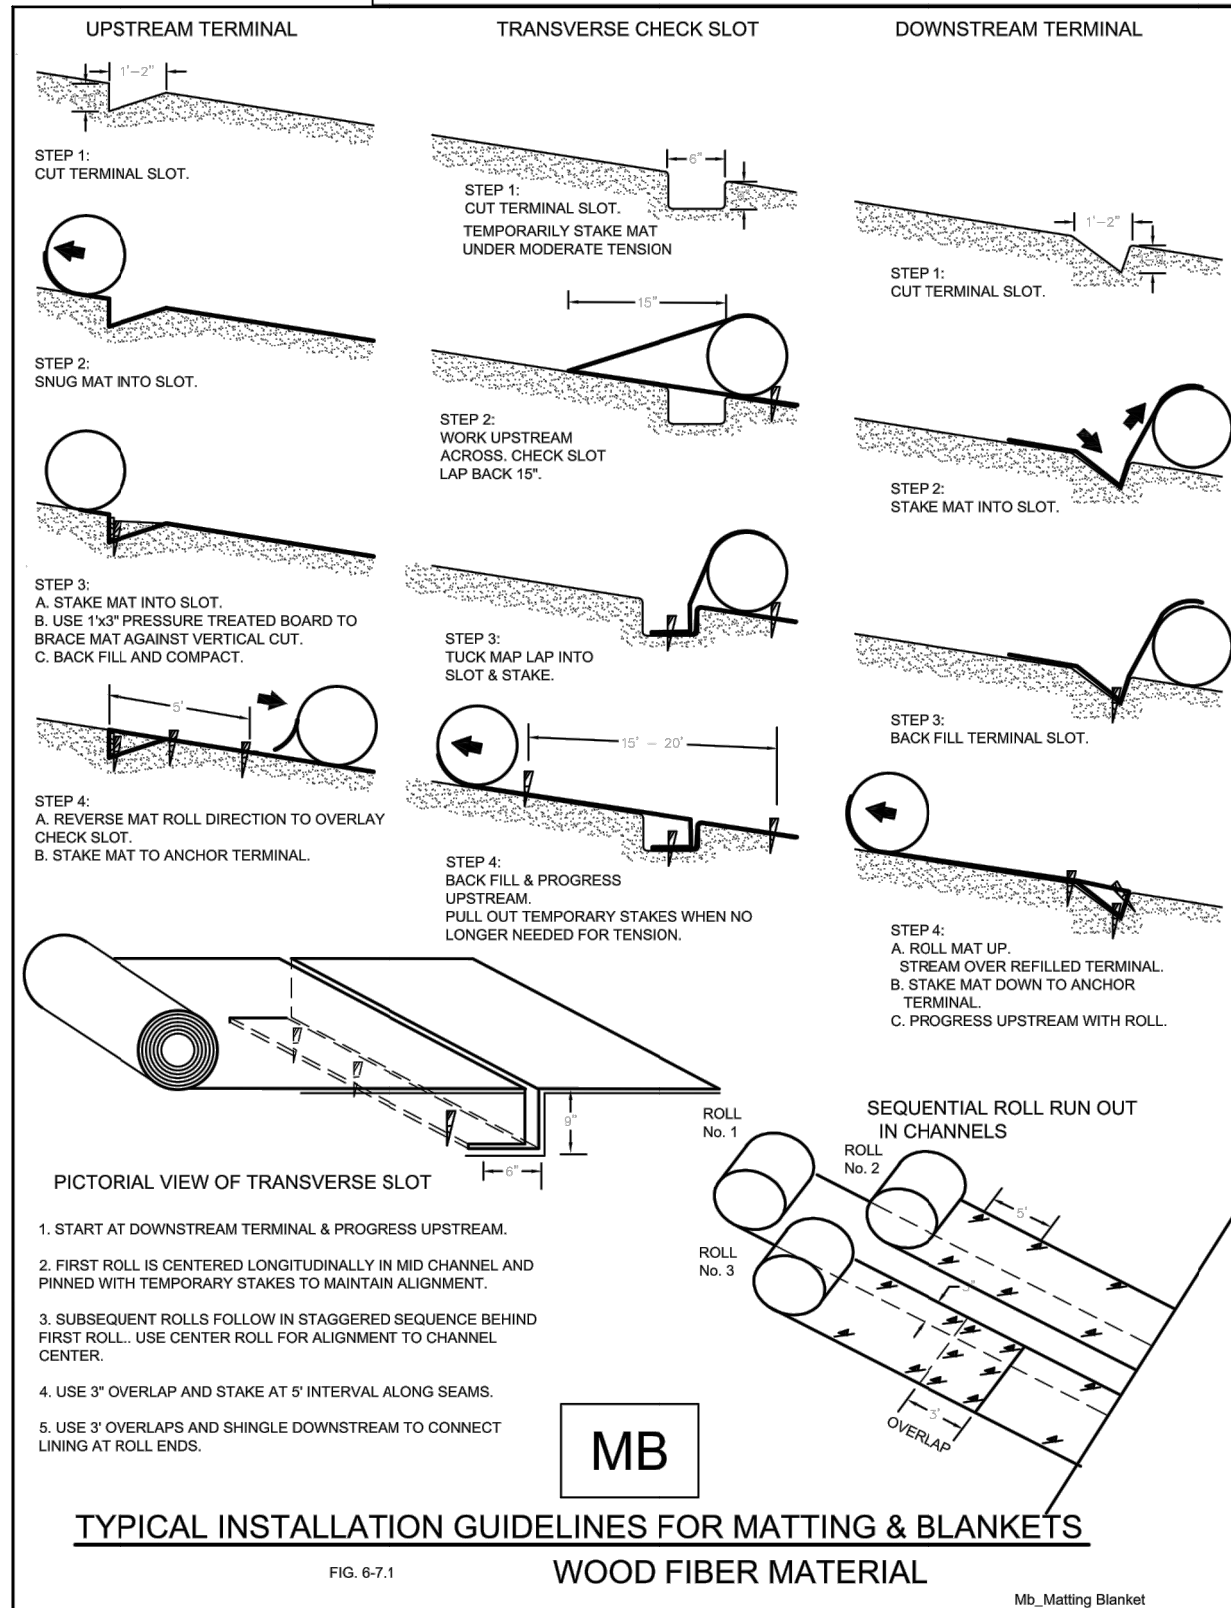

Chapter 7

Management Practices


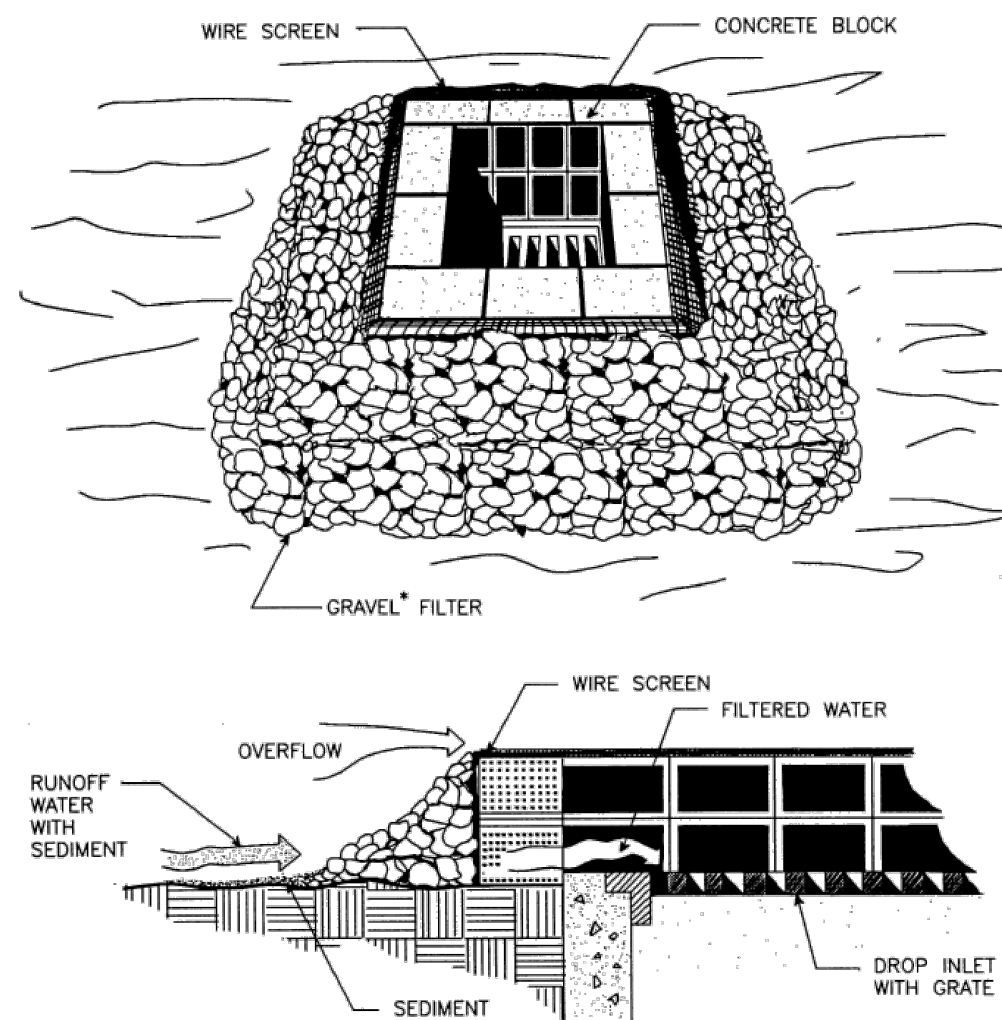


Figure 7.35-3 Block and Gravel Inlet Protection (Source: V&A DSWC)

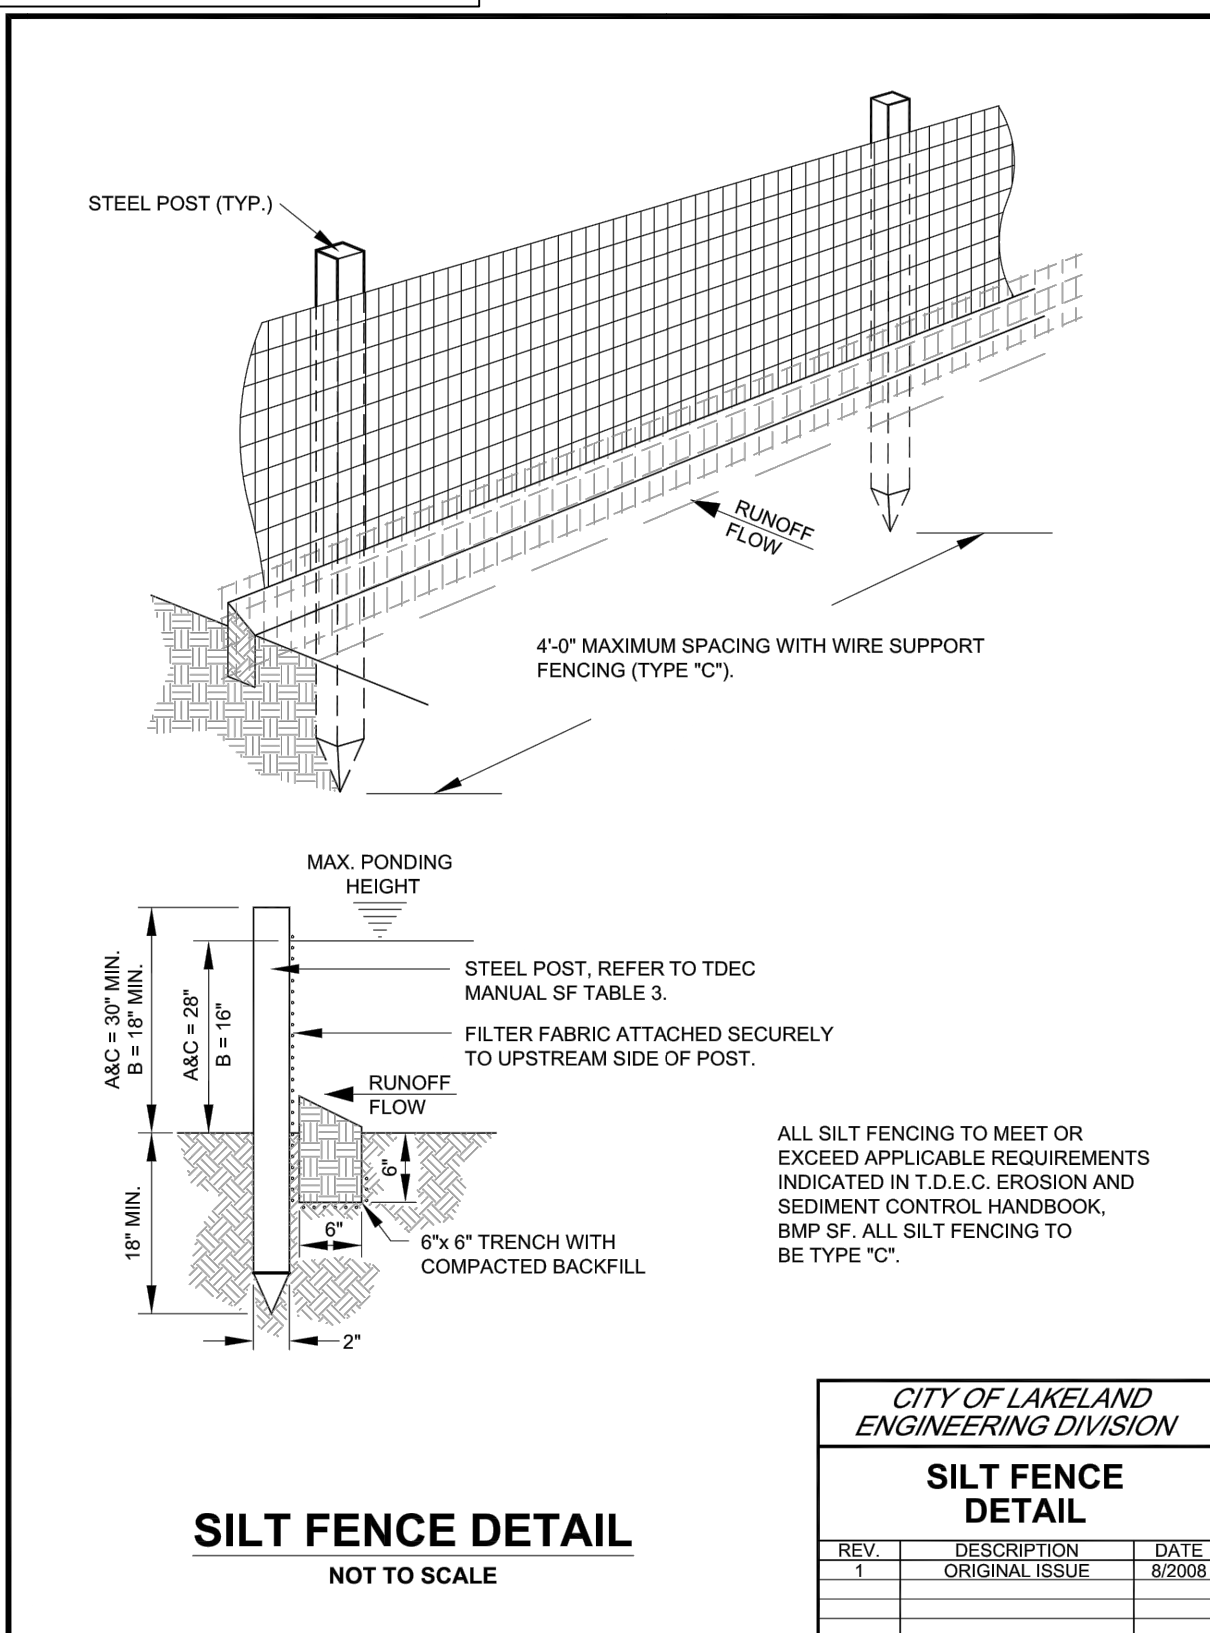

Manufacturers Advanced Composite Materials, Automotive and Apparel Specialty Fabrics, Wax Binding, Electrical Insulation, Reflective Tape, Narrow Fabrics, EXC. Film, Construction, Survey & Safety Accessories


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707 W. GRANGE STREET, PHILADELPHIA, PA 19120

800 623-0888 215 927-6000 FAX: 215 927-3366

CUSTOMER SERVICE LINE

#14925 SILT SACK

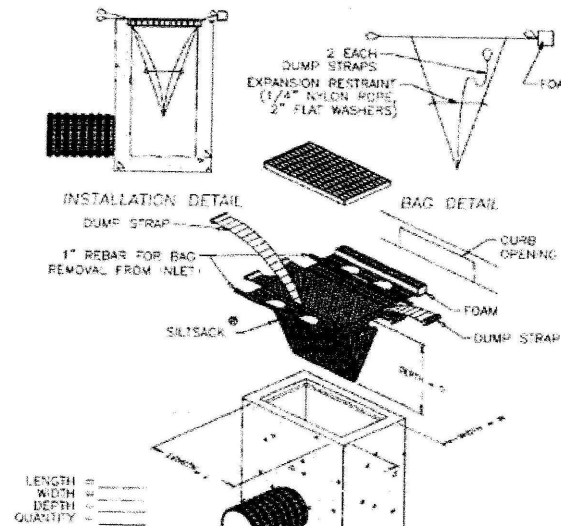

Property	Test Method	Units	Test Results
Grab Sample	ASTM D-4884	Bu.	3750/500
Grab Elongation	ASTM D-4832	%	154/3
Puncture	ASTM D-4833	Bu.	125
Machine Burst	ASTM D-3380	PSI	650
Tensile Tear	ASTM D-4533	Bu.	1200/150
UV Resistance	ASTM D-4355	%	90
Apparent Opening	ASTM D-4351	US Sieve	40
Flow Rate	ASTM D-4491	gallon/hr	40
Permeability	ASTM D-4491	sec."	0.55



**Chick-fil-A**

5200 Buffington Rd.  
Atlanta Georgia,  
30349-2998

REVISION BLOCK:		REVISION		DATE		INITIAL REVIEW	
REV. #	A	DATE	06/02/2023	INITIAL REVIEW	PCR	DATE	07/25/2023
	B		06/06/2023		PCR		07/25/2023
	C		07/25/2023		TTODA SUBMITTAL		08/28/2023
	D		08/28/2023		REVISED PER TTODA COMMENTS		



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STORE # 05442  
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SHEET TITLE

EROSION  
DETAILS

REVISION 4-2023

Job No. : 23043CFA

Store : 05442

Date : 08/28/23

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C-5.3

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REVISION BLOCK:				REVISION			
REV. #	DATE	DESCRIPTION	BY	DATE	DESCRIPTION	BY	DATE
A	06/02/2023	INITIAL REVIEW	PCR				
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2187 GREENLAND WAY,  
KNOXVILLE, TN 37932

SHEET TITLE

**STANDARD  
DETAILS II**

REVISION 4-2023

Job No. : 23043CFA









Store : 05442

Date : 08/28/23

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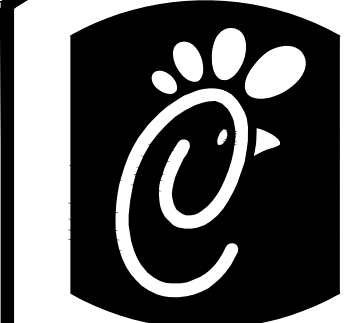
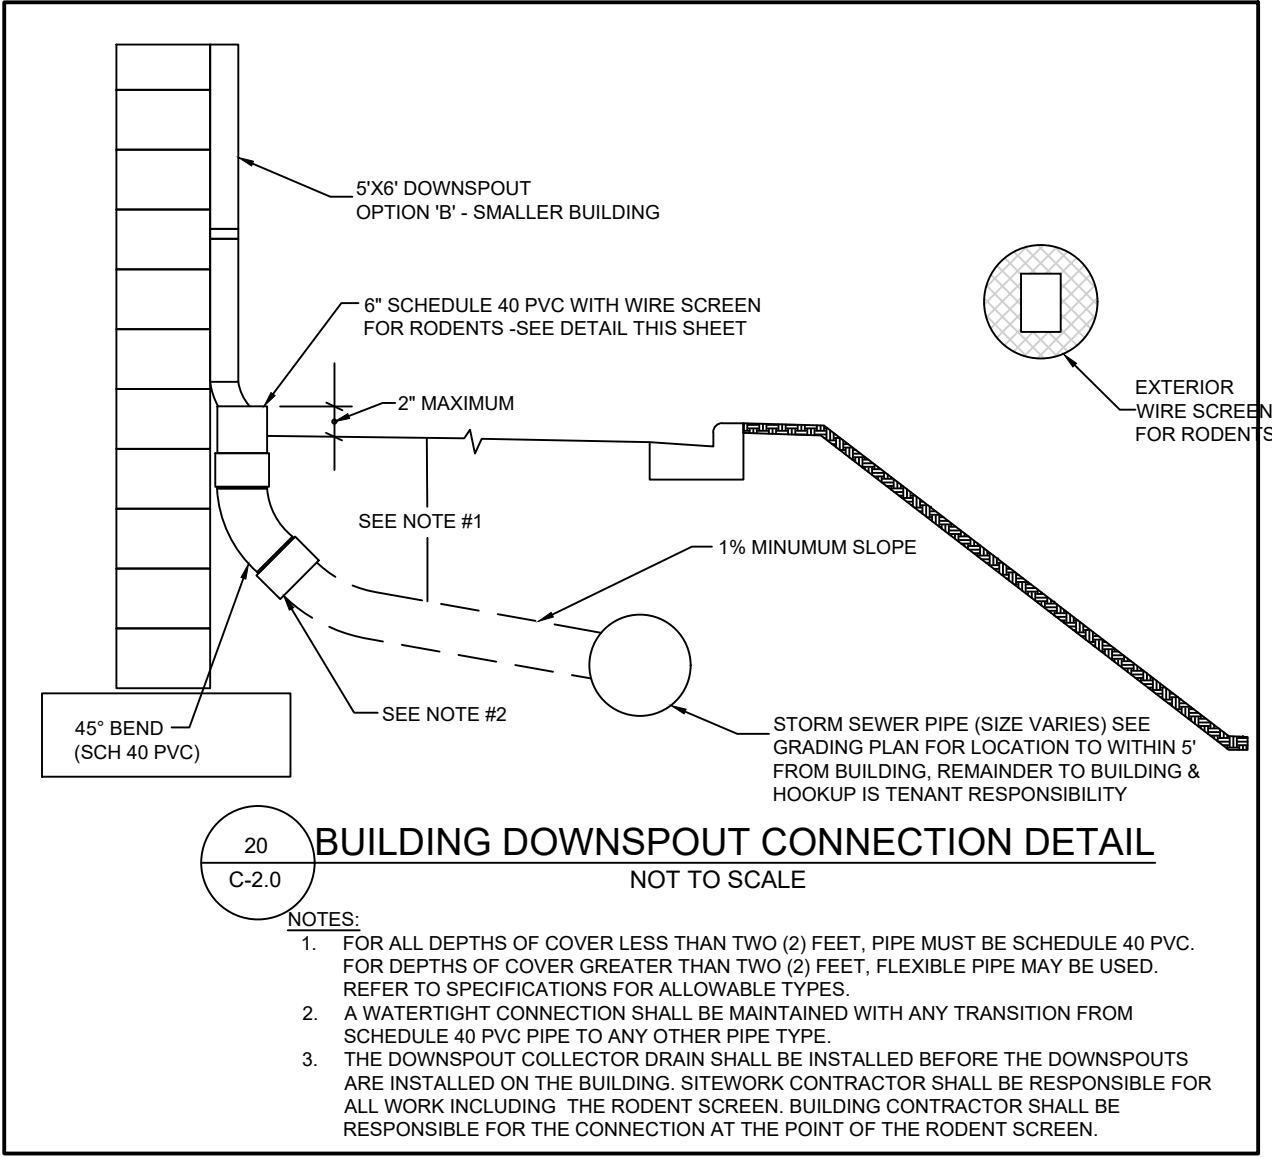
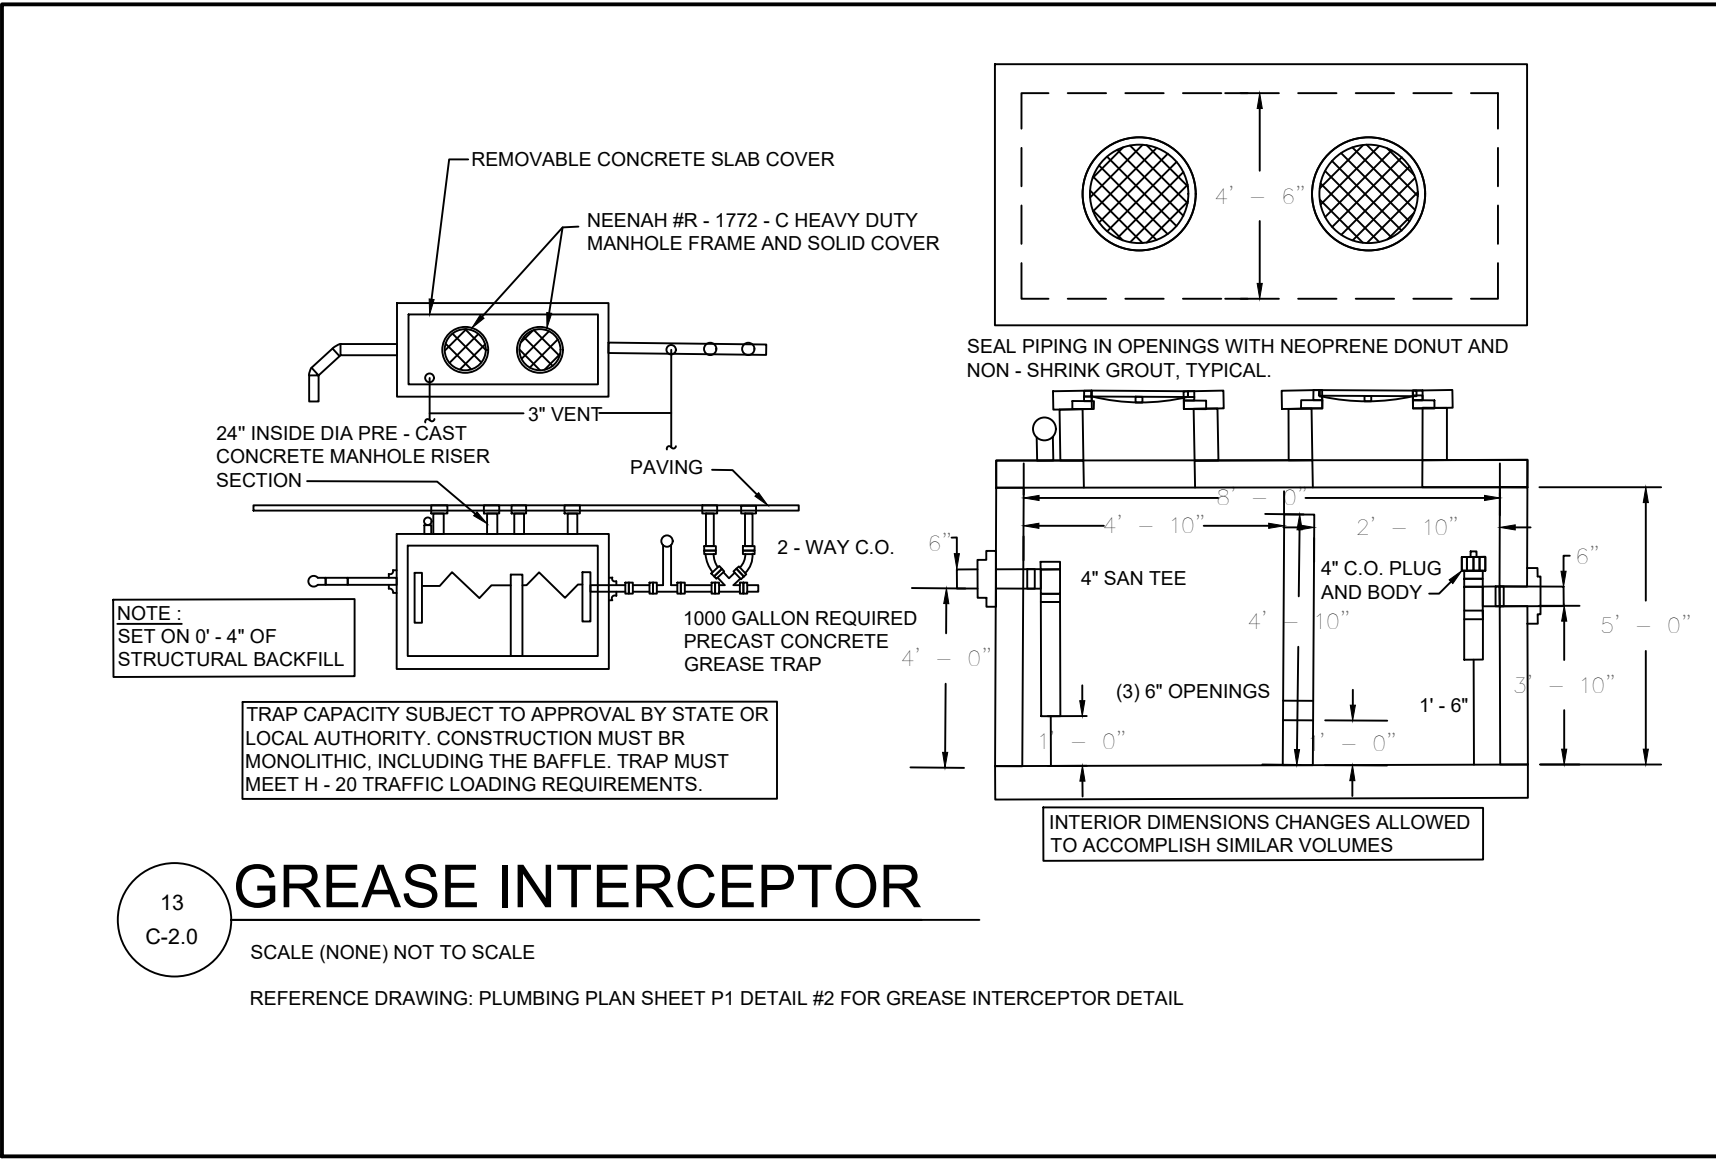
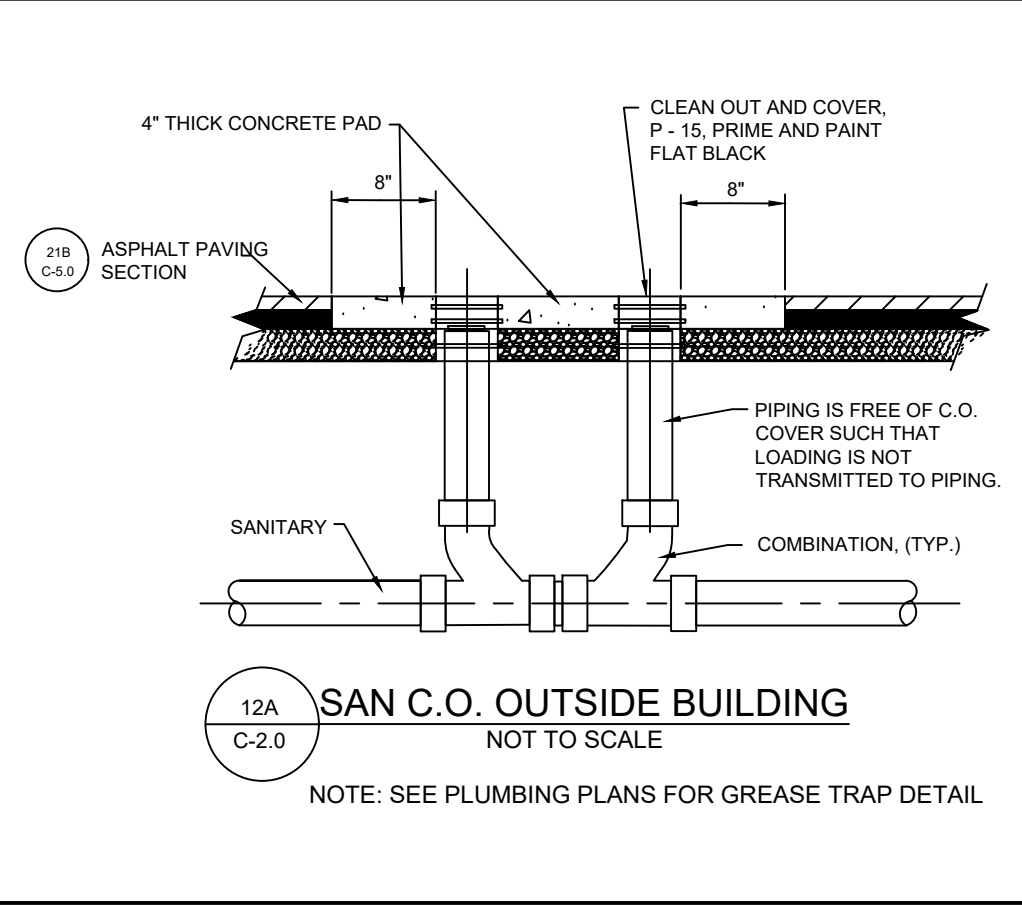
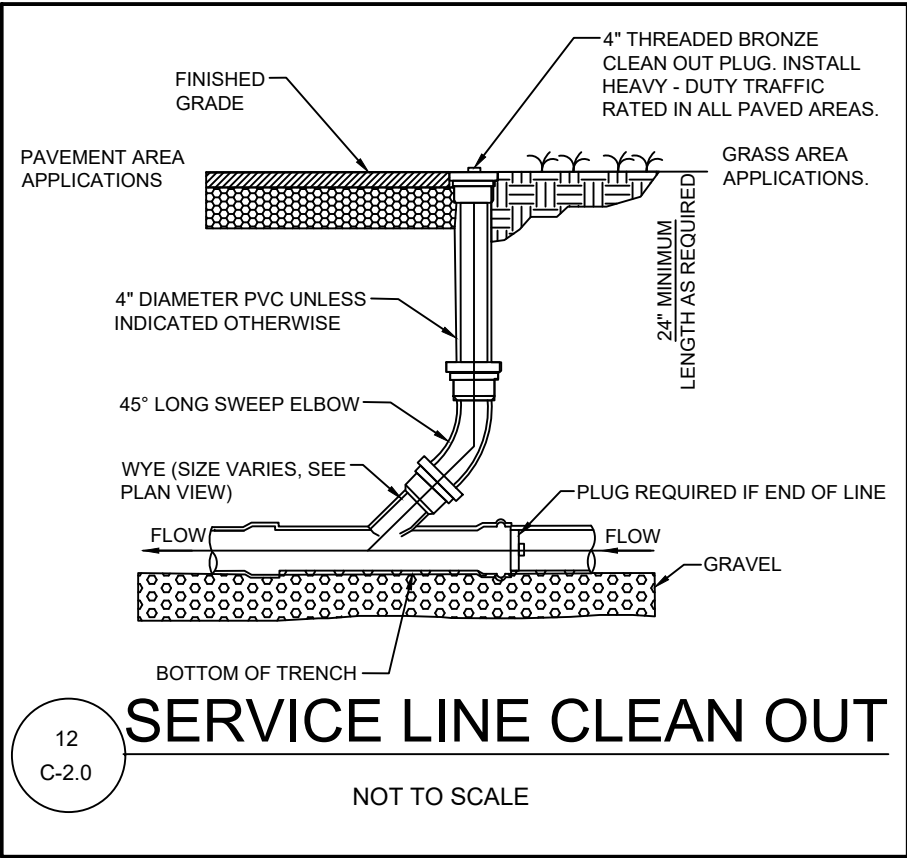
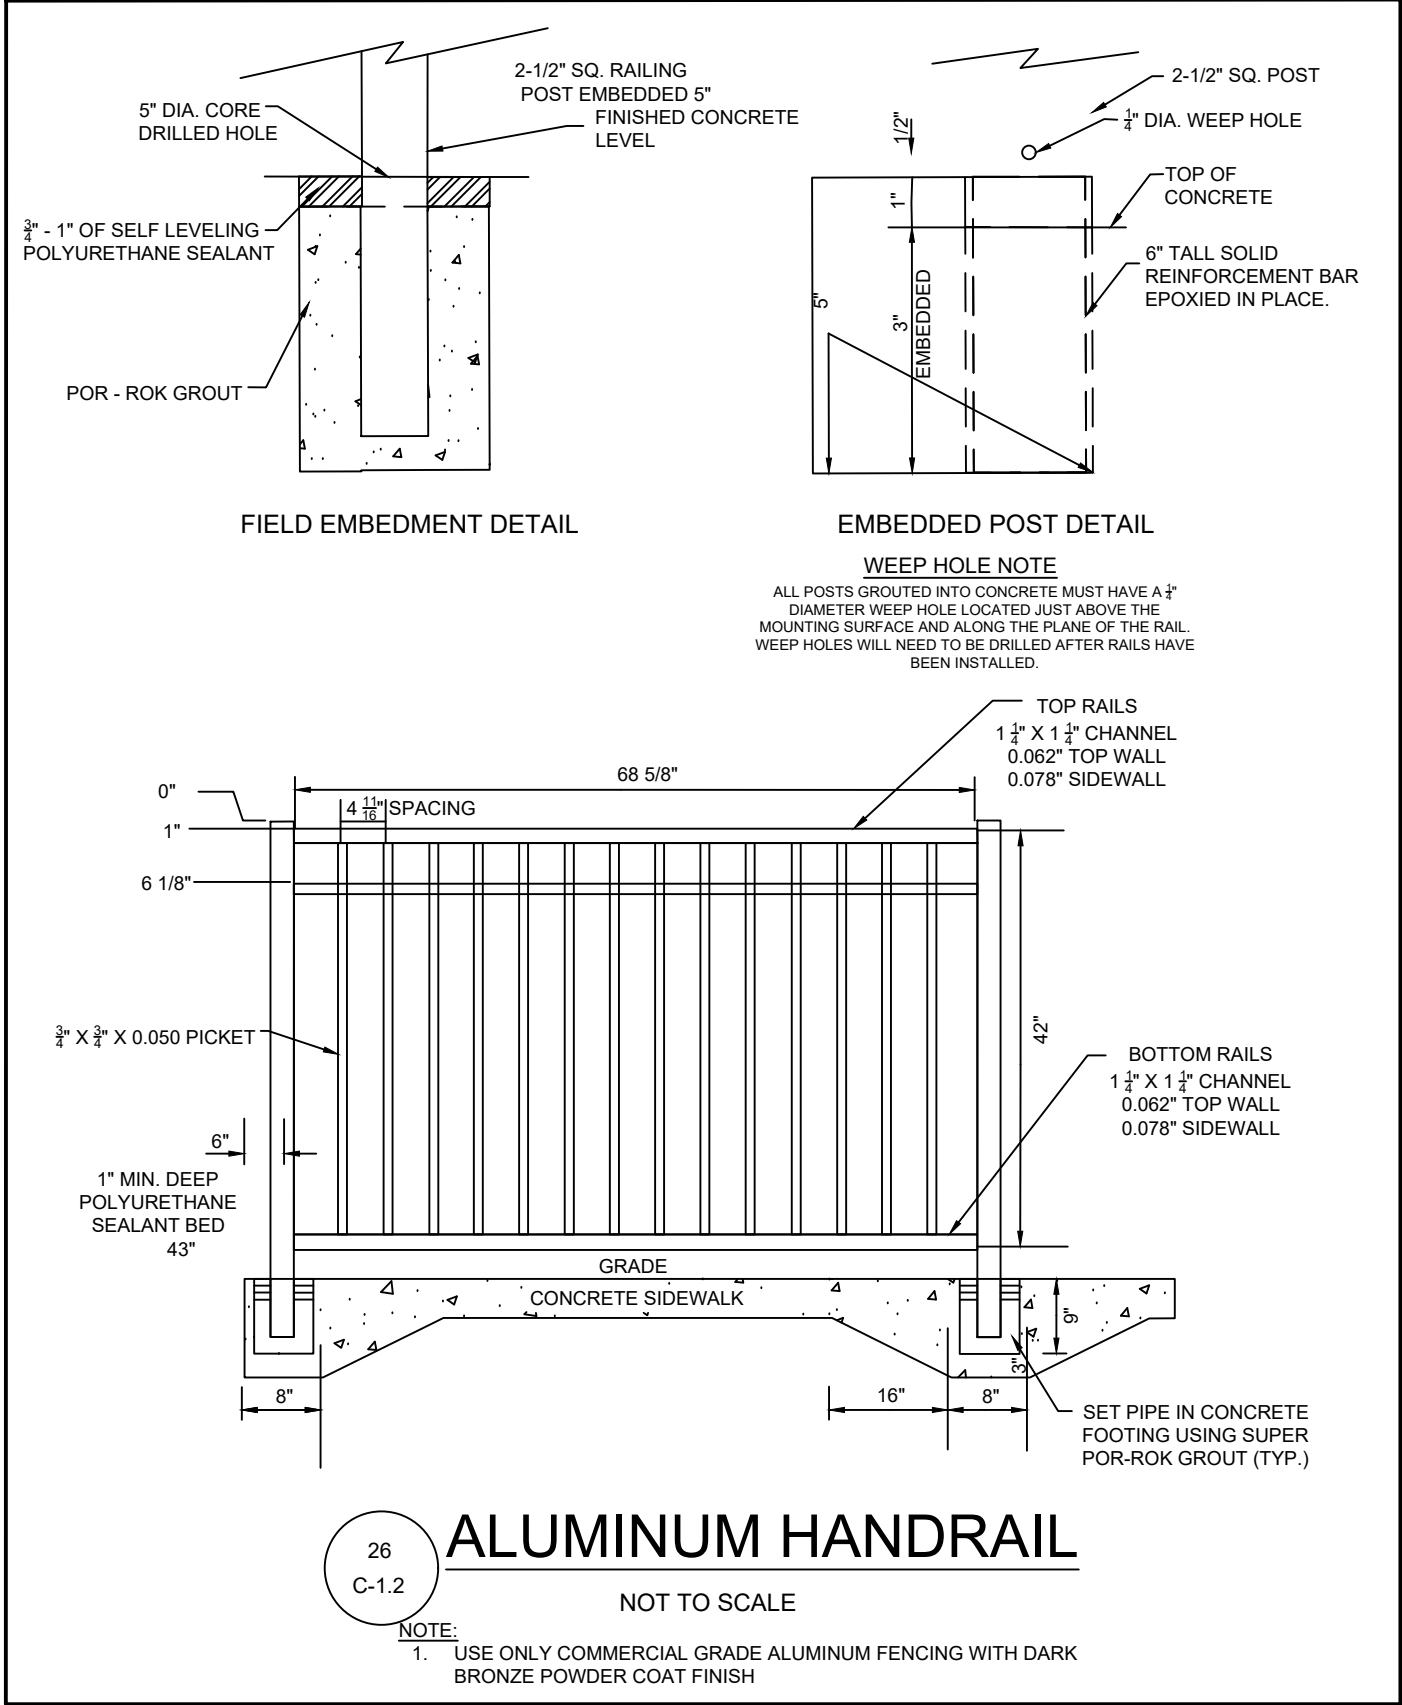
**C-6.1**

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UTILITY STANDARD DETAILS

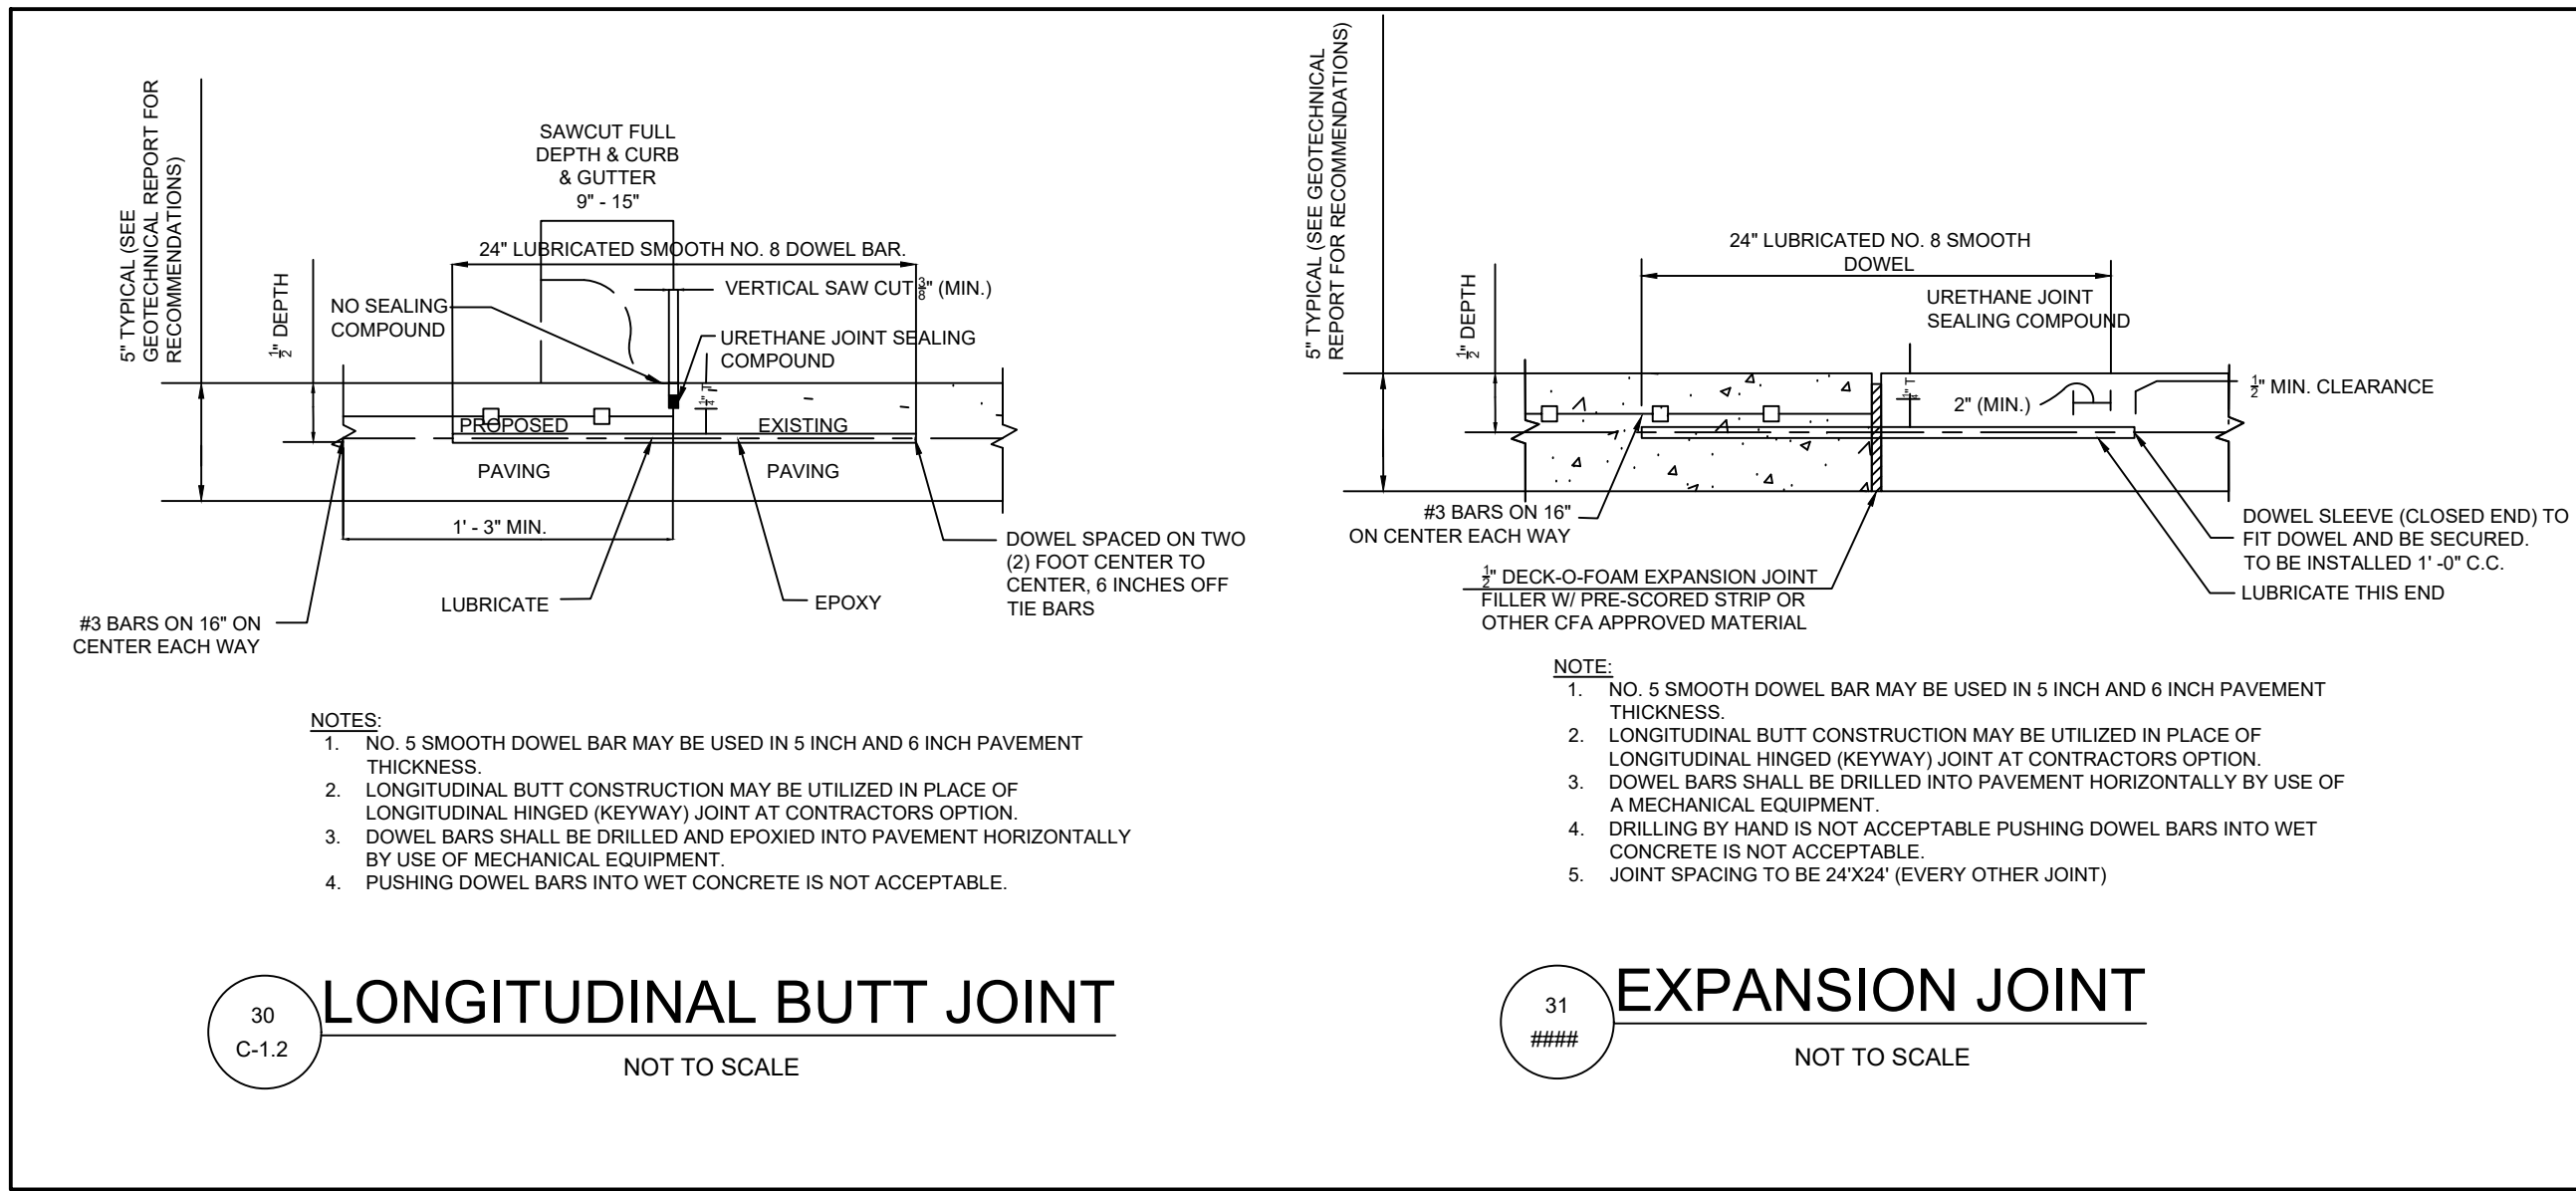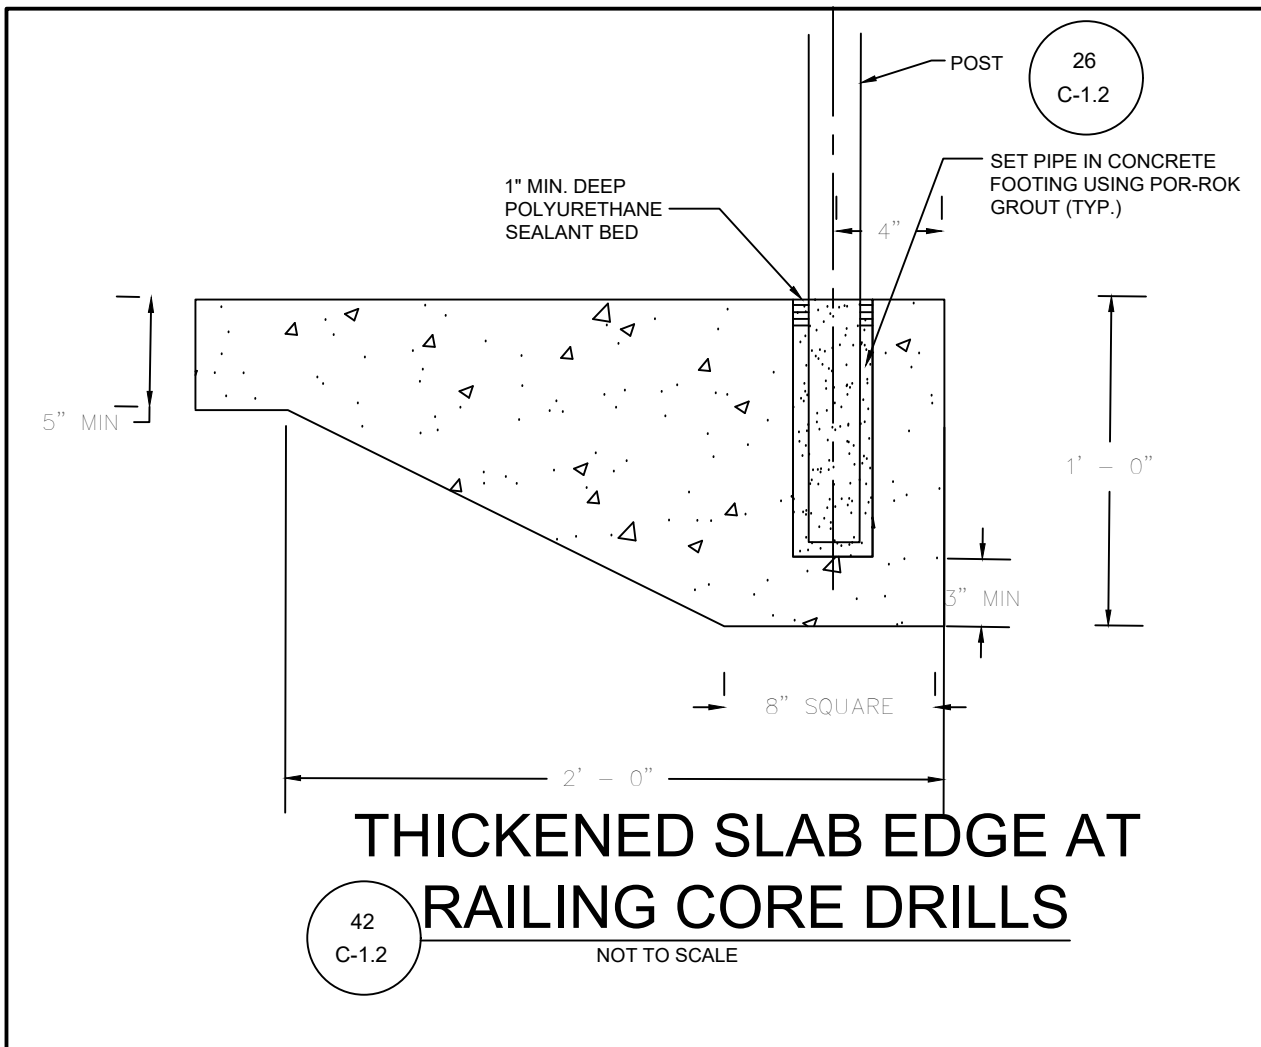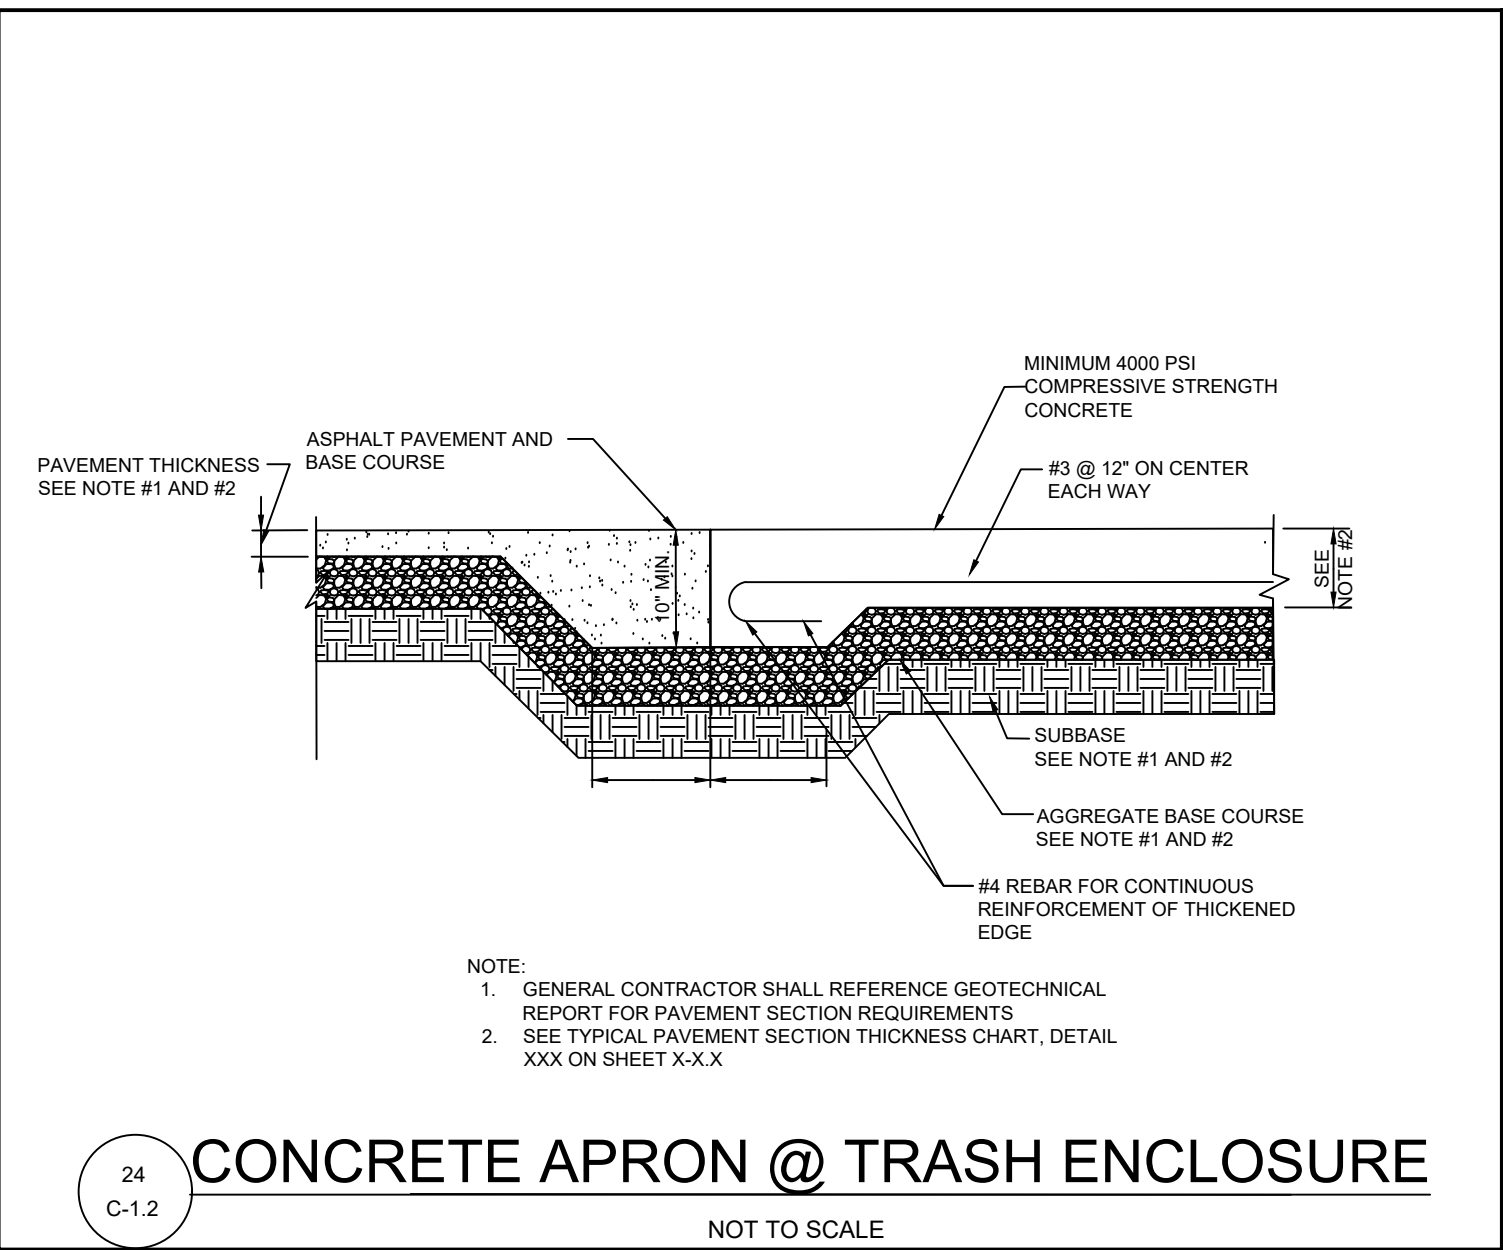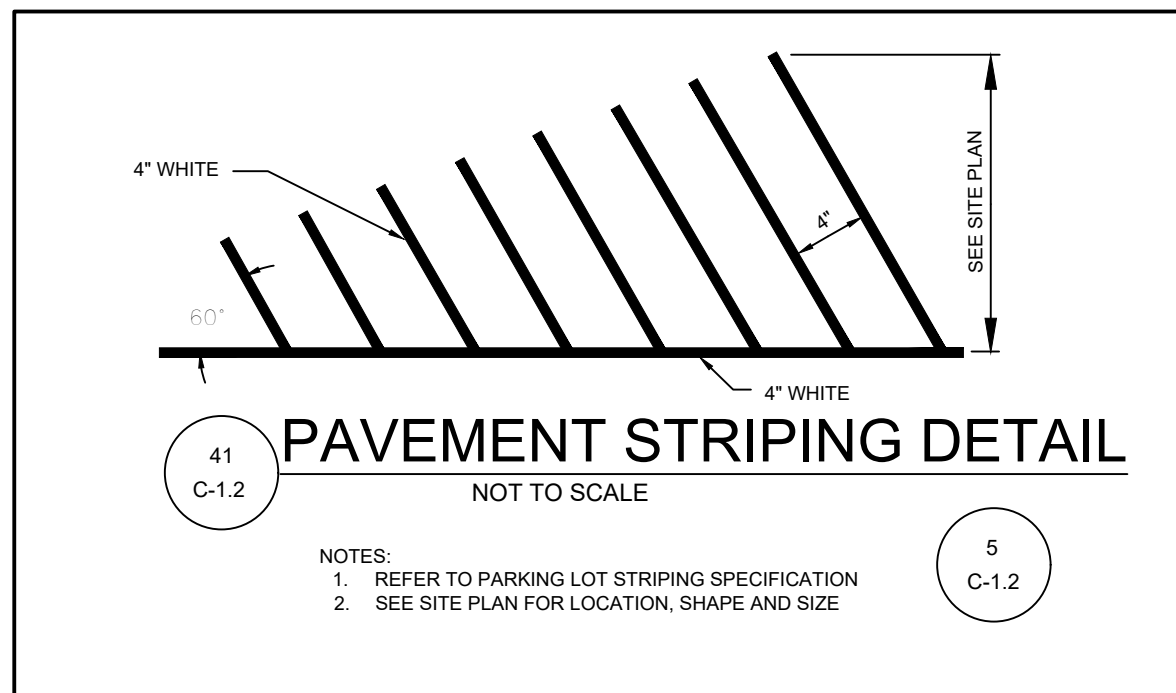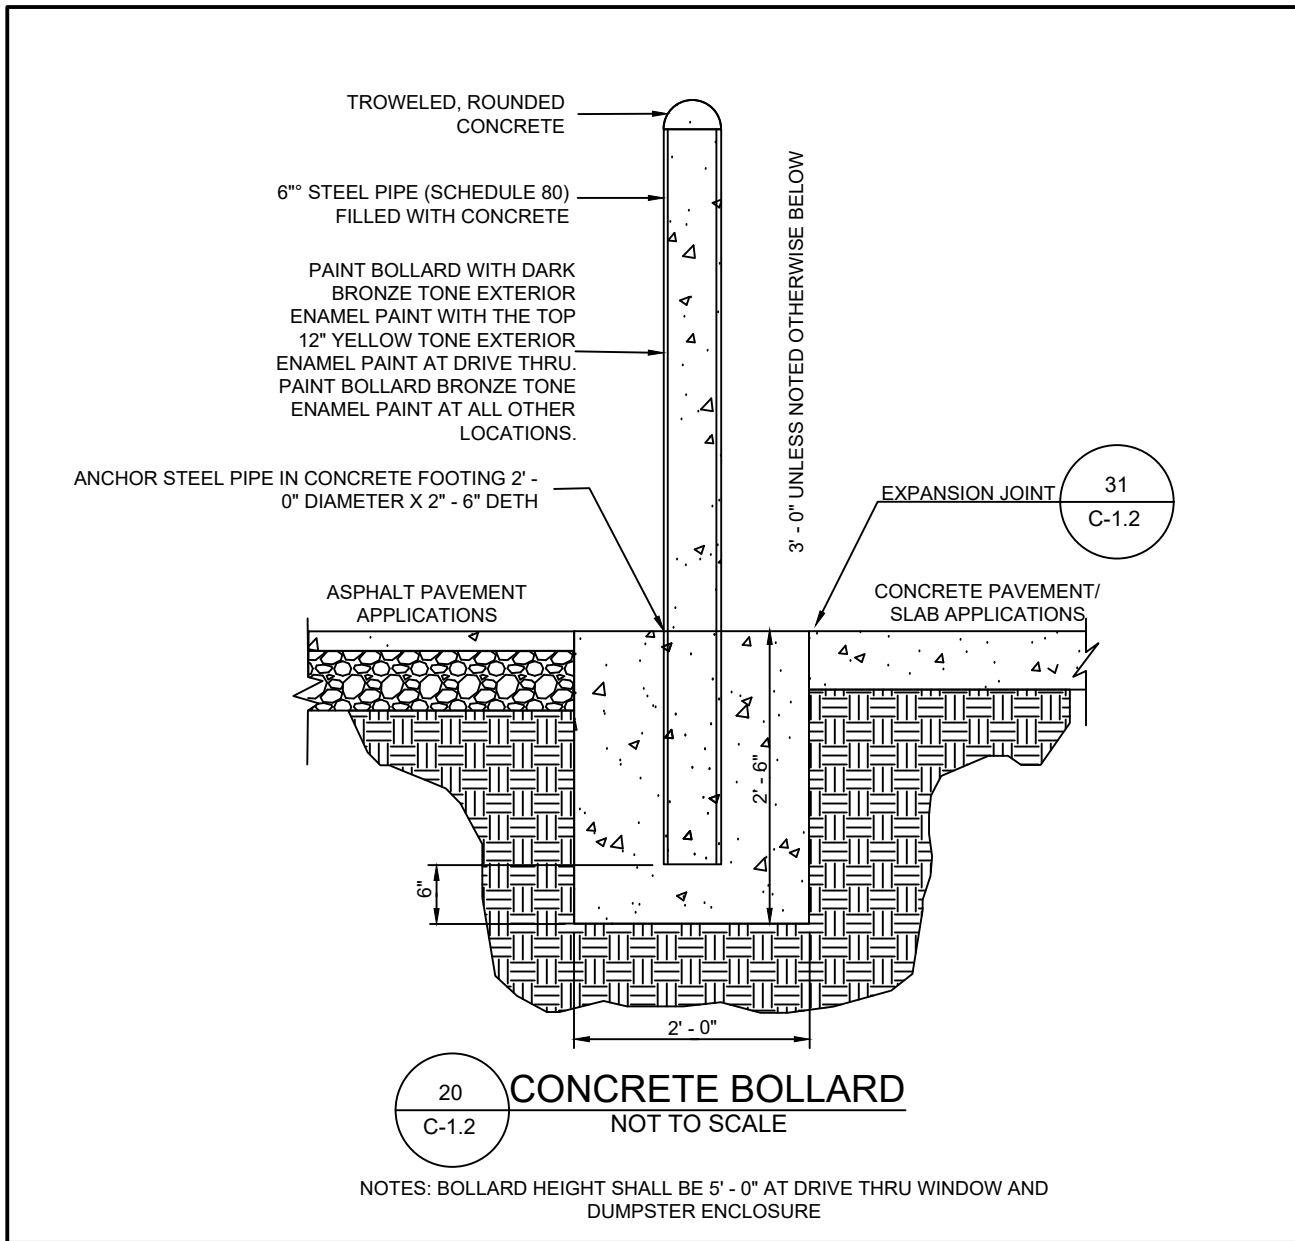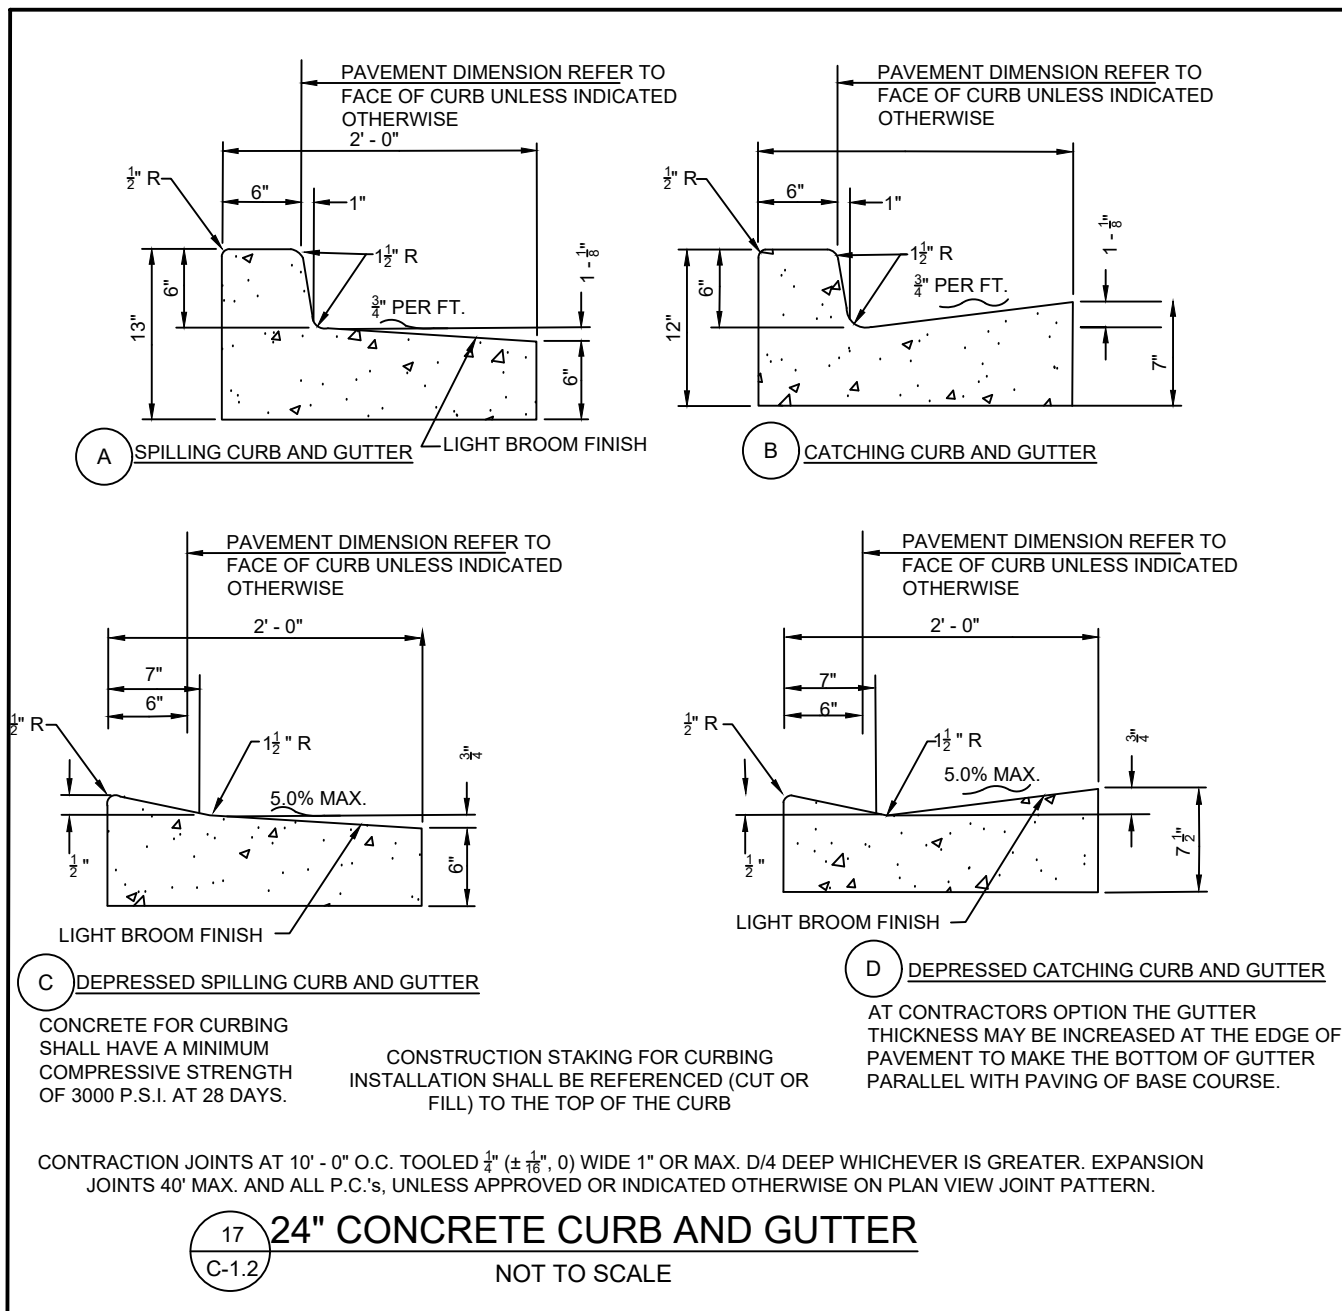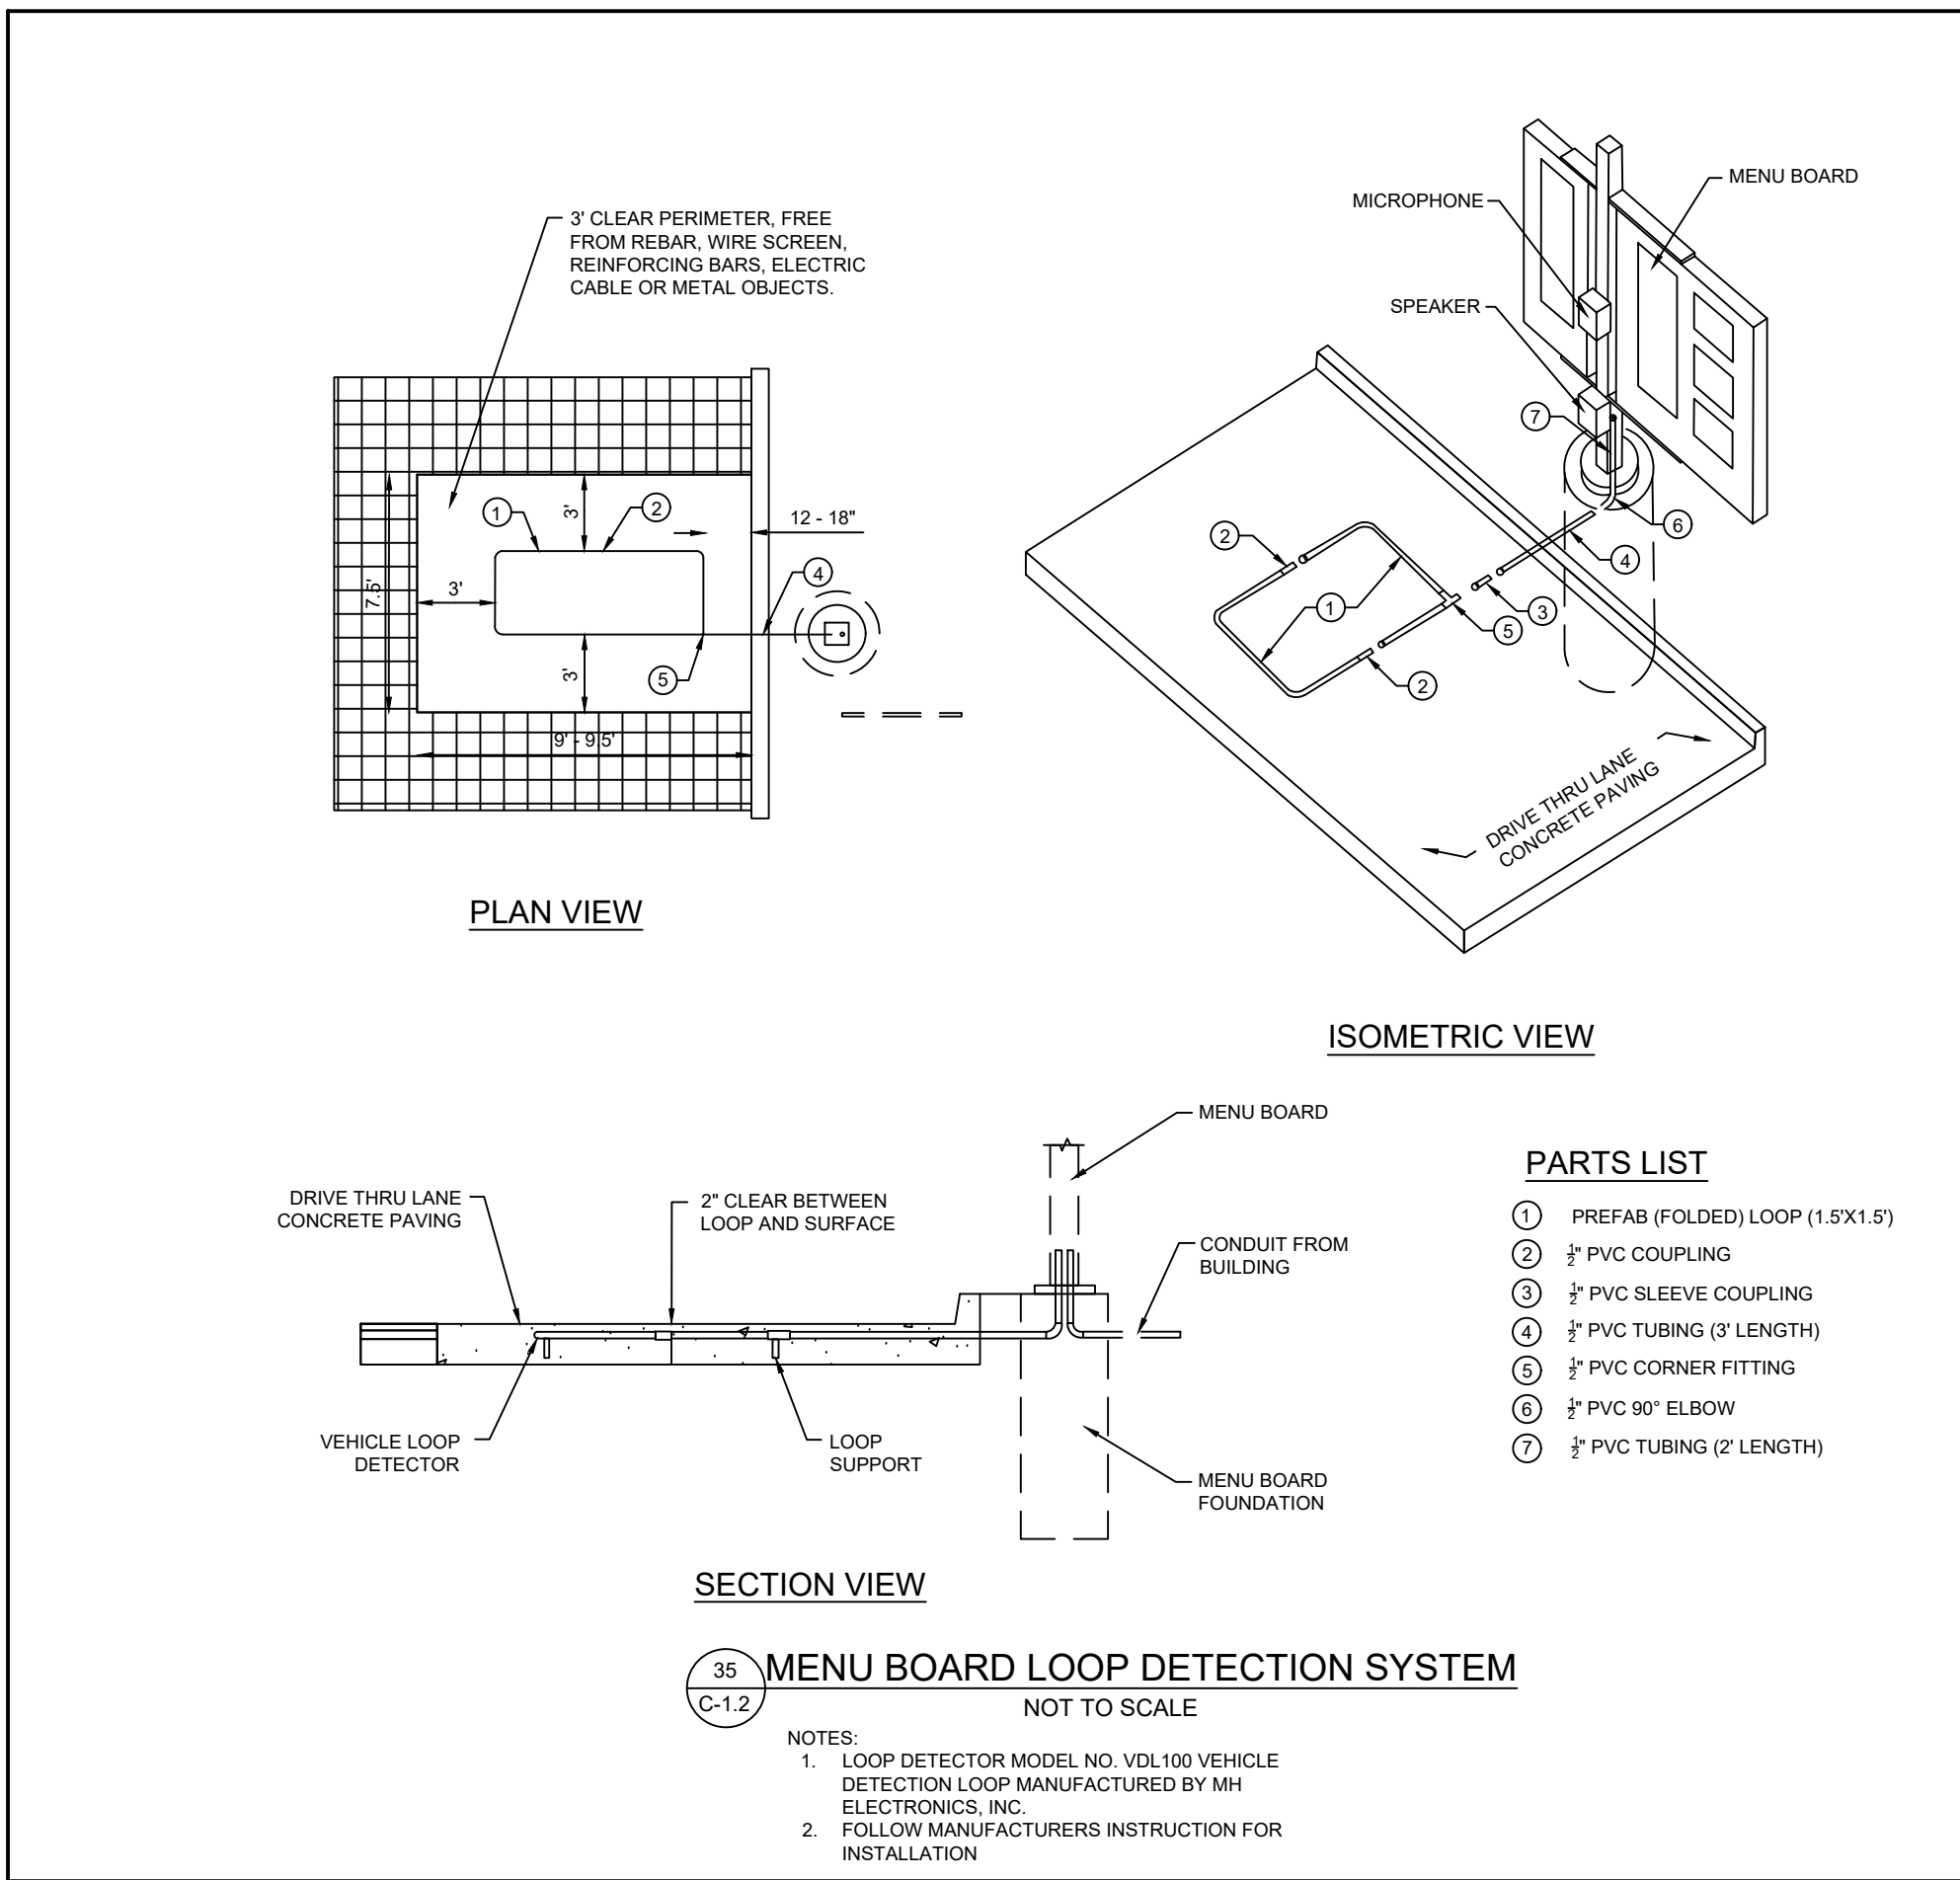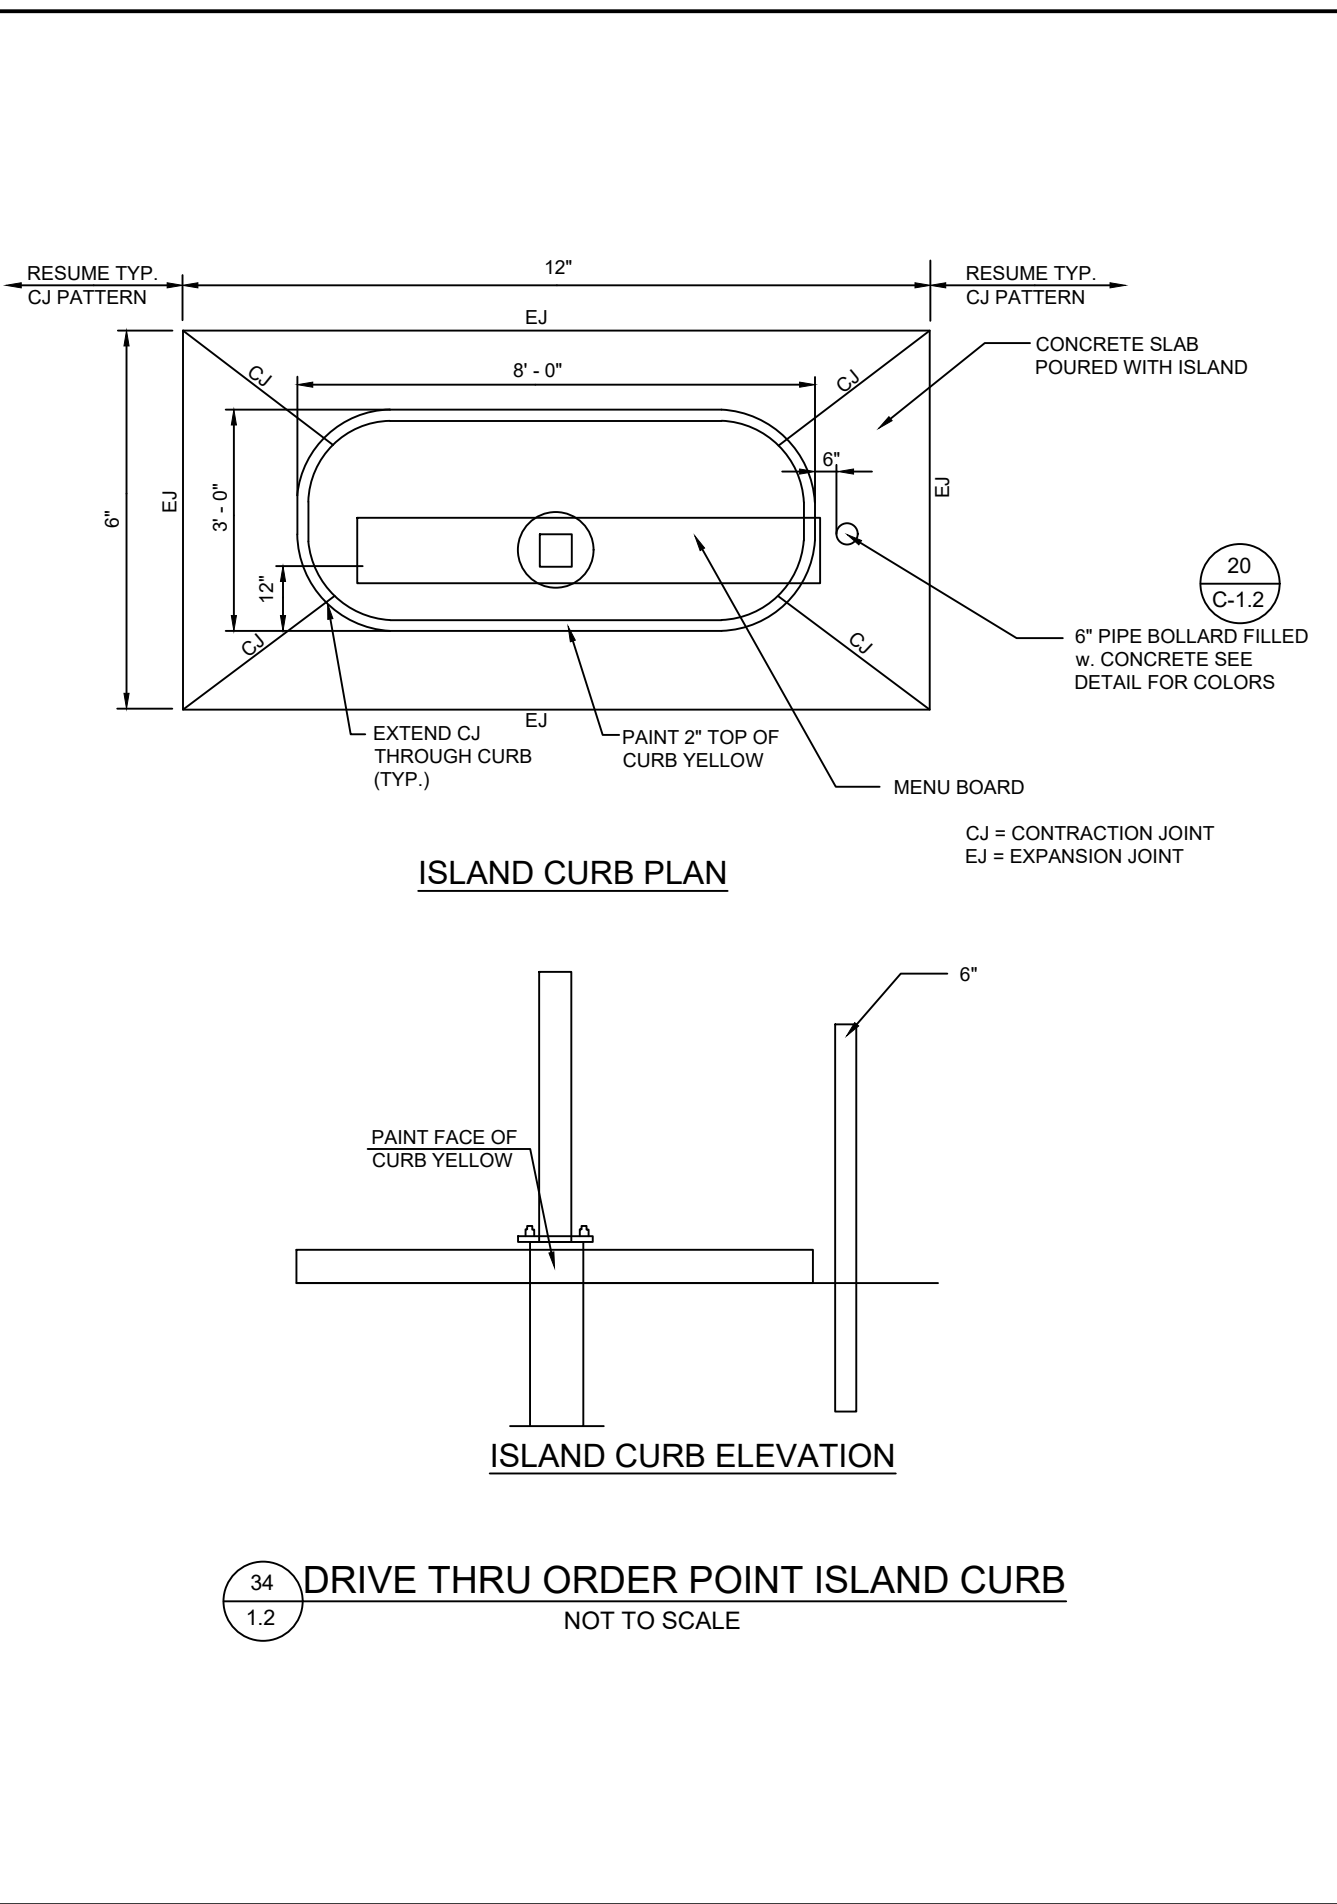

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B	06/06/2023	PCR	
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SHEET TITLE

**STANDARD  
DETAILS III**

REVISION 4-2023

Job No. : 23043CFA

Store : 05442



Date : 08/28/23

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


**C-6.2**

ISSUE FOR PERMIT



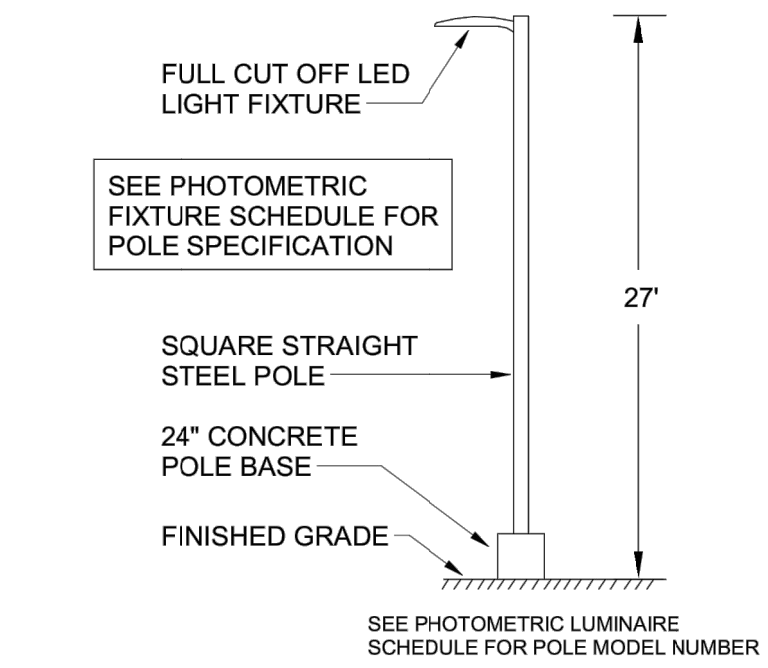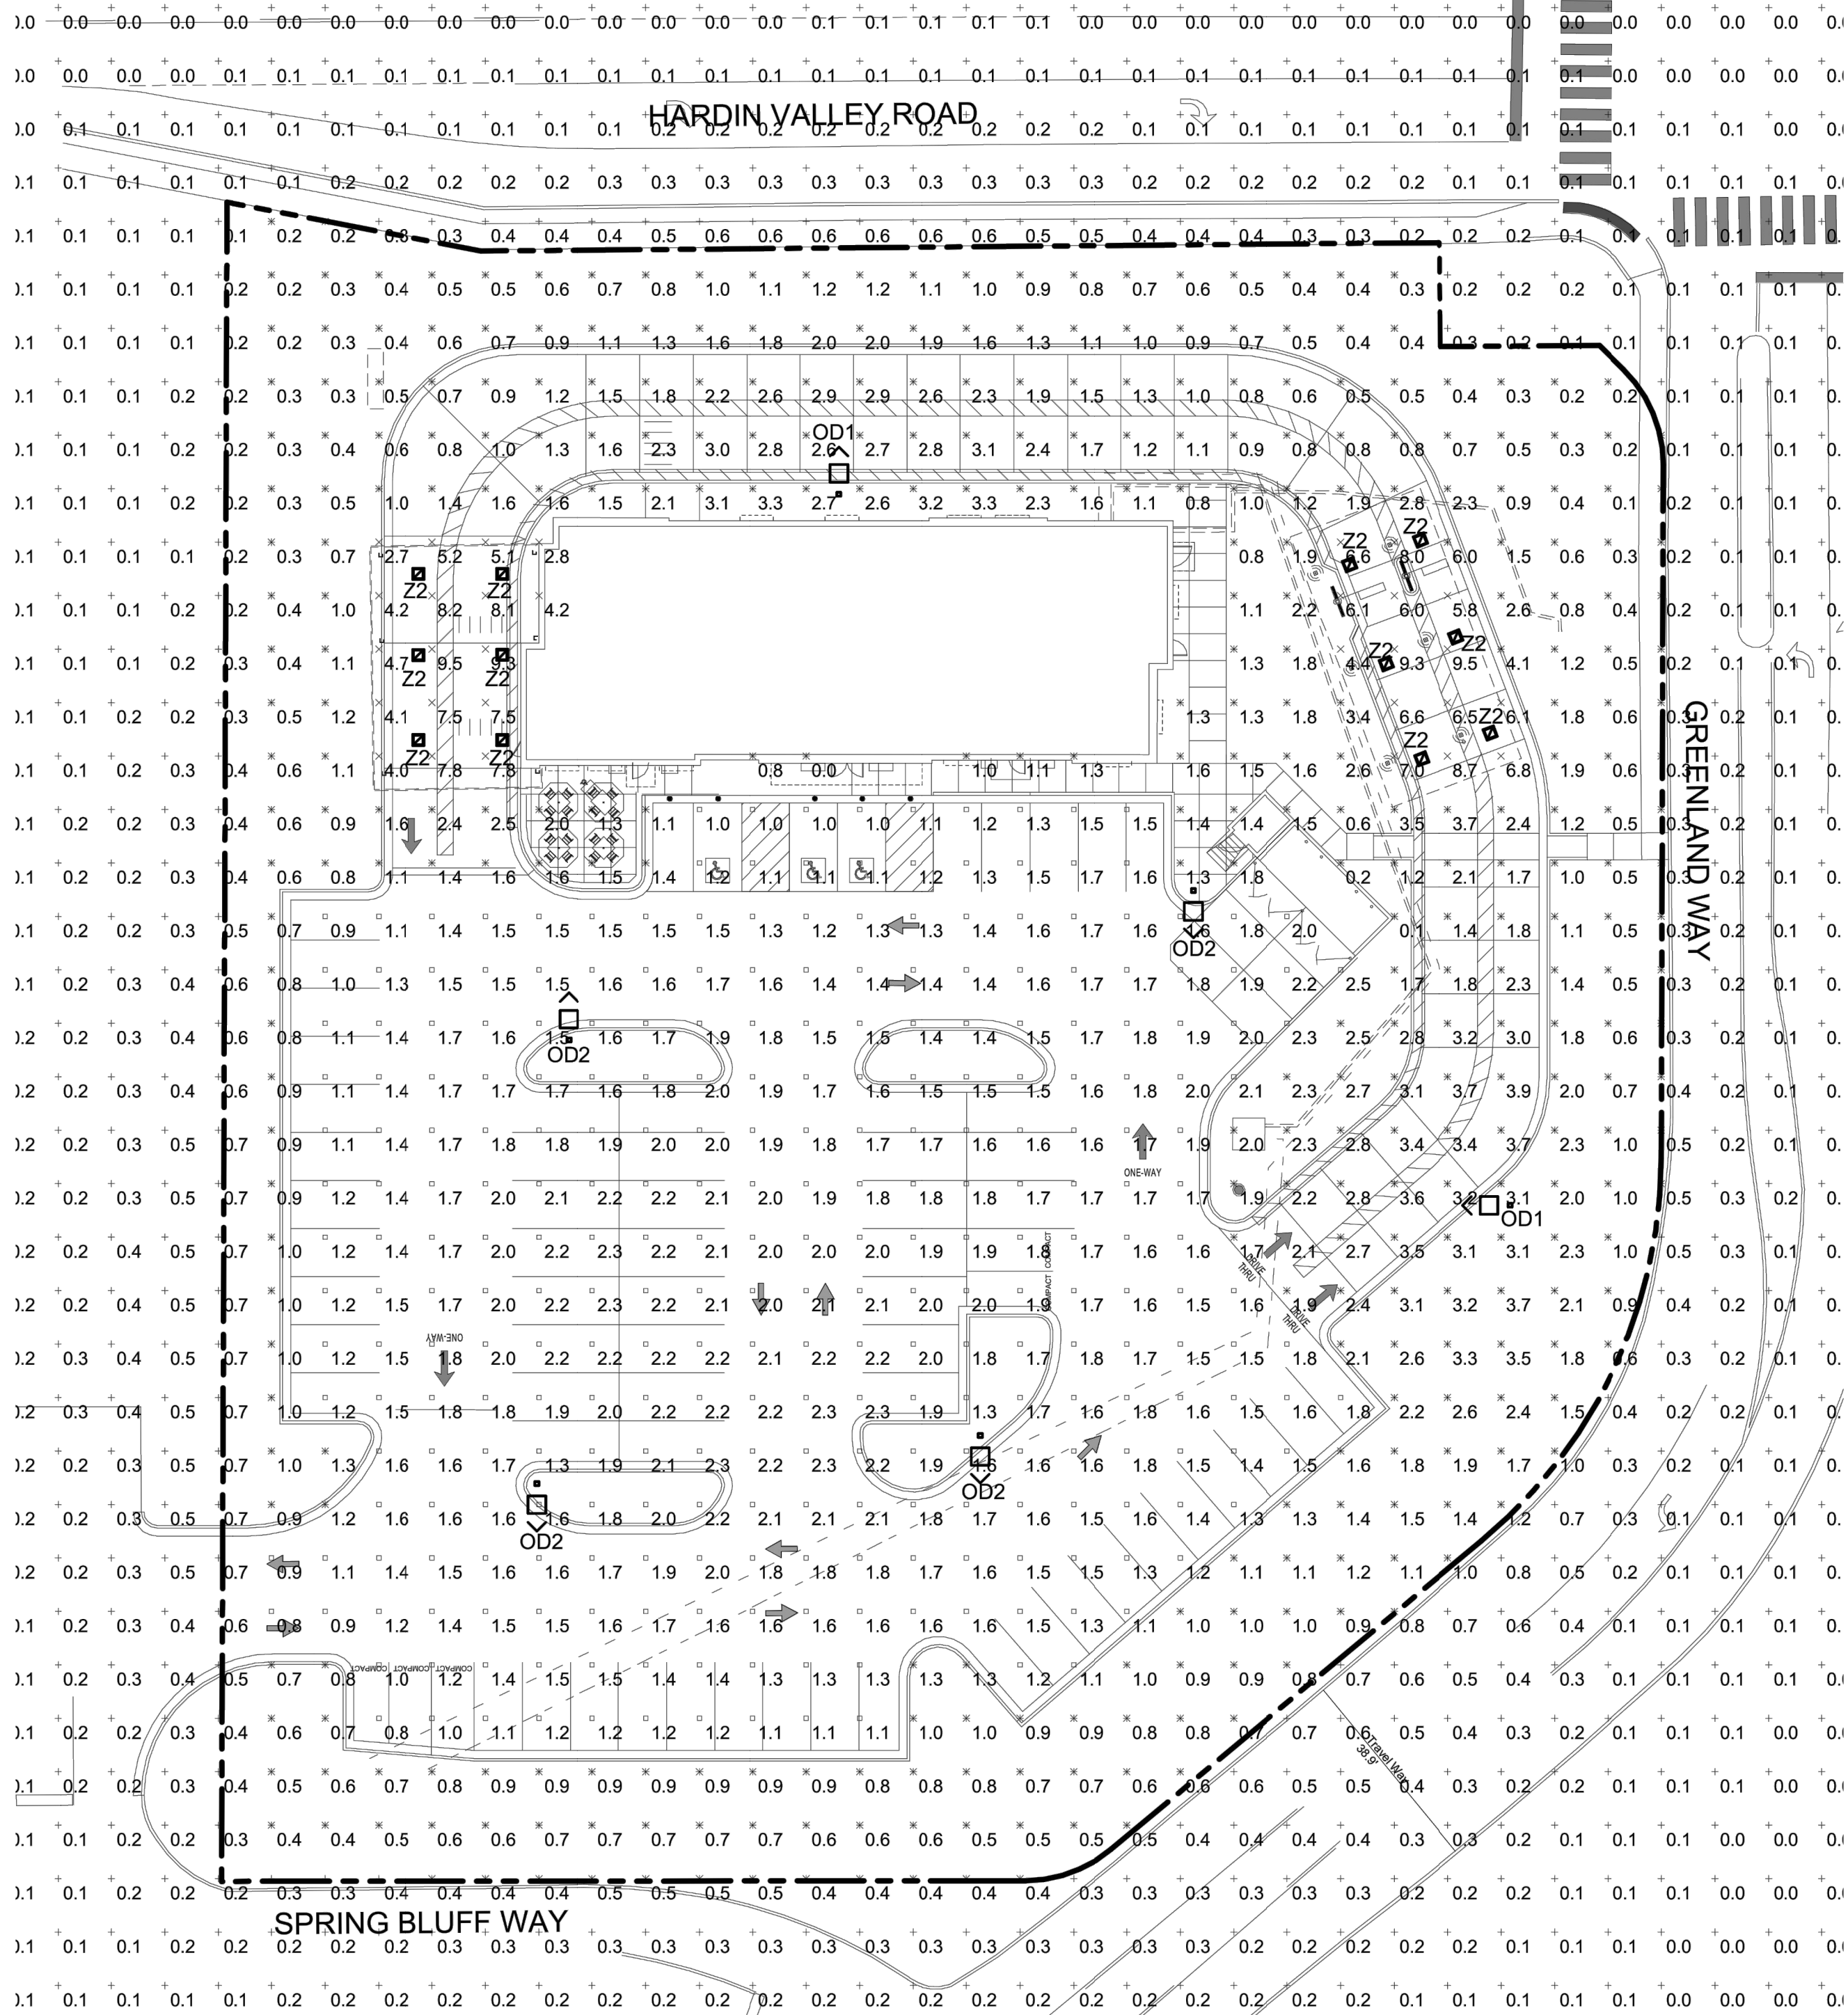

E1 AREA LIGHTING POLE DETAIL  
N.T.S.

Schedule								
Symbol	Label	Quantity	Manufacturer	Catalog Number	Number Lamps	Lumens Per Lamp	Light Loss Factor	Wattage
	OD1	2	EATON - LUMARK (FORMER COOPER LIGHTING)	PRV-C60-D-UNV-T3-BZ	2	10029	0.95	153
	OD2	4	EATON - LUMARK (FORMER COOPER LIGHTING)	PRV-C60-D-UNV-T5-BZ	2	10678	0.95	153
	Z2	12	LSI INDUSTRIES, INC	CRUS-SC-SLW-30	1	5584	0.4	38
OD POLES SHALL BE 25' SQUARE STRAIGHT STEEL POLES BY KW INDUSTRIES: SSP25-4.0-7-BRZ-DM10/2180-BC. MOUNT POLES ON A 2' CONCRETE POLE BASE. POLES AND LIGHTING FIXTURES TO HAVE A DARK BRONZE FINISH.								
NOTE: THE LIGHT LOSS FACTOR FOR FIXTURE Z2 WAS ADJUSTED TO LIMIT THE FOOT CANDLE LEVELS BELOW THE CANOPIES. A DIMMER WILL BE INSTALLED AT EACH CANOPY IN ORDER TO MAINTAIN THE REQUIRED LIGHT LEVELS. REFER TO WIRING DIAGRAMS ON SHEETS E-303 AND E-304 FOR ADDITIONAL INFO ON THE DIMMER.								


Statistics						
Description	Symbol	Avg	Max	Min	Max/Min	Avg/Min
Calc Zone	+	0.9 fc	9.5 fc	0.0 fc	N/A	N/A
CFA Lot Summary	x	1.7 fc	9.5 fc	0.0 fc	N/A	N/A
Parking Lot Summary	□	1.6 fc	2.5 fc	0.8 fc	3.1:1	2.0:1
Meal Delivery Canopy	x	6.0 fc	9.5 fc	2.7 fc	3.5:1	2.2:1
Order Canopy	x	7.0 fc	9.5 fc	4.4 fc	2.2:1	1.6:1

A1 PHOTOMETRIC PLAN  
1" = 20'-0"



Chick-fil-A

Chick-fil-A  
5200 Buffington Road  
Atlanta, Georgia  
30349-2998

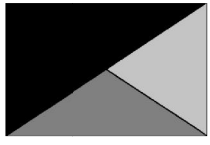

Kurzynske  
& Associates  
2705 Lebanon Pike - Suite One  
Nashville, Tennessee 37214  
Telephone: (615) 255-5203



CHICK-FIL-A  
HARDIN VALLEY FSU

2187 Greenland Way  
Knoxville, TN 37932

FSR#05442

BUILDING TYPE / SIZE: P14 LE  
RELEASE: 23.02


PERMIT

REVISION SCHEDULE  
NO. DATE DESCRIPTION

CONSULTANT PROJECT # 23124.EH.S  
DATE 08/23/2023  
DRAWN BY SM  
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SHEET  
SITE PHOTOMETRIC PLAN  
SHEET NUMBER

E-102



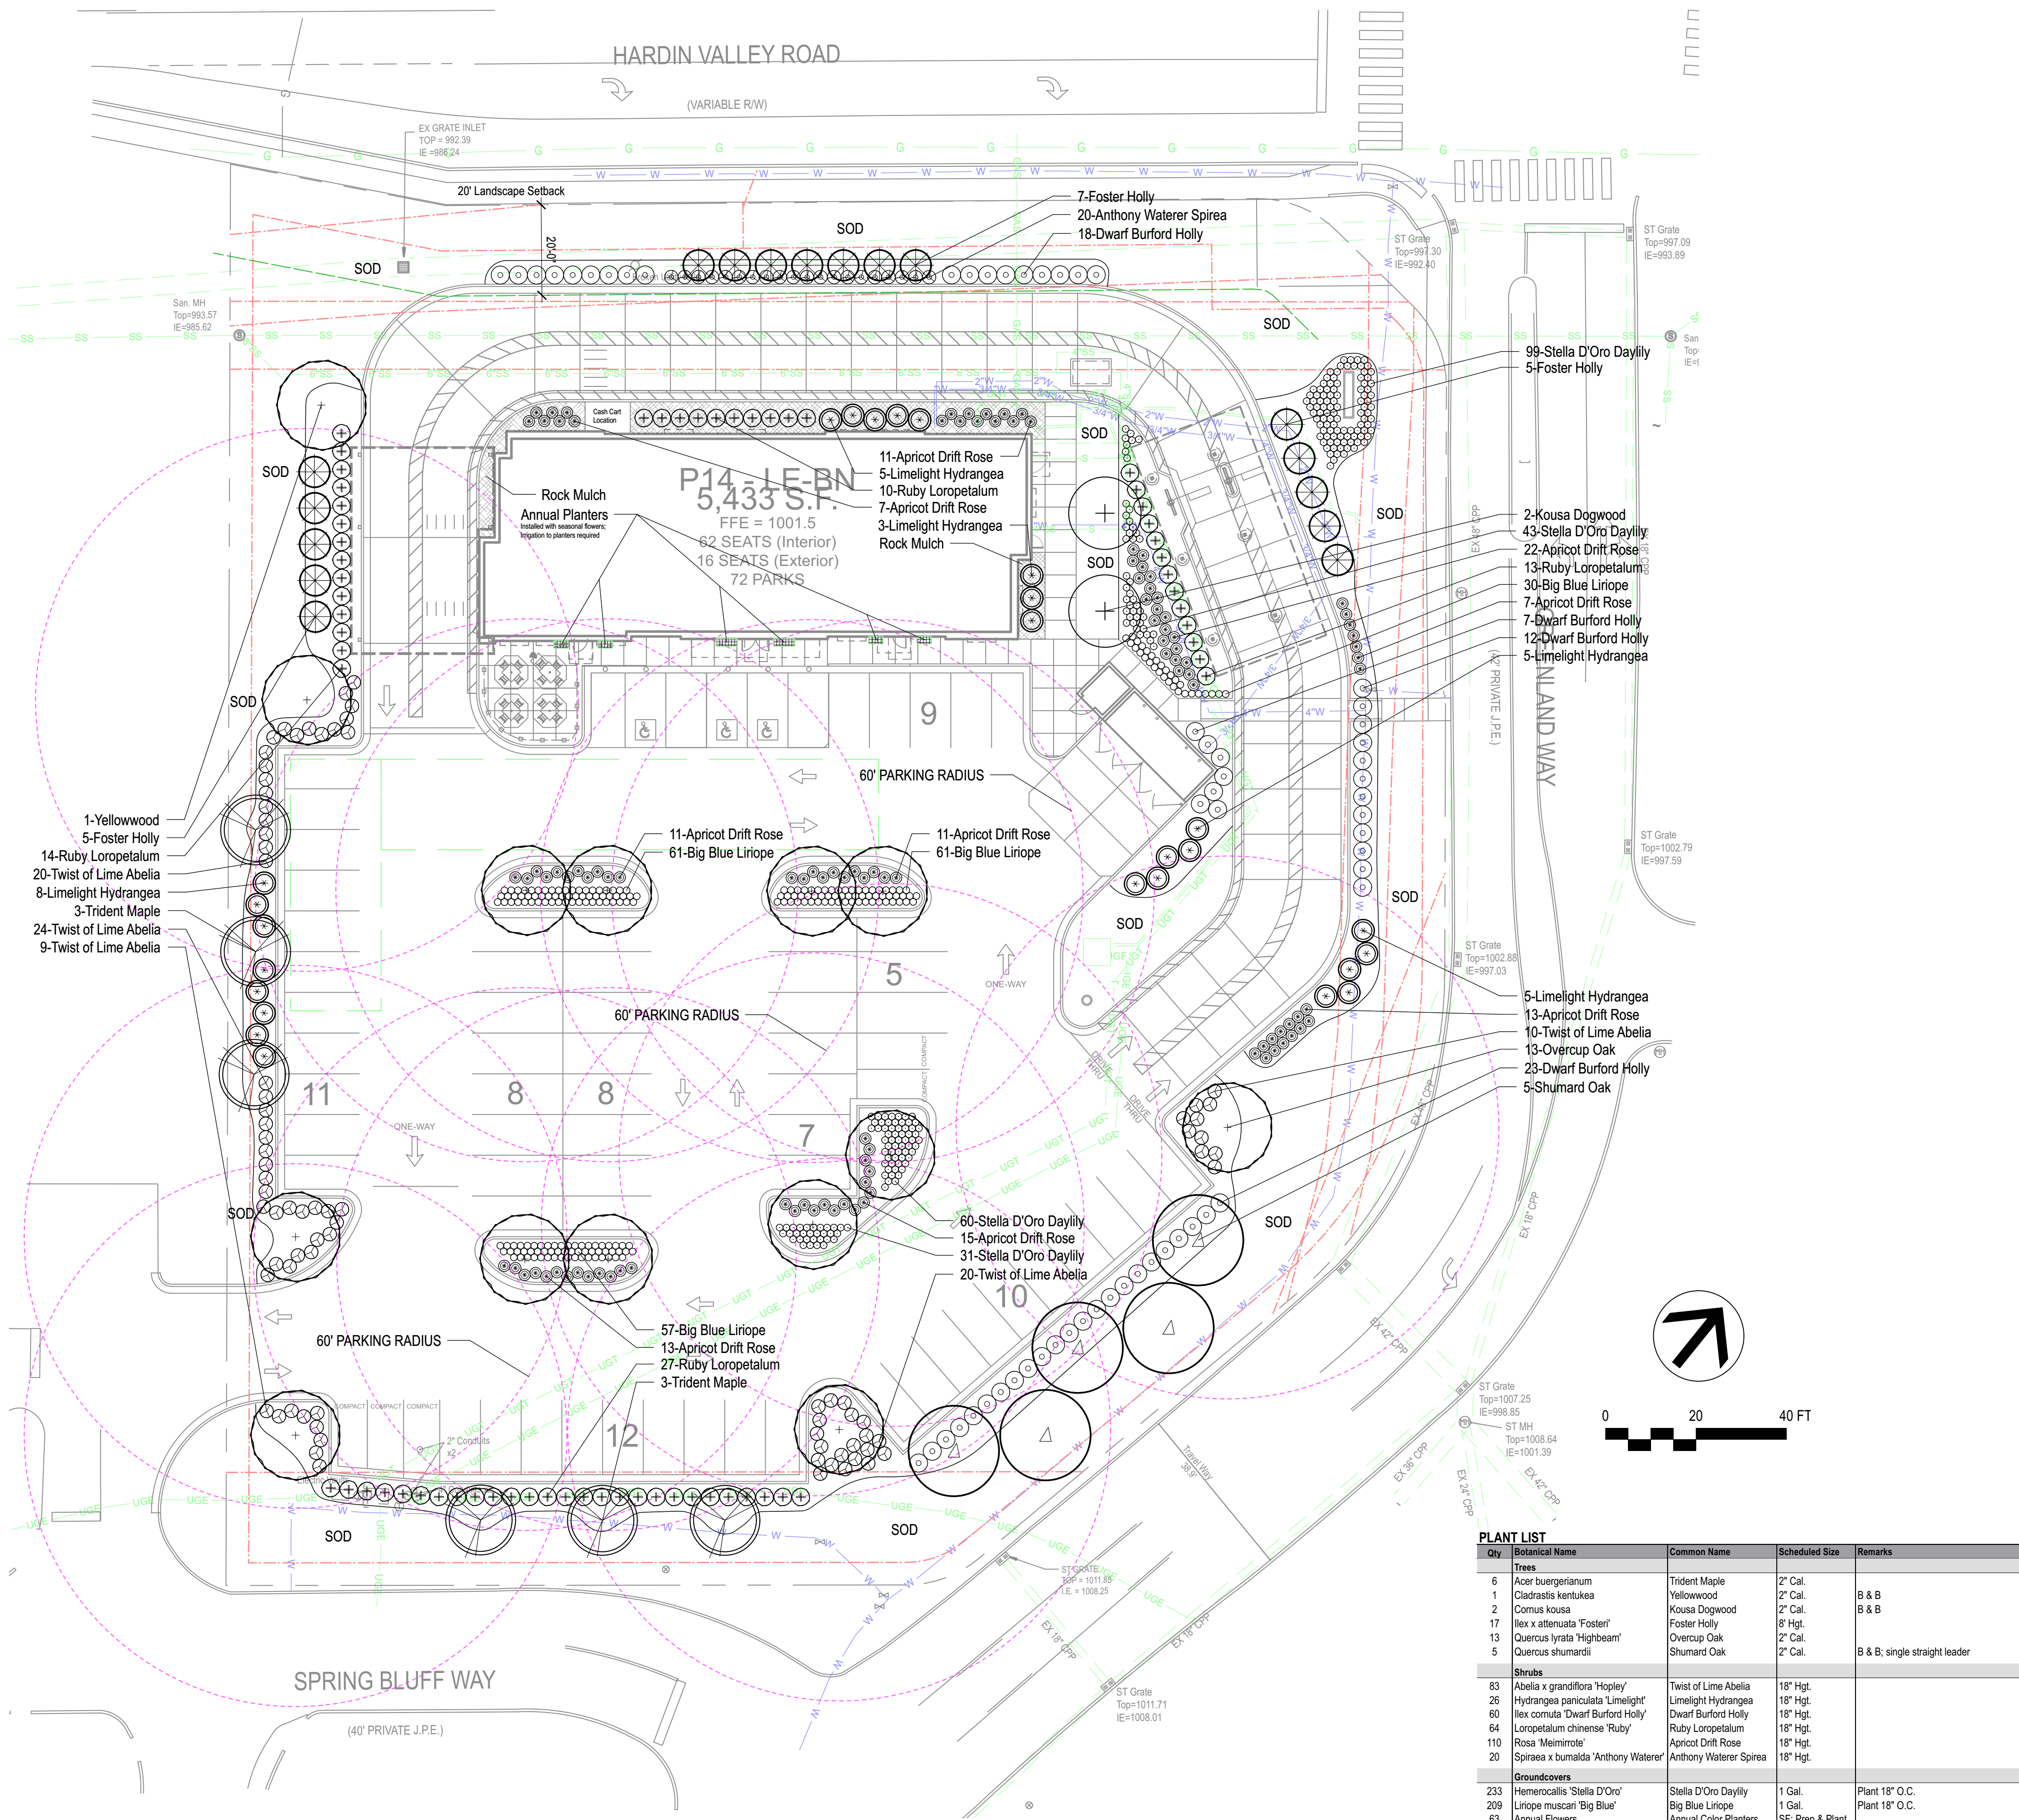

# LANDSCAPE REQUIREMENTS

## A. GENERAL DIVERSITY

REQUIRED		
1. Evergreen trees min. 8' hgt.; Shade trees min. 2" cal.; Single stem ornamental min. 2.5" cal.; multistem ornamental min. 8' hgt. All shrubs min. 18" hgt.		
2. Species diversity required per Table 12-1: Plant Diversity Requirements		
3. Min. 25% new trees must be evergreen.		
4. Provide a roughly equal combination of large, medium, and small trees (utilize Appendix B). Min. 10 large trees per acre of yard space. 10 x 1.75 acres	=	18 large trees required
5. Min. 20' required landscape front yard for building w/ no parking in front. (Hardin Valley Rd.)		
6. Max. GAC (ground area coverage) 25%. Building Footprint Area/Gross Lot Area	<	Less than 25% required
PROVIDED		
1. We meet requirement - See Plant List table.		
2. 42 Total Trees: Max. 40% 1 species - (no more than qty 17)	=	17 Foster Holly provided
5 tree species provided		
331 Total Shrubs: Max 25% 1 species - (no more than qty 83)	=	83 Abelia provided
6 shrub species provided		
3. 17 evergreen trees/42 total trees	=	40% provided
4. 13 Overcup Oak, 5 Shumard Oak	=	18 large trees provided
5. 20' landscape setback noted on plan along Hardin Valley Rd.		
6. 5,433 SF/76,244 SF	=	7% provided

## B. PARKING LOT PERIMETER LANDSCAPE

REQUIRED		
1. Min. 3 shade and/or evergreen trees and 10 shrubs per 100 LF perimeter yard. Min. 50% shrubs must be evergreen.		
Hardin Valley Rd = No Parking frontage		
Greenland Way = 120 LF/100'3	=	4 trees required
Greenland Way = 120 LF/100'10	=	12 shrubs required
Spring Bluff Way = 114 LF/100'10	=	3 trees required
Spring Bluff Way = 114 LF/100'10	=	11 shrubs required
Perimeter A = 96 LF/100'3	=	3 trees required
Perimeter A = 96 LF/100'10	=	10 shrubs required
2. Min. 60% of landscape area outside of shrub & tree masses must be groundcover, perennials, grass.		
3. Parking areas required to be screened from public ROW by landscaped berms and/or low level shrubbery.		
PROVIDED		
1. Hardin Valley Rd = No Parking frontage		
Greenland Way = Shumard Oak	=	5 trees
Greenland Way = Burford Holly (evergreen)	=	23 shrubs
Spring Bluff Way = Trident Maple	=	3 trees
Spring Bluff Way = Loropetalum (evergreen)	=	27 shrubs
Perimeter A = Trident Maple	=	3 trees
Perimeter A = Abelia (evergreen)	=	18 shrubs
2. We exceed the requirement. More than 60% other area is living landscape.		
3. All parking areas screened with appropriate evergreen plant material.		

## C. INTERIOR PARKING LOT LANDSCAPE

REQUIRED		
1. Min. 1 medium or large shade tree per parking island (2 shade trees for double row parking lot islands). Per parking rows/islands provided	=	13 trees required
Min. 1 medium or large canopy tree per 10 parking spaces provided.		
72 Parking spaces/10	=	7 trees required
2. Min. 60% of islands planted w/ shrubs, groundcover, perennials, or grass.		
3. No parking space to be located >60' from the trunk of a large canopy tree.		
4. In addition to required canopy trees, planting areas for ornamental trees, shrubbery and bedding plants shall be min. 5% of the surface area devoted to parking.		
26,750 SF parking lot area & 2,780 landscape interior islands	=	Min. 5% required
PROVIDED		
1. Overcup Oaks (meeting greater of requirements)	=	13 trees provided
2. We exceed the requirement. All islands planted with shrubs and/or groundcovers.		
3. We meet the requirement - See 60' parking radius circles shown on plan.		
4. 10% (of surface parking area) devoted to landscape planting areas.	=	10% provided

## D. BUILDING LANDSCAPE

REQUIRED		
1. Areas around buildings equal to 50% of the area of each front and side elevation shall be planted with ornamental trees, shrubbery and bedding plants.		
Building Height: 20.5 FT		
Front: 119 LF x 20.5 FT	=	2,439.5 SF
R Side: 44 LF x 20.5 FT	=	902 SF
L Side: 45 LF x 20.5 FT	=	922.5 SF
TOTAL SF	=	4,264 SF
4,264 x 50%	=	2,132 SF bldg LS required
2. Landscape required around base of the freestanding sign.		
PROVIDED		
1. Planting beds adjacent to/abutting building	=	2,311 SF bldg LS provided
2. Landscaping provided (Daylilies and shrubs adjacent) around sign.		

## ATLANTIC LANDSCAPE NOTES

- Landscape Contractor to read and understand the Landscape Specifications prior to finalizing bids. The Landscape Specifications shall be adhered to throughout the construction process.
- Contractor is responsible for locating and protecting all underground utilities prior to digging.
- Contractor is responsible for protecting existing trees from damage during construction.
- All tree protection devices to be installed prior to the start of land disturbance, and maintained until final landscaping.
- All tree protection areas to be protected from sedimentation.
- All tree protection fencing to be inspected daily, and repaired or replaced as needed.
- No parking, storage or other construction activities are to occur within tree protection areas.
- All planting areas shall be cleaned of construction debris (ie. concrete, rock, rubble, building materials, etc) prior to adding and spreading of the topsoil.
- General Contractor is responsible for adding a min of 4" clean friable topsoil in all planting beds and all grassed areas. Graded areas to be held down the appropriate elevation to account for topsoil depth. See Landscape Specifications for required topsoil characteristics.
- In all parking lot islands, the General Contractor is responsible to remove all debris, fracture/loosen subgrade to a min. 24" depth. Add topsoil to a 6"-8" berm height above island curbing; refer to landscape specifications and landscape island detail.
- Prior to beginning work, the Landscape Contractor shall inspect the subgrade, general site conditions, verify elevations, utility locations, irrigation, approve topsoil provided by the General Contractor and observe the site conditions under which the work is to be done. Notify the General Contractor of any unsatisfactory conditions, work shall not proceed until such conditions have been corrected and are acceptable to the Landscape Contractor.
- Any deviations from the approved set of plans are to be approved by the Landscape Architect.
- Landscaping shall be installed in conformance with ANSI Z60.1 the "American Standard for Nursery Stock" and the accepted standards of the American Association of Nurserymen.
- Existing grass in proposed planting areas shall be killed and removed. Hand rake to remove all rocks and debris larger than 1 inch in diameter, prior to adding topsoil and planting shrubs.
- Soil to be tested to determine fertilizer and lime requirements prior to laying sod.
- Annual and perennial beds: add min. 4 inch layer of organic material and till to a min. depth of 12 inches. Mulch annual and perennial beds with 2-3 inch depth of mini nuggets.
- All shrubs beds (existing and new) to be mulched with a min. 3 inch layer of mulch (mulch type to be: double shredded hardwood mulch).
- Planting holes to be dug a minimum of twice the width of the root ball, for both shrub and tree. Set plant material 2-3" above finish grade. Backfill planting pit with topsoil and native excavated soil.
- Sod to be delivered fresh (Cut less than 24 hours prior to arriving on site), laid immediately, rolled, and watered thoroughly immediately after planting. Edge of sod at planting beds are to be "V" trenched; see Landscape Details.
- Any existing grass disturbed during construction to be fully removed, regraded and replaced. All tire marks and indentations to be repaired.
- Water thoroughly twice in first 24 hours and apply mulch immediately.
- The Landscape Contractor shall guarantee all plants installed for one full year from date of acceptance by the owner. All plants shall be alive and at a vigorous rate of growth at the end of the guarantee period. The Landscape Contractor shall not be responsible for acts of God or vandalism. See Landscape Specifications for Warranty requirements/expectations.
- Any plant that is determined dead, in an unhealthy, unsightly condition, lost its shape due to dead branches, or other symptoms of poor, non-vigorous growth, shall be replaced by the Landscape Contractor. See Landscape Specifications for warranty requirements/expectations.
- Site to be 100% irrigated in all planting beds and grass area by an automatic underground Irrigation System. Irrigation as-built shall be provided to the Landscape Architect within 24 hours of irrigation install completion.
- Stake all evergreen and deciduous trees as shown in the planting detail and as per the Landscape Specifications.
- Remove stakes and guying from all trees after one year from planting.

## PLANT LIST


Qty	Botanical Name	Common Name	Scheduled Size	Remarks
<b>Trees</b>				
6	Acer buergerianum	Trident Maple	2" Cal.	
1	Ciadrasis kentukea	Yellowwood	2" Cal.	B & B
2	Cornus kousa	Kousa Dogwood	2" Cal.	B & B
17	Ilex x attenuata 'Foster'	Foster Holly	8" Hgt.	
13	Quercus lyrata 'Highbeam'	Overcup Oak	2" Cal.	
5	Quercus shumardii	Shumard Oak	2" Cal.	B & B; single straight leader
<b>Shrubs</b>				
83	Abelia x grandiflora 'Hopley'	Twist of Lime Abelia	18" Hgt.	
26	Hydrangea paniculata 'Limelight'	Limelight Hydrangea	18" Hgt.	
60	Ilex cornuta 'Dwarf Burford Holly'	Dwarf Burford Holly	18" Hgt.	
64	Loropetalum chinense 'Ruby'	Ruby Loropetalum	18" Hgt.	
110	Rosa 'Meimurde'	Apricot Drift Rose	18" Hgt.	
20	Spiraea x bumalda 'Anthony Waterer'	Anthony Waterer Spirea	18" Hgt.	
<b>Groundcovers</b>				
233	Hemerocallis 'Stella D'Oro'	Stella D'Oro Daylily	1 Gal.	Plant 18" O.C.
209	Liriope muscari 'Big Blue'	Big Blue Liriope	1 Gal.	Plant 18" O.C.
63	Annual Flowers	Annual Color Planters	5F; Prep & Plant	Selections to be made by contractor and based on seasonal availability. Irrigation for planters required.
<b>Other</b>				
930	Rock Mulch	Rock Mulch	SF.	See Specifications



Chick-fil-A  
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Atlanta, Georgia 30349-2998



Manley Land Design, Inc.  
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CHICK-FIL-A  
HARDIN VALLEY  
2187 GREENLAND WAY  
KNOXVILLE, TN 37932

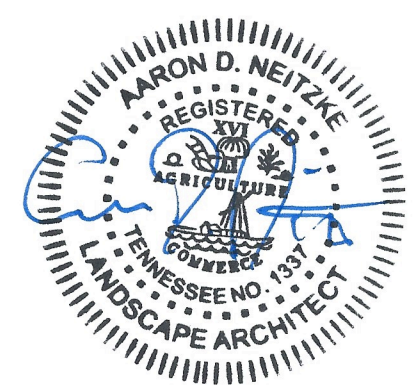FSU# 05442

REVISION SCHEDULE
NO. DATE BY DESCRIPTION
1 8/25/23 DO City Comments

MLD PROJECT #	2023173
PRINTED FOR	PERMIT
DATE	7/6/23
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SHEET

PERMIT Landscape Plan  
TTCTDA & Development Plan File #s:  
9-B-23-TOB / 9-C-23-DP


SHEET NUMBER

L-100




Know what's below.  
Call before you dig.




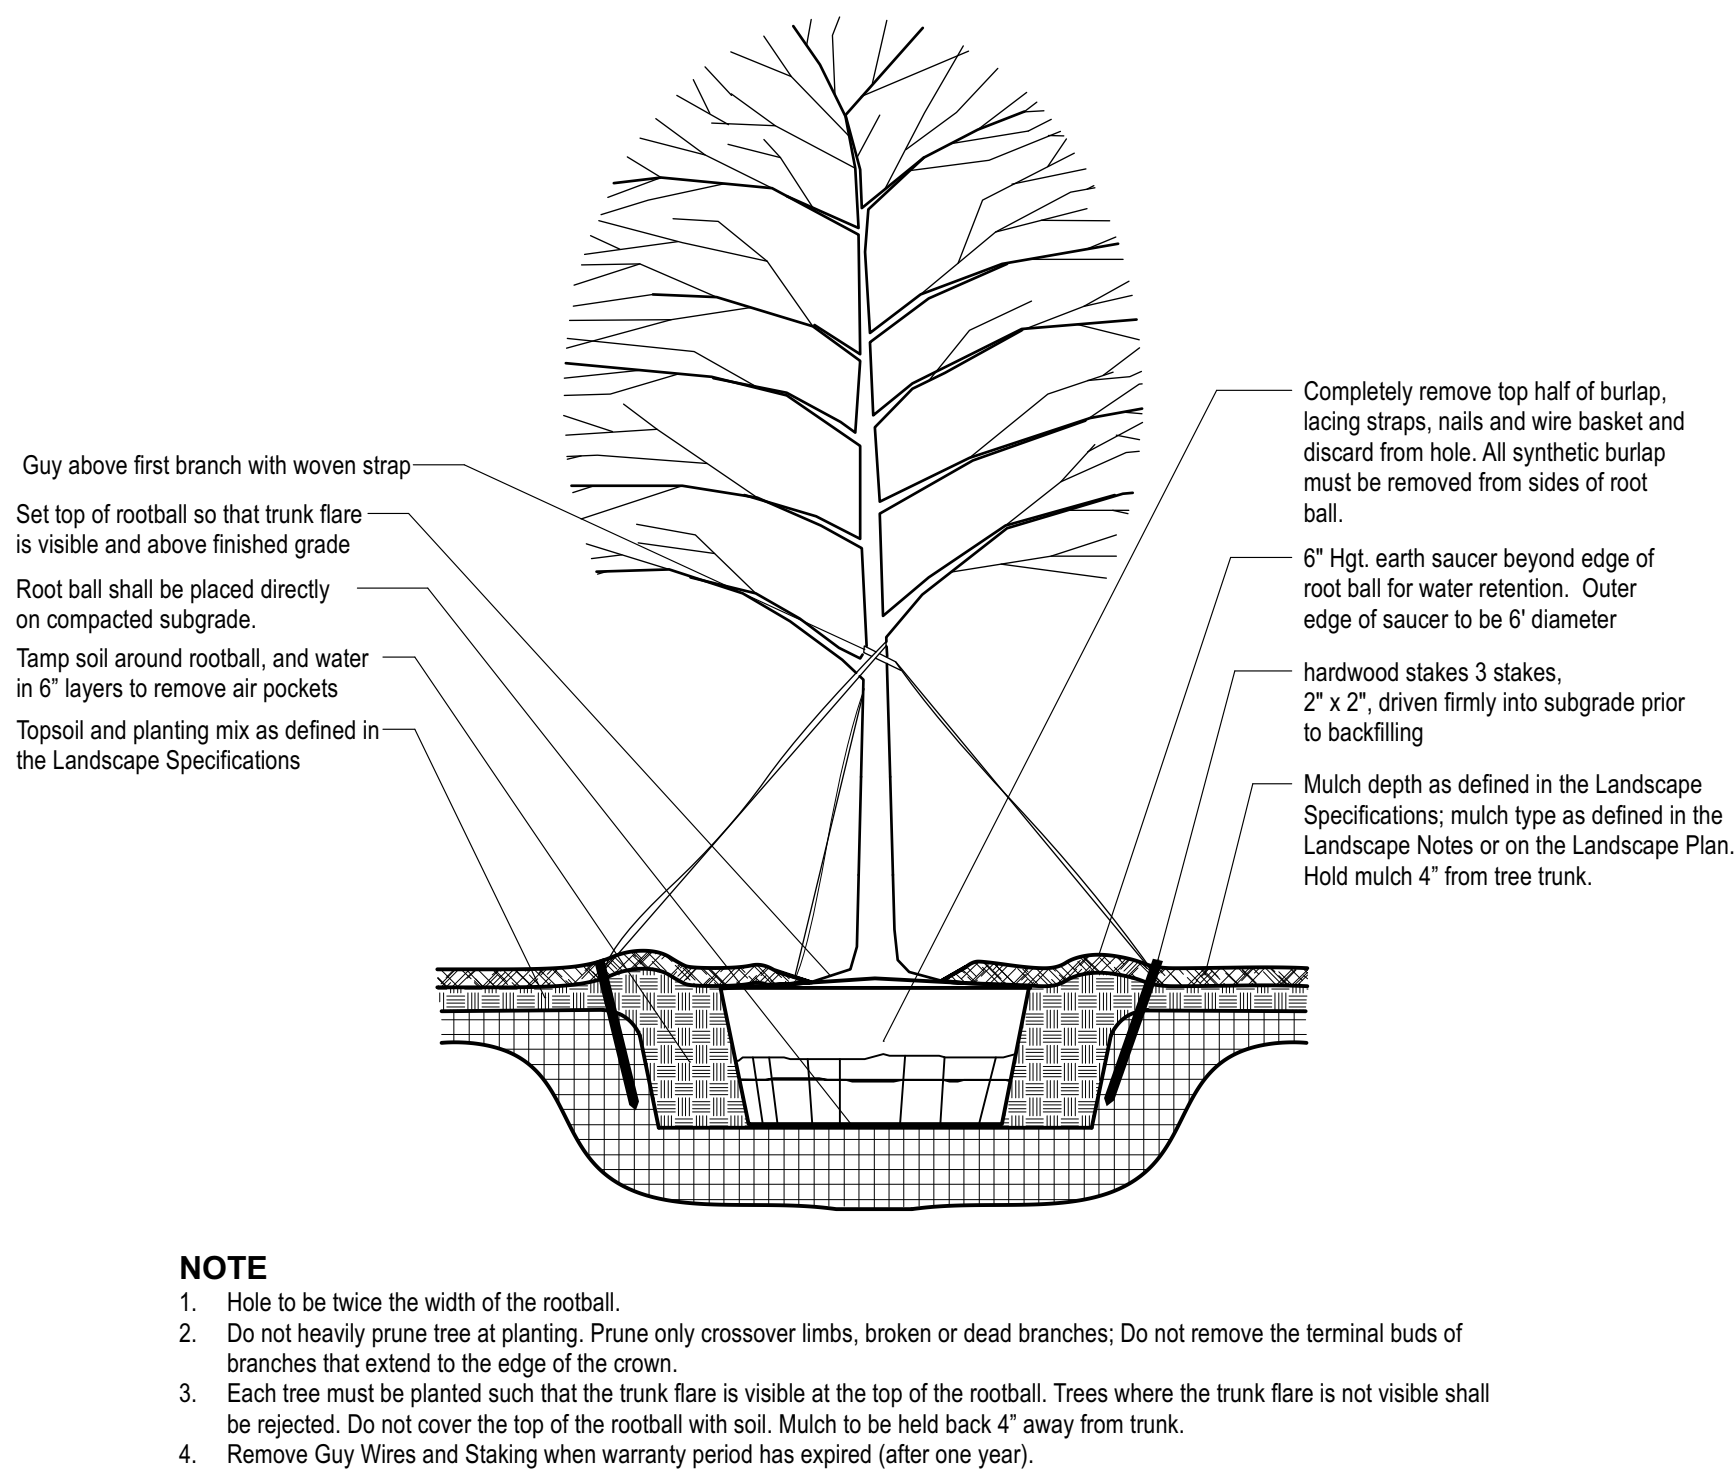


1 **TREE PLANTING & STAKING**  
SCALE: NTS

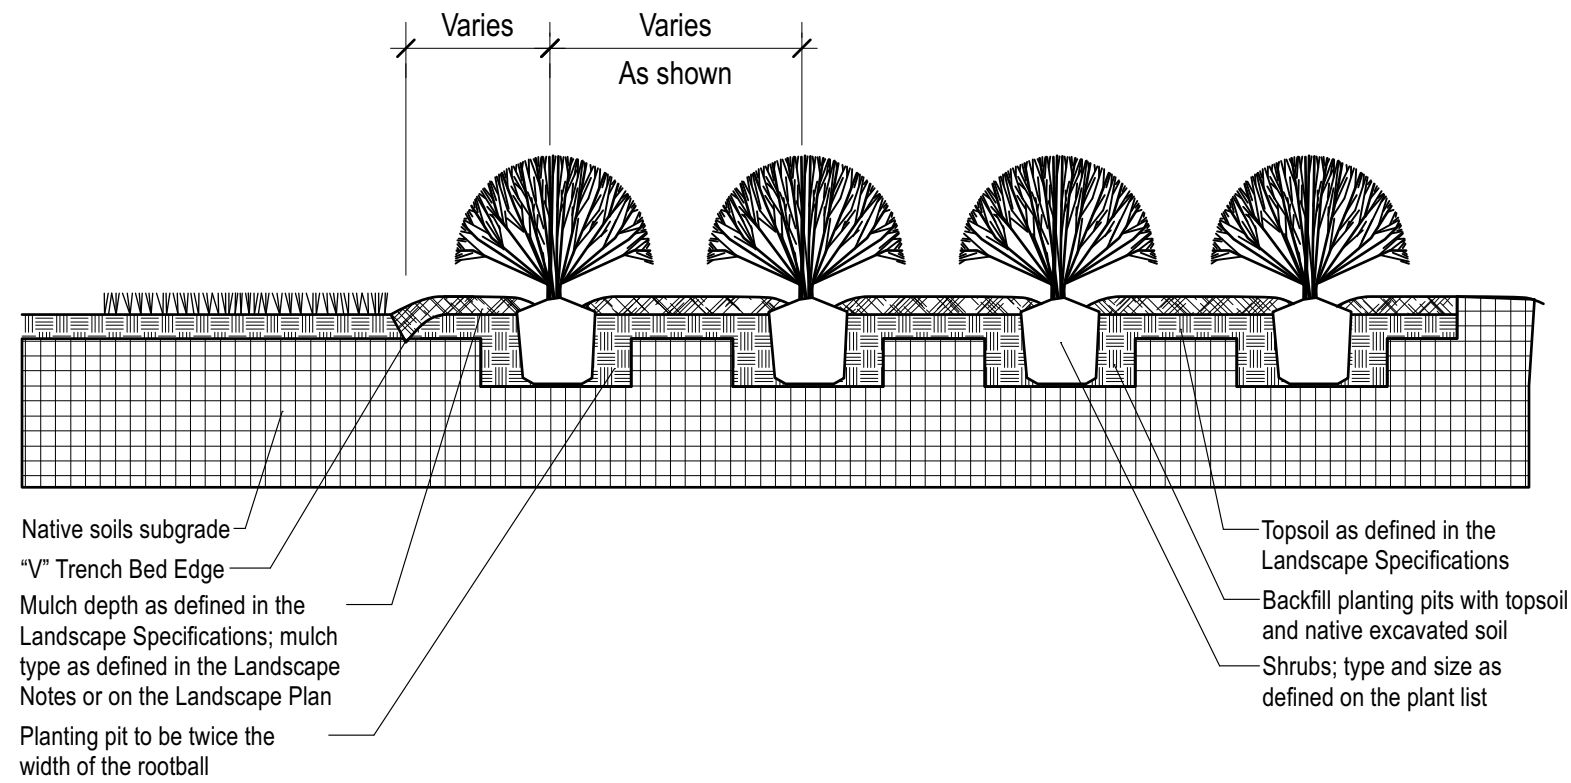


2 **SHRUB BED PLANTING DETAIL**  
SCALE: NTS

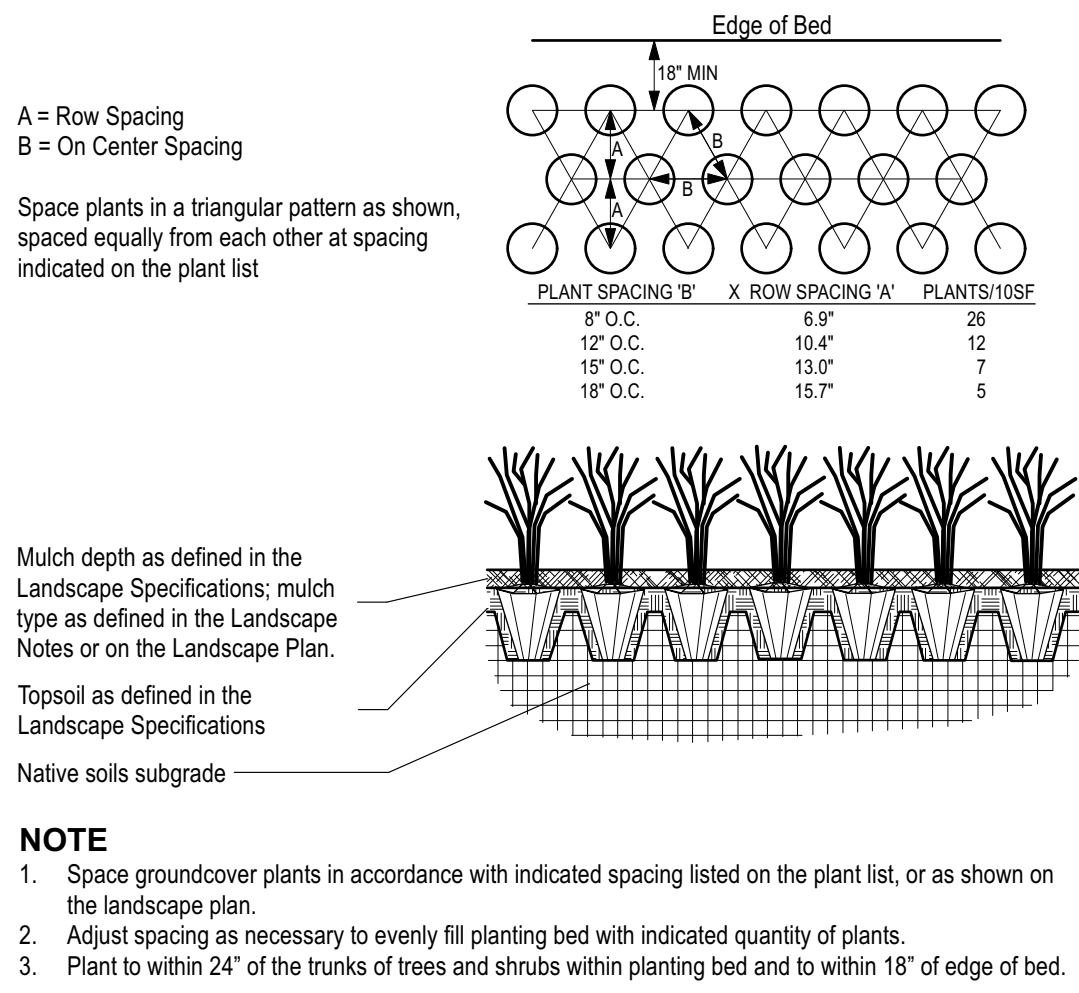


3 **GROUNDCOVER PLANTING DETAIL**  
SCALE: NTS

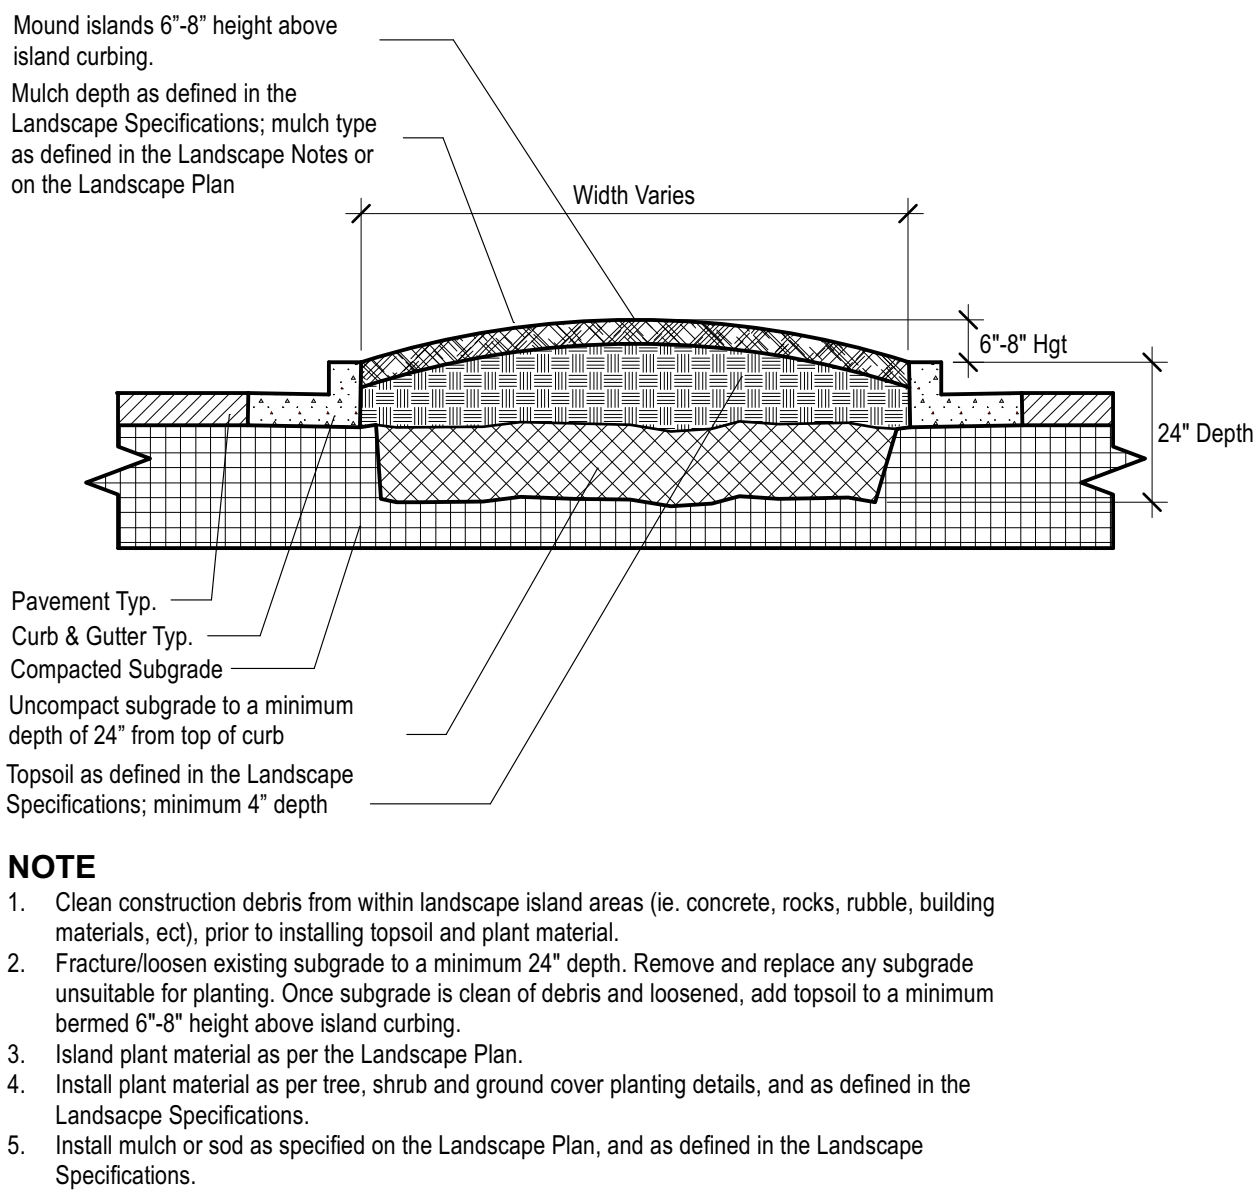

4 **PARKING ISLAND DETAIL**  
SCALE: NTS

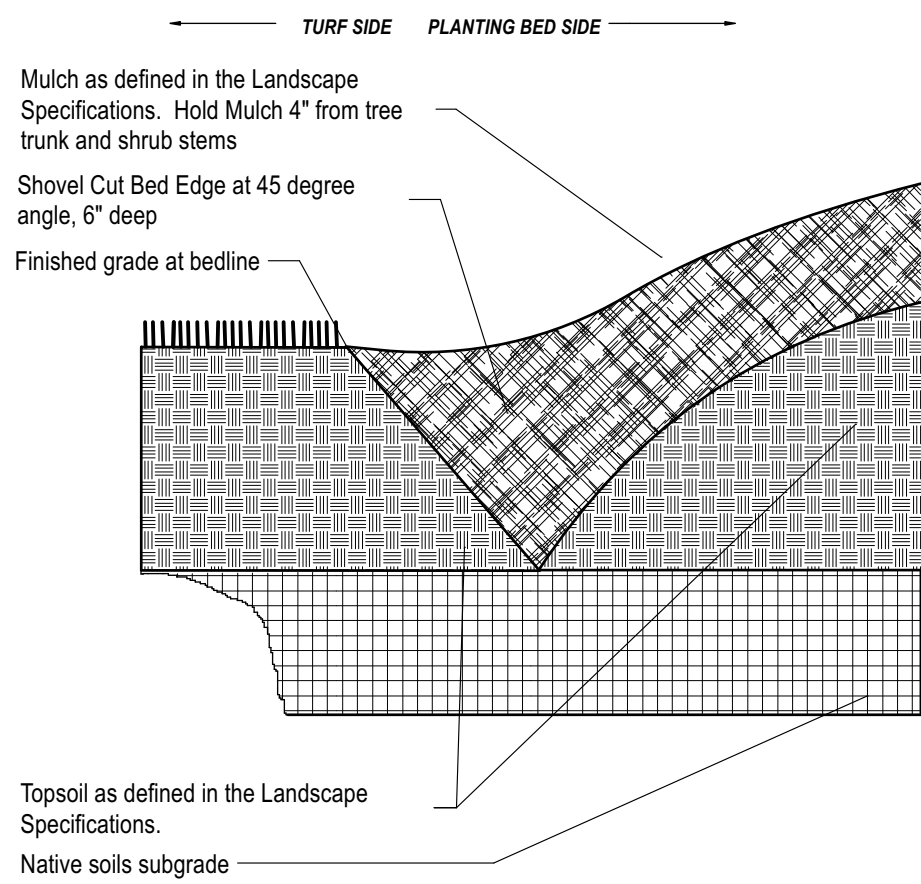

5 **\"V\" TRENCH BED EDGING**  
SCALE: NTS

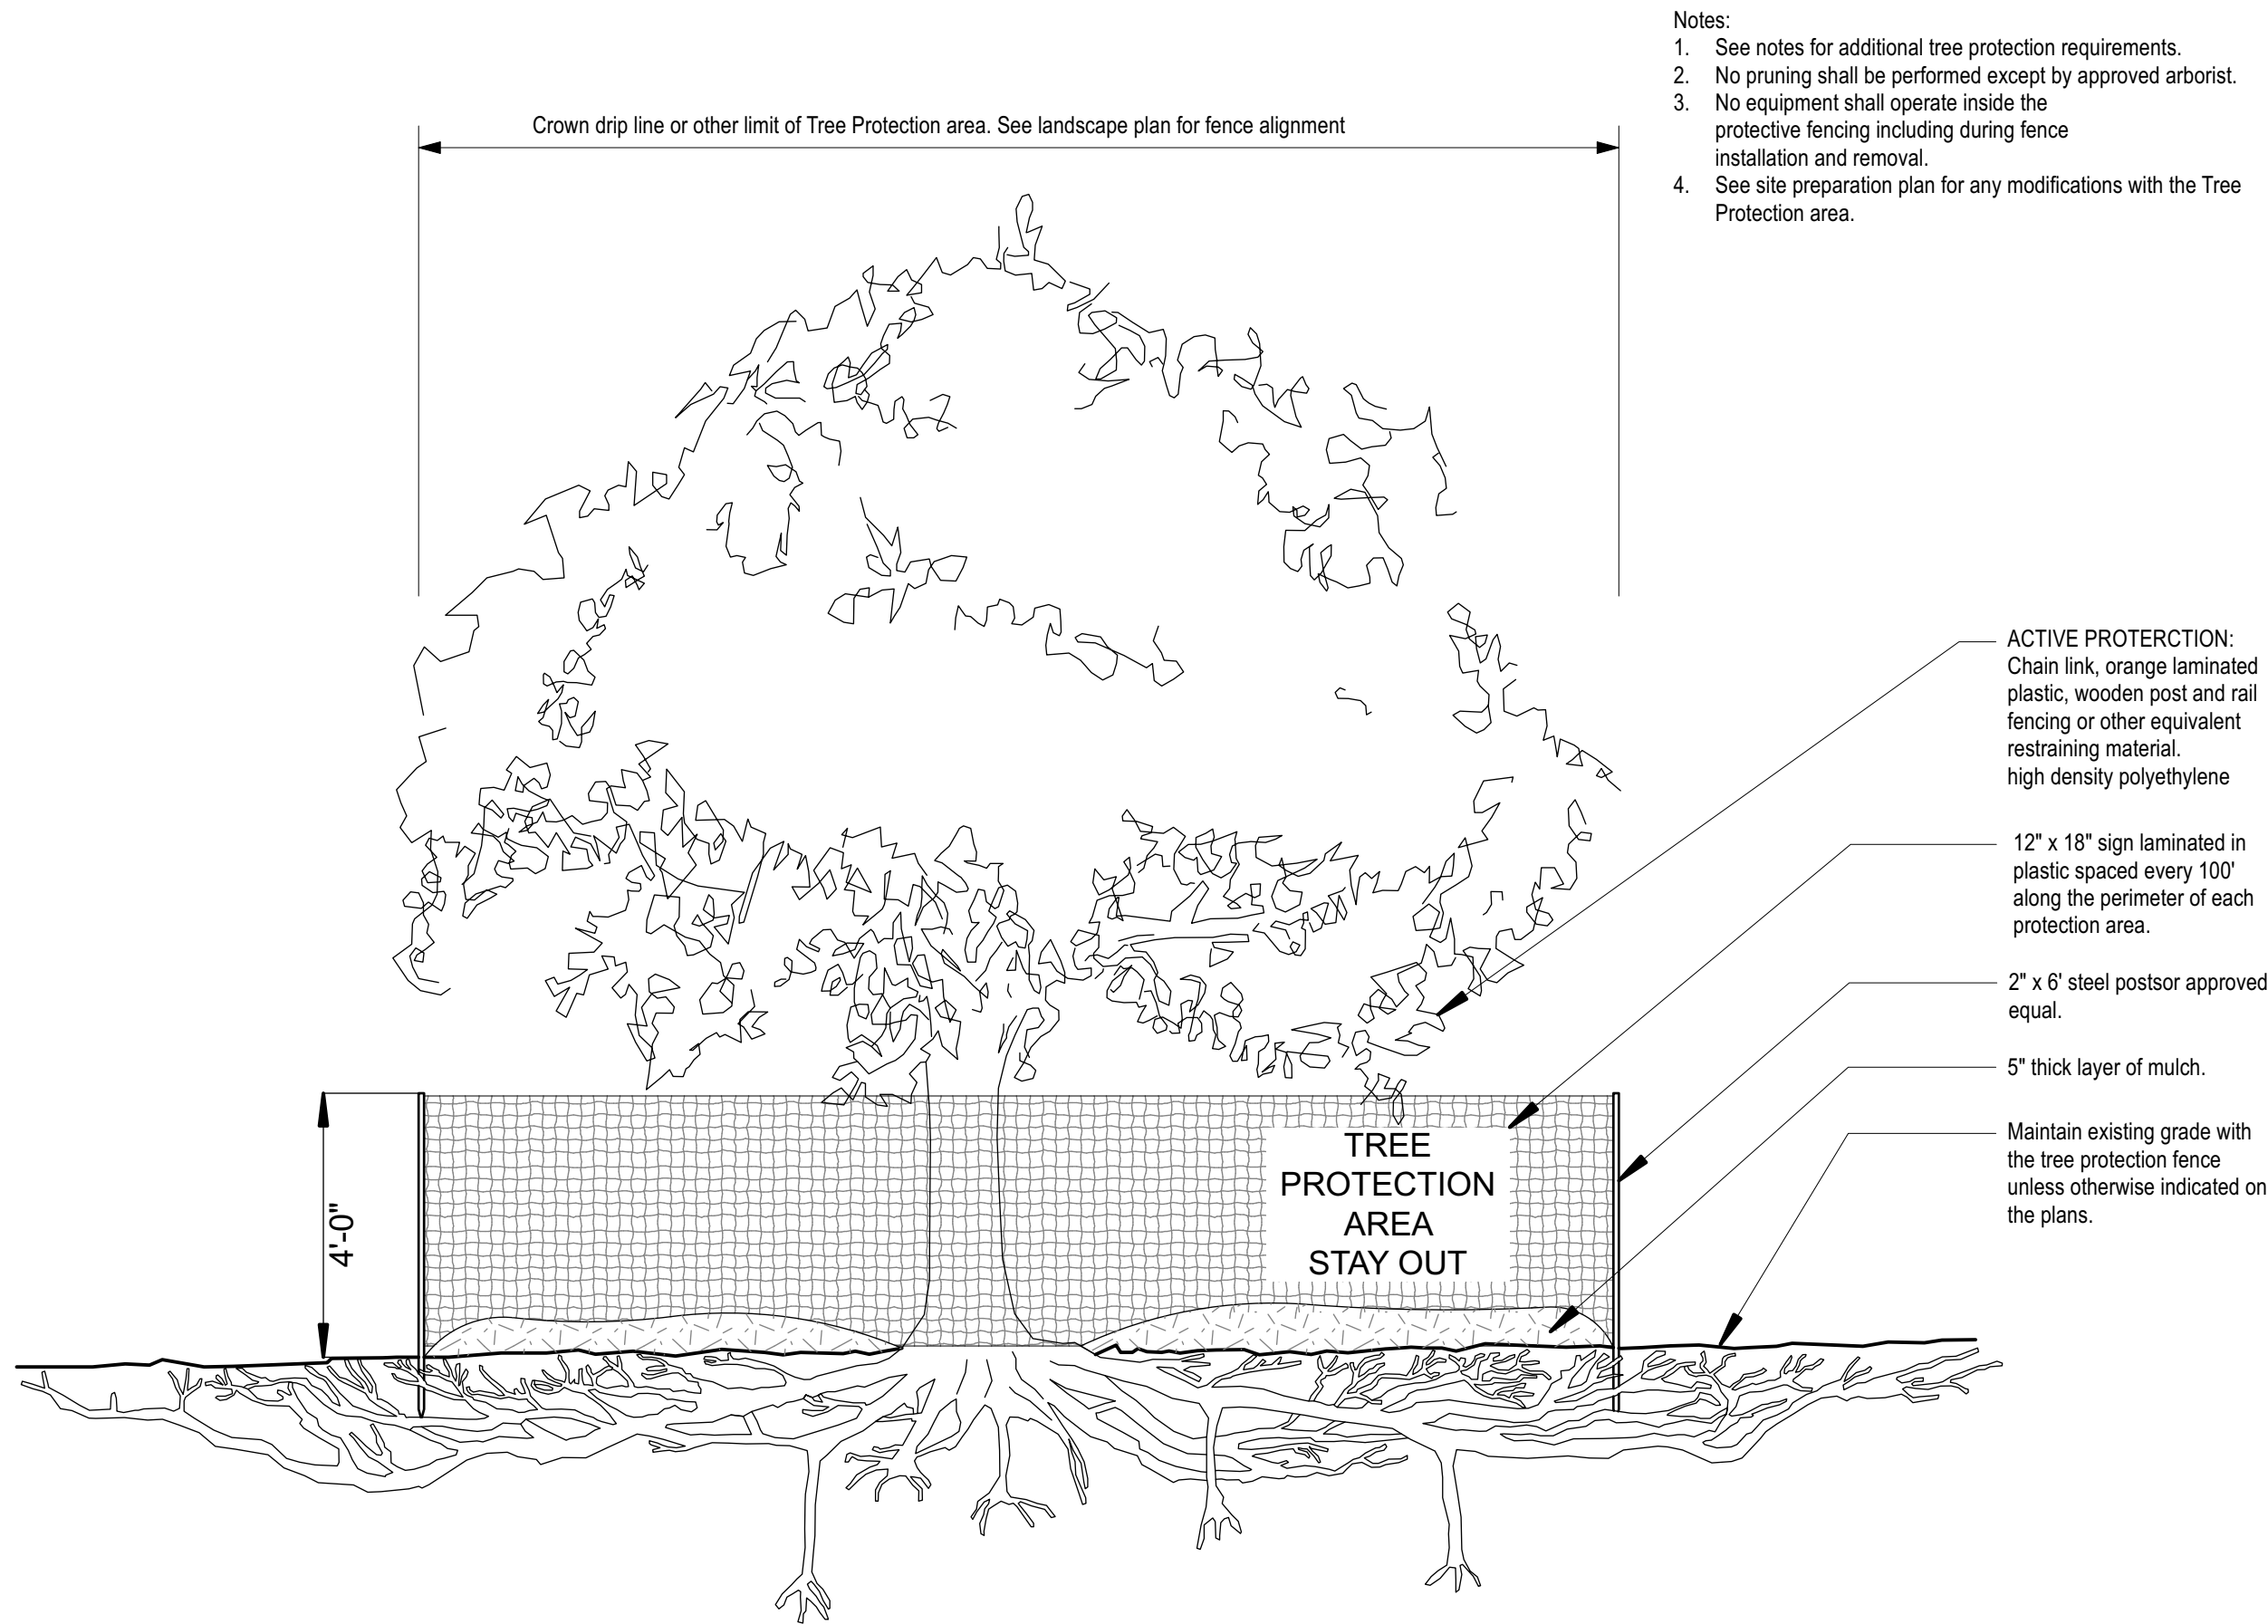


6 **TREE PROTECTION FENCING DETAIL**  
SCALE: NTS



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**FSU# 05442**

REVISION SCHEDULE			
NO.	DATE	BY	DESCRIPTION
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SHEET

**PERMIT**  
**Landscape Details**  
TTODA & Development Plan File #s:  
9-B-23-TOB / 9-C-23-DP

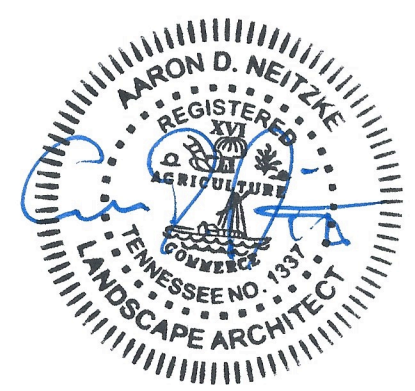SHEET NUMBER

**L-101**



## LANDSCAPE SPECIFICATIONS

### PART 1 - GENERAL

#### DESCRIPTION

Provide trees, shrubs, ground covers, sod, and annuals/perennials as shown and specified on the landscape plan. The work includes:

1. Soil preparation.
2. Trees, shrubs, ground covers, and annuals/perennials.
3. Planting mixes.
4. Top Soil, Mulch and Planting accessories.
5. Maintenance.
6. Decorative stone.

#### Related Work:

1. Irrigation System.

#### QUALITY ASSURANCE

Plant names indicated; comply with "Standardized Plant Names" as adopted by the latest edition of the American Joint Committee of Horticultural Nomenclature. Names of varieties not listed conform generally with names accepted by the nursery trade. Provide stock true to botanical name and legibly tagged.

Comply with sizing and grading standards of the latest edition of "American Standard for Nursery Stock". A plant shall be dimensioned as it stands in its natural position.

All plants shall be nursery grown under climatic conditions similar to those in the locality of the project for a minimum of 2 years.

Nursery Stock furnished shall be at least the minimum size indicated. Larger stock is acceptable, at no additional cost, and providing that the larger plants will not be cut back to size indicated. Provide plants indicated by two measurements so that only a maximum of 25% are of the minimum size indicated and 75% are of the maximum size indicated.

Before submitting a bid, the Contractor shall have investigated the sources of supply and be satisfied that they can supply the listed plants in the size, variety and quality as specified. Failure to take this precaution will not relieve the Contractor from their responsibility for furnishing and installing all plant materials in strict accordance with the Contract Documents without additional cost to the Owner. The Landscape Architect shall approve any substitutes of plant material, or changes in plant material size, prior to the Landscape Contractor submitting a bid.

#### DELIVER, STORAGE AND HANDLING

Take all precautions customary in good trade practice in preparing plants for moving. Workmanship that fails to meet the highest standards will be rejected. Spray deciduous plants in foliage with an approved "Anti-Desiccant" immediately after digging to prevent dehydration. Dig, pack, transport, and handle plants with care to ensure protection against injury. Inspection certificates required by law shall accompany each shipment invoice or order to stock. Drying out, if plants cannot be planted immediately upon delivery, properly protect them with soil, wet peat moss, or in a manner acceptable to the Landscape Architect. Water heeled-in plantings daily. No plant shall be bound with rope or wire in a manner that could damage or break the branches. Cover plants transported on open vehicles with a protective covering to prevent wind burn.

#### PROJECT CONDITIONS

Protect existing utilities, paving, and other facilities from damage caused by landscape operations.

A complete list of plants, including a schedule of sizes, quantities, and other requirements are shown on the drawings. In the event that quantity discrepancies or material omissions occur in the plant materials list, the planting plans shall govern.

The irrigation system will be installed prior to planting. Locate, protect and maintain the irrigation system during planting operations. Repair irrigation system components damaged during planting operations; at the Contractor's expense. Refer to the irrigation specifications, irrigation plan and irrigation details.

Do not begin landscape accessory work before completion of final grading or surfacing.

#### WARRANTY

Warrant plant material to remain alive, be healthy and in a vigorous condition for a period of 1 year after completion and final acceptance of entire project.

Replace, in accordance with the drawings and specifications, all plants that are dead or, are in an unhealthy, or unsightly condition, and have lost their natural shape due to dead branches, or other causes due to the Contractor's negligence. The cost of such replacement(s) is at the Contractor's expense. Warrant all replacement plants for 1 year after installation.

Warranty shall not include damage, loss of trees, plants, or ground covers caused by fires, floods, freezing rains, lightning storms, winds over 75 miles per hour, winter kill caused by extreme cold, severe winter conditions not typical of planting area, and/or acts of vandalism or negligence on a part of the Owner.

Remove and immediately replace all plants, found to be unsatisfactory during the initial planting installation.

Maintain and protect plant material, lawns, and irrigation until final acceptance is made.

#### ACCEPTANCE

Inspection of planted areas will be made by the Owner's representative.

1. Planted areas will be accepted provided all requirements, including maintenance, have been complied with and plant materials are alive and in a healthy, vigorous condition.

Upon acceptance, the Contractor shall commence the specified plant maintenance.

#### CODES, PERMITS AND FEES

Obtain any necessary permits for this Section of Work and pay any fees required for permits.

The entire installation shall fully comply with all local and state laws and ordinances, and with all established codes applicable thereto; also as depicted on the landscape and irrigation construction set.

### PART 2 - PRODUCTS

#### MATERIALS

Plants: Provide typical of their species or variety; with normal, densely developed branches and vigorous, fibrous root systems. Provide only sound, healthy, vigorous plants free from defects, disfiguring knots, sun scald injuries, frost cracks, abrasions of the bark, plant diseases, insect eggs, borers, and all forms of infestation. All plants shall have a fully developed form without voids and open spaces. Plants held on storage will be rejected if they show signs of growth during the storage period.

1. Balled and plants wrapped with burlap, to have firm, natural balls of earth of sufficient diameter and depth to encompass the fibrous and feeding root system necessary for full recovery of the plant. Provide ball sizes complying with the latest edition of the "American Standard for Nursery Stock". Cracked or mushroomed balls, or signs of circling roots are not acceptable.
2. Container- grown stock: Grown in a container for sufficient length of time for the root system to have developed to hold its soil together, firm and whole.
  - a. No plants shall be loose in the container.
  - b. Container stock shall not be pot bound.
3. Plants planted in rows shall be matched in form.
4. Plants larger than those specified in the plant list may be used when acceptable to the Landscape Architect.
  - a. If the use of larger plants is acceptable, increase the spread of roots or root ball in proportion to the size of the plant.
5. The height of the trees, measured from the crown of the roots to the top of the top branch, shall not be less than the minimum size designated in the plant list.
6. No pruning wounds shall be present with a diameter of more than 1" and such wounds must show vigorous bark on all edges.
7. Evergreen trees shall be banded to the ground or as specified in plant list.
8. Shrubs and small plants shall meet the requirements for spread and height indicated in the plant list.
  - a. The measurements for height shall be taken from the ground level to the height of the top of the plant and not the longest branch.
  - b. Single stemmed or thin plants will not be accepted.
  - c. Side branches shall be generous, well-twigged, and the plant as a whole well-bushed to the ground.
  - d. Plants shall be in a moist, vigorous condition, free from dead wood, bruises, or other root or branch injuries.

#### ACCESSORIES

Topsoil: Shall be Fertile, friable, natural topsoil of loamy character, without admixture of subsoil material, obtained from a well-drained arable site, reasonably free from clay, lumps, coarse sands, stones, roots, sticks, and other foreign materials, with acidity range of between pH 6.0 and 6.8.

Note: All planting areas shall be cleaned of construction debris (ie. Concrete, rubble, stones, building material, etc.) prior to adding and spreading of the top soil.

1. **Sod Areas:** Spread a minimum 4" layer of top soil and rake smooth.
2. **Planting bed areas:** Spread a minimum 4" layer of top soil and rake smooth.

3. **Landscape Islands/Medians:** Fracture/loosen existing subgrade to a minimum 24" depth. Remove and replace any subgrade unsuitable for planting. Once subgrade is clean of debris and loosened, add topsoil to a minimum berm 6"-8" height above island curbing.
4. **Annual/Perennial bed areas:** Add a minimum of 4" organic matter and till to a minimum 12" depth.

Mulch: Type selected dependent on region and availability; see landscape plans for type of much to be used. Hold mulch 4" from tree trunks and shrub stems.

1. Hardwood: (color) dark brown, 6 month old well rotted double shredded native hardwood bark mulch not larger than 4" in length and ½" in width, free of wood chips and sawdust. Install minimum depth of 3".
2. Pine Straw: Pine straw to be fresh harvest, free of debris, bright in color. Bales to be wired and tightly bound. Needles to be dry. Install minimum depth of 3".
3. River Rock: (color) light gray to buff to dark brown, washed river rock, 1" – 3" in size. Install in shrub beds to an even depth of 3". Weed control barrier to be installed under all rock mulch areas. Use caution during installation not to damage plant material.
4. Mini Nuggets: Install to a minimum depth of 2"-3" at all locations of annual and perennial beds. Lift the stems and leaves of the annuals and alocally spread the mulch to avoid injuring the plants. Gently brush the mulch off the plants.

#### Guying/Staking:

1. Arbotrie: Green (or white) staking and guying material to be flat, woven, polypropylene material, ¾" wide 900 lb. break strength. Arbotrie shall be fastened to stakes in a manner which permits tree movement and supports the tree.
2. Remove Guying/Staking after one year from planting.

Tree Wrap: Tree wraps should be used on young, newly planted thin-barked trees (Cherry, Crabapple, Honey Locust, Linden, Maple, Mountain Ash, Plum) that are most susceptible to sun scald/Sunburn. Standard waterproofed tree wrapping paper, 2-1/2" wide, made of 2 layers of crepe Draft paper weighing not less than 30 lbs. per ream, cemented together with asphalt. Wrap the tree in the fall and leave the wrap in place throughout the winter and early spring. Tree wraps are temporary and no longer needed once trees develop corky bark.

### PART 3 – EXECUTION

#### INSPECTION

Prior to beginning work, the Landscape Contractor shall inspect the subgrade, general site conditions, verify elevations, utility locations, irrigation, approve top soil provided by the General Contractor and observe the site conditions under which the work is to be done. Notify the General Contractor of any unsatisfactory conditions, and work shall not proceed until such conditions have been corrected and are acceptable to the Landscape Contractor.

#### PREPARATION

Planting shall be performed only by experienced workmen familiar with planting procedures under the supervision of a qualified supervisor.

Locate plants as indicated on the plans or as approved in the field after staking by the Landscape Contractor. If obstructions are encountered that are not shown on the drawings, do not proceed with planting operations until alternate plant locations have been selected and approved by the Landscape Architect; spacing of plant material shall be as shown on the landscape plan.

Excavate circular plant pits with vertical sides, except for plants specifically indicated to be planted in beds. Provide shrub pits at least 12" greater than the diameter of the root system and 24" greater for trees. Depth of pit shall accommodate the root system. Provide undisturbed sub grade to hold root ball at nursery grade as shown on the drawings.

#### INSTALLATION

Set plant material in the planting pit to proper grade and alignment. Set plants upright, plumb, and faced to give the best appearance or relationship to each other or adjacent structure. Set plant material 2" – 3" above the finish grade. No filling will be permitted around trunks or stems. Backfill the pit with topsoil mix and excavated material. Do not use frozen or muddy mixtures for backfilling. Form a ring of soil around the edge of each planting pit to retain water.

After balled and wrapped in burlap plants are set, mulde planting soil mixture around bases of balls and fill all voids.

1. Remove all burlap, ropes, and wires from the top 1/3 of the root ball

Space ground cover plants in accordance with indicated dimensions. Adjust spacing as necessary to evenly fill planting bed with indicated quantity of plants. Plant to within 24" of the trunks of trees and shrubs within planting bed and to within 18" of edge of bed.

#### Mulching:

1. Mulch tree and shrub planting pits and shrub beds with required mulching material (see landscape plan for mulch type); depth of mulch as noted above. **Hold mulch back 4" away from tree trunks and shrub stems.** Thoroughly water mulched areas. After watering, rake mulch to provide a uniform finished surface.
- Decorative Stone: (where indicated on landscape plan)
1. Install weed control barrier over sub-grade prior to installing stone. Lap 6" on all sides.
  2. Place stone without damaging weed barrier.
  3. Arrange stones for best appearance and to cover all weed barrier fabric.

#### Wrapping, guying, staking:

1. Inspect trees for injury to trunks, evidence of insect infestation, and improper pruning before wrapping.
2. Wrapping:
  - a. Wrap trunks of all young newly planted trees known to have thin bark. Wrap spirally from bottom to top with specified tree wrap and secure in place.
  - b. Overlap ½ the width of the tree wrap strip and cover the trunk from the ground to the height of the second branch.
  - c. Secure tree wrap in place with twine wound spirally downward in the opposite direction, tied around the tree in at least 3 places in addition to the top and bottom.
  - d. Wrap the trees in the fall and leave the wrap in place throughout the winter and early spring.
  - e. Tree wraps are temporary and no longer needed once the trees develop corky bark.
3. Staking/Guying:
  - a. Stake/guy all trees immediately after lawn sodding operations and prior to acceptance.
  - b. Stake deciduous trees 2" caliper and less. Stake evergreen trees under 7"-0" tall.
    1. Stakes are placed in line with prevailing wind direction and driven into undisturbed soil.
    2. Ties are attached to the tree, usually at the lowest branch.
  - c. Guy deciduous trees over 2" caliper. Guy evergreen trees 7"-0" tall and over.
    1. Guy wires to be attached to three stakes driven into undisturbed soil, with one stake placed in the direction of the prevailing wind.
    2. Ties are attached to the tree as high as practical.
    3. The axis of the stake should be at 90 degree angle to the axis on the pull of the guy wire.
4. **Remove all guying and staking after one year from planting.**

#### Pruning:

1. Prune deciduous trees and evergreens only to remove broken or damaged branches.

#### WORKMANSHIP

During landscape/irrigation installation operations, all areas shall be kept neat and clean. Precautions shall be taken to avoid damage to existing structures. All work shall be performed in a safe manner to the operators, the occupants and any pedestrians.

Upon completion of installation operations, all excess materials, equipment, debris and waste material shall be cleaned up and removed from the site; unless provisions have been granted by the owner to use on-site trash receptacles. Sweep parking and walks clean of dirt and debris. Remove all plant tags and other debris from lawns and planting areas.

Any damage to the landscape, the structure, or the irrigation system caused by the landscape contractor shall be repaired by the landscape contractor without charge to the owner.

#### MAINTENANCE

Contractor shall provide maintenance until work has been accepted by the Owner's Representative.

Maintenance shall include mowing, fertilizing, mulching, pruning, cultivation, weeding, watering, and application of appropriate insecticides and fungicides necessary to maintain plants and lawns free of insects and disease.

1. Re-set settled plants to proper grade and position. Restore planting saucer and adjacent material and remove dead material.
2. repair guy wires and stakes as required. Remove all stakes and guy wires after 1 year.
3. Correct defective work as soon as possible after deficiencies become apparent and weather and season permit.
4. Water trees, plants and ground cover beds within the first 24 hours of initial planting, and not less than twice per week until final acceptance.

## LANDSCAPE MAINTENANCE SPECIFICATIONS

The Contractor shall provide as a separate bid, maintenance for a period of **1 year** after final acceptance of the project landscaping. The Contractor must be able to provide continued maintenance if requested by the Owner or provide the name of a reputable landscape contractor who can provide maintenance.

#### STANDARDS

All landscape maintenance services shall be performed by trained personnel using current, acceptable horticultural practices.

All work shall be performed in a manner that maintains the original intent of the landscape design.

All chemical applications shall be performed in accordance with current county, state and federal laws, using EPA registered materials and methods of application. These applications shall be performed under the supervision of a Licensed Certified applicator.

#### APPROVALS

Any work performed in addition to that which is outlined in the contract shall only be done upon written approval by the Owner's Representative (General Manager of the restaurant).

All seasonal color selections shall be approved by the General Manager prior to ordering and installation.

#### SOIL TESTING

The maintenance contractor shall perform soil tests as needed to identify imbalances or deficiencies causing plant material decline. The owner shall be notified of the recommendation for approval, and the necessary corrections made at an additional cost to the owner.

#### Acceptable Soil Test Results

	Landscape Trees and Shrubs	Turf
pH Range	5.0-7.0	6.0-7.0
Organic Matter	>1.5%	>2.5%
Magnesium (Mg)	100-lbs./acre	100-lbs./acre
Phosphorus (P2O5)	150-lbs./acre	150-lbs./acre
Potassium (K2O)	120-lbs./acre	120-lbs./acre
Soluble Phosphorus	Not to exceed 900ppm/1.9 mmhos/cm	Not to exceed 750ppm/0.75 mmhos/cm
Conductivity	In soil; not to exceed 1400 ppm/2.5 mmhos/cm in high organic mix	In soil; not to exceed 2000 ppm/2.0 mmhos/cm in high organic mix
For unusual soil conditions, the following optional tests are recommended with levels not to exceed:		
Boron		3 pounds per acre
Manganese		50 pounds per acre
Potassium (K2O)		450 pounds per acre
Sodium		20 pounds per acre

#### WORKMANSHIP

During landscape maintenance operations, all areas shall be kept neat and clean. Precautions shall be taken to avoid damage to existing structures. All work shall be performed in a safe manner to the operators, the occupants and any pedestrians.

Upon completion of maintenance operations, all debris and waste material shall be cleaned up and removed from the site, unless provisions have been granted by the owner to use on-site trash receptacles.

Any damage to the landscape, the structure, or the irrigation system caused by the maintenance contractor, shall be repaired by the maintenance contractor without charge to the owner.

## TURF

#### GENERAL CLEAN UP

Prior to mowing, all trash, sticks, and other unwanted debris shall be removed from lawns, plant beds, and paved areas.

#### MOWING

Warm season grasses (i.e. Bermuda grass) shall be maintained at a height of 1" to 2" during the growing season.

Cool season grasses, including blue grass, tall fescue, perennial ryegrass, etc., shall be maintained at a height of 2" to 3" in spring and fall. From June through September, mowing height shall be maintained at no less than 3".

The mowing operation includes trimming around all obstacles, raking excessive grass clippings and removing debris from walks, curbs, and parking areas. Caution: Weed eaters should NOT be used around trees because of potential damage to the bark.

#### EDGING

Edging of all sidewalks, curbs and other paved areas shall be performed once every other mowing. Debris from the edging operations shall be removed and the areas swept clean. Caution shall be used to avoid flying debris.

#### LIMING & FERTILIZING

A soil test shall be taken to determine whether an application of limestone in late fall is necessary. If limestone is required, the landscape contractor shall specify the rate, obtain approval from the owner and apply it at an additional cost. A unit price for liming of turf shall accompany the bid based on a rate of 50 pounds per 1000 square feet.

Fertilizer shall be applied in areas based on the existing turf species.

#### LAWN WEED CONTROL: HERBICIDES

Selection and proper use of herbicides shall be the landscape contractor's responsibility. All chemical applications shall be performed under the supervision of a Licensed Certified Applicator. **Read the label prior to applying any chemical.**

#### INSECT & DISEASE CONTROL FOR TURF

The contractor shall be responsible for monitoring the site conditions on each visit to determine if any insect pest or disease problems exist. The contractor shall identify the insect pest or disease, as well as the host plant, and then consult the most current edition of the Cooperative Extension Service's "Commercial Insecticide Recommendation for Turf" for control. The licensed applicator shall be familiar with the label provided for the selected product prior to application.

Inspection and treatment to control insect pests shall be included in the contract price.

## TREES, SHRUBS, & GROUND COVER

#### PRUNING

All ornamental trees, shrubs and ground cover shall be pruned when appropriate to remove dead or damaged branches, develop the natural shapes. **Do not shear trees or shrubs.** If previous maintenance practice has been to shear and ball, then a natural shape will be restored gradually.

#### Pruning Guidelines:

1. Prune those that flower before the end of June immediately after flowering. Flower buds develop during the previous growing season. Fall, winter or spring pruning would reduce the spring flowering display.
2. Prune those that flower in summer or autumn in winter or spring before new growth begins, since these plants develop flowers on new growth.
3. Delay pruning plants grown for ornamental fruits, such as cotoneasters, pyracanthas and viburnums.
4. Hollies and other evergreens may be pruned during winter in order to use their branches for seasonal decoration. However, severe pruning of evergreens should be done in early spring only.
5. Broadleaf evergreen shrubs shall be hand-pruned to maintain their natural appearance after the new growth hardens off.
6. Hedges or shrubs that require shearing to maintain a formal appearance shall be pruned as required. Dead wood shall be removed from sheared plants before the first pruning of the season.
7. Conifers shall be pruned, if required, according to their genus.
  - A. Yews, junipers, hemlocks, arborvitae, and false-cypress may be pruned after new growth has hardened off in late summer. If severe pruning is necessary, it must be done in early spring.
  - B. Firs and spruces may be lightly pruned in late summer, fall, or winter after completing growth. Leave side buds. Never cut central leader.
  - C. Pines may be lightly pruned in early June by reducing candles.
8. Groundcover shall be edged and pruned as needed to contain it within its borders.

9. Thinning: Remove branches and water sprouts by cutting them back to their point of origin on parent stems. This method results in a more open plant, without stimulating excessive growth. Thinning is used on crepe myrtle, ilacs, viburnums, smoke bush,etc.
10. Renewal pruning: Remove oldest branches of shrub at ground, leaving the younger, more vigorous branches. Also remove weak stems. On overgrown plants, this method may be best done over a three-year period. Renewal pruning may be used on abelia, forsythia, deutzia, spiraea, etc.

Plants overhanging passageways and parking areas and damaged plants shall be pruned as needed.

Shade trees that cannot be adequately pruned from the ground shall not be included in the Maintenance Contract. A certified arborist under a separate contract shall perform this type of work.

#### SPRING CLEANUP

Plant beds shall receive a general cleanup before fertilizing and mulching. Cleanup includes removing debris and trash from beds and cutting back herbaceous perennials left standing through winter, e.g. ornamental grasses, Sedum Autumn Joy.

#### FERTILIZING

For trees, the rate of fertilization depends on the tree species, tree vigor, area available for fertilization, and growth stage of the tree. Mature specimens benefit from fertilization every 3 to 4 years; younger trees shall be fertilized more often during rapid growth stages.

The current recommendation is based on the rate of 1000 square feet of area under the tree to be fertilized. For deciduous trees, 2 to 6 pounds of Nitrogen per 1000 square feet; for narrow-leaf evergreens, 1 to 4 pounds of Nitrogen per 1000 square feet; for broadleaf evergreens, 1 to 3 pounds of Nitrogen per 1000 square feet.

Shrubs and groundcover shall be top-dressed with compost 1" deep, or fertilized once in March with 10-6-4 analysis fertilizer at the rate of 3 pounds per 100 square feet of bed area. Eriaceous material shall be fertilized with an ericaceous fertilizer at the manufacturer's recommendation rate. If plants are growing poorly, a soil sample should be taken.

#### MULCHING

Annually, all tree and shrub beds will be prepared and mulched, to a minimum depth of 3" with quality mulch to match existing. Bed preparation shall include removing all weeds, cleaning up said bed, edging and cultivating decayed mulch into the soil. Debris from edging is to be removed from beds where applicable. If deemed necessary, a pre-emergent herbicide may be applied to the soil to inhibit the growth of future weeds.

Organically maintained gardens shall not receive any pre-emergent herbicides. Mulch in excess of 4" will be removed from the bed areas. SPECIAL CARE shall be taken in the mulching operation not to over-mulch or cover the base of trees and shrubs. This can be detrimental to the health of the plants.

#### WEEDING

All beds shall be weeded on a continuous basis throughout the growing season to maintain a neat appearance at all times.

Pre-emergent (soil-applied) and post-emergent (foliar-applied) herbicides shall be used where and when applicable and in accordance with the product's label.

#### INSECT & DISEASE CONTROL: TREES, SHRUBS & GROUNDCOVER

The maintenance contractor shall be responsible for monitoring the landscape site on a regular basis. The monitoring frequency shall be monthly except for growing season, which will be every other week. Trained personnel shall monitor for plant damaging insect activity, plant pathogenic diseases and potential cultural problems in the landscape. The pest or cultural problem will be identified under the supervision of the contractor.

For plant damaging insects and mites identified in the landscape, the contractor shall consult and follow the recommendations of the most current edition of the state Cooperative Service publication on insect control on landscape plant material.

Plant pathogenic disease problems identified by the contractor that can be resolved by pruning or physical removal of damaged plant parts will be performed as part of the contract. For an additional charge, plant pathogenic diseases that can be resolved through properly timed applications of fungicides shall be made when the owner authorizes it.

If the contractor notes an especially insect-or disease-prone plant species in the landscape, he/she will suggest replacement with a more pest-resistant cultivar or species that is consistent with the intent of the landscape design.

NOTE: For identification of plant-damaging insects and mites, a reference textbook that can be used is *Insects that Feed on Trees and Shrubs* by Johnson and Lyon, Comstock Publishing Associates. For plant pathogenic diseases, two references are suggested: *Scouting and Controlling Woody Ornamental Diseases in Landscapes and Nurseries*, authorized by Gary Moorman, published by Penn State College of Agricultural Sciences, and *Diseases of Trees and Shrubs* by Sinclair and Lyon, published by Comstock Publishing Press.

#### TRASH REMOVAL

The maintenance contractor shall remove trash from all shrub and groundcover beds with each visit.

#### LEAF REMOVAL

All fallen leaves shall be removed from the site in November and once in December. If requested by the owner, the maintenance contractor, at an additional cost to the owner shall perform supplemental leaf removals.

#### WINTER CLEAN-UP

The project shall receive a general clean-up once during each of the winter months, i.e., January, February, and March.

#### Clean-up includes:

- Cleaning curbs and parking areas
- Removing all trash and unwanted debris
- Turning mulch where necessary
- Inspection of grounds

## SEASONAL COLOR: PERENNIALS, ANNUALS, AND BULBS

The installation of perennials, annuals, and bulbs, unless specified herein, shall be reviewed with the owner, and, if accepted, installed and billed to the owner.

#### SEASONAL COLOR MAINTENANCE

##### Perennialization of Bulbs:

1. After flowering, cut off spent flower heads.
2. Allow leaves of daffodils and hyacinths to remain for six weeks after flowers have faded. Cut off at base.
3. Allow leaves of other bulbs to yellow naturally and then cut off at base.
4. Apply fertilizer after flowering in spring, possibly again in fall. Apply 10-10-10 at the rate of 2 pounds per 1000 square feet, or top-dress with compost 1" deep. Fall fertilization with a bulb fertilizer or mulching with 1" of compost is optional.

##### Flower Rotation:

1. Bulbs: Remove the entire plant and bulb after flowers have faded or at the direction of the owner, and install new plants if included in contract.
2. Summer Annuals or Fall Plants:
  - a. Dead heading: Pinch and remove dead flowers on annuals as necessary.
  - b. Fertilizing Summer Annuals: Fertilize using one or two methods: Apply a slow-release fertilizer in May following manufacturer's recommendations. A booster such as 10-10-10 may be necessary in late summer. Or, apply liquid fertilizations of 20-20-20 water-soluble fertilizers, not to exceed 2 pounds of 20-20-20 per 100 gallons of water, monthly, or mulch with compost 1" deep.
  - c. Removal: If fall plants are to be installed, summer annuals shall be left in the ground until the first killing frost and then removed, unless otherwise directed by the owner.

##### Perennials:

1. After initial installation, if a time-released fertilizer has been incorporated during plant installation, no more fertilizer need be applied the first growing season.
2. The following year:
  - a. Fertilize perennials with a slow-release fertilizer or any 50% organic fertilizer, or mulch perennials with compost