NEW FACILITY FOR

TAKE 5 CAR WASH

7590 BILL BELL WAY POWFII TN 37849

ABBREVIATIONS CODE ANALYSIS PROJECT INFORMATION SCOPE OF WORK	'A'.
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ELCC. ELECTRICAL PROCESSION JOINT O.C. EVANSION JOINT O.C. EVANSIO	849
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F.D. FLOOR DRAIN PLBW. PLBW. PLWBING PLNW. PLWO.D PLYWOOD Exit Signs: NO YES SUNDAY: STURDAY: NO FIRE RESISTANCE PLW MONDAY - SATURDAY: NO FIRE RESISTANCE P	, ⊢
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F.F. FIBERGLASS P.T. PRESSURE TREATED REINFORCED PANEL REINFORCED PANEL REINFORCED PANEL REINFORCED PANEL REQUIREMENTS Panic Hardware: NO YES CONTACT: TRAVIS EVANS REQUIREMENTS Panic Hardware: NO YES CONTACT: MARY PHONE: (865) 215-2325 CONTACT: TRAVIS EVANS REQUIREMENTS PROTECTED OPENINGS TABLE REQUIREMENTS PROTECTED OPENINGS TABLE PROTECTED OPENING	
F.S. FLOWS SINK R. RISER FT. FOOT/FEET (R) RELOCATED FTG. FOOTING RAD. RADIUS FTG. FOOTING R.D. ROOF DRAIN FTG. FURRING R.D. ROOF DRAIN FTG. FURRING R.D. ROOF DRAIN FTG. FURRING R.D. ROOF DRAIN FTG. FOOTING RAD. RADIUS FLOW SINK R. RISER FREV DATE DESCRIAGE OS. 10 LIMITED + 30 FEET REV DATE DESCRIAGE FEET DESCRIAGE FEET DESCRIAGE FOOTING RELOCATED KNOXVILLE-KNOX COUNTY PLANING 400 MAIL & 50% FEMALE) 400 MAIL ST., RM. 547 KNOXVILLE, TN 37902	
ANNOTATION SYMBOL LEGEND OFFICE AREA 68 S.F. /100 1 OCC. PLAN DETAIL REFERENCE X DOOR NUMBER X DOO	
SHEET NUMBER ————————————————————————————————————	
ELEVATION REFERENCE SHEET NUMBER WALL TYPE KEYNOTE DEFERRED ITEM LISTED BELOW PRIOR TO COMMENCING ANY WORK WITHIN THE SCOPE OF SUCH DEFERRAL. DEFERRALS MUST BE REVIEWED AND ACCEPTED BY THE ARCHITECT OR ENGINEER OF RECORD PRIOR TO SUBMITTING FOR REVIEW WITH THE LOCAL JURISDICTION. MINIMUM PLUMBING FACILITIES PER UPC TABLE 422.1 (50% MALE & 50% FEMALE) WATERCLOSETS URINAL LAVATORIES	
SUB-ELEVATION LETTER	
PROVIDED S.S. S. DRAWN BY: ROOM NAME ROOM NUMBER 101 PROVIDED S.S. S. D. D. S. S. S. D. DRAWN BY: CED A D A TE DED NATE RESTROOM FOR ALL EMPLOYEES AND CLIENT.	TMN TMN
SHEET NUMBER COLUMN GRID LINE NUMBER COLUMN GRID LINE NUMBER COLUMN GRID LINE NUMBER A. ALL EXTERIOR SIGNAGE TO BE SUBMITTED AND PERMITTED SEPARATELY BY OTHERS. SHEET NAME:	
SHEET NUMBER — X — FINISH CALLOUT — X-X — C. VACUUM EQUIPMENT TO BE SUBMITTED BY OTHERS. COVE SHEET NUMBER — X — SHEET NUMBER — X — SHEET NUMBER — X — X — X — X — X — X — X — X — X —	
ELEVATION HEIGHT — O'-O" A.F.F. CEILING FINISH CALLOUT — X-X SHEET NUMBER:	`FT
LAYOUT STARTPOINT ————————————————————————————————————	

SHEET INDEX

ARCHITECTURAL

morris+associates Build on Our Strengths

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SHEET SHEET NAME

A0.20 EGRESS PLAN

A1.10 SITE PLAN

A1.50 SITE DETAILS

A2.00 SLAB PLAN

A2.01 SLAB DETAILS

A2.02 CONDUIT PLAN

A0.00 COVER SHEET


A0.01 GENERAL NOTES, PROJECT NOTES & BID NOTES

A0.10 ACCESSIBILITY DETAILS

A0.11 ACCESSIBILITY DETAILS

A0.12 ACCESSIBILITY DETAILS

A0.20 EGRESS PLAN

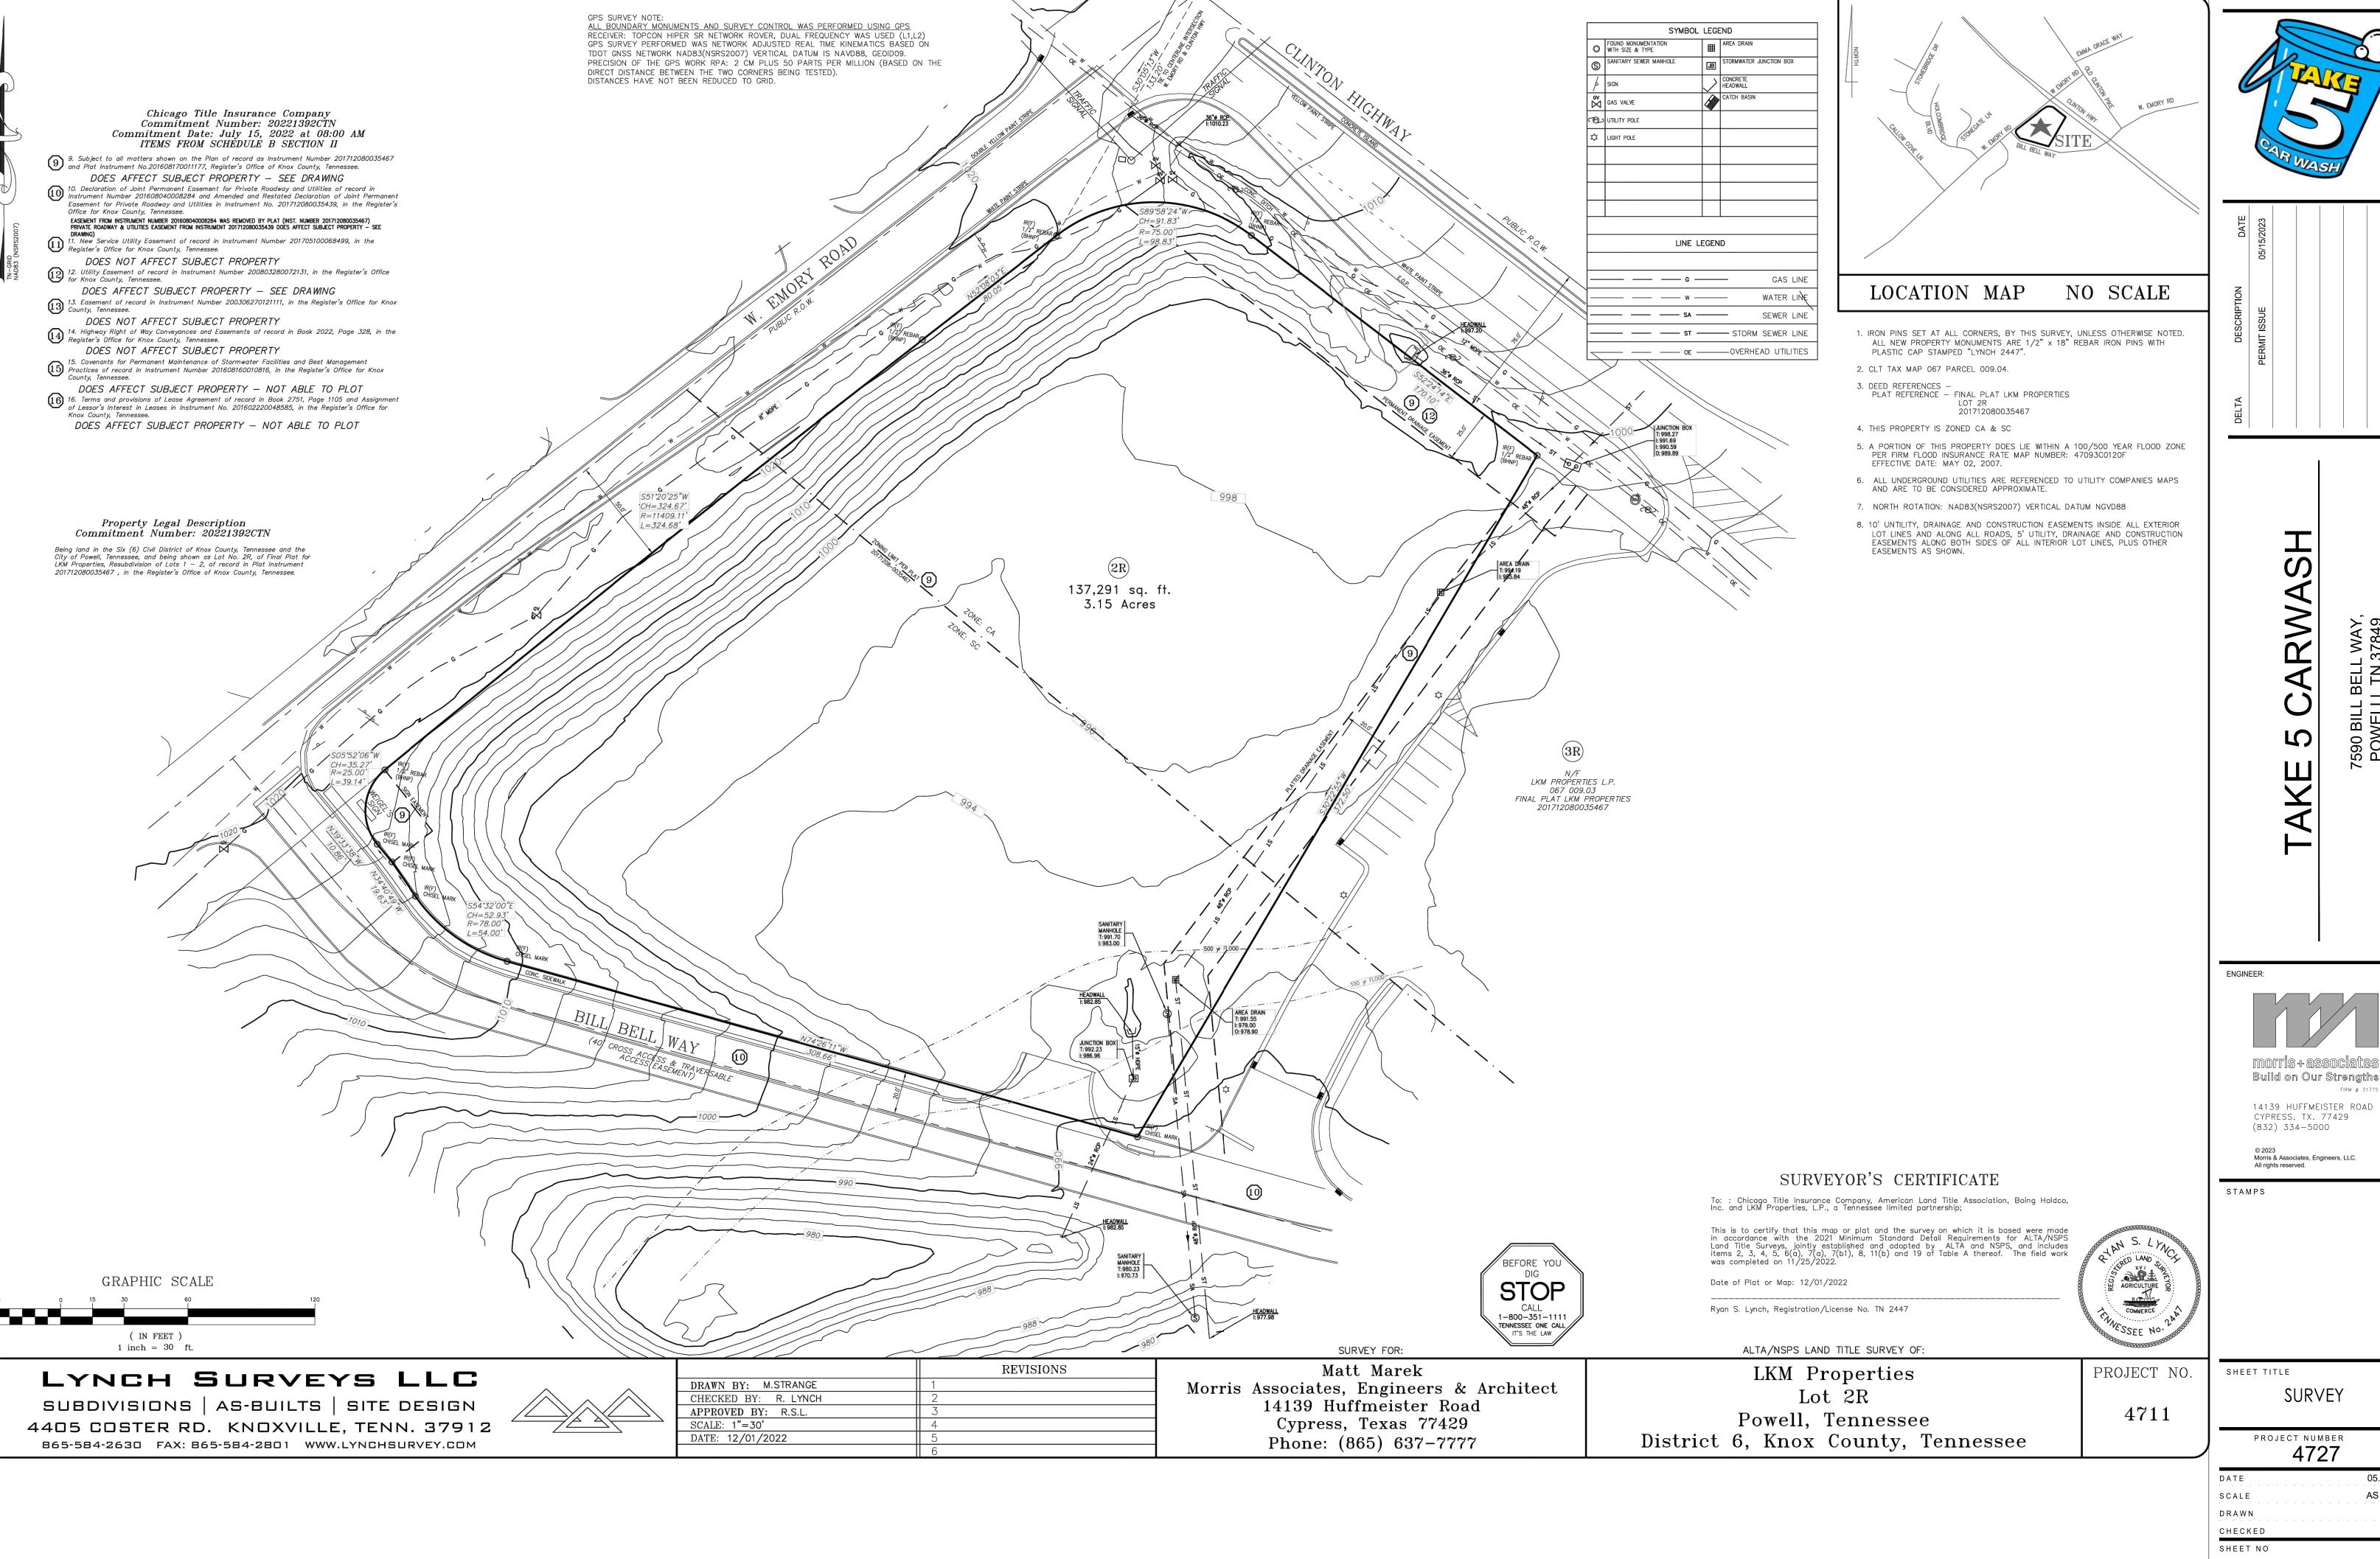


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SURVEY

PROJECT NUMBER 4727


05.15.2023 AS NOTED



DRIVEWAY PROFILE

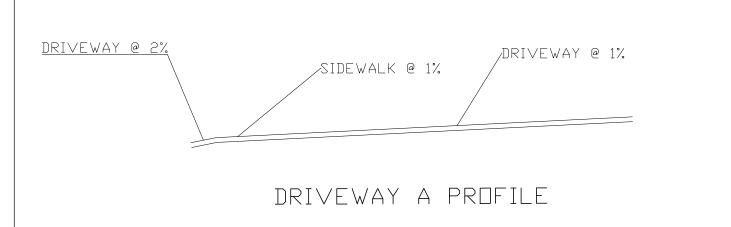HORIZONTAL SCALE: 1" = 30' VERTICAL SCALE : N.T.S.

	PLANT LIST		
KEY NUMBER	PLANT TYPE	QUANTITY	SIZE
А	NORWAY SPRUCE (PICEA ABIES)	30	
В	SYCAMORE (PLATANUS OCCIDENTALIS)	16	
С	SOFT TOUCH HOLLY (ILEX CRENATA)	103	

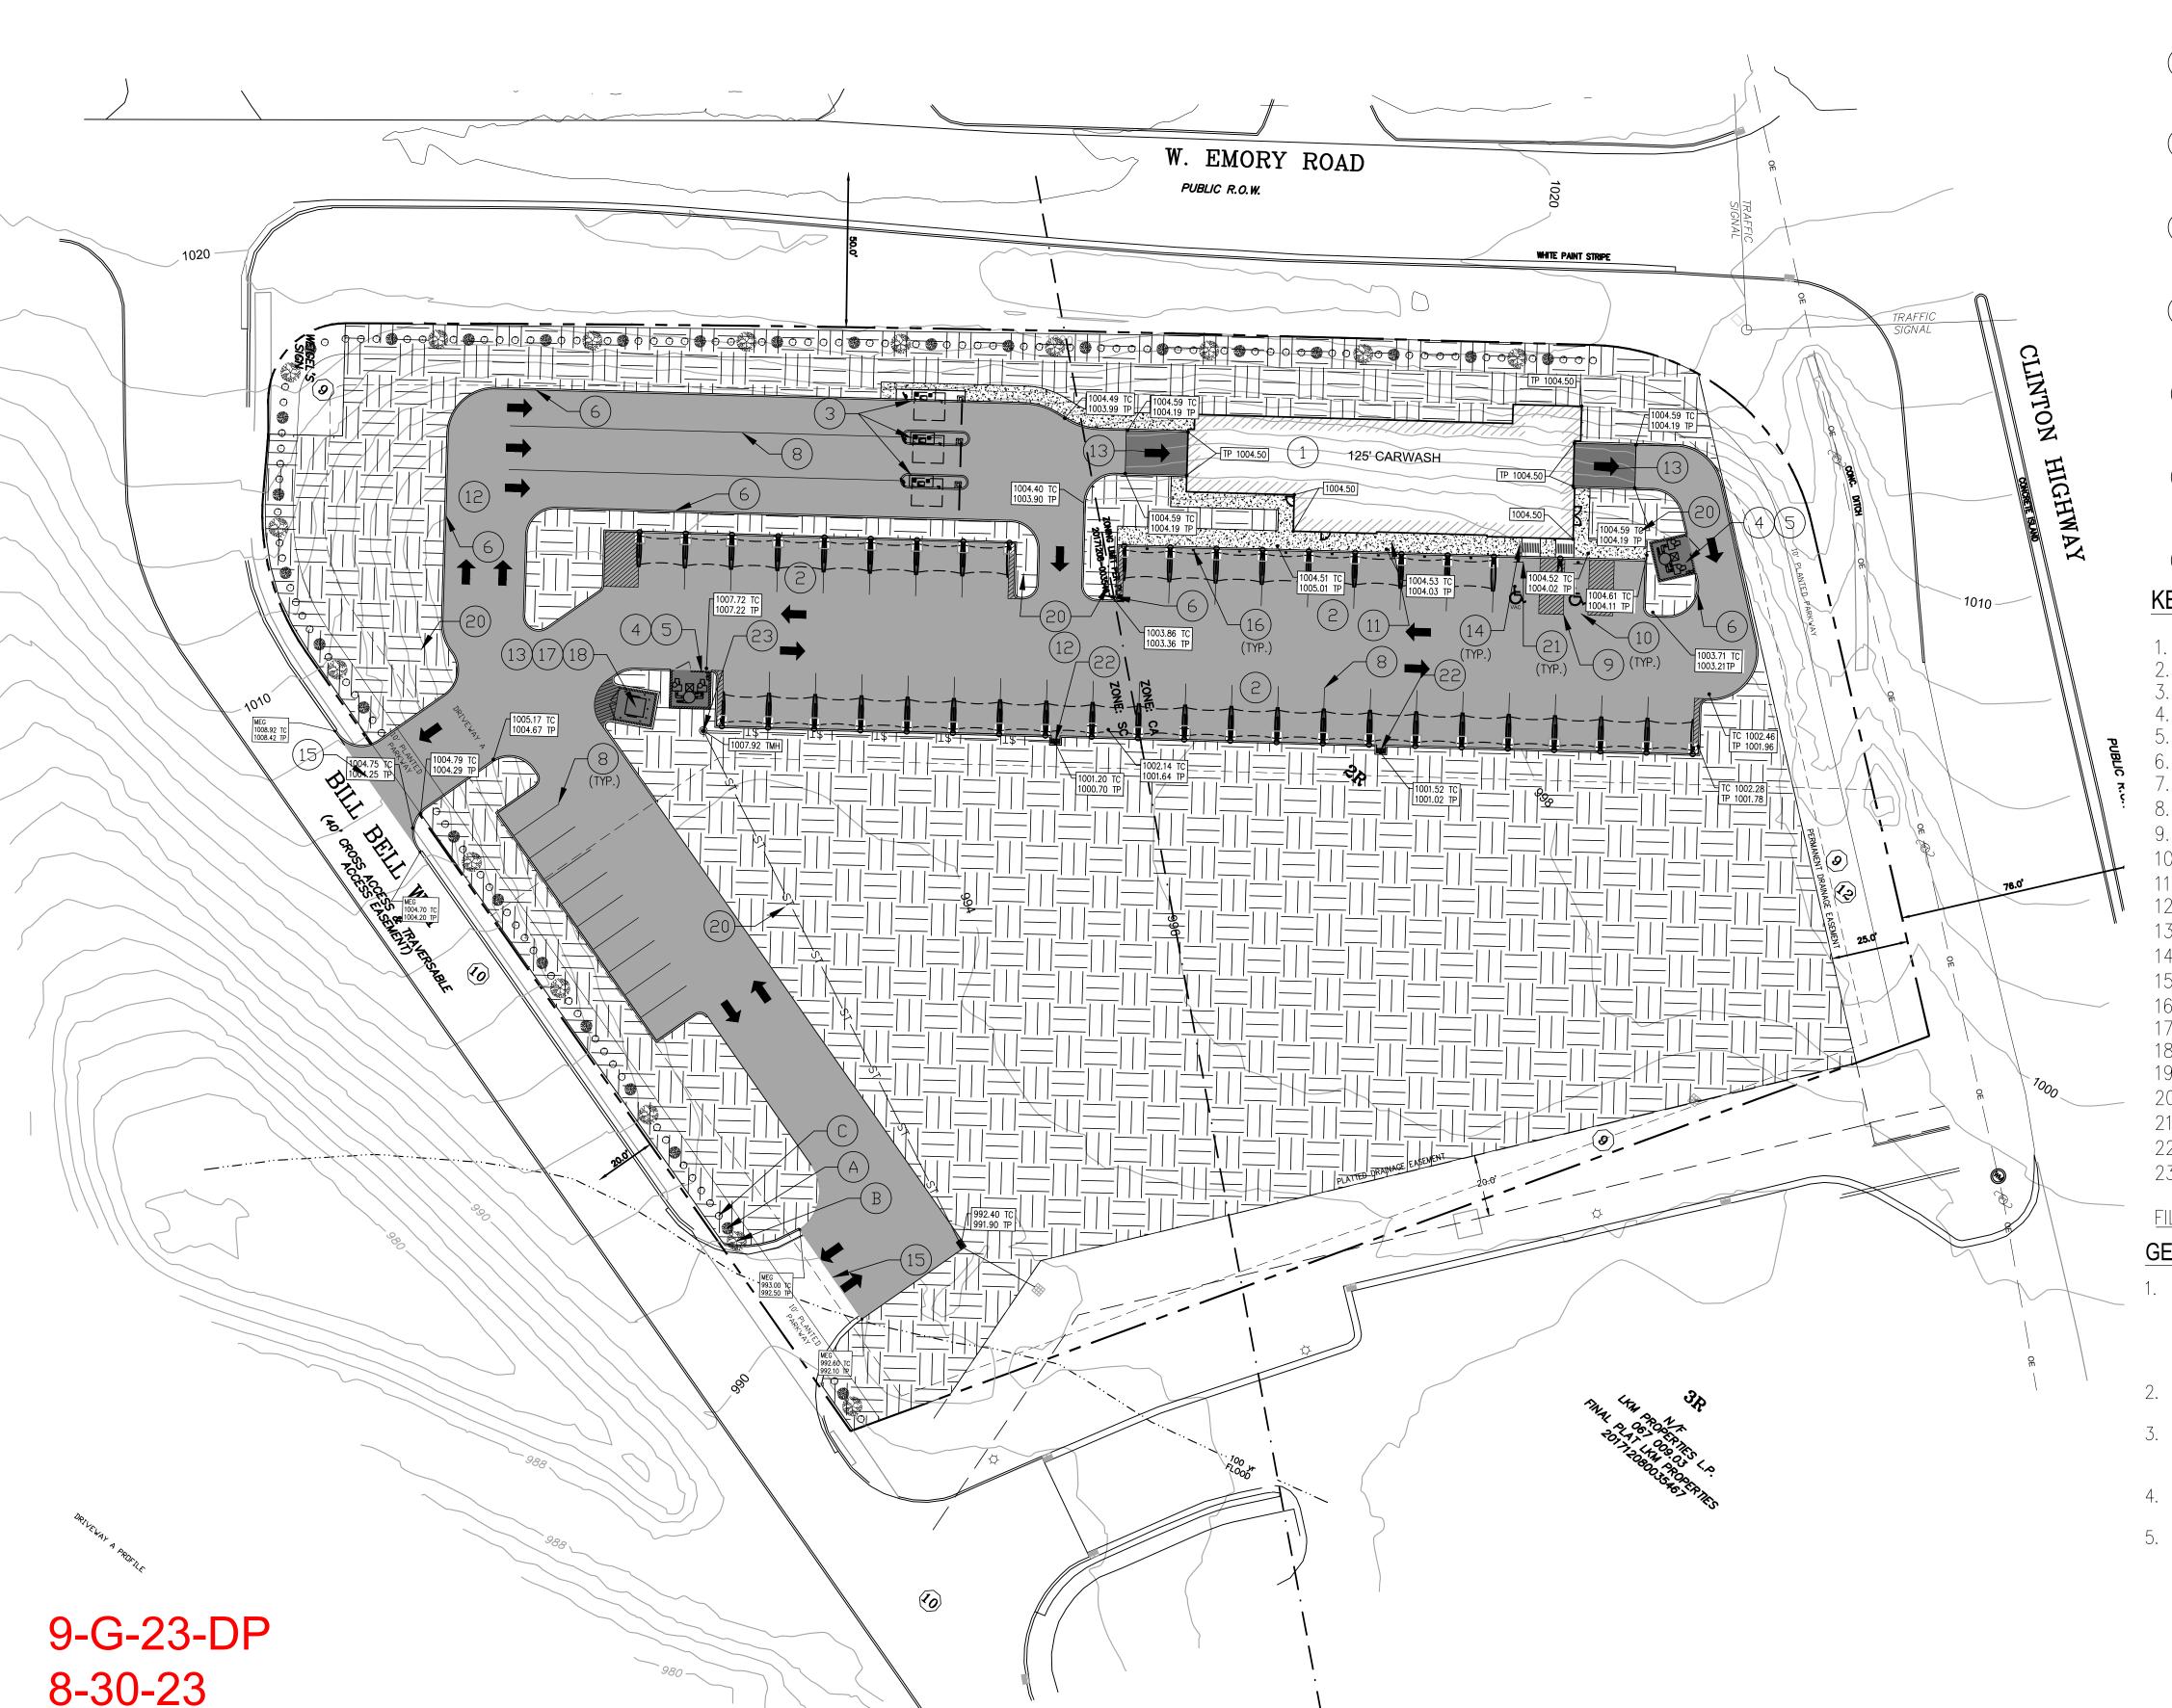

LEGEND:

PROPERTY LINE



TRAFFIC DIRECTION PAVEMENT MARKINGS






BUILDING SETBACK



BUILDING

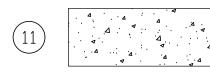

CONCRETE SIDEWALK




STANDARD DUTY REINFORCED CONCRETE

PAVEMENT



HEAVY DUTY REINFORCED CONCRETE PAVEMENT

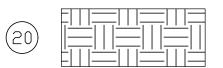

GRASS (SOD)







KEY SCHEDULE:

1. AUTOMATED CARWASH BUILDING; REF. ARCH AND STRUCTURAL DWGS

6" CONCRETE CURB AND GUTTER; REF DTL 9/C7.0. SEE ALSO NOTE 6

7. BUSINESS SIGN; REF SIGN VENDOR DWGS

8. 4" WIDE WHITE PAVEMENT STRIPING

9. 4" WIDE WHITE PAVEMENT STRIPING @ 45° ANGLE

10. HANDICAP ACCESSIBLE SPACE; REF DTL 1/C7.1

11. CONCRETE SIDEWALK; REF DTL 1/C7.0

12. STANDARD DUTY CONCRETE PAVÉMENT;

13. HEAVY DUTY CONCRETE PAVEMENT; REF DTL 4/C7.0

14. HANDICAP ACCESSIBLE RAMP; REF DTL 4/C7.1

15. LIMITS OF NEW CONCRETE PAVEMENT; REF DTL 7/C7.0

16. 6" BOLLARD; REF DTL 5/C7.1

17. DUMPSTER; REF ARCH DWGS

18. DUMPSTER ENCLOSURE; REF ARCH & STRUCTURAL DWGS 19. AREA LIGHT; REF MEP DWGS

20. GRASS (SOD); REF SHEET L1.0

21. HANDICAP ACCESSIBLE SIGN ON BOLLARD; REF DTL 3/C7.1

22. CURB INLET; REF DTL 1/C7.2

23. STORM MANHOLE; REF DTL2/C7.2

FILE NUMBER: 9-G-23-DP


GENERAL INFO:

- 1. THE EXISTING SITE LAYOUT AS SHOWN ON THESE DRAWINGS HAS BEEN DEVELOPED FROM EXISTING DRAWINGS WHICH MAY NOT REFLECT ACTUAL FIELD CONDITIONS. THE CONTRACTOR SHALL VERIFY THESE DRAWINGS WITH ACTUAL SITE CONDITIONS AND NOTIFY THE ARCHITECT OF ANY INCONSISTENCIES BETWEEN THESE DRAWINGS AND ACTUAL CONDITIONS PRIOR TO BEGINNING CONSTRUCTION.
- 2. THE CONTRACTOR SHALL CONFORM TO ALL LOCAL CODES AND OBTAIN ALL PERMITS PRIOR TO BEGINNING WORK.
- 3. PROVIDE A SMOOTH TRANSITION BETWEEN EXISTING PAVEMENT AND ANY NEW PAVEMENT FIELD ADJUSTMENT OF FINAL GRADES MAY BE NECESSARY. INSTALL ALL NECESSARY UTILITIES PRIOR TO INSTALLATION OF NEW PAVEMENT.
- 4. ALL NEW CONCRETE WALKS AND PADS SHALL HAVE A BROOM FINISH. ALL CONCRETE SHALL BE A MINIMUM 3000 PSI UNLESS OTHERWISE NOTED. 5. ALL DAMAGE TO EXISTING PAVEMENT TO REMAIN WHICH RESULTS FROM NEW

CONSTRUCTION SHALL BE REPLACED WITH LIKE MATERIALS AT CONTRACTOR'S EXPENSE. EXCESS MATERIAL SHALL BE DISPOSED OF OFF THE OWNER'S PROPERTY AT NO ADDITIONAL COST.

> SITE PLAN SCALE : 1" = 30'



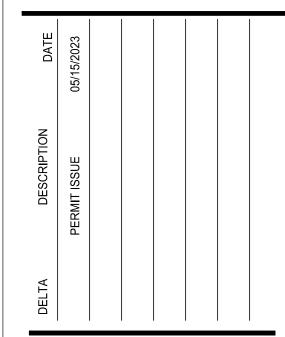



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STAMPS

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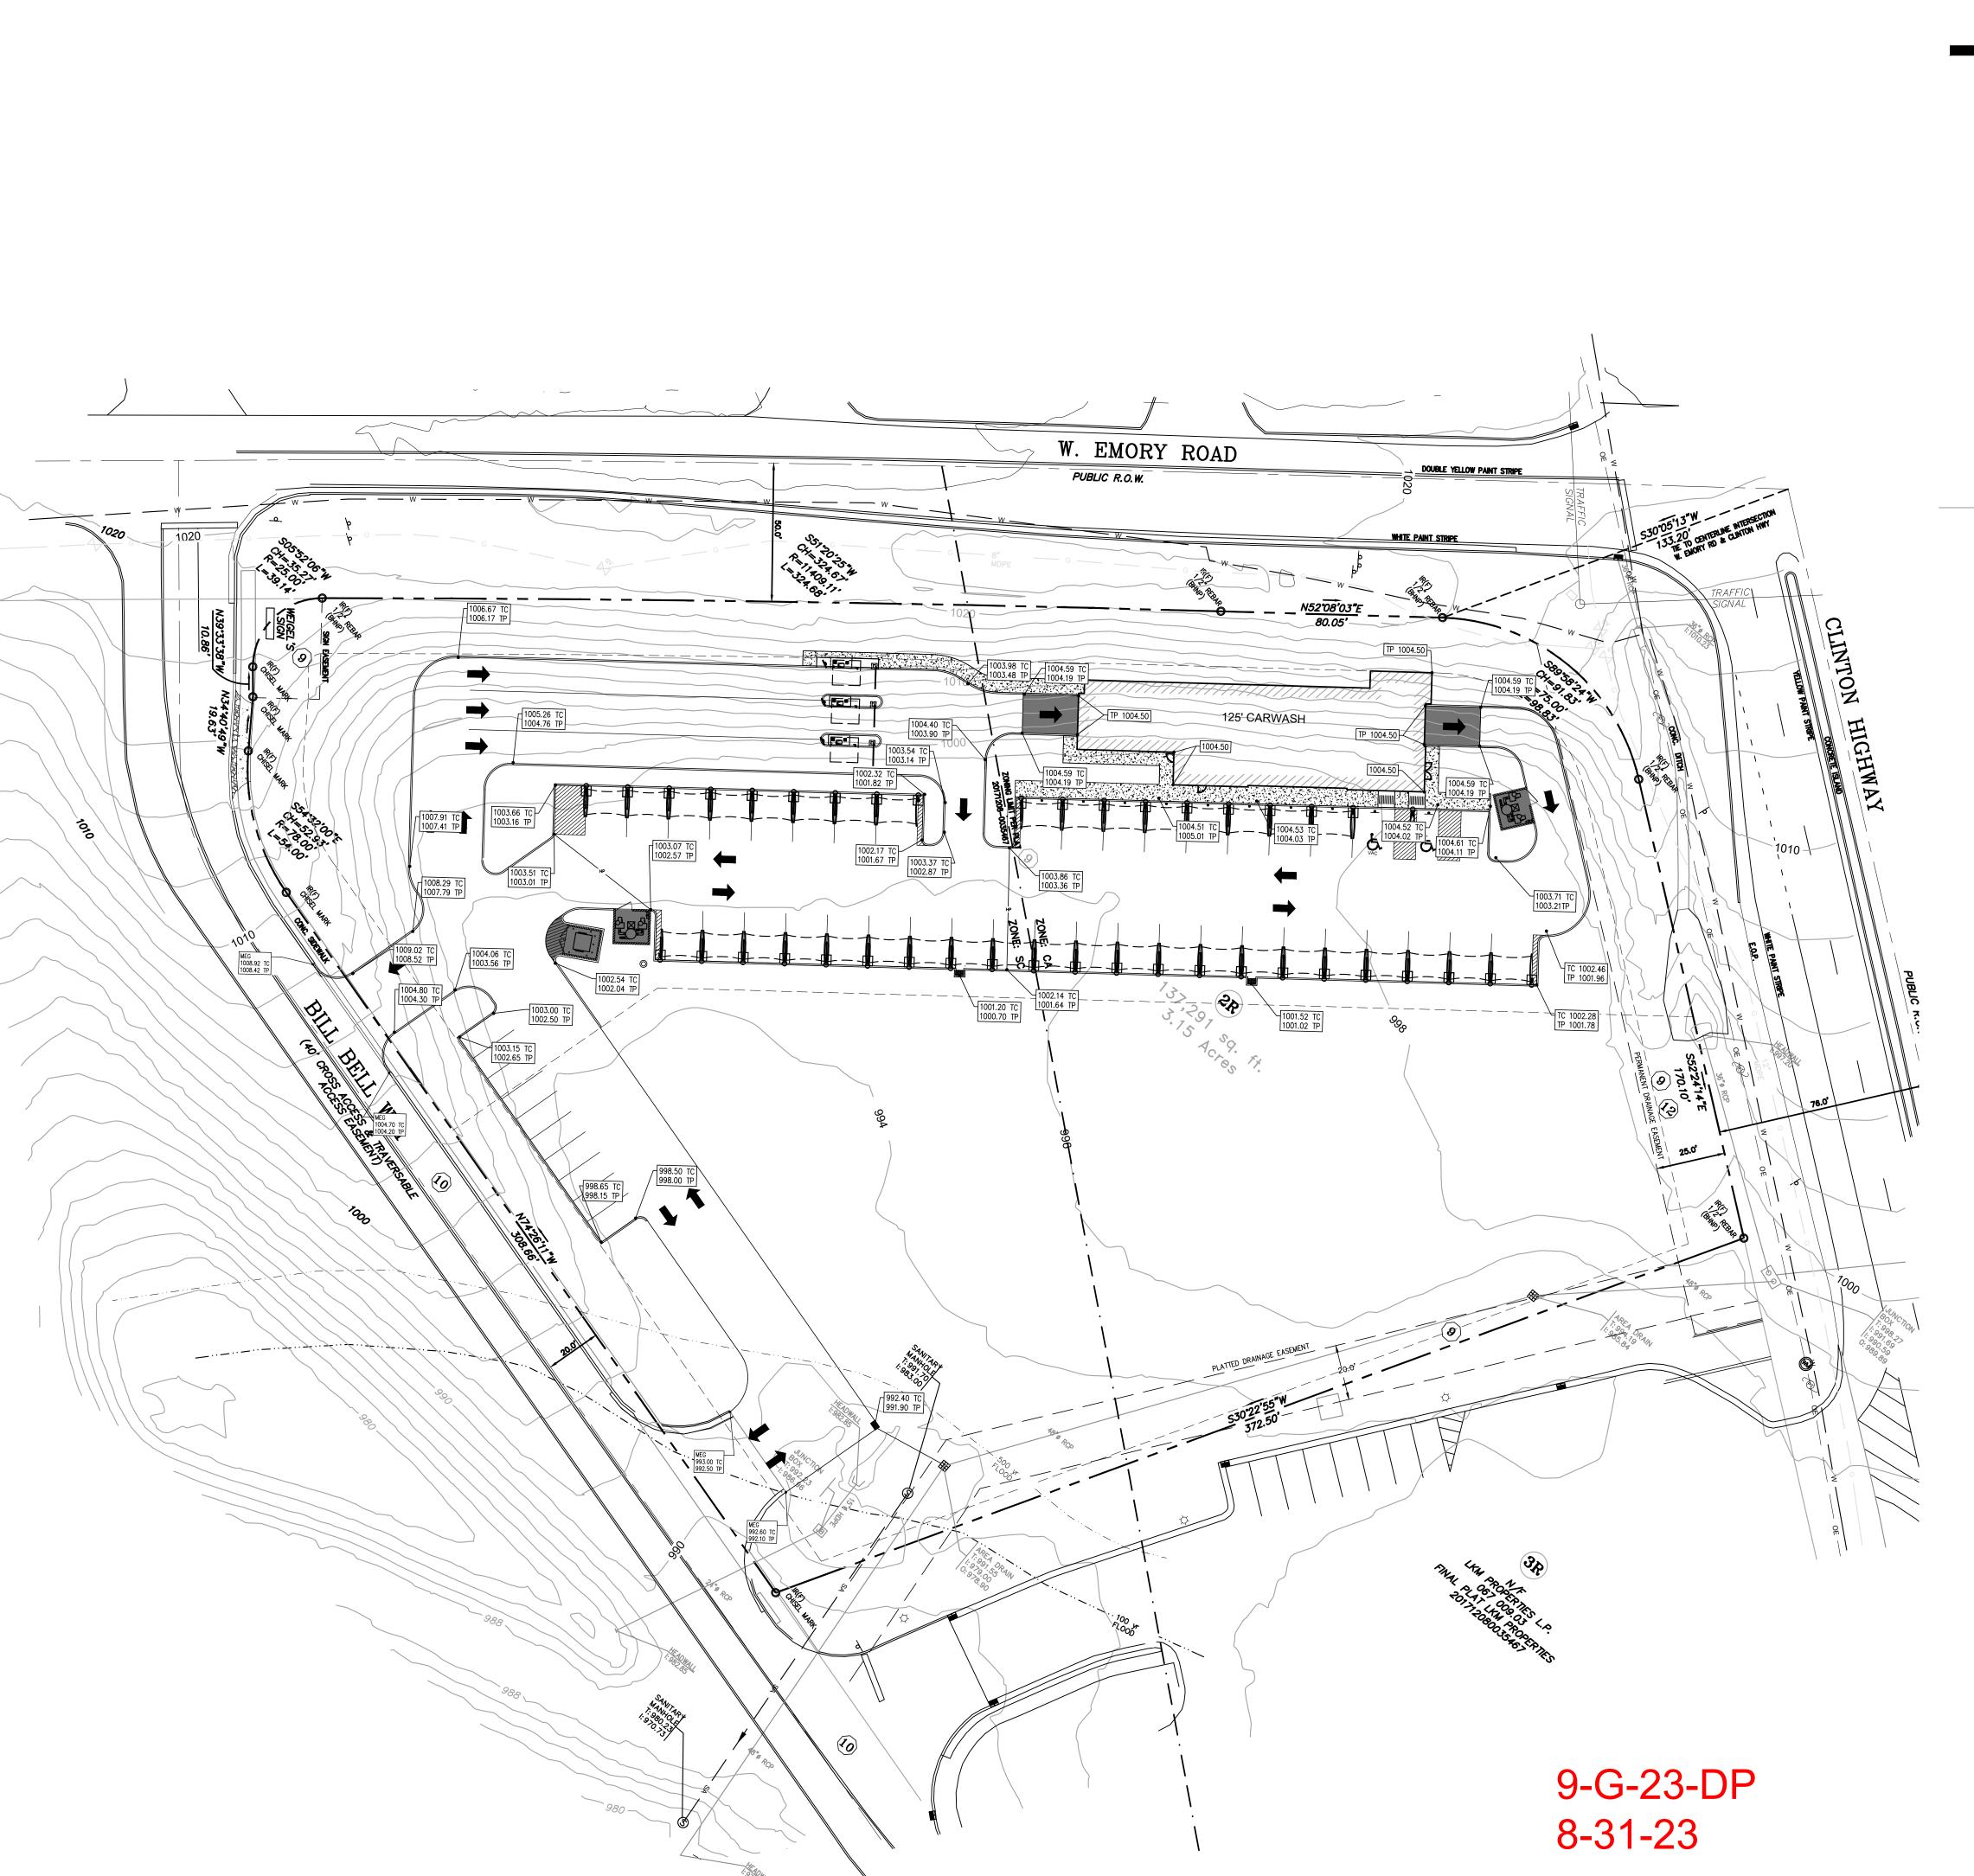
SHEET TITLE

SITE PLAN

PROJECT NUMBER 4727 05.15.2023 SCALE AS NOTED DRAWN

CHECKED SHEET NO

C2.0



LEGEND:

PROPERTY LINE MATCH EXISTING GRADE 110.00 W/ APPROXIMATE ELEV. MATCH EXISTING CURB MEC EXISTING GRADE 100.0 PROPOSED GRADE 100.0 TOP OF PAVEMENT TP TOP OF CURB TOP OF GRATE TOP OF INLET

TOP OF MANHOLE

EXIST. STORM PIPE

FLOW ARROW



- 1. CONTRACTOR TO VERIFY ALL GRADES PRIOR TO FORMWORK OR PLACEMENT OF REINFORCEMENT AND CONCRETE.
- 2. NO TREES SHALL BE REMOVED AND/OR VEGETATION DISTURBED EXCEPT AS NECESSARY FOR GRADING PURPOSES AND ONLY AS APPROVED BY AE.
- 3. TOPSOIL SHALL BE STRIPPED FROM ALL CUT AND FILL AREAS, STOCKPILED AND REDISTRIBUTED OVER GRADED AREAS TO A MINIMUM DEPTH OF 6 INCHES.
- 4. ALL NEW STRUCTURES AND EXISTING STRUCTURES SHALL HAVE SEDIMENT REMOVED BEFORE FINAL ACCEPTANCE.
- 5. NEW SPOT ELEVATIONS REPRESENT FINISHED GRADE, TOP OF FINISHED PAVEMENT AND TOP OF CONCRETE.
- CONTOUR LINES AND SPOT ELEVATIONS ARE THE RESULT OF A DETAILED GRADING DESIGN AND REFLECT A PLANNED INTENT WITH REGARD TO DRAINAGE. SHOULD THE CONTRACTOR HAVE ANY QUESTIONS OF THIS INTENT OR ANY PROBLEMS WITH CONTINUITY OF GRADES, THE ENGINEER SHOULD BE CONTACTED PRIOR TO BEGINNING WORK.
- 7. ALL CURBS SHALL BE BACK FILLED WITH TOP SOIL AND LANDSCAPED UNLESS NOTED OTHERWISE.
- 8. SIDEWALK TO DRAIN AWAY FROM BUILDING AT ALL LOCATIONS (2% MAX)

FILE NUMBER: 9-G-23-DP

GRADING SITE PLAN

SCALE : 1" = 30'



DATE	05/15/2023			
DESCRIPTION	PERMIT ISSUE			
DELTA				



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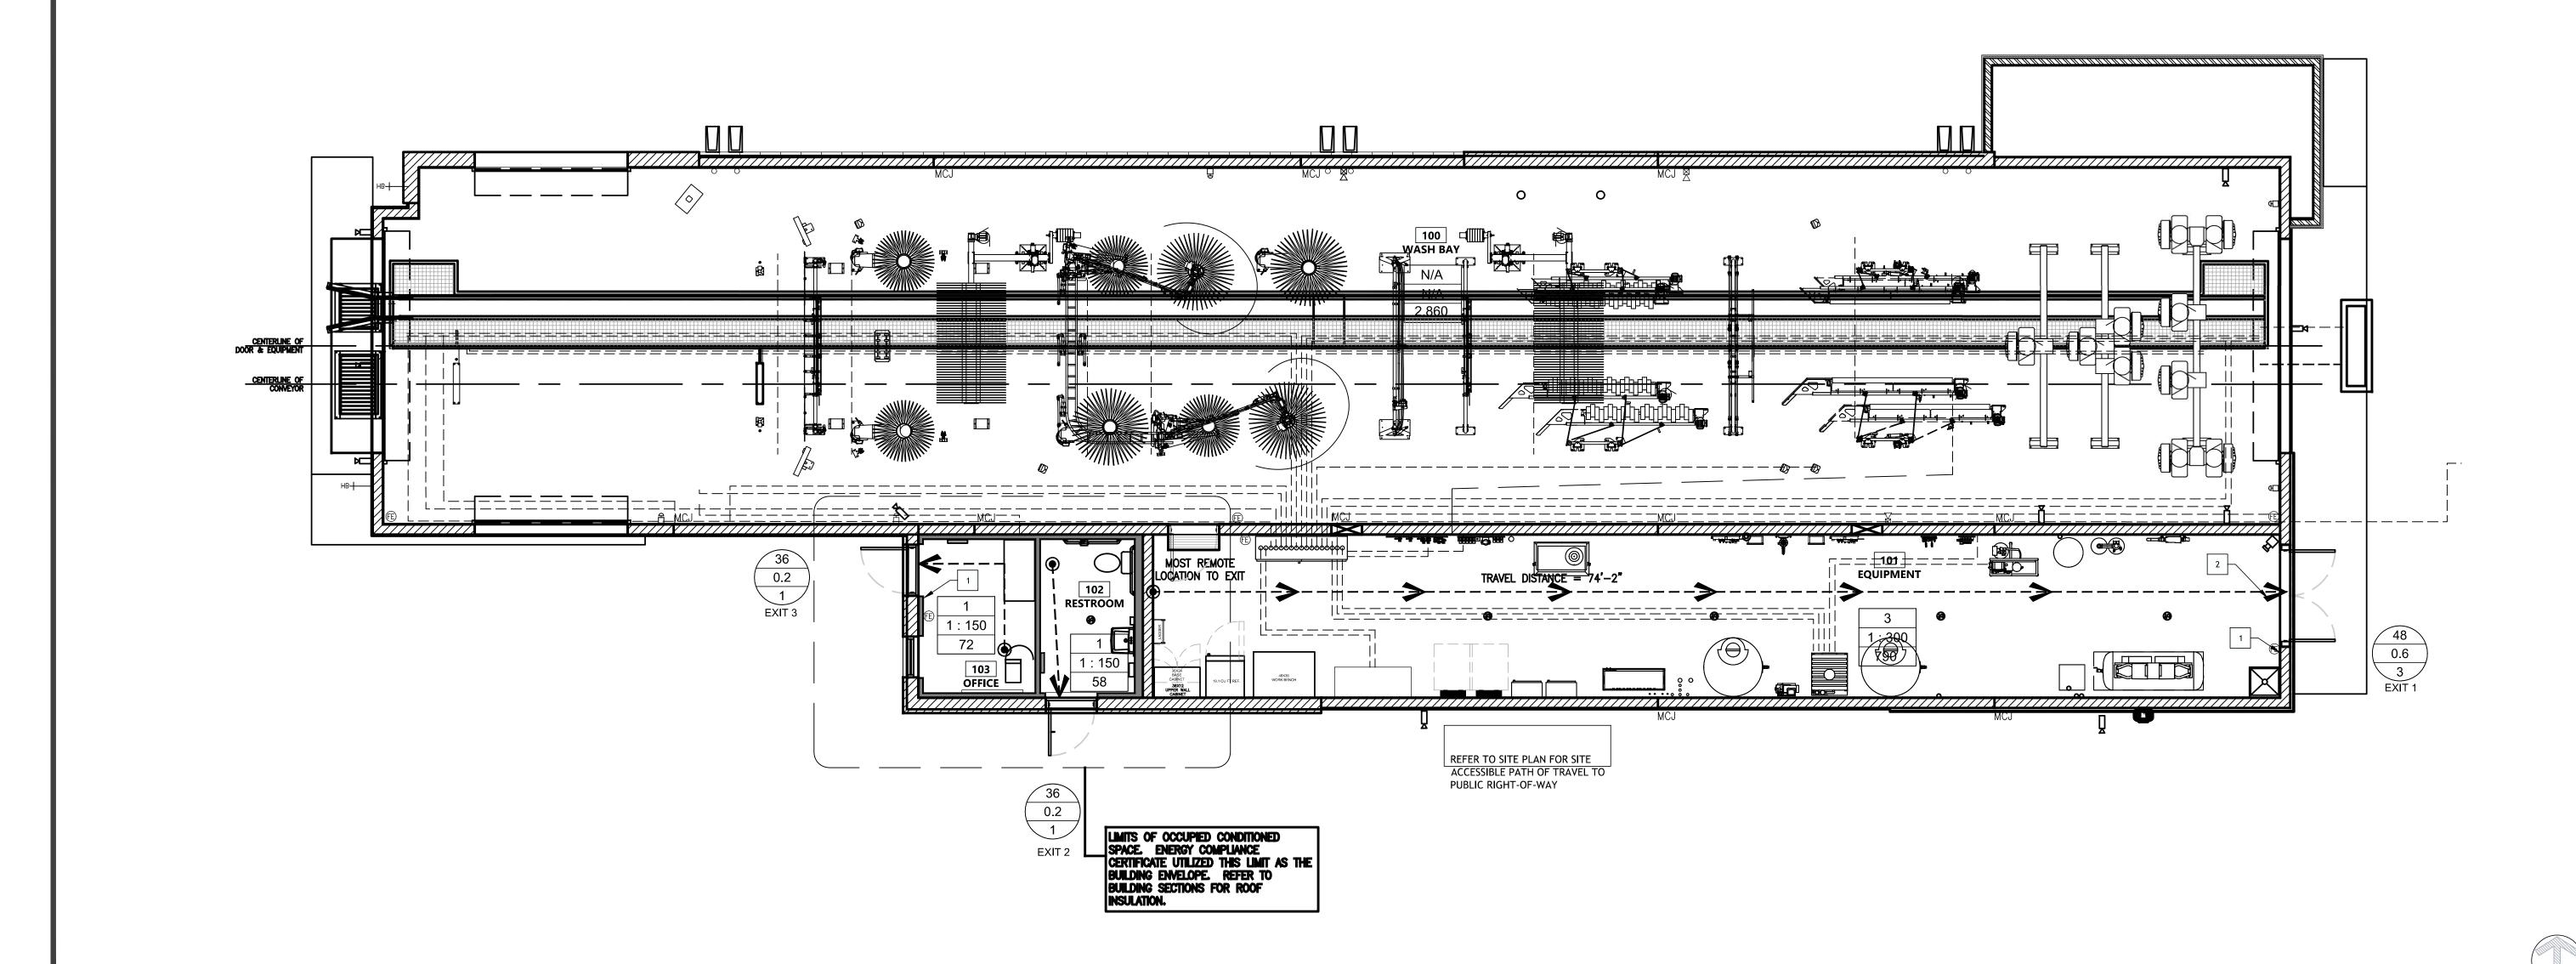
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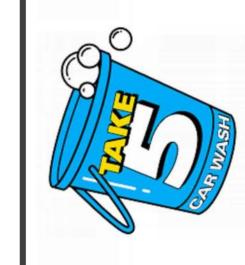
GRADING SITE PLAN

project number 4727
DATE 08.31.2
SCALE AS NOT
DRAWN
CHECKED
SHEET NO

C3.0

March Marc





CAR WASH BELL WAY TN 37849 7590 BILL TAKE

-	-	
REV	DATE	DESCRIPTION
		PERMIT ISSUE
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DRAW	/N BY:	TMN
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ARCH. PROJECT NO.:


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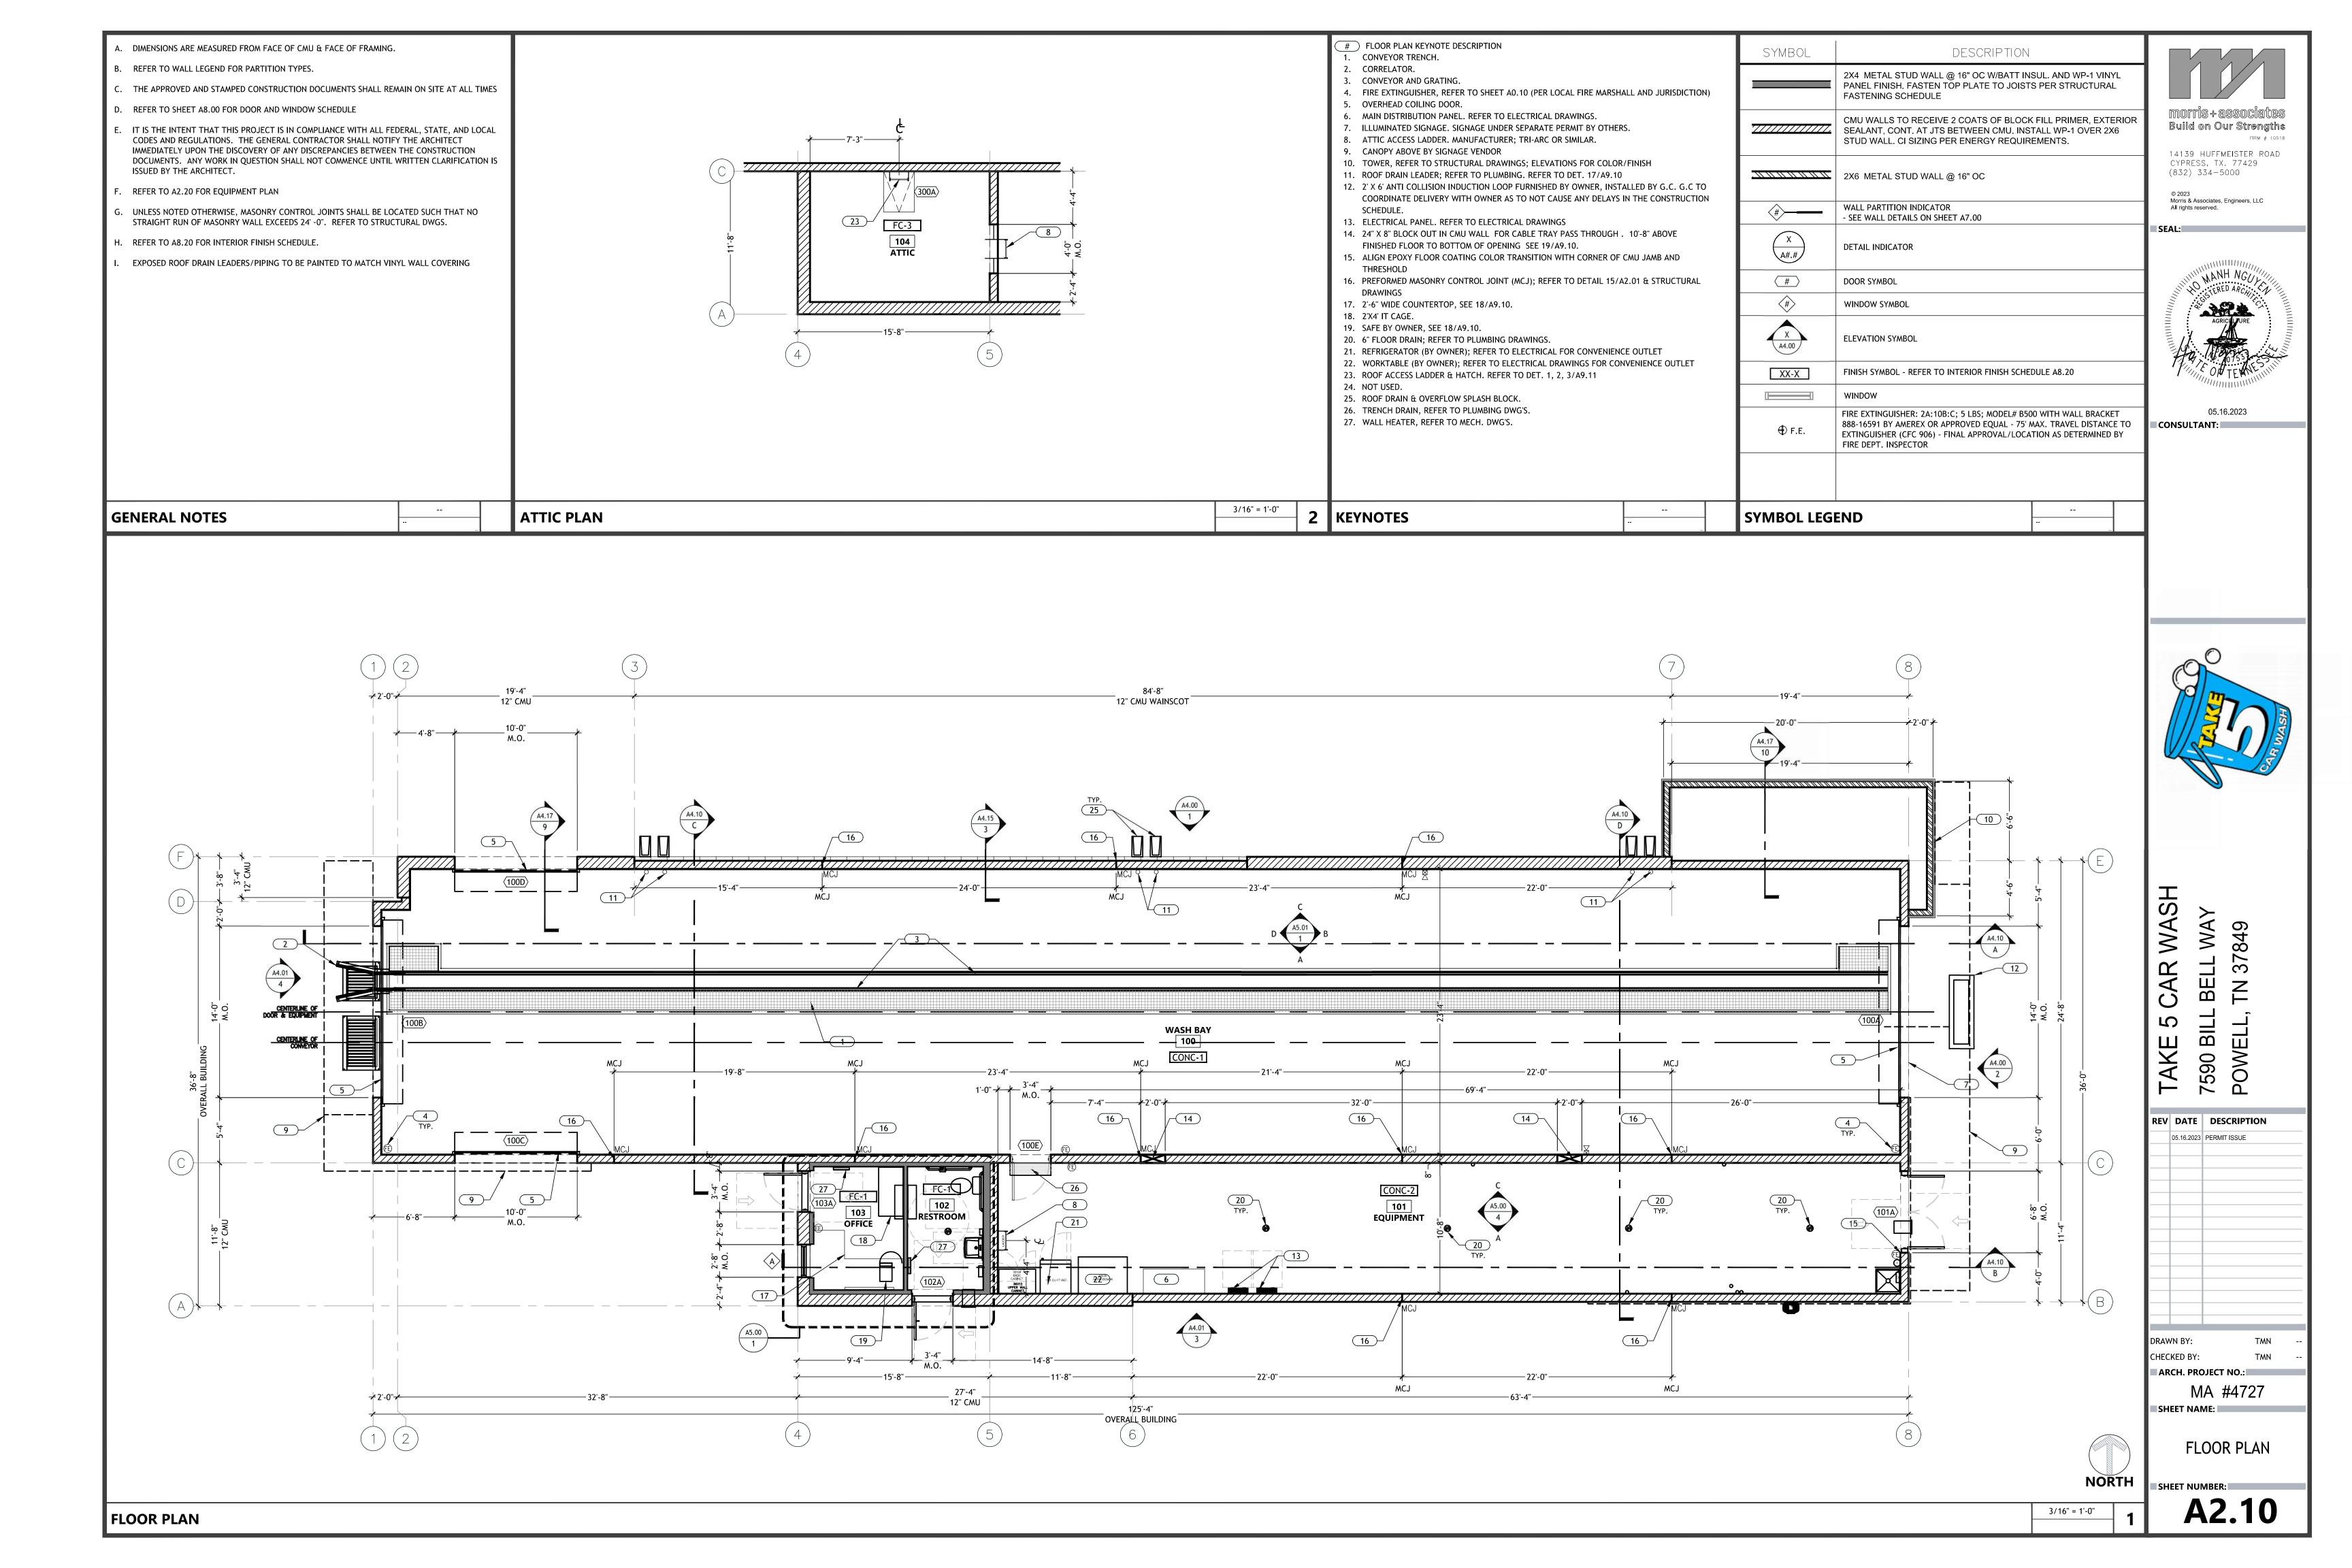
CODE AND EGRESS PLAN


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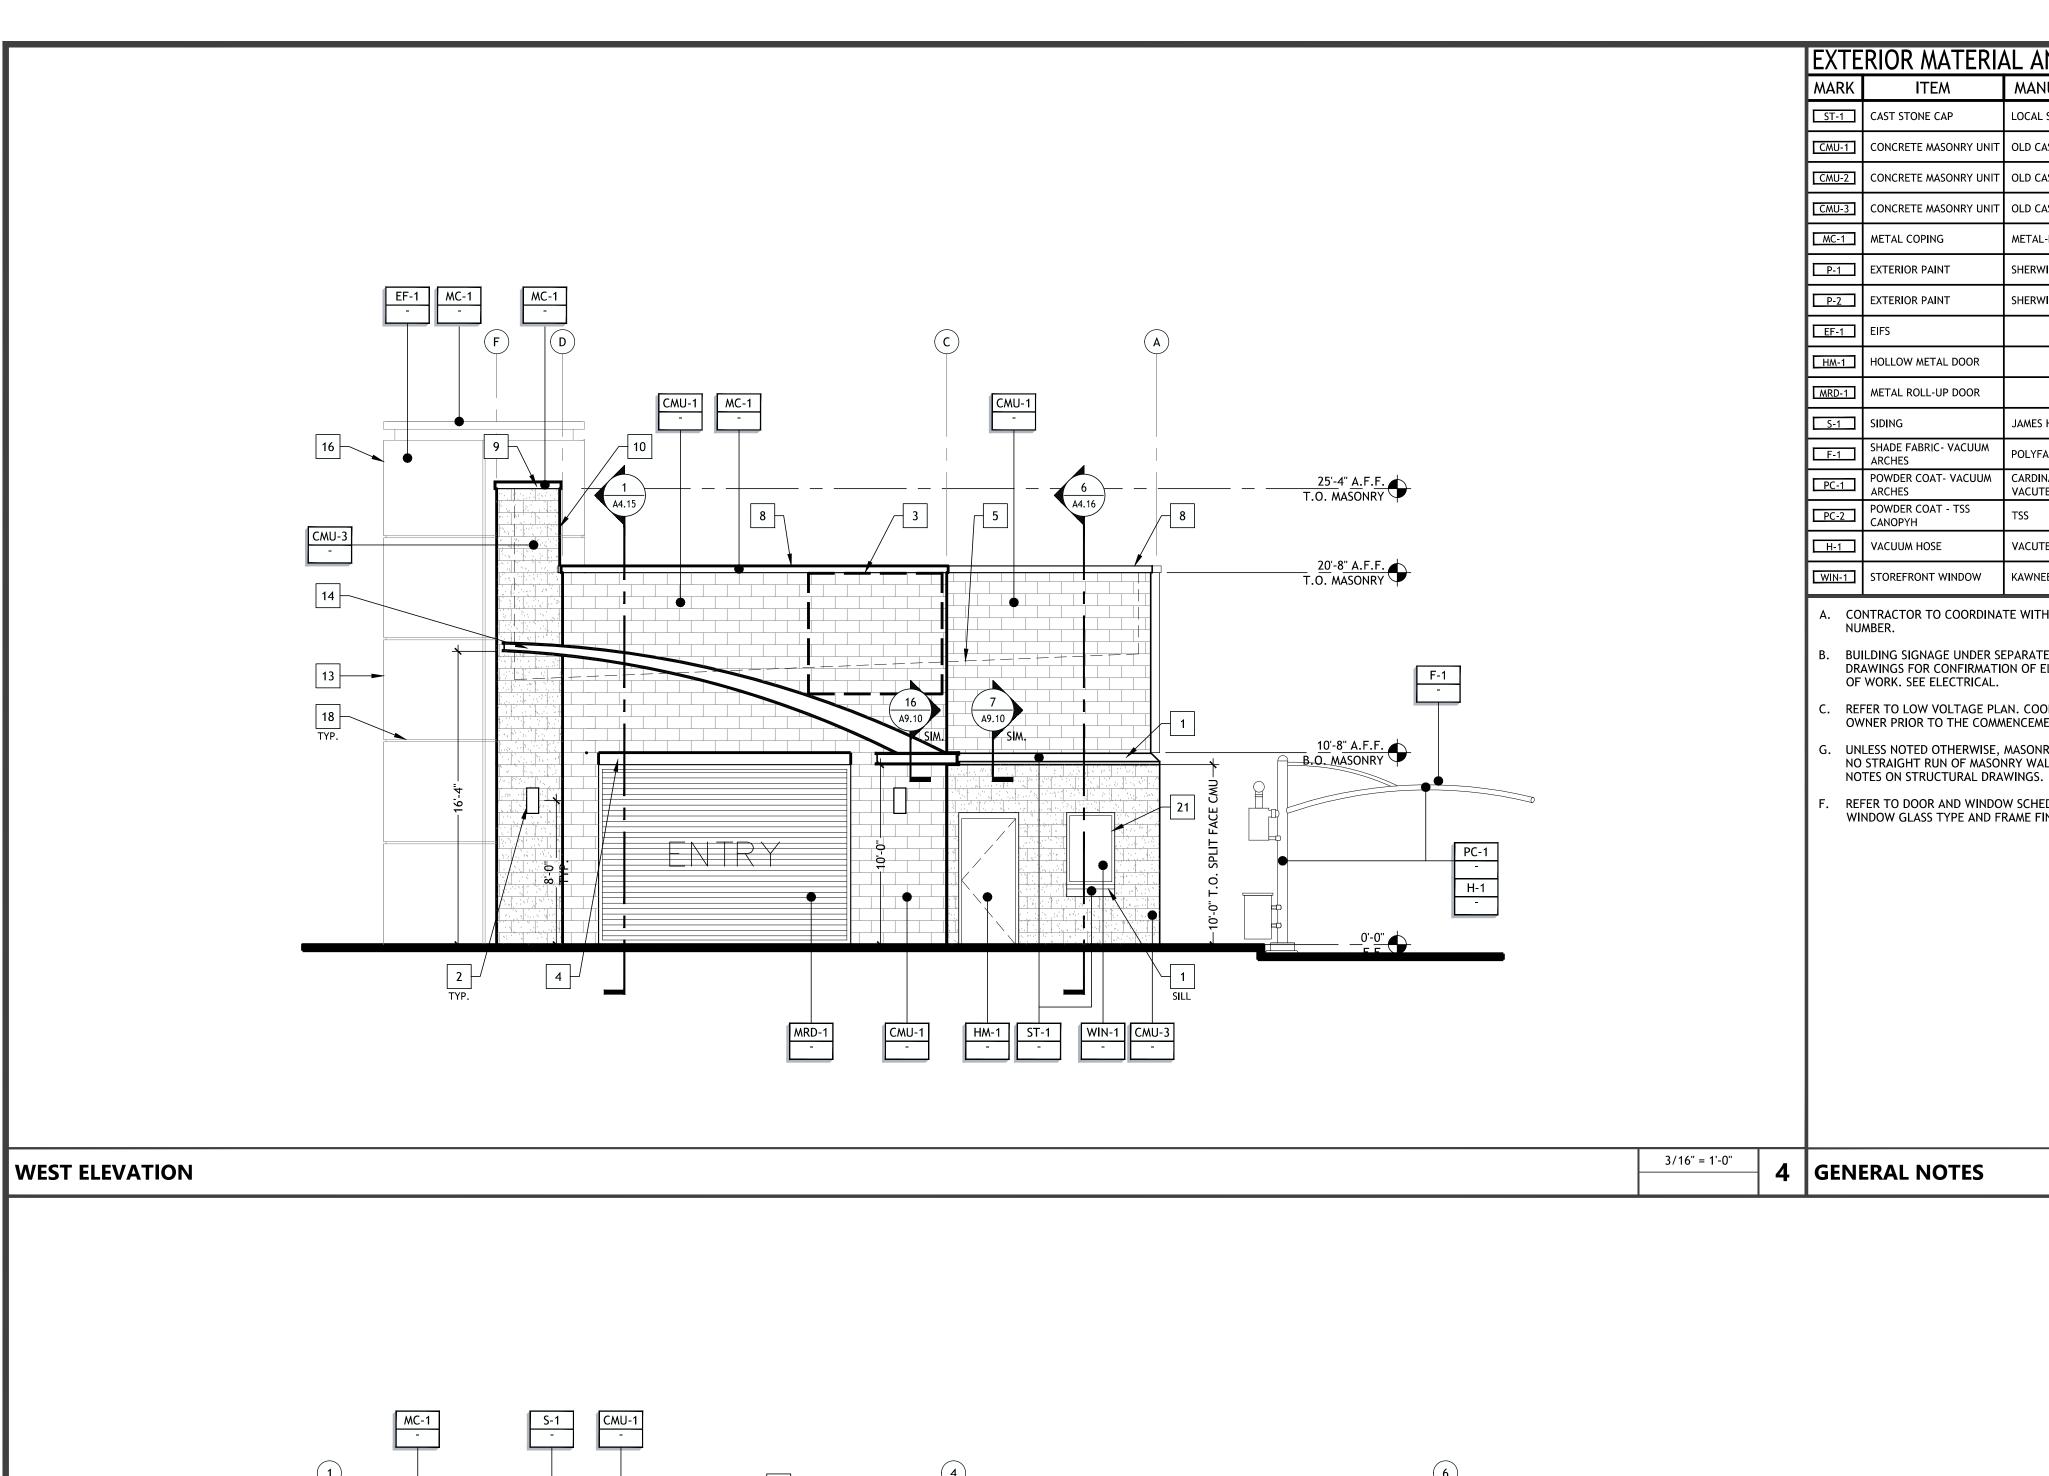
CODE AND EGRESS PLAN

3/16" = 1'-0"





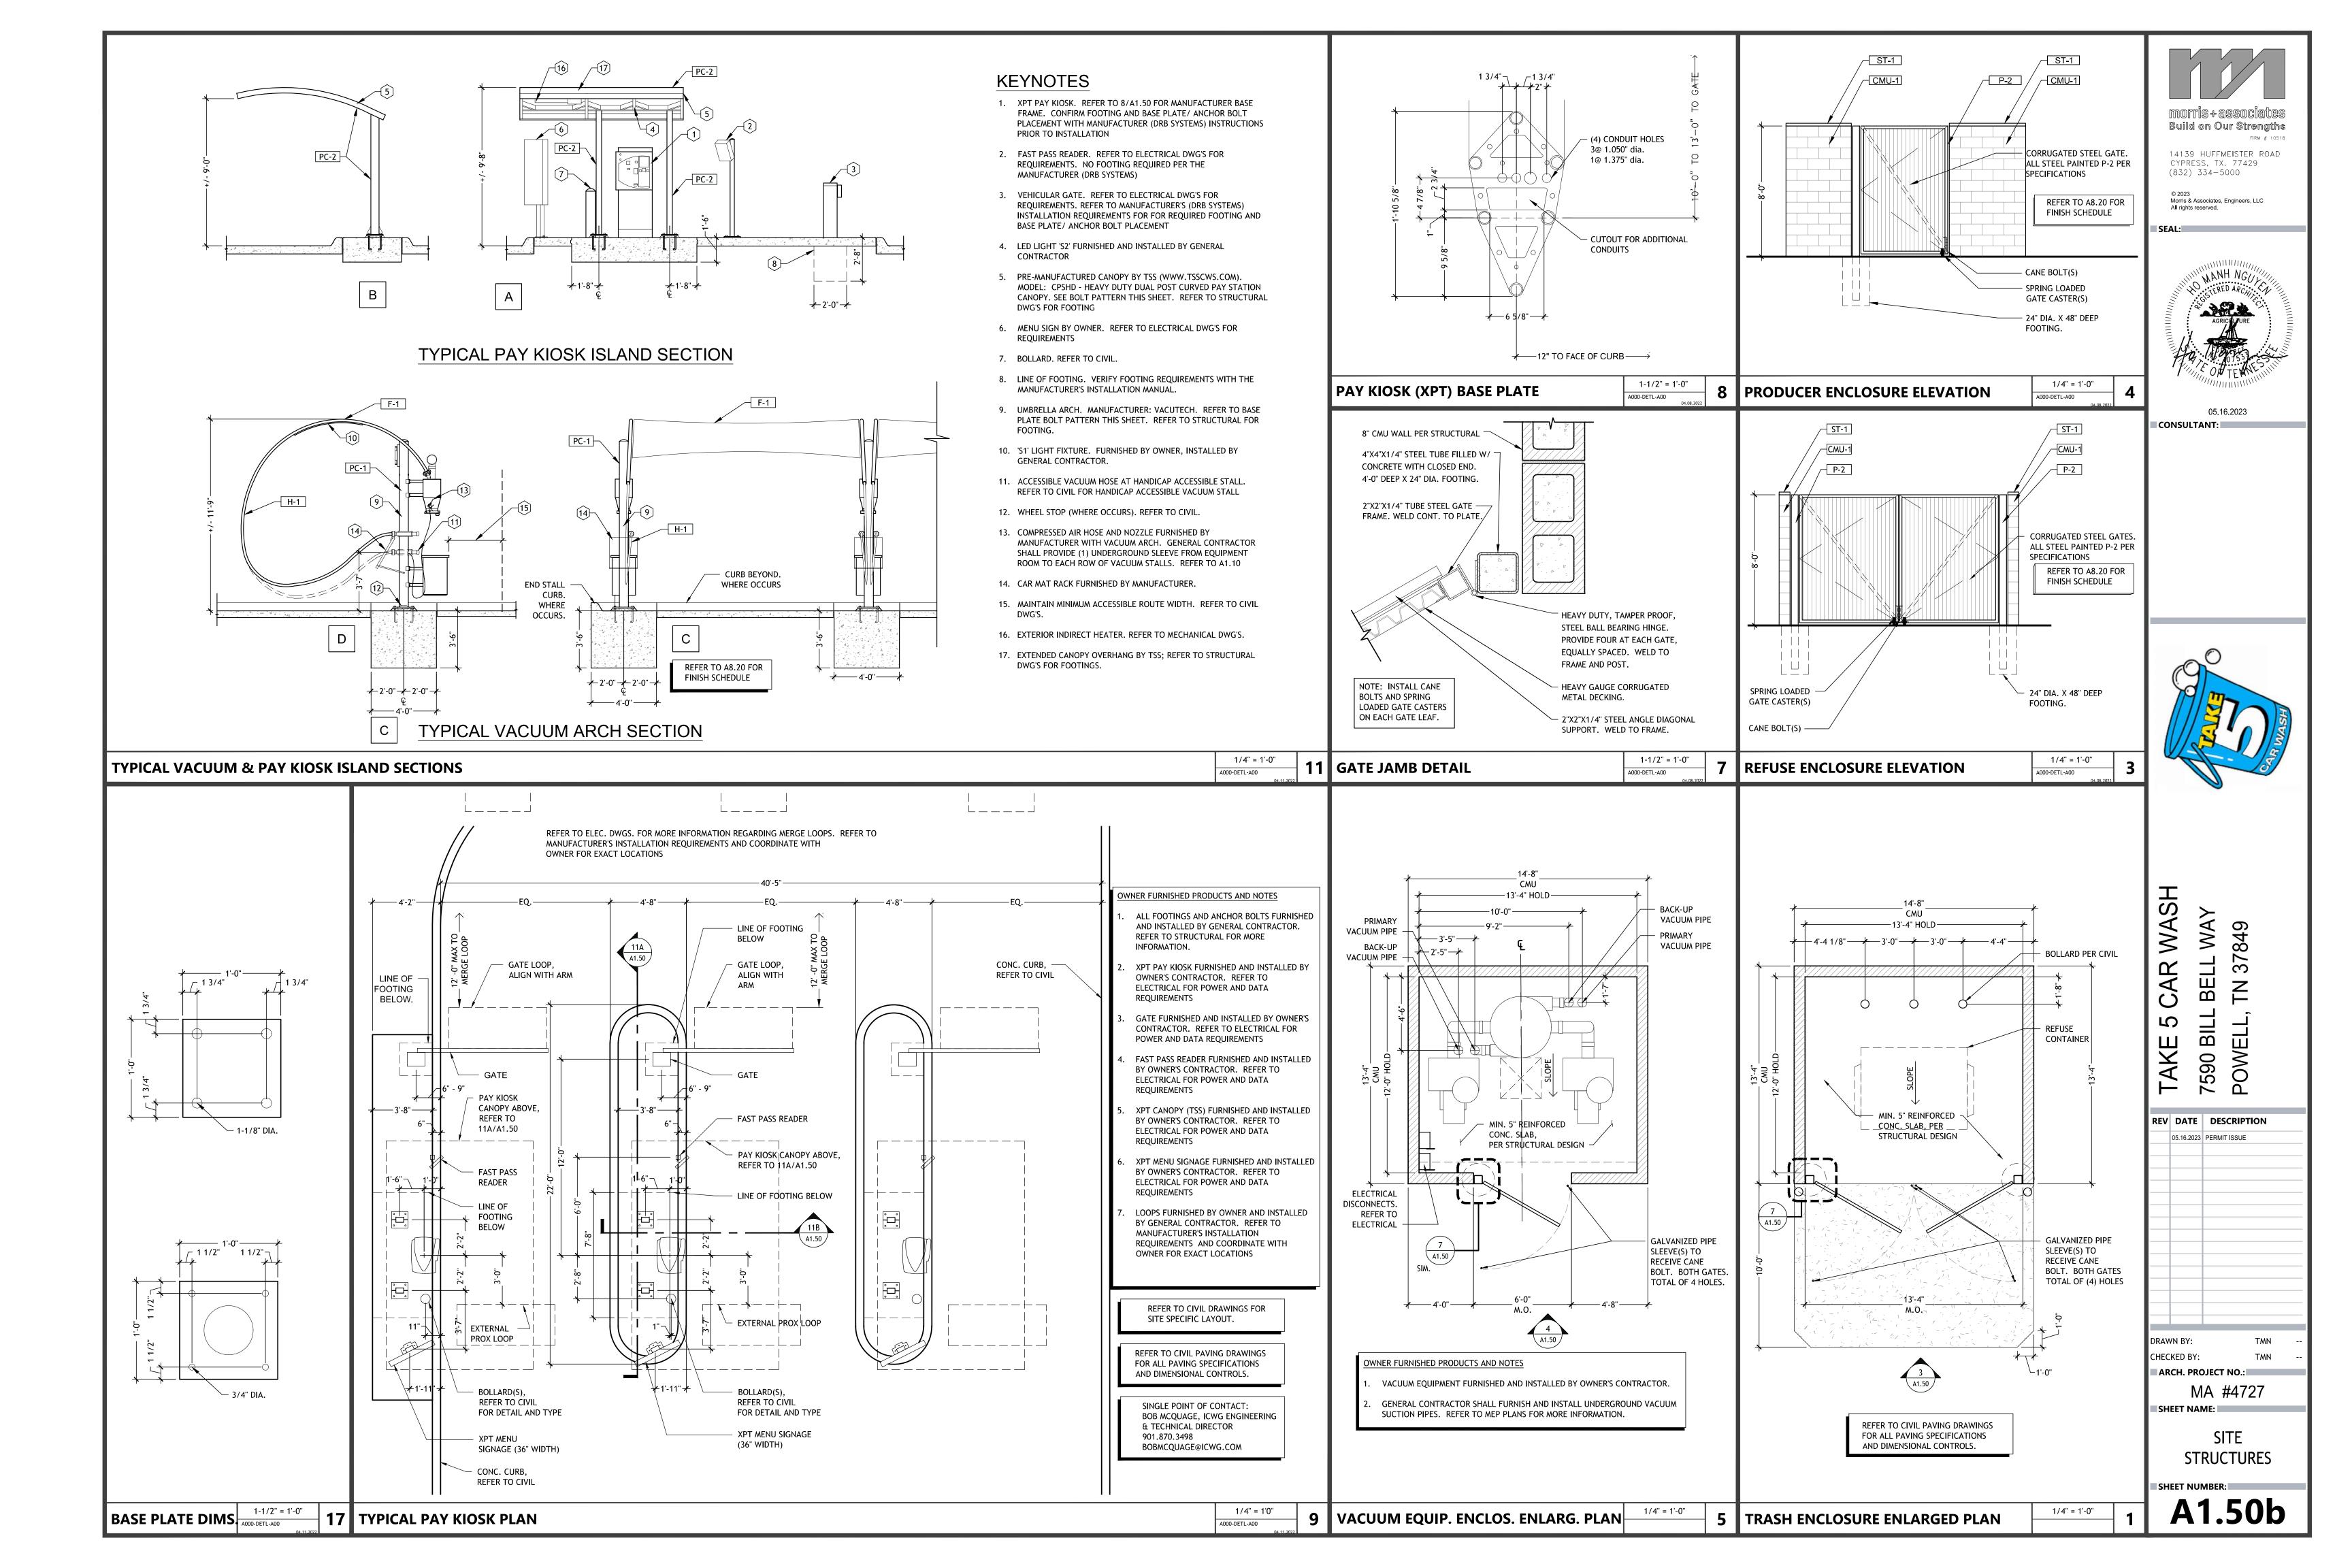

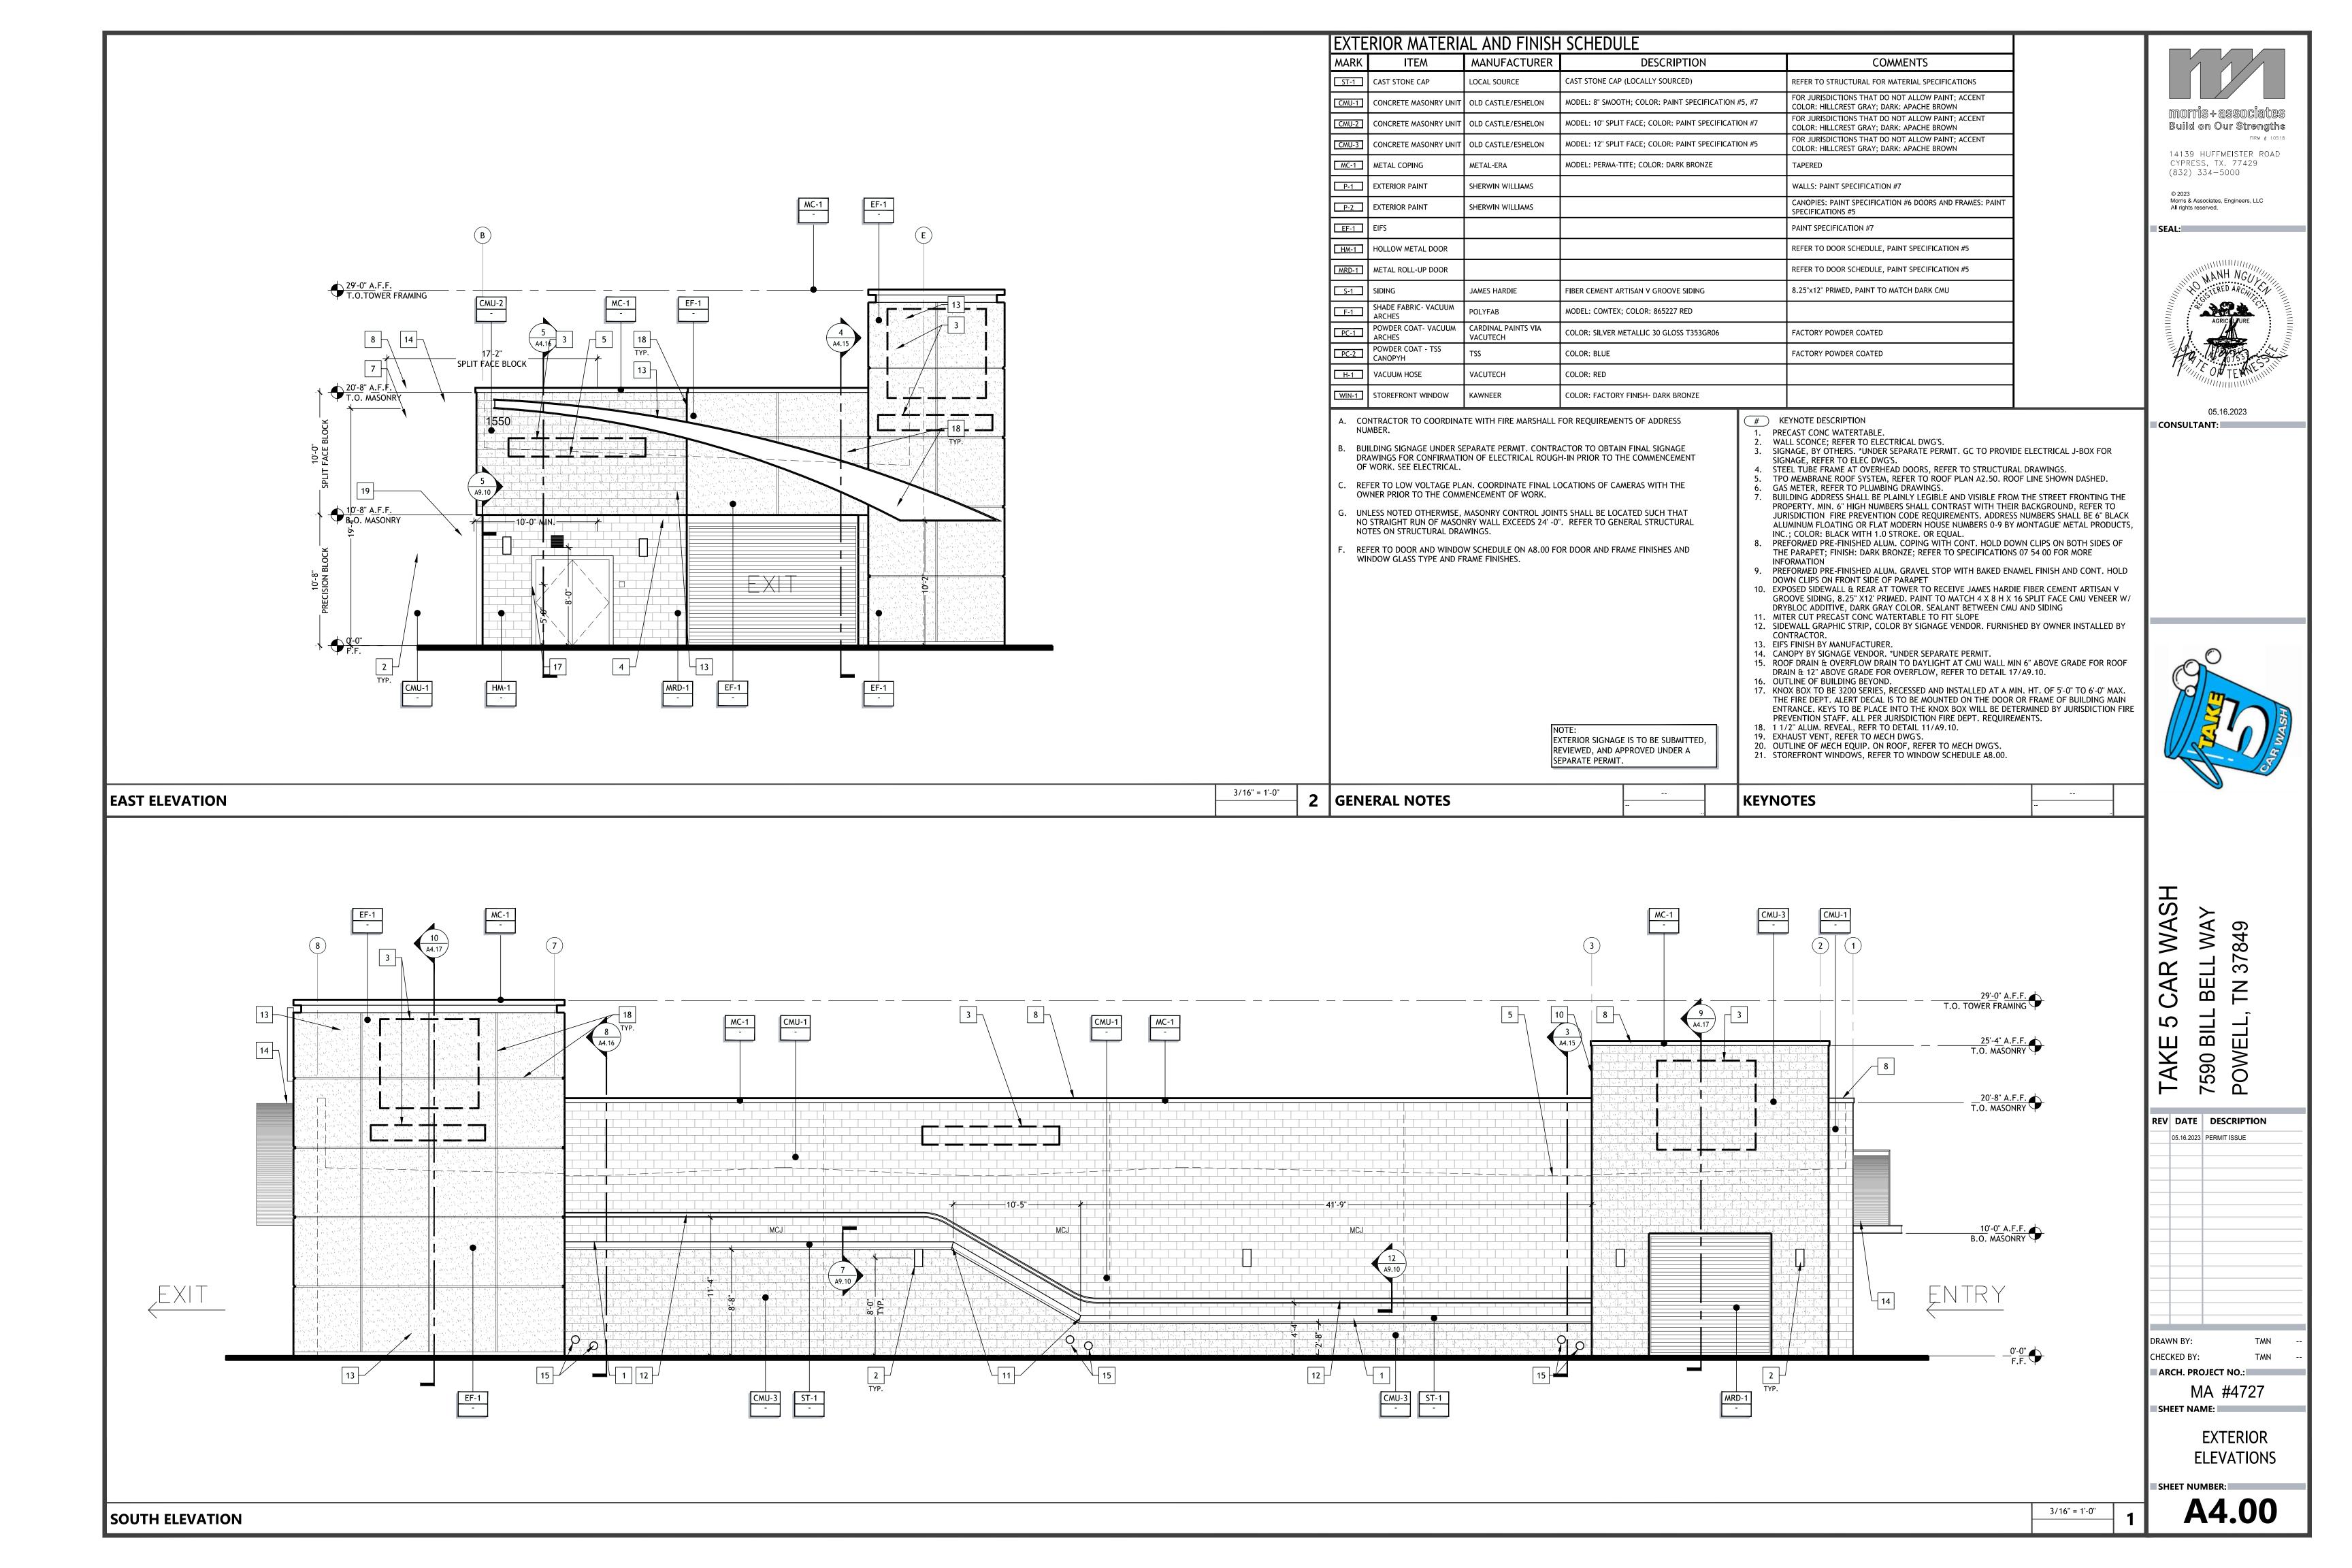

MARK	ITEM	MANUFACTURER	DESCRIPTION	COMMENTS
ST-1	CAST STONE CAP	LOCAL SOURCE	CAST STONE CAP (LOCALLY SOURCED)	REFER TO STRUCTURAL FOR MATERIAL SPECIFICATIONS
CMU-1	CONCRETE MASONRY UNIT	OLD CASTLE/ESHELON	MODEL: 8" SMOOTH; COLOR: PAINT SPECIFICATION #5, #7	FOR JURISDICTIONS THAT DO NOT ALLOW PAINT; ACCENT COLOR: HILLCREST GRAY; DARK: APACHE BROWN
CMU-2	CONCRETE MASONRY UNIT	OLD CASTLE/ESHELON	MODEL: 10" SPLIT FACE; COLOR: PAINT SPECIFICATION #7	FOR JURISDICTIONS THAT DO NOT ALLOW PAINT; ACCENT COLOR: HILLCREST GRAY; DARK: APACHE BROWN
CMU-3	CONCRETE MASONRY UNIT	OLD CASTLE/ESHELON	MODEL: 12" SPLIT FACE; COLOR: PAINT SPECIFICATION #5	FOR JURISDICTIONS THAT DO NOT ALLOW PAINT; ACCENT COLOR: HILLCREST GRAY; DARK: APACHE BROWN
MC-1	METAL COPING	METAL-ERA	MODEL: PERMA-TITE; COLOR: DARK BRONZE	TAPERED
P-1	EXTERIOR PAINT	SHERWIN WILLIAMS		WALLS: PAINT SPECIFICATION #7
P-2	EXTERIOR PAINT	SHERWIN WILLIAMS		CANOPIES: PAINT SPECIFICATION #6 DOORS AND FRAMES: PAINT SPECIFICATIONS #5
EF-1	EIFS			PAINT SPECIFICATION #7
HM-1	HOLLOW METAL DOOR			REFER TO DOOR SCHEDULE, PAINT SPECIFICATION #5
MRD-1	METAL ROLL-UP DOOR			REFER TO DOOR SCHEDULE, PAINT SPECIFICATION #5
S-1	SIDING	JAMES HARDIE	FIBER CEMENT ARTISAN V GROOVE SIDING	8.25"x12" PRIMED, PAINT TO MATCH DARK CMU
F-1	SHADE FABRIC- VACUUM ARCHES	POLYFAB	MODEL: COMTEX; COLOR: 865227 RED	
PC-1	POWDER COAT- VACUUM ARCHES	CARDINAL PAINTS VIA VACUTECH	COLOR: SILVER METALLIC 30 GLOSS T353GR06	FACTORY POWDER COATED
PC-2	POWDER COAT - TSS CANOPYH	TSS	COLOR: BLUE	FACTORY POWDER COATED
H-1	VACUUM HOSE	VACUTECH	COLOR: RED	
WIN-1	STOREFRONT WINDOW	KAWNEER	COLOR: FACTORY FINISH- DARK BRONZE	


EXTERIOR SIGNAGE IS TO BE SUBMITTED,

REVIEWED, AND APPROVED UNDER A

SEPARATE PERMIT.

- BUILDING SIGNAGE UNDER SEPARATE PERMIT. CONTRACTOR TO OBTAIN FINAL SIGNAGE DRAWINGS FOR CONFIRMATION OF ELECTRICAL ROUGH-IN PRIOR TO THE COMMENCEMENT OF WORK. SEE ELECTRICAL.
- REFER TO LOW VOLTAGE PLAN. COORDINATE FINAL LOCATIONS OF CAMERAS WITH THE OWNER PRIOR TO THE COMMENCEMENT OF WORK.
- UNLESS NOTED OTHERWISE, MASONRY CONTROL JOINTS SHALL BE LOCATED SUCH THAT NO STRAIGHT RUN OF MASONRY WALL EXCEEDS 24' -0". REFER TO GENERAL STRUCTURAL
- REFER TO DOOR AND WINDOW SCHEDULE ON A8.00 FOR DOOR AND FRAME FINISHES AND WINDOW GLASS TYPE AND FRAME FINISHES.
- PRECAST CONC WATERTABLE. WALL SCONCE; REFER TO ELECTRICAL DWG'S.
- SIGNAGE, BY OTHERS. *UNDER SEPARATE PERMIT. GC TO PROVIDE ELECTRICAL J-BOX FOR SIGNAGE, REFER TO ELEC DWG'S.
- STEEL TUBE FRAME AT OVERHEAD DOORS, REFER TO STRUCTURAL DRAWINGS. TPO MEMBRANE ROOF SYSTEM, REFER TO ROOF PLAN A2.50. ROOF LINE SHOWN DASHED.
- 6. GAS METER, REFER TO PLUMBING DRAWINGS. BUILDING ADDRESS SHALL BE PLAINLY LEGIBLE AND VISIBLE FROM THE STREET FRONTING THE PROPERTY. MIN. 6" HIGH NUMBERS SHALL CONTRAST WITH THEIR BACKGROUND, REFER TO
- JURISDICTION FIRE PREVENTION CODE REQUIREMENTS. ADDRESS NUMBERS SHALL BE 6" BLACK ALUMINUM FLOATING OR FLAT MODERN HOUSE NUMBERS 0-9 BY MONTAGUE' METAL PRODUCTS, INC.; COLOR: BLACK WITH 1.0 STROKE. OR EQUAL.
- 8. PREFORMED PRE-FINISHED ALUM. COPING WITH CONT. HOLD DOWN CLIPS ON BOTH SIDES OF THE PARAPET; FINISH: DARK BRONZE; REFER TO SPECIFICATIONS 07 54 00 FOR MORE INFORMATION
- 9. PREFORMED PRE-FINISHED ALUM. GRAVEL STOP WITH BAKED ENAMEL FINISH AND CONT. HOLD DOWN CLIPS ON FRONT SIDE OF PARAPET 10. EXPOSED SIDEWALL & REAR AT TOWER TO RECEIVE JAMES HARDIE FIBER CEMENT ARTISAN V
- GROOVE SIDING, 8.25" X12' PRIMED. PAINT TO MATCH 4 X 8 H X 16 SPLIT FACE CMU VENEER W/ DRYBLOC ADDITIVE, DARK GRAY COLOR. SEALANT BETWEEN CMU AND SIDING
- 11. MITER CUT PRECAST CONC WATERTABLE TO FIT SLOPE 12. SIDEWALL GRAPHIC STRIP, COLOR BY SIGNAGE VENDOR. FURNISHED BY OWNER INSTALLED BY CONTRACTOR.
- 13. EIFS FINISH BY MANUFACTURER.
- CANOPY BY SIGNAGE VENDOR. *UNDER SEPARATE PERMIT.
 ROOF DRAIN & OVERFLOW DRAIN TO DAYLIGHT AT CMU WALL MIN 6" ABOVE GRADE FOR ROOF DRAIN & 12" ABOVE GRADE FOR OVERFLOW, REFER TO DETAIL 17/A9.10.
- 16. OUTLINE OF BUILDING BEYOND. 17. KNOX BOX TO BE 3200 SERIES, RECESSED AND INSTALLED AT A MIN. HT. OF 5'-0" TO 6'-0" MAX. THE FIRE DEPT. ALERT DECAL IS TO BE MOUNTED ON THE DOOR OR FRAME OF BUILDING MAIN ENTRANCE. KEYS TO BE PLACE INTO THE KNOX BOX WILL BE DETERMINED BY JURISDICTION FIRE
- PREVENTION STAFF. ALL PER JURISDICTION FIRE DEPT. REQUIREMENTS. 18. 1 1/2" ALUM. REVEAL, REFR TO DETAIL 11/A9.10.
- 19. EXHAUST VENT, REFER TO MECH DWG'S. 20. OUTLINE OF MECH EQUIP. ON ROOF, REFER TO MECH DWG'S.
- 21. STOREFRONT WINDOWS, REFER TO WINDOW SCHEDULE A8.00.

KEYNOTES

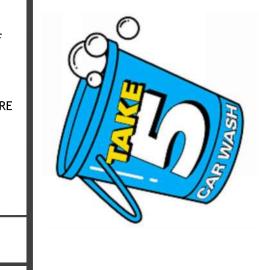

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05.16.2023

CONSULTANT:

SEAL:

CMU-2 _____18 13 Z9'-0" A.F.F.
T.O. TOWER FRAMING MC-1 8 5 ___ 26'-8" __ SPLIT FACE BLOCK 20'-8" A.F.F. T.O. MASONRY 14 10'-8" A.F.F. B.O. CANOPY ENTRY HM-1 Z TYP. 16 6 CMU-3 MRD-1 ST-1 CMU-1 CMU-1

TAKE 5 CAR WASH 7590 BILL BELL WAY POWELL, TN 37849

REV	DATE	DESCRIPTION
	05.16.2023	PERMIT ISSUE
DRAV	VN BY:	TMN
CHEC	KED BY:	TMN
ΔΡ	CH DDC	DJECT NO.:
	CII. FAC	7, LC 140

MA #4727

EXTERIOR ELEVATIONS

A4.01

3/16" = 1'-0"

NORTH ELEVATION

PRIOR TO COMMENCING WORK.

2. CONTRACTOR SHALL CONTACT ALL GOVERNING AGENCIES A MINIMUM OF 48 HOURS PRIOR

- TO CONSTRUCTION AND COORDINATE ALL WORK WITH THE SAME.

 3. WHETHER SHOWN ON DRAWINGS OR NOT THE CONTRACTOR SHALL PROVIDE ALL PIPING. APPURTENANCES, AND MISCELLANEOUS FITTINGS REQUIRED TO ACCOMPLISH THE DESIGN AS DRAWN AT NO ADDITIONAL COST TO THE OWNER. CONTRACTOR SHALL. CONTACT ENGINEER IF UNSURE OF PIPING LAYOUT, SIZES OR LENGTHS.
- 4. VERIFY ALL DIMENSIONS AND CONDITIONS IN THE FIELD BEFORE COMMENCING ANY WORK. IT SHALL BE THE CONTRACTOR'S RESPONSIBILITY TO REPORT ANY DISCREPANCIES TO THE ENGINEER IN A TIMELY MANNER.
- 5. ALL DIMENSIONS SHOWN ARE APPROXIMATE AND ARE TO BE VERIFIED BY THE CONTRACTOR. CHANGES IN HORIZONTAL OR VERTICAL ALIGNMENT ARE TO BE APPROVED BY THE ENGINEER.
- 6. THE DRAWINGS SHOW AS MUCH INFORMATION AS CAN BE REASONABLY OBTAINED FROM AN ON THE GROUND OBSERVATION, SURVEY AND EXISTING CONSTRUCTION DRAWINGS REGARDING THE TOPOGRAPHIC FEATURES, ELEVATIONS AS WELL AS THE LOCATION AND NATURE OF PIPELINES, NATURAL GAS LINES, UNDERGROUND CABLES, UTILITIES, ETC. HOWEVER, THE ACCURACY OF OR COMPLETENESS OF SUCH INFORMATION IS NOT GUARANTEED. THE CONTRACTOR SHALL VERIFY THE LOCATION OF ALL UNDERGROUND UTILITIES SUFFICIENTLY IN ADVANCE OF CONSTRUCTION TO PRECLUDE DAMAGE TO DOSING UTILITIES. IN THE EVENT THAT UNDERGROUND UTILITIES NOT SHOWN ON THE DRAWINGS ARE ENCOUNTERED DURING CONSTRUCTION, THE CONTRACTOR SHALL NOTIFY THE ENGINEER IMMEDIATELY.
- 7. THE CONTRACTOR SHALL NOTIFY ALL UTILITY COMPANIES IN THE AREA A MINIMUM OF 48 HOURS PRIOR TO COMMENCING WORK IN ANY RIGHT—OF—WAY OR EXISTING EASEMENT.

 8. SOME OF THE EXISTING UNDERGROUND UTILITIES SHOWN HEREON HAVE NOT BEEN FIELD
- VERIFIED.

 9. CONTRACTOR SHALL UNCOVER EXISTING UTILITIES AT ALL"POINTS OF CROSSING" TO
- 9. CONTRACTOR SHALL UNCOVER EXISTING UTILITIES AT ALL POINTS OF CROSSING TO DETERMINE IF CONFLICT EXISTS BEFORE COMMENCING ANY CONSTRUCTION. NOTIFY THE ENGINEER AT ONCE OF ANY CONFLICT.
- 10. IN THE EVENT OF DAMAGE TO UNDERGROUND UTILITIES OR FACILITIES, WHETHER SHOWN OR NOT ON THE DRAWINGS, THE CONTRACTOR SHALL MAKE THE NECESSARY REPAIRS TO REPLACE THE UTILITY OR FACILITY BACK IN SERVICE AT NO INCREASE IN THE CONTRACT PRICE. ALL SUCH REPAIRS SHALL CONFORM TO THE REQUIREMENTS OF THE COMPANY OR AGENCY SERVICING THE FACILITY.
- 11. ALL EXISTING POWER POLES, LIGHT STANDARDS, SIGNS, ETC. WHICH AFFECT THE PROPOSED CONSTRUCTION, SHALL BE REMOVED AND/OR RELOCATED AS REQUIRED WHETHER SHOWN ON DRAWINGS OR NOT AT NO ADDITIONAL COST TO THE OWNER.
- 12. ALL WORK WITHIN THE PUBLIC RIGHT-OF-WAY SHALL ADHERE TO THE STANDARDS OF THE GOVERNING AUTHORITY.
- 13. INGRESS AND EGRESS SHALL BE PROVIDED AT ALL TIMES FOR THE PROPERTY OWNERS AND BUSINESSES OF THE ABUTTING PROPERTY AND THE CROSS STREETS WHICH ARE AFFECTED BY THE CONSTRUCTION OF THIS PROJECT.
- 14. THE CONTRACTOR SHALL BE FULLY RESPONSIBLE FOR MAINTAINING A SAFE PROJECT SITE 24 HOURS A DAY.
- 15. DURING THE ENTIRE CONSTRUCTION PERIOD, THE CONTRACTOR SHALL MAINTAIN CONSTRUCTION WARNING SIGNS AT EACH END OF THE PROJECT TO WARN MOTORING AND PEDESTRIAN TRAFFIC THAT CONSTRUCTION IS IN PROGRESS AND OF POSSIBLE HAZARDOUS CONDITIONS GENERATED BY THE CONSTRUCTION.
- 16. THE CONTRACTOR SHALL BE RESPONSIBLE FOR DELINEATING THE PERIMETER OF CONSTRUCTION AREA WITH SAFETY FENCING AT NO ADDITIONAL COST. SAFETY FENCING SHALL BE ERECTED PRIOR TO CONSTRUCTION AND REMOVED UPON COMPLETION.
- 17. THE CONTRACTOR SHALL BE RESPONSIBLE FOR CONTROLLING TRAFFIC IN THE IMMEDIATE VICINITY OF CONSTRUCTION. ALL WORK SHALL BE IN SUCH A MANNER AND SEQUENCE AS TO PROVIDE MAXIMUM PROTECTION TO TRAFFIC AND PEDESTRIANS. CONTROLS SHALL BE CONSISTENT WITH THE TYPE OF WORK BEING PERFORMED.
- 18. CONTRACTOR SHALL PROVIDE AND INSTALL TRAFFIC CONTROL DEVICES IN CONFORMANCE WITH THE GOVERNING "MANUAL ON UNIFORM TRAFFIC CONTROL DEVICES" (MOST RECENT EDITION WITH ALL APPLICABLE SUPPLEMENTS AND REVISIONS) DURING CONSTRUCTION.
- 19. DELINEATORS SHALL BE INSTALLED ALONG THE PAVEMENT EDGE TO WARN TRAFFIC OF ANY ROADSIDE OBJECTS OR HAZARDS AND TO DELINEATE THE ROADWAY EDGE DURING HOURS OF DARKNESS.
- 20. THE WORK AREA SHALL BE BARRICADED AND ILLUMINATED DURING DARKNESS AND PERIODS OF INACTIVITY. WHEN IN AN AREA OF DIRECT PUBLIC ACCESS.
- 21. UNOCCUPIED TRENCHES SHALL BE SECURED WITH SAFETY FENCING OR OTHER APPROPRIATE MEANS AT ALL TIMES. TRENCHES WHICH ARE NOT IMMEDIATELY BACKFILLED
- SHALL BE SECURELY COVERED OVERNIGHT AND BE SURROUNDED BY SAFETY FENCING.

 22. THE CONTRACTOR SHALL BE RESPONSIBLE FOR PROVIDING REQUIRED SECURITY TO
- PROTECT HIS OWN PROPERTY, EQUIPMENT, AND WORK IN PROGRESS.

 23. THE CONTRACTOR SHALL BE RESPONSIBLE FOR ENSURING THAT ADEQUATE DRAINAGE BE MAINTAINED AT ALL TIMES DURING CONSTRUCTION AND ANY DRAINAGE DITCH OR STRUCTURE DISTURBED DURING CONSTRUCTION SHALL BE RESTORED TO THE SATISFACTION OF THE GOVERNING AUTHORITY.
- 24. CONTRACTOR IS RESPONSIBLE FOR THE CONSTRUCTION OF ANY TEMPORARY DITCH OR DRAINAGE FACILITIES REQUIRED TO MAINTAIN ADEQUATE SITE DRAINAGE DURING
- CONSTRUCTION AT NO ADDITIONAL COST TO OWNER

 25. THE CONTRACTOR IS TO INSTALL GROUND WATER CONTROL FACILITIES OR WELLPOINTS IF

 NEEDED AT NO ADDITIONAL COST TO OWNER
- NEEDED, AT NO ADDITIONAL COST TO OWNER.

 26. THE CONTRACTOR SHALL BE RESPONSIBLE FOR OBTAINING ALL APPLICABLE PERMITS
- REQUIRED BY ALL GOVERNING AGENCIES.

 27. THE CONTRACTOR IS RESPONSIBLE TO COMPLY WITH ALL REQUIREMENTS OF THE
- 27. THE CONTRACTOR IS RESPONSIBLE TO COMPLY WITH ALL REQUIREMENTS OF THE STORMWATER POLLUTION PREVENTION PLAN (SWP3 PLAN) FOR THIS PROJECT.
- 28. THE CONTRACTOR SHALL COMPLY WITH OSHA REGULATIONS AND STATE LAW CONCERNING EXCAVATION, TRENCHING AND SHORING.
- 29. THE CONTRACTOR SHALL DESIGN AND PROVIDE A TRENCH SAFETY SYSTEM TO MEET APPROPRIATE REQUIREMENTS ESTABLISHED IN OCCUPATIONAL SAFETY AND HEALTH ADMINISTRATION (OSHA) SAFETY & HEALTH REGULATIONS. 29 CFR 1926, SUBPART P EXCAVATIONS, TRENCHING AND SHORING, AND OSHA'S PROPOSED STANDARDS ON TRENCHING, EXCAVATION PUBLISHED IN VOLUME 52, NO. 72 OF THE FEDERAL REGISTER. APRIL 15. 1987, PAGES 12288—12339. SHOULD THE REFERENCED OSHA STANDARDS BE MODIFIED OR AMENDED, THE MORE STRINGENT REQUIREMENTS SHALL APPLY.
- 30. CONTRACTOR SHALL PROVIDE SHEETING, SHORING AND BRACING AS NECESSARY TO PROTECT WORKMEN AND EXISTING UTILITIES DURING ALL PHASES OF CONSTRUCTION.
- 31. IN ORDER TO COMPLY WITH HANDICAP REGULATIONS, THE CONTRACTOR SHALL ENSURE THAT THE SLOPE OF THE SIDEWALK AND / OR PAVING IN THE FIRST FIVE FEET OUTSIDE ANY DOOR DOES NOT EXCEED 2% IN ANY DIRECTION.
- 32. NO CONSTRUCTION WHICH BLOCKS TRAFFIC ON ANY STREET, ALLEY, OR DRIVEWAY WILL BE ALLOWED DURING THE HOURS OF 6:30 A.M. 8:30 A.M. AND 2:30—6:00 P.M.
- 33. THE CONTRACTOR MUST CLEAN MUD, DIRT OR DEBRIS TRACKED ONTO EXISTING STREETS
- BY HIMSELF OR SUBCONTRACTOR'S VEHICLES AND EQUIPMENT IN A TIMELY MANNER.

 34. CONDITION OF THE ROAD AND/OR RIGHT-OF-WAY. UPON COMPLETION OF JOB SHALL BE
- AS GOOD OR BETTER THAN PRIOR TO STARTING WORK.
- 35. ALL AREAS DISTURBED BY CONSTRUCTION WHICH ARE NOT TO BE REPAVED OR OTHERWISE COVERED BY LANDSCAPING SHALL BE HYDROMULCHED.
- 36. CONTRACTOR SHALL STRIP AND STOCKPILE TOPSOIL. TOPSOIL SHALL BE SPREAD OVER ALL AREAS RECEIVING SOD AND OR HYDROMULCH. CONTRACTOR IS RESPONSIBLE FOR ESTABLISHING A STAND OF GRASS WITH NO AREAS OF EROSION BEFORE FINAL
- 37. THE CONTRACTOR SHALL BE RESPONSIBLE FOR THE REMOVAL AND DISPOSAL OF ALL WASTE MATERIAL GENERATED DURING CONSTRUCTION. WASTE MATERIAL MUST BE REMOVED FROM THE WORK SITE AND DISPOSED OF IN SUCH A MANNER COMPLIANT WITH ALL LAWS AND REGULATIONS AND AS TO NOT DAMAGE THE OWNER OR OTHER PERSONS AT NO
- 38. ALL FILL PLACED ON SITE SHALL BE ENGINEERED FILL PER THE RECOMMENDATION OF THE SOILS REPORT.
- 39. FINISH GRADE ELEVATIONS INDICATE FINAL GRADE OF PROPOSED MATERIAL (I.E SOD, DIRT, MULCH. ETC.) LANDSCAPED AREAS ADJACENT TO BUILDING, INCLUDING, DIRT, MULCH, AND/OR BEDDING MATERIALS SHALL NOT COVER WEEPHOLES. AREAS ADJACENT TO BUILDING, LANDSCAPED, OR OTHERWISE SHALL SHEET FLOW AWAY FROM BUILDING WITH NO AREAS OF STANDING WATER ADJACENT TO BUILDING.
- 40. GRADING AROUND BUILDINGS INCLUDING WALKWAYS SHALL BE COORDINATED WITH ARCHITECT AND FINAL APPROVAL OF GRADES IN GRASS AREAS AND SWALES SHALL BE APPROVED BY ENGINEER PRIOR TO INSTALLATION OF LANDSCAPING MATERIALS
- 41. AFTER INSTALLATION OF DRAINAGE SYSTEM. CONTRACTOR SHALL PERFORM FINAL GRADING AS SHOWN ON THE PLANS AND/OR AS DIRECTED BY ENGINEER OR OWNER TO INSURE POSITIVE DRAINAGE OF ENTIRE SITE. FINAL GRADING SHALL BE APPROVED BY ENGINEER PRIOR TO INSTALLATION OF GRASS.

- 42. THE CONTRACTOR SHALL COORDINATE FINAL GRADING OF LANDSCAPED AREAS WITH THE ARCHITECT.
- 43. CONTRACTOR IS RESPONSIBLE FOR ESTABLISHING FINAL GRADES TO ENSURE POSITIVE DRAINAGE.
- DRAINAGE.

 44. PLACE BACKFILL AS PROMPTLY AS PRACTICABLE AFTER COMPLETION OF EACH STRUCTURE OR PORTION OF A STRUCTURE. DO NOT PLACE BACKFILL AGAINST CONCRETE WALLS OR
- SIMILAR STRUCTURES UNTIL CONCRETE HAS CURED AT LEAST SEVEN (7) DAYS.

 45. ALL STRUCTURES AND SEWER PIPE UNDER OR WITHIN TWO (2) FEET OF PROPOSED OR FUTURE PAVEMENT SHALL BE BEDDED AND BACKFILLED WITH CEMENT STABILIZED SAND UP TO THE BOTTOM OF THE PAVEMENT SUBGRADE.
- 46. CEMENT—SAND BACKFILL SHALL CONSIST OF NOT LESS THAN 1—1/2 SACKS OF CEMENT PER TON OF SAND WITH SUFFICIENT WATER TO HYDRATE THE CEMENT. THE MATERIAL SHALL BE PLACED IN LAYERS EIGHT (8) INCHES THICK MAXIMUM AND COMPACTED to 95% STANDARD PROCTOR DENSITY.
- 47. WHERE PAVEMENT OR CURB IS BEING REMOVED AND REPLACED FULL DEPTH SAW CUT SHALL BE PERFORMED AT STREET CONNECTION.
- 48. CONCRETE PAVEMENT SHALL HAVE MINIMUM OF FIVE AND ONE—HALF SACKS OF CEMENT PER CUBIC YARD AND SHALL HAVE A MINIMUM COMPRESSIVE STRENGTH OF 3700 PSI AT 28 DAYS. CONCRETE SHALL COMPLY WITH GEOTECHNICAL REPORT.
- 49. ALL STEEL REINFORCEMENT SHALL CONFORM TO ASTM A615 GRADE 60. 50. DETAILING AND FABRICATION OF CONCRETE REINFORCEMENT AND ACCESSORIES SHALL BE
- IN ACCORDANCE WITH ACI-318 LATEST EDITION.
 51. LAP ALL CONTINUOUS REINFORCING STEEL 36 DIAMETERS AT SPLICES, TEES, AND
- CORNERS UNLESS NOTED OTHERWISE ON PLANS.

 52. WHERE CONCRETE CURB OR WALK IS INDICATED, ELEVATION SHALL BE 6 INCHES ABOVE TOP OF PAVEMENT ELEVATION SHOWN, UNLESS OTHERWISE SHOWN ON DRAWINGS.

53. MOW STRIPS SHALL BE INSTALLED SO AS NOT TO BLOCK ANY SHEET FLOW PATTERNS AS

- DESIGNED. ANY MOW STRIPS THAT BLOCK DRAINAGE SHALL BE REMOVED AND REPLACED AT NO ADDITIONAL COST TO THE OWNER. IF CONTRACTOR HAS ANY QUESTIONS ON CORRECT ELEVATIONS FOR MOW STRIPS CONTACT ENGINEER OR ARCHITECT.
- 54. A FIBERBOARD EXPANSION JOINT SHALL BE PLACED BETWEEN THE BUILDING FOUNDATION AND THE CONCRETE PAVEMENT.
- 55. THE CONTRACTOR SHALL VERIFY LOCATION AND ELEVATION OF ALL PROPOSED UTILITIES EXITING BUILDING PRIOR TO COMMENCING WORK ON SITE UTILITIES. UPON ANY DISCREPANCIES, ENGINEER IS TO BE NOTIFIED.
- 56. ELECTRIC METER AND SERVICE LINE INSTALLATION TO BE COORDINATED WITH ELECTRICAL PROVIDER BY THE CONTRACTOR.
- 57. GAS METER AND SERVICE LINE INSTALLATION TO BE COORDINATED WITH GAS COMPANY BY THE CONTRACTOR.
- 58. ALL EXISTING STORM SEWER MANHOLES OR STRUCTURES ON SITE SHALL BE ADJUSTED TO FINISH GRADE. ALL EXISTING SANITARY SEWER MANHOLES SHALL BE ADJUSTED TO 3" ABOVE FINISH GRADE.

SANITARY SEWER CONSTRUCTION NOTES:

- SANITARY SEWER SHALL BE PVC (POLY-VINYL CHLORIDE) PIPE MEETING A.S.T.M. SPECIFICATIONS. D-3034-08 AND HAVING A S.D.R. OF 26 UNLESS OTHERWISE SHOWN ON PLANS. BEDDING BACKFILLING AND INSTALLATION OF PIPE AND CONSTRUCTION OF APPURTENANCES SHALL BE IN ACCORDANCE WITH THE CIVIL DETAIL SHEETS.
 THE CONTRACTOR SHALL USE PRECAST SANITARY SEWER MANHOLES.
- 3. ALL MANHOLES, AND CLEANOUTS SHALL BE BACKFILLED WITH CEMENT STABILIZED SAND. CEMENT STABILIZED SAND FILL SHALL BE AT LEAST 12" ON BOTTOM OF STRUCTURE AND 12" AROUND OUTSIDE OF STRUCTURE.
- 4. CONTRACTOR SHALL CUT OFF PIPE FLUSH WITH INSIDE FACE OF MANHOLES.
- 5. CONTRACTOR SHALL SEAL INTERIOR SURFACE OF PROPOSED SANITARY SEWER MANHOLES WITH RAVEN LINER 405, OR APPROVED EQUAL AS PER MANUFACTURER'S SPECIFICATIONS.
- 6. ALL SANITARY SEWER MANHOLES SHALL BE VACUUM TESTED.
- 7. ALL SANITARY SEWER LINES SHALL BE MANDREL AND AIR TESTED. ALL SANITARY SEWER LINES SHALL ALSO BE INSPECTED VIA CAMERA.
- 8. TIE-INS TO EXISTING MANHOLES SHALL BE MADE SUCH THAT THE FINAL CONDITIONS UPON COMPLETION OF THE JOB SHALL BE AS GOOD OR BETTER THAN PRIOR TO STARTING WORK.
- 9. THE CONTRACTOR IS TO INSTALL WATER—TIGHT ADAPTORS OF A TYPE COMPATIBLE WITH THE MATERIALS BEING JOINED AT THE POINT OF CONNECTION OF THE SERVICE LINE TO THE BUILDING PLUMBING. NO CEMENT GROUT MATERIALS ARE PERMITTED.
- 10. THE CONTRACTOR IS TO INSTALL EACH CLEANOUT SO THAT IT OPENS IN A DIRECTION OPPOSITE TO THE FLOW OF THE WASTE AND, EXCEPT IN THE CASE OF A "WYE" BRANCH AND END-OF-THE-LINE CLEANOUTS, CLEANOUTS WILL BE INSTALLED VERTICALLY ABOVE THE FLOW LINE OF THE PIPE. CLEANOUTS WILL BE MADE WITH AIR-TIGHT MECHANICAL PLUG.
- 11. THE DOWNSTREAM END OF THE PROPOSED SEWER REMAIN PLUGGED UNTIL ALL DEBRIS IS CLEANED OUT OF THE PROPOSED SEWER AND ALL LINE TESTING IS COMPLETED PRIOR TO REMOVING THE PLUG AND CONNECTING TO THE DOWNSTREAM PIPE.

WATER LINE CONSTRUCTION NOTES:

- 1. DOMESTIC OR FIRE WATER LINES 4" AND LARGER SHALL BE POLYVINYL CHLORIDE PVC, DR-18, CLASS 150, CONFORMING TO AWWA C900 OR C905, AS CURRENTLY AMENDED UNLESS OTHERWISE NOTED ON THE PLANS.
- 2. WATER LINES 3" AND SMALLER SHALL BE SCHEDULE 40 PVC UNLESS OTHERWISE NOTED ON THE PLANS.
- 3. ALL VALVES SHALL BE LEFT HAND (COUNTERCLOCKWISE) OPEN.
- 4. CONTRACTOR SHALL INSTALL METALLIC TRACER WIRE ON ALL UNDERGROUND PVC PIPING AND SECURE WIRE ENDS AT ALL VALVE BOXES.
- 5. CONTRACTOR SHALL ADJUST ELEVATION OF WATER LINES AS REQUIRED TO CLEAR OTHER UTILITIES ADJUSTMENT MUST MEET TCEQ REQUIREMENT FOR MINIMUM CLEARANCES, TYPE OF PIPE, ETC.
- 6. MINIMUM VERTICAL CLEARANCE BETWEEN WATER LINES AND OVER UTILITIES SHALL BE TWELVE INCHES, UNLESS OTHERWISE NOTED ON THE PLANS.
- 7. EXISTING WATER SERVICES SHALL NOT BE INTERRUPTED DURING CONSTRUCTION.


 8. NO CONNECTIONS SHALL BE MADE TO EXISTING WATER LINES UNTIL ALL PROPOSED WATER LINES HAVE BEEN THOROUGHLY CLEANED. TESTED, DISINFECTED AND

APPROVED. ALL TESTING PROCEDURES SHALL CONFORM TO THE GOVERNING AGENCY.

STORM SEWER CONSTRUCTION NOTES:

- 1. ALL INLETS, MANHOLES, CLEANOUTS, AND HEADWALLS SHALL BE BACKFILLED WITH CEMENT STABILIZED SAND. CEMENT STABILIZED SAND FILL SHALL BE AT LEAST 12" ON BOTTOM OF STRUCTURE AND 12" AROUND OUTSIDE OF STRUCTURE.
- 2. NO CORNER CONNECTIONS WILL BE ALLOWED TO ANY INLETS, JUNCTION BOXES, OR BOX MANHOLES3. CONTRACTOR SHALL CUT OFF PIPE FLUSH WITH INSIDE FACE OF INLETS AND
- 3. CONTRACTOR SHALL CUT OFF PIPE FLUSH WITH INSIDE FACE OF INLETS AND MANHOLES.
- 4. CONCRETE FOR DRAINAGE STRUCTURES SHALL HAVE A MINIMUM COMPRESSIVE STRENGTH OF 4500 PSI AT 28 DAYS.
- 5. CULVERT CROSSINGS LOCATED WITHIN 30 FEET OF THE RIGHT—OF—WAY SHALL HAVE MINIMUM 6:1 SLOPING ENDS KNOWN AS SAFETY END TREATMENTS (SETS). THE CULVERT SHALL HAVE SUFFICIENT LENGTH TO ALLOW THE 6:1 SLOPE TO BE ACHIEVED FROM THE EDGE OF PAVEMENT TO THE FLOWLINE AT THE END OF THE SET
- 6. CULVERTS LARGER THAN SINGLE 30-INCH DIAMETER (OR LARGER THAN MULTIPLE 24-INCH DIAMETER CULVERTS) SHALL REQUIRE SAFETY PIPE RUNNERS.
- 7. CONTRACTOR SHALL FLUSH AND CLEAN ALL STORM SEWER LINES AND STRUCTURES PRIOR TO ACCEPTANCE. ALL STORM LINES SHALL ALSO BE INSPECTED VIA CAMERA.
- 8. TIE-INS TO EXISTING MANHOLES SHALL BE MADE SUCH THAT THE FINAL CONDITIONS UPON COMPLETION OF THE JOB SHALL BE AS GOOD OR BETTER THAN PRIOR TO STARTING WORK.
- 9. THE CONTRACTOR IS TO INSTALL EACH CLEANOUT SO THAT IT OPENS IN A DIRECTION OPPOSITE TO THE FLOW OF THE WASTE AND, EXCEPT IN THE CASE OF A "WYE' BRANCH AND END—OF—THE—LINE CLEANOUTS, CLEANOUTS WILL BE INSTALLED VERTICALLY ABOVE THE FLOW LINE OF THE PIPE. CLEANOUTS WILL BE MADE WITH AIR—TIGHT MECHANICAL PLUG.



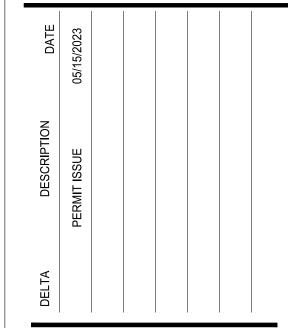

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ENGINEER:



Build on Our Strengths

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SHEET TITLE

CIVIL SPECS

PROJECT NUMBER 4727

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05.15.2023

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