THE GODDARD SCHOOL

r a n d o l p h architecture

9724 kingston pike suite 305 B knoxville, tn 37922 v: 865.357.3750 f: 865.357.3746



2015_11

CH

GODDARD

10720 VIRGINIA PINE WAY KNOXVILLE, TN 37932

RANDOLPH ARCHITECTURE

ABBREVIATIONS

^ - - -	ABOVE FINISH ELOOP	MTI	NACTAL
A.F.F. ALT.	ABOVE FINISH FLOOR ALTERNATE	MTL.	METAL
ALUM.	ALUMINUM	MG. MFG.	MANUFACTURING MANUFACTURER
ARCH.	ARCHITECTURAL	MIN.	MINIMUM
A.C.T.	ACOUSTICAL TILE	MISC.	MISCELLANEOUS
ASPH.	ASPHALT	N.I.C.	NOT IN CONTRACT
B.F.	BOTTOM FACE	N.T.S.	NOT TO SCALE
BSMT.	BASEMENT	NO.,#	NUMBER
B.M.	BENCHMARK	O.C.	ON CENTER
BLDG.	BUILDING	O.D.	OUTSIDE DIAMETER
BLK.	BLOCK	P.	PLATE
BRG.	BEARING	PLAS.	
C.B.	CATCH BASIN		PLASTIC LAMINATE
C.J.	CONTROL JOINT	PLYWD.	
CH.B.	CHALK BOARD	PTD.	PAINTED
CLG.	CEILING		RADIUS
CLOS.,CL		R.D.	ROOF DRAIN
CLR.	CLEAR	RINF.	REINFORCING
COL. COMP.	COLUMN COMPOSITION		REQUIRED
COMP.		RS. RM.	RISER ROOM
CONC.		R.O.	ROUGH OPENING
C.M.A.	CONCRETE MASONRY UNIT	RB.T.	RUBBER TILE
C.W.A.	CERAMIC TILE	SCHED.	
DTL.	DETAIL	S.C.WD.	SOLID CORE WOOD DOOR
DIA.	DIAMETER	SECT.	SECTION SECTION
DN.	DOWN	SHT.	SHEET
DWG.	DRAWING	SIM.	SIMILAR
D.F.	DRINKING FOUNTAIN	SPECS.	
D.S.	DOWNSPOUT	SQ.FT.	SQUARE FEET
EA.	EACH	STD.	STANDARD
E.F.	EACH FACE	STL.	STEEL
ELEC.	ELECTRICAL	STOR.	STORAGE
E.W.A.	ELECTRIC WATER COOLER	S.D.	STORM DRAIN
ELEV.	ELEVATION	SUSP.	SUSPENDED
EXIST.	EXISTING	SQ.	SQUARE
EXT.	EXTERIOR	T.B.	TACK BOARD
E.J.	EXPANSION JOINT	T'HOLD	THRESHOLD
F.E.	FIRE EXTINGUISHER	TLT.	TOILET
FL.	FLOOR	TD.,TDS.	TREADS
F.D. FT.	FLOOR DRAIN	T.F.	TOP FACE
FTG.	FOOT FOOTING	TYP.	TYPICAL
GALV.	GALVANIZED IRON	U. V.I.F.	URINAL VERIFY IN FIELD
G.A.	GAUGE	V.I.I . V.S.	VENT STACK
GYP.	GYPSUM	VOL.	VOLUME
H.B.	HOSE BIB	V.A.	VINYL TILE
H.C.WD.	HOLLOW CORE WOOD	VERT.	VERTICAL
HDW.	HARDWARE	WSCT.	WAINSCOT
HGT.	HEIGHT	W.C.	WATER CLOSET
H.A.	HOLLOW METAL	W.H.	WATER HEATER
I.D.	INSIDE DIAMETER	WPFG.	WATERPROOFING
IN.	INCH	W.F.	WIDE FLANGE
INV.	INVERT	WDW.	WINDOW
JAN.	JANITOR	WD.	WOOD
JST.	JOIST	W/	WITH
LAV.	LAVATORY	W.W.F.	WELDED WIRE FABRIC
LB.	POUND	W.W.M.	WELDED WIRE MESH
M.H.	MANHOLE	L	ANGLE
MAX.	MAXIMUM	С	CHANNEL
MECH.	MECHANICAL	0	ROUND

GRAPHIC SYMBOLS DETAIL NUMBER



MATERIALS LEGEND

		<u> </u>	<i></i>
	SOIL IN SECTION	PL	YWOOD
	RIGID INSULATION	FII	NISH WOOD
	BATT INSULATION	W	OOD BLOCKING
	CONCRETE BLOCK	CF	RUSHED STONE
<u>a</u>	CONCRETE IN SECT	ION ///// MF	ETAL IN SECTIOI
	BRICK		YP. BD, PLASTEF R CONCRETE

PROJECT DATA

PROJECT DAT	A
KNOX COUNTY PLANS REVIEW SUITE 547 400 MAIN STREET KNOXVILLE, TN 37902 PHONE (865) 215-2325 FAX (865) 215-4255 CONSTRUCTION TYPE: 2012 IBC - TYPE V-B, SPRINKLERED OCCUPANCY TYPE: EDUCATION GROUP I-4 BUILDING HEIGHT: ALLOWABLE: 2 STORIES PER TABLE 503; ACTUAL: 1 STORY: 28'-0" +/- BUILDING AREA: ALLOWABLE:	OJECT CONTACT: MARK RANDOLPH/ JACQUELINE RANDOLPH 9724 KINGSTON PIKE, STE. 305B KNOXVILLE, TN 37922 PLICABLE CODES: LOCAL CODES: INTERNATIONAL BUILDING CODE 2012 INTERNATIONAL EXISTING BUILDING CODE 2012 INTERNATIONAL MECHANICAL CODE 2012 INTERNATIONAL PLUMBING CODE 2012 INTERNATIONAL FIRE CODE 2012 INTERNATIONAL FIRE CODE 2012 INTERNATIONAL FUEL GAS CODE 2012 INTERNATIONAL PROPERTY MAINTENANCE CODE 2012 INTERNATIONAL ENERGY CONSERVATION CODE 2012 INTERNATIONAL ENERGY CONSERVATION CODE 2012 NFPA 101 LIFE SAFETY CODE 2012 NFPA 70 NATIONAL ELECTRICAL CODE 2011 ACCESSIBLE AND USABLE BUILDINGS AND FACILITIES ICC /A117.1-2009 ANSI AMERICAN NATIONAL STANDARD INTERNATIONAL PERFORMANCE CODE 2012 KNOXVILLE CODE OF ORDINANCES: CHAPTER 6 BUILDINGS AND BUILDING REGULATIONS, ARTICLE I. SECTION 6-5. FIRE DISTRICT
9,000 SQ. FT. TOTAL ALLOWABLE ACTUAL: EXISTING BLDG: 8,164 SQ. FT. NEW BLDG: 3,159 SQ. FT. TOTAL: 11,364 SQ. FT. AREA INCREASE CALCULATION PER IBC 2006, SECTION 506 Aa = { At + [At x If] + [At x Is] } = {9,000 + [9,000 x .244] + [9,000 x 3] } = 38,196 SQ. FT ALLOWABLE	STATE FIRE MARSHALL ADOPTED CODES: BUILDING CODE: 2006 INTERNATIONAL BUILDING CODE (EXCLUDING CHAPTERS 11 &27) FIRE CODE: 2006 INTERNATIONAL FIRE CODE LIFE SAFETY CODE: 2006 NFPA 101 ENERGY CODE: 2006 INTERNATIONAL ENERGY CONSERVATION CODE RESIDENTIAL CODE: 2009 INTERNATIONAL RESIDENTIAL CODE

FIRE RESISTIVE RATING REQUIREMENTS

FIRE RESISTANCE RATING REQUIREMENTABLE 601, IBC 2006 FOR TY	, ,
STRUCTURAL FRAME	0
BEARING WALLS EXTERIOR INTERIOR	0 0
NON BEARING WALLS/PARTITIONS EXTERIOR INTERIOR	TABLE 602 0
FLOOR CONSTRUCTION	0
ROOF CONSTRUCTION	0
FIRE RESISTANCE RATING REQUIREMENT ON FIRE SEPARATION DISTANCE FROM TABLE 602, IBC 2006 FOR T	

OCCUPANCY GROUP I-4

FIRE ALARM & DETECTION SYSTEMS

FIRE SEPARATION DISTANCE=X

X < 5 FT

X ≥ 30 FT

5 FT ≤ X < 10 FT

 $10 \text{ FT} \leq X < 30 \text{ FT}$

EXISTING BUILDING AND NEW BUILDING ADDITION IS EQUIPPED WITH A FIRE ALARM SYSTEM.

EXIT ACCESS TRAVEL DISTANCE
TABLE 1016.1, PER IBC 2006
OCCUPANCY WITHOUT SPRINKLER SYSTEM

200 FEET

OCCUPANCY: 112 CHILDREN + 20 TEACHERS = 132 OCCUPANTS

ZONE: PLANNED COMMERCIAL/TECHNOLOGY OVERLAY HEIGHT: 45'-0" MAXIMUM (28'-0" ACTUAL HEIGHT)

LOT COVERAGE: PER TTCDA REQUIREMENTS - LISTED BELOW

TECHNOLOGY OVERLAY SETBACKS: FRONT, REAR & SIDES: 20'-0"

MPC, SECTION 4.91 DAY CARE CENTERS:
REQUIREMENTS FOR CHILD CARE CENTER AND
GROUP DAY CARE HOMES, WHEN
CONSIDERED AS USES PERMITTED ON
REVIEW.

TOTAL LOT AREA: 10,000 SQ. FT. 30 S.F. PER CHILD OF USABLE INDOOR SPACE.

PLAY AREA - FENCED 2,500 SQ. FT. MIN. HEIGHT OF FENCE SHALL BE 48"

PARKING REQ'D (ARTICLE 3, 3.50): EXISTING PARKING SPACES: 31

TTCDA SITE REQUIREMENTS:

CHILD DAY CARE CENTERS OR KINDERGARTENS, DAY SCHOOLS AND THE EQUIVALENT PRIVATE OR PAROCHIAL SCHOOLS: TWO OFF STREET PARKING SPACES PER THREE EMPLOYEES, PLUS ONE OFF STREET LOADING SPACE FOR EVERY EIGHT CHILDREN.

20 STAFF/3 = 6.66 X 2 SPACES = 13.3 SPACES 112 CHILDREN/8 = 14

27 PARKING SPACES REQUIRED 31 PARKING SPACES PROVIDED

GROUND AREA COVERAGE:
ALLOWABLE: 25%
ACTUAL: 12%

PERVIOUS/IMPERVIOUS RATIO:
ALLOWABLE: 30%/70%

ACTUAL: 33,563 SQ. FT./93,182 SQ. FT. = 36%

FLOOR AREA RATIO:
 ALLOWABLE: 30%

EGRESS NOTES 12% MEANS OF EGRESS; TABLE 1005.1, IBC 2006, FOR NONSPRINKLERED BUILDINGS

STAIRWAYS
OTHER EGRESS COMPONENTS
MIN. EGRESS CORRIDOR WIDTH:
MIN. CLEAR OPENING OF EXIT DOORS
MAX. TRAVEL DISTANCE TO EXIT
(PER TABLE 1016.1, IBC 2006)
MAX. DEAD END CORRIDOR LENGTH

(INCHES PER OCCUPANT)
22"
44"
44"
200 FEET (UNSPRINKLED)

NUMBER OF EXITS FOR OCCUPANT LOAD

TABLE 1019.1, PER IBC 2006

OCCUPANT LOAD (PERSONS PER STORY)

MIN. NUMBER OF EXITS (PER STORY)

EXIT ACCESS

NOTE: ALL APPLICABLE PROVISIONS OF SECTION 1025 OF IBC 2006, MEANS OF EGRESS - ASSEMBLY, SHALL BE COMPLIED WITH.

1 SERVICE SINK REQUIRED
1 SERVICE SINK PROVIDED

PLUMBING FIXTURE CALCULATIONS

138 OCCUPANTS

9 WATER CLOSETS REQUIRED

15 WATER CLOSETS PROVIDED

9 LAVATORIES REQUIRED

25 LAVATORIES PROVIDED

TOTAL OCCUPANT LOAD:

PER IBC 2012, TABLE 2902.1

132 / 15 = 8.8

132 / 15 = 8.8

DRINKING FOUNTAINS

1 DRINKING FOUNTAIN REQUIRED

1 DRINKING FOUNTAIN PROVIDED

WATER CLOSETS

LAVATORIES

1 PER 1,000

SERVICE SINKS

VICINITY MAP



9-J-15-UR

Revised: 8/26/2015

LIST OF DRAWINGS

	LANDSCAPE			
	L1.01 CIVIL	LANDSCAPE PLAN / 1		
	C1.01	SITE DEMOLITION PLAN		
	C1.02	SITE LAYOUT PLAN		
	C1.03	SITE GRADING PLAN		
	C2.01	SITE DETAILS		
	AR <u>CH</u> IT	ECTURAL		
ار ا	A0.01	EXISTING/DEMOLITION PLAN		

COVERSHEET

A0.02 LIFE SAFETY PLAN
A1.01 FLOOR PLAN

A2.01 DOOR SCHEDULE, DOOR & FRAME ELEVATIONS, HEAD & JAMB DETAILS

A3.01 ROOF PLAN, ROOF DETAILS

A4.01 EXTERIOR ELEVATIONS - SOUTH & EAST

A4.02 EXTERIOR ELEVATIONS - SOUTH & EAST

A5.01 BUILDING SECTION

A5.02 BUILDING SECTION

A7.01 REFLECTED CEILING PLAN

A8.01 ENLARGED TOILET PLANS AND ELEVATIONS

F1.01 FINISH PLAN, FINISH SCHEDULE, FINISH LEGEND
STRUCTURAL

S.10 STRUCTURAL NOTES

S1.1 STRUCTURAL DETAILS

S2.0 FOUNDATION PLAN

S2.1 SHEAR WALL PLAN

S2.2 ROOF FRAMING PLAN

S3.0 SECTIONS AND DETAILS

MECHANICAL

M1.01 HVAC PLAN

MECHANICAL

P1.01 SEWER & VENT PLAN

P1.02 HOT AND COLD WATER PLAN

FIRE PROTECTION

FP1.01 FIRE PROTECTION PLAN

ELECTRICAL
E1.01 LIGHTING PLAN

POWER & COMMUNICATIONS PLAN
SCHEDULES & DETAILS

Issue Date 08-14-2015

Drawn Checked

JMR RMR

Revisions

 rev 1: 08 - 26 - 2015

coversheet

randolph

architecture

9724 kingston pike

knoxville, tn 37922


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suite 305 B

Checked Drawn

Revisions



EASEMENT EDGE OF PAVEMENT STORM DRAIN SANITARY SEWER POTABLE WATER NATURAL GAS SCALE: 1" = 20"FIRE PROTECTION MANHOLE WATER METER FIRE HYDRANT SILT FENCING INLET PROTECTION CURB

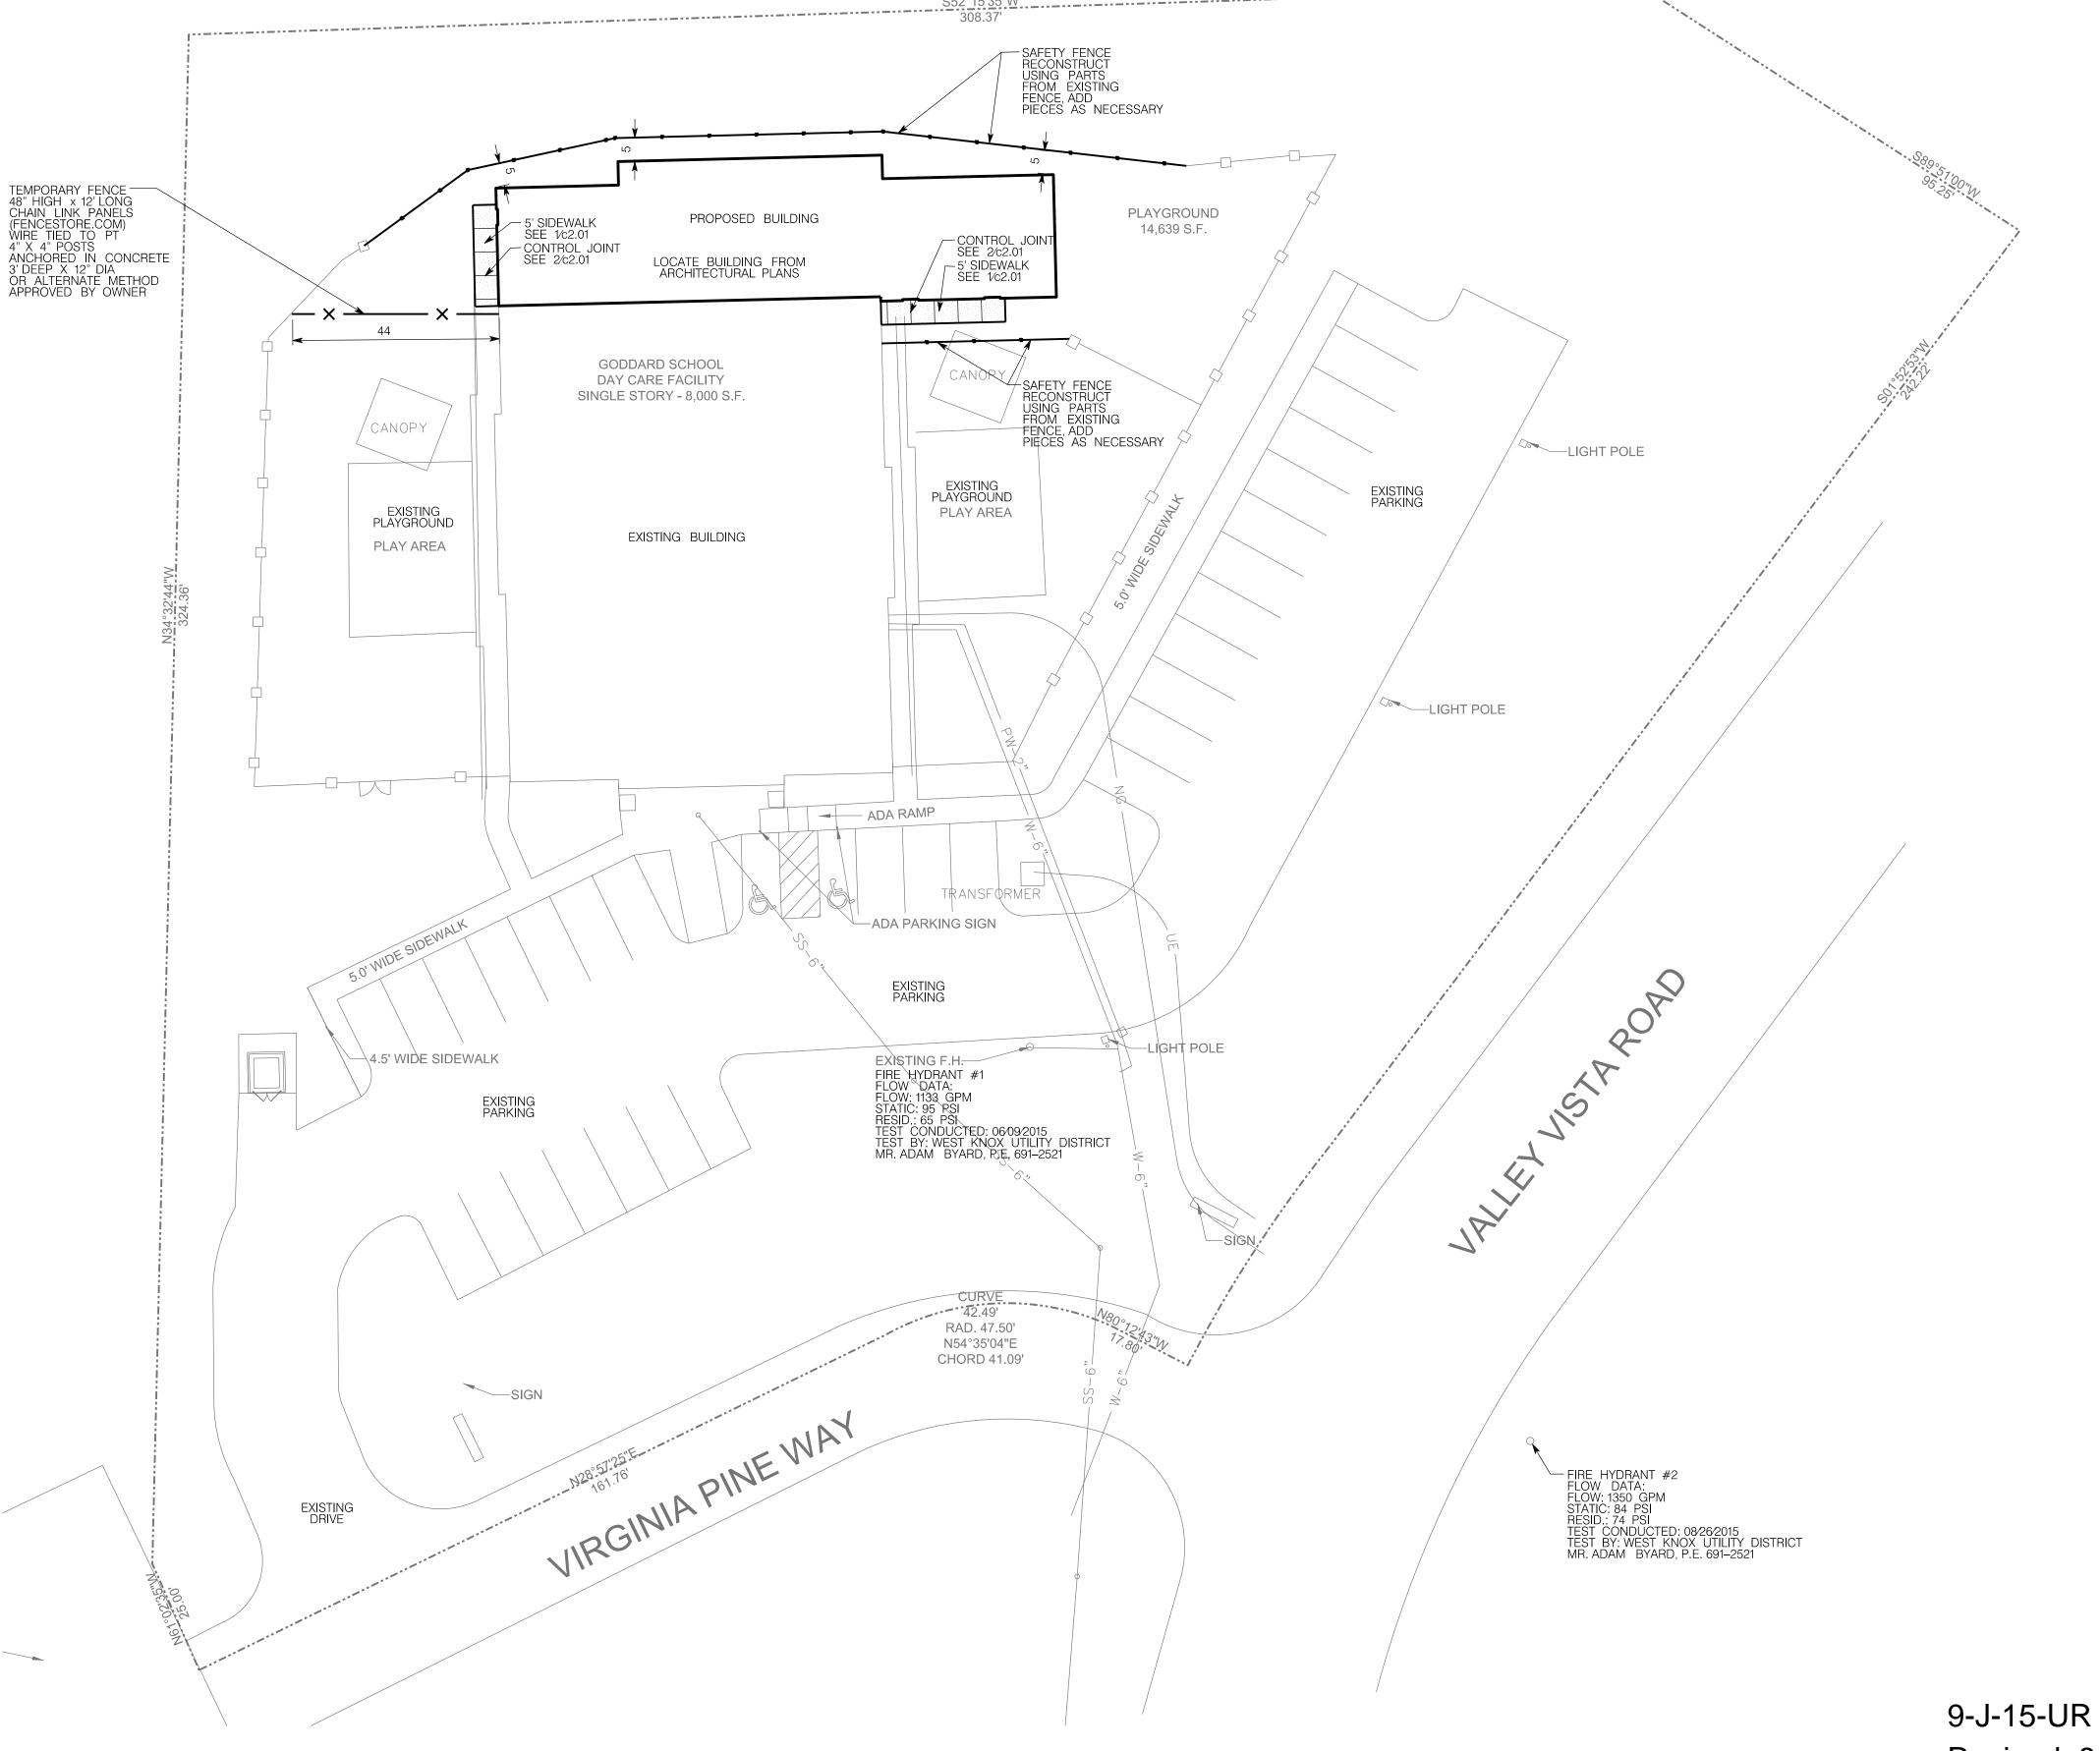LEGEND:

EXISTING

____ 535 ____

535.25

Θ-----Θ

PROPOSED

535.25

GROUND CONTOUR ELEVATION

SPOT ELEVATION

STRUCTURE

PROPERTY LINE


CONCRETE PAVEMENT

ASPHALT PAVEMENT

SITE LAYOUT NOTES

- 1. USE: PRIVATE SCHOOL, ZONING PC/TO, CLT 103 12006
- 2. TOTAL BUILDING AREA: EXIST: 8,353, PROPOSED: 3,270 SF
- 3. TOTAL SITE: 2.14 AC, TOTAL DIST AREA: .20 AC, TOTAL IMPERV: 0.09 AC
- 4. DEED REFERENCE: 20080917-0019168 PLAT REFERENCE: 20070618-0103903
- 5. THIS PROPERTY IS NOT IN AN AREA DESIGNATED AS A SPECIAL FLOOD HAZARD AREA. REFERENCE FEMA MAP 0233G.
- 6. SITE BENCHMARK: CONTACT SURVEYOR FOR SITE BENCHMARK. DATUM NGVD.
- 7. SITE BOUNDARY AND TOPOGRAPHIC INFORMATION IS BASED ON INFORMATION PROVIDED ARCHITECT OF ANY DISCREPANCIES. THE ARCHITECT AND THE ENGINEER ACCEPT NO RESPONSIBILITY FOR THE ACCURACY AND/OR COMPLETENESS OF EXISTING CONDITIONS INFORMATION PROVIDED BY THE OTHERS.
- 8. UTILITY INFORMATION IS BASED ON INFORMATION OBTAINED FROM THE UTILITY PROVIDERS. THE CONTRACTOR IS REPSONSIBLE FOR DETERMINING THE ACCURACY OF THIS INFORMATION.
- 9. PARKING SUMMARY: TOTAL REQUIRED: 27 SPACES TOTAL PROVIDED: 31 SPACES HANDICAP SPACES REQUIRED: 2 PROVIDED: 2
- 10 SETBACKS: FRONT: 25'
- SIDE: 16' REAR: 20'
- 11. THE CONTRACTOR SHALL OBTAIN ALL REQUIRED PERMITS AND LICENSES FOR EXECUTION OF THE WORK. ALL MATERIALS AND EXECUTION OF THE WORK SHALL BE IN ACCORDANCE WITH FEDERAL, STATE, AND LOCAL LAWS, RULES AND REGULATIONS.
- 12. CONTRACTOR SHALL COMPLY WITH ALL PERTINENT PROVISIONS OF THE 'MANUAL OF ACCIDENT PREVENTION IN CONSTRUCTION' ISSUED BY THE AGC OF AMERICA, INC. AND THE SAFETY AND HEALTH REGULATIONS FOR CONSTRUCTION ISSUED BY THE US DEPARTMENT OF LABOR. ALL CONSTRUCTION SHALL BE PERFORMED IN ACCORDANCE WITH THE TENNESSEE DEPARTMENT OF ENVIRONMENT AND CONSERVATION EROSION AND SEDIMENT CONTROL HANDBOOK.
- 13. VERIFY SITE CONDITIONS, DIMENSIONS, ELEVATIONS, AND LOCATION OF EXISTING FEATURES BEFORE STARTING WORK. THE OWNERS REPRESENTATIVE SHALL BE NOTIFIED OF ANY INTERFERENCES OR DISCREPANCIES.
- 14. TRAFFIC CONTROL IN CONSTRUCTION AREAS TO BE INSTALLED AND MAINTAINED IN ACCORDANCE WITH THE MANUAL ON UNIFORM TRAFFIC CONTROL
- MPC RATIOS: GAC: 11,623/93,218 = 0.12 FAR: 11,623/93,218 = 0.12 IAR: 34,858/93,218 = 0.37


KEY	EXISTING QUANTITY	NEW QUANTITY	BOTANICAL NAME	COMMON NAME	SIZE	NOTES
SHAD	E TREES					
QA	7	5	QUERCUS ALBA	WHITE OAK	3" cal.	6' CT, FULL & MATCHED
AC	0	7	ABIES CONCOLOR	WHITE FIR	3" cal.	6' CT, FULL & MATCHED
CN	1	1	CORNUS	DOGWOOD	2" cal.	6' CT, FULL & MATCHED
SHRU	BS					
CA	49	0	CALLICARPA AMERICANA	AMERICAN BEAUTYBERRY	3 gal.	
IG	45	0	ILEX GLABRA	INKBERRY HOLLY	3 gal.	
IV	22	0	ITEA VIRGINICA	VIRGINIA SWEETSPIRE	3 gal.	
HQ	3	0	HYDRANGEA QUERCIFOLIA	OAKLEAF HYDRANGEA	3 gal.	
LV	33	0	ILEX VERTICILLATA	WINTERBERRY RED SPRITE	3 gal.	
GROL	INDCOVER					
HHR	0	12	HEMEROCALLIS 'HAPPY RETURNS'	HAPPY RETURNS DAYLILY	1 gal.	18" O.C.
LMB	0	40	LIRIOPE MUSCARI 'BIG BLUE'	BIG BLUE LIRIOPE	1 gal.	18" O.C.

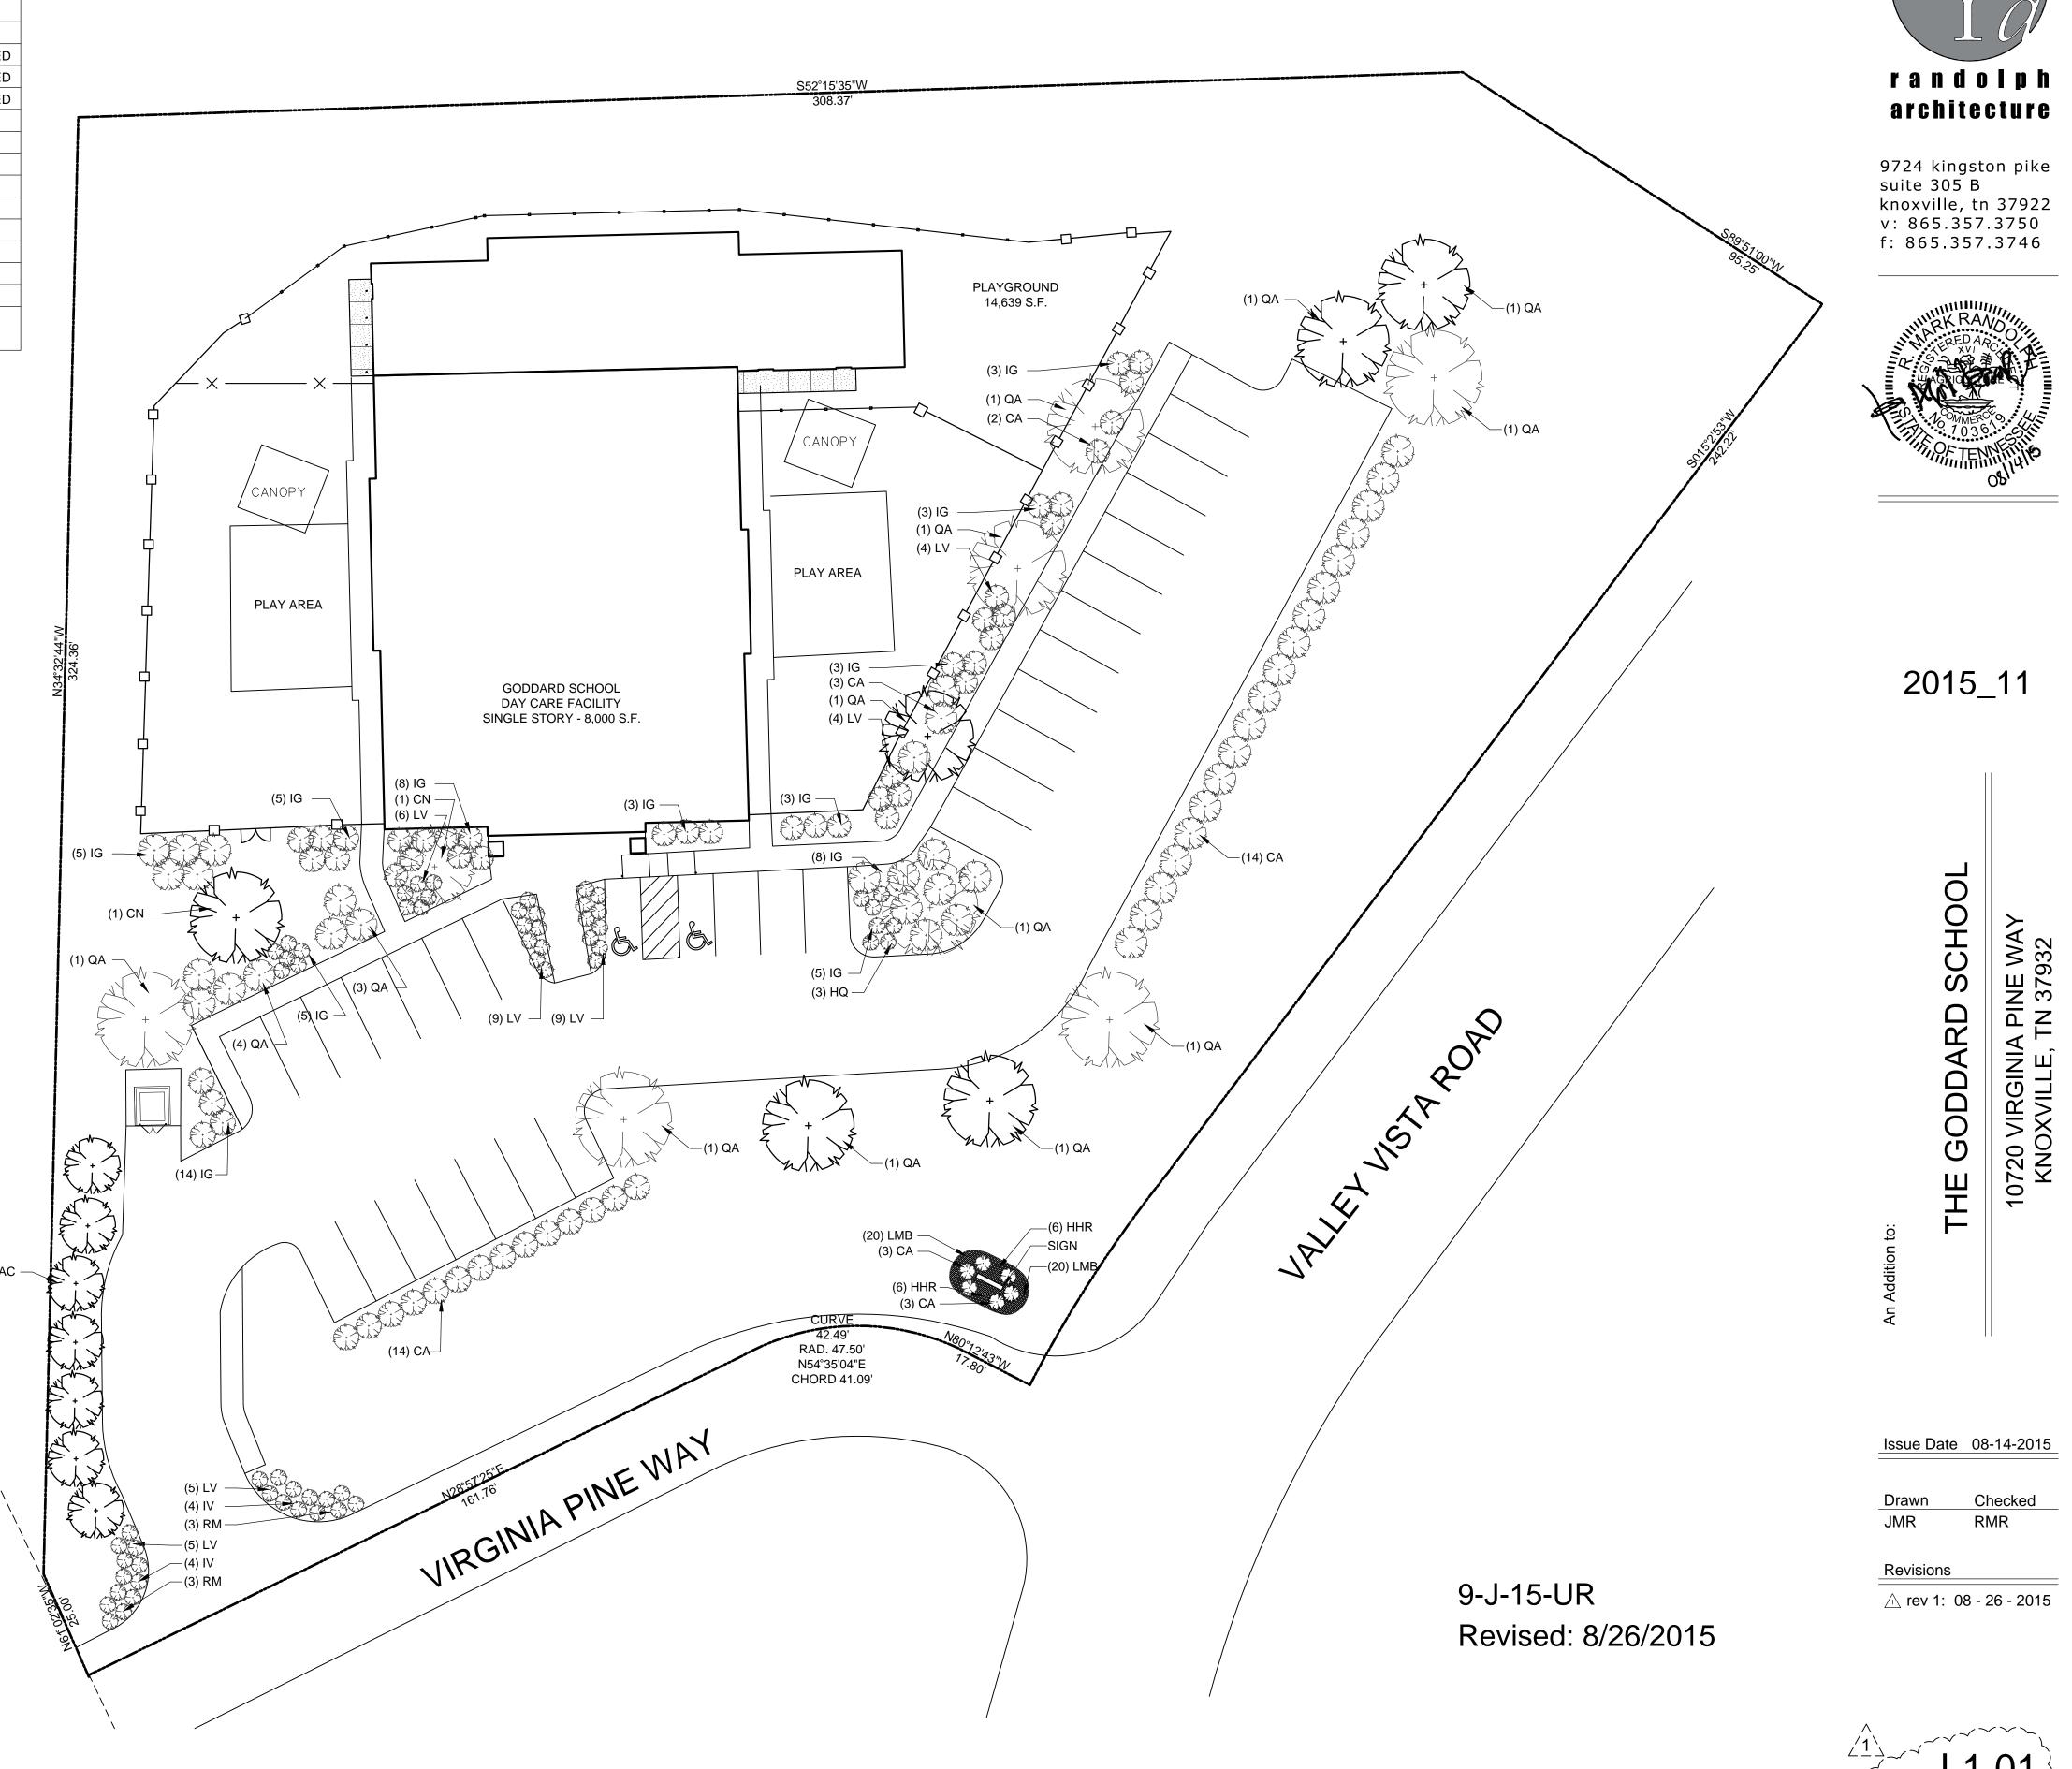


LANDSCAPE PLAN


SCALE: 1: = 20'-0"



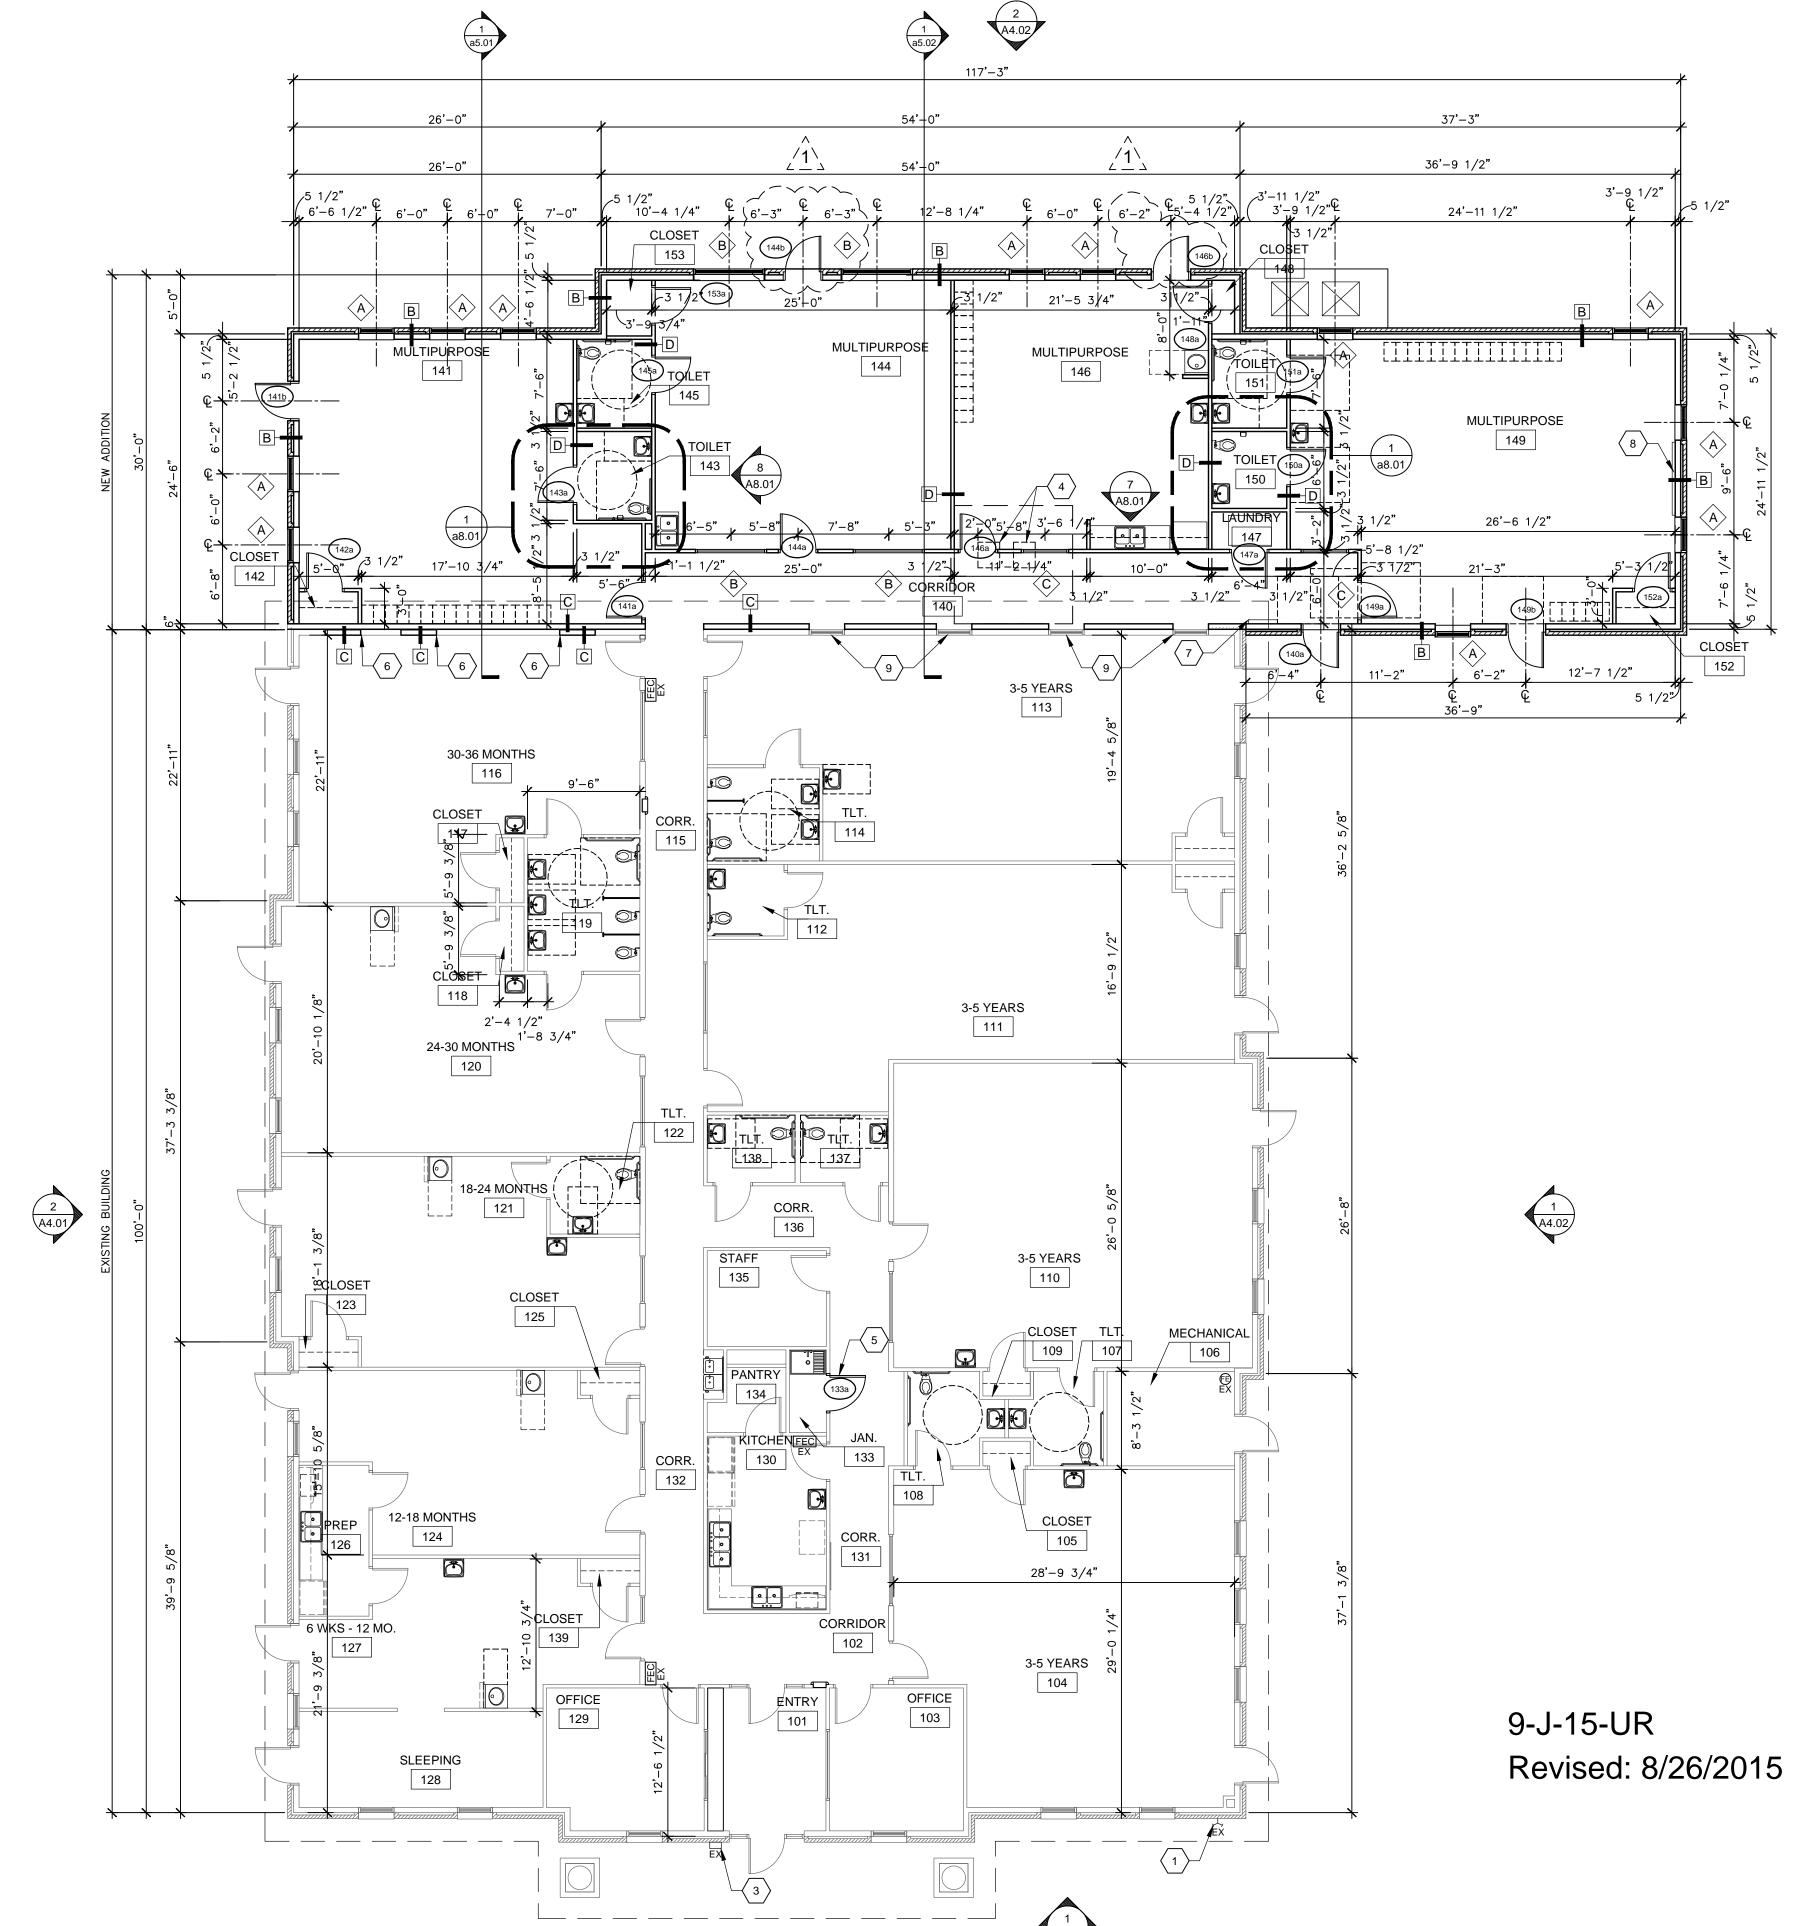

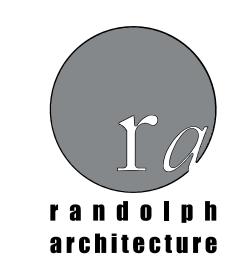

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THE GODDARD SCHOOL
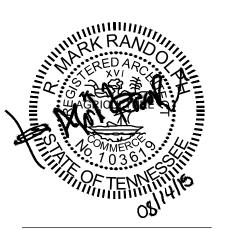
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KNOXVILLE, TN 37932

n Addition to:

Issue Date 08-14-2015

Drawn Checked
JMR RMR

Revisions

a1.01

FLOOR PLAN

5. NEW DOOR, FRAME & HARDWARE - SEE DOOR SCHEDULE
6. PATCH AND REPAIR GYP. BD. ON THIS SIDE. PAINT TO MATCH EXISTING

MECHANICAL SHEETS

KEYNOTES (x)

EXISTING FDC TO REMAIN

3. EXISTING KNOX BOX TO REMAIN

REMOVED

2. EXISTING STONE AND E.I.F.S. VENEER TO BE

4. NEW MECHANICAL UNITS ABOVE, SEE RCP &

7. NEW ELECTRICAL PANEL - SEE ELECTRICAL SHEETS

8. SMART BOARD LOCATION

9. EXISTING WINDOWS TO REMAIN

10. EXISTING SIDEWALK TO BE REMOVED

11. REMOVE GUTTER & DOWNSPOUTS ON THIS FACADE.

GENERAL NOTE S2.- FETWORR BIPLEAR NOCATED.

EXISTING CLEANOUT TO REMAIN. COORDINATE WIT

NEW FINISH FLOOR SLAB AND VCT FLOORING

1. CONTRACTOR TO VERIFY AND COORDINATE ALL DIMENSIONS PRIOR TO PROCEEDING
WITH WORK. NOTIFY ARCHITECT OF ANY EXISTING FOR PROCEEDING
WITH WORK.

2. ALL DIMENSIONS ARE FACE OF MTL. STUDS, UNLESS OTHERWISE NOTED 15. EXISTING LIGHT FIXTURE TO BE REMOVED - SEE R

3. WORK TO COMPLY WITH ALL GOVERNING AUTHORITIES HAVING JURISDICTION

16. EXISTING WINDOW TO BE REMOVED

4. PROVIDE SOLID WOOD BLOCKING AS REQUIRED FOR ALL WALL MOUNTED ITEMS SUCH AS BUT NOT LIMITED TO: COUNTERTOPS SHELVING, RESTROOM ACCESSORIES, HANDRAILS,

FIRE EXTINGUISHERS, ETC.

5. CONTRACTOR TO VERIFY WITH OWNER FOR MILLWORK FINISHES AND INSTALLATION

PRIOR TO BUILD OUT.

6. CONTRACTOR TO VERIFY WITH OWNER ALL FLOOR FINISHES PRIOR TO CONSTRUCTION

7. DOORS AND DOOR HARDWARE TO MATCH EXISTING TYPE AND MATERIALS

8. NEW EGRESS SIGNAGE AND/OR LIGHTING AS REQUIRED

EQUIPMENT AS REQUIRED.

9. ADJUST EXISTING EMERGENCY LIGHTING AND FIRE SAFETY EQUIPMENT TO RETAIN FUNCTIONALITY AS REQUIRED. NEW EMERGENCY LIGHTING AND FIRE SAFETY

10. FURNISH FIRE EXTINGUISHER AS REQUIRED AND VERIFY LOCATION WITH FIRE MARSHALL PRIOR TO INSTALLATION.

WALL LEGEND

STONE VENEER AND E.I.F.S. OVER 2X6 WD. STUDS W/
GYP. BD. ON INTERIOR SIDE

EXISTING NON RATED INTERIOR WALL TO REMAIN - 2X4
WD. STUDS W/ GYP. BD. ON BOTH SIDES

EXISTING WALL TO BE REMOVED

EXISTING NON RATED EXTERIOR WALL TO BE MODIFIED -

EXISTING NON RATED EXTERIOR WALL TO REMAIN -

EXISTING NON RATED EXTERIOR WALL TO BE MODIFIED A
EXISTING STONE VENEER AND E.I.F.S. TO BE REMOVED
2X6 WD. STUDS W/ GYP. BD. ON INTERIOR SIDE TO
REMAIN


NEW NON RATED EXTERIOR WALL - STONE VENEER AND E.I.F.S. OVER VAPOR BARRIER OVER 1/2" PLYWOOD SHEATHING OVER 2X6 WD. STUDS AT 16" O.C. W/ GYP. BD. ON INTERIOR SIDE W/ R-19 BATT INSULATION

NEW INTERIOR WALL - 2X6 WD. STUDS AT 16" O.C. W/

GYP. BD. ON BOTH SIDES


NEW INTERIOR WALL - 2X4 WD. STUDS AT 16" O.C. W/
GYP. BD. ON BOTH SIDES

SCALE: 1/8"=1'-0"

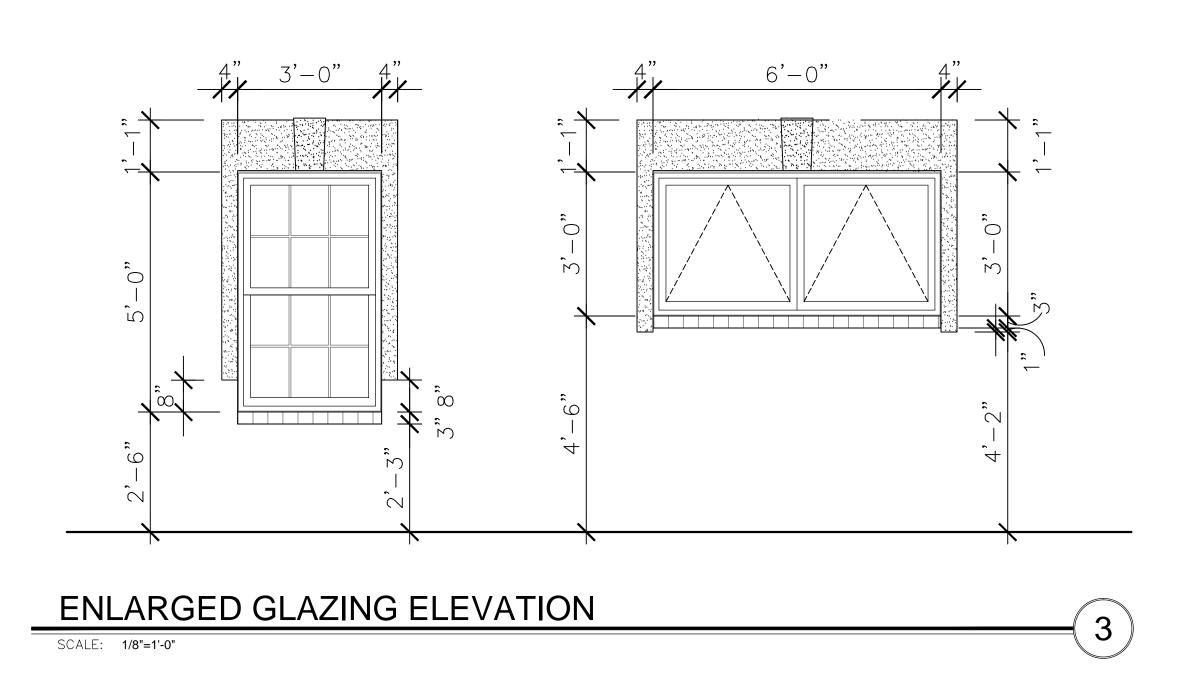

FRONT ELEVATION (NORTH)

SCALE: 1/8"=1'-0"

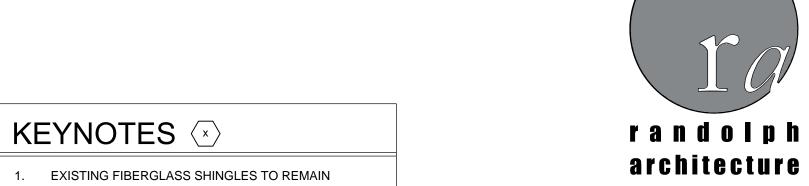

2. EXISTING STONE VENEER TO REMAIN

4. NEW FIBERGLASS SHINGLES TO MATCH EXISTING

5. NEW STONE VENEER TO MATCH EXISTING

9. RIDGE VENT - COLOR TO MATCH EXISTING

10. E.I.F.S. SURROUND - SEE DETAIL 3/A4.01

3. EXISTING COLUMNS TO REMAIN

6. NEW E.I.F.S. TO MATCH EXISTING


8. EXISTING E.I.F.S. TO REMAIN

7. NEW CRICKET

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THE GODDARD SCHOOL

THE GODDARD SCHOOL®

TRUSS BEARING
19-2 14

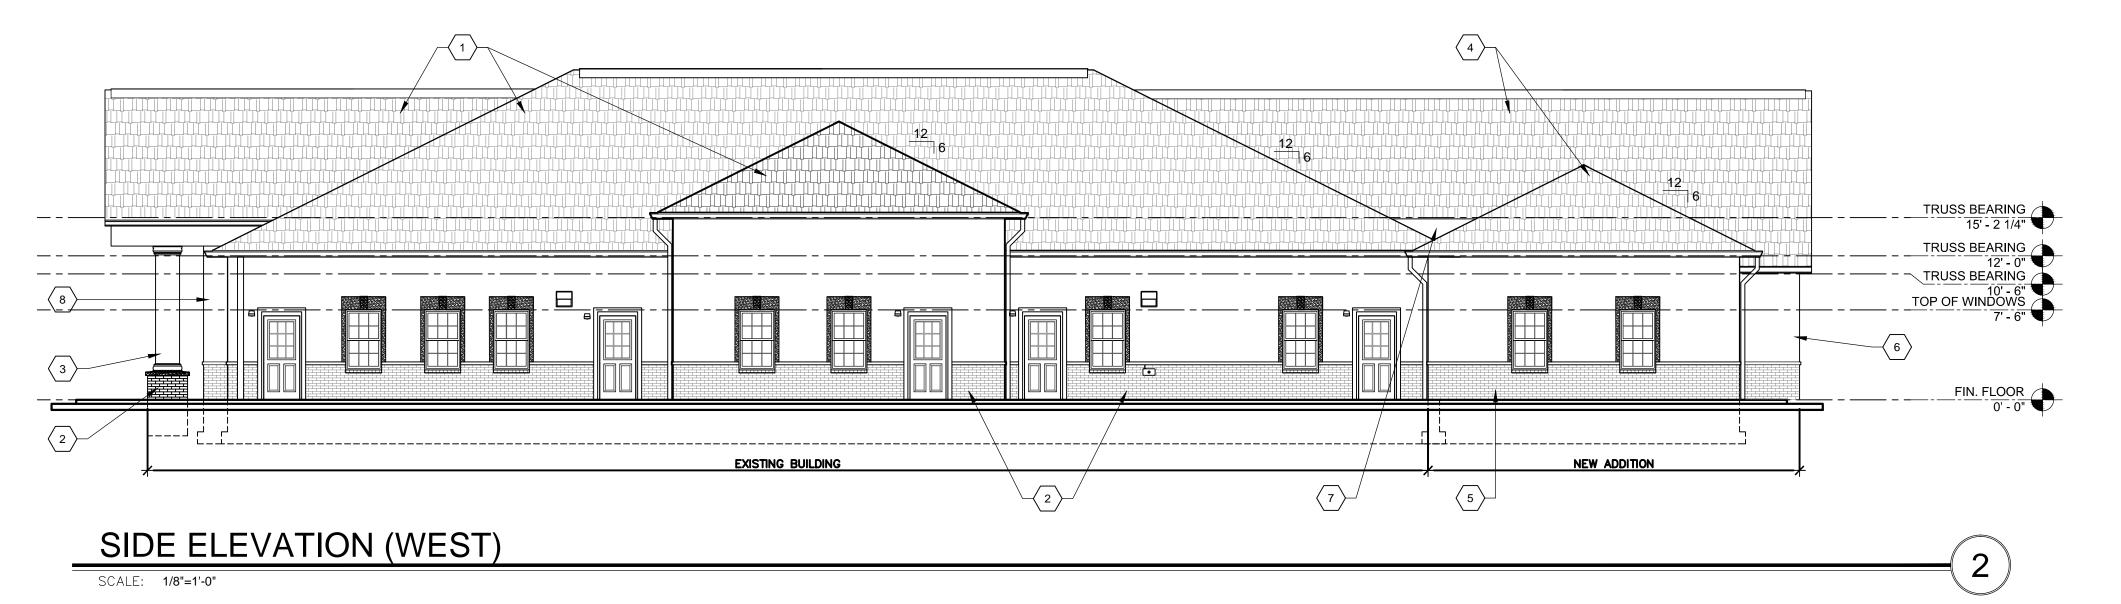TRUSS BEARING
19-2 14

TRUSS BEARING
19-2 10

T

9-J-15-UR Revised: 8/26/2015

a4.01

Issue Date 08-14-2015

Revisions

exterior elevations




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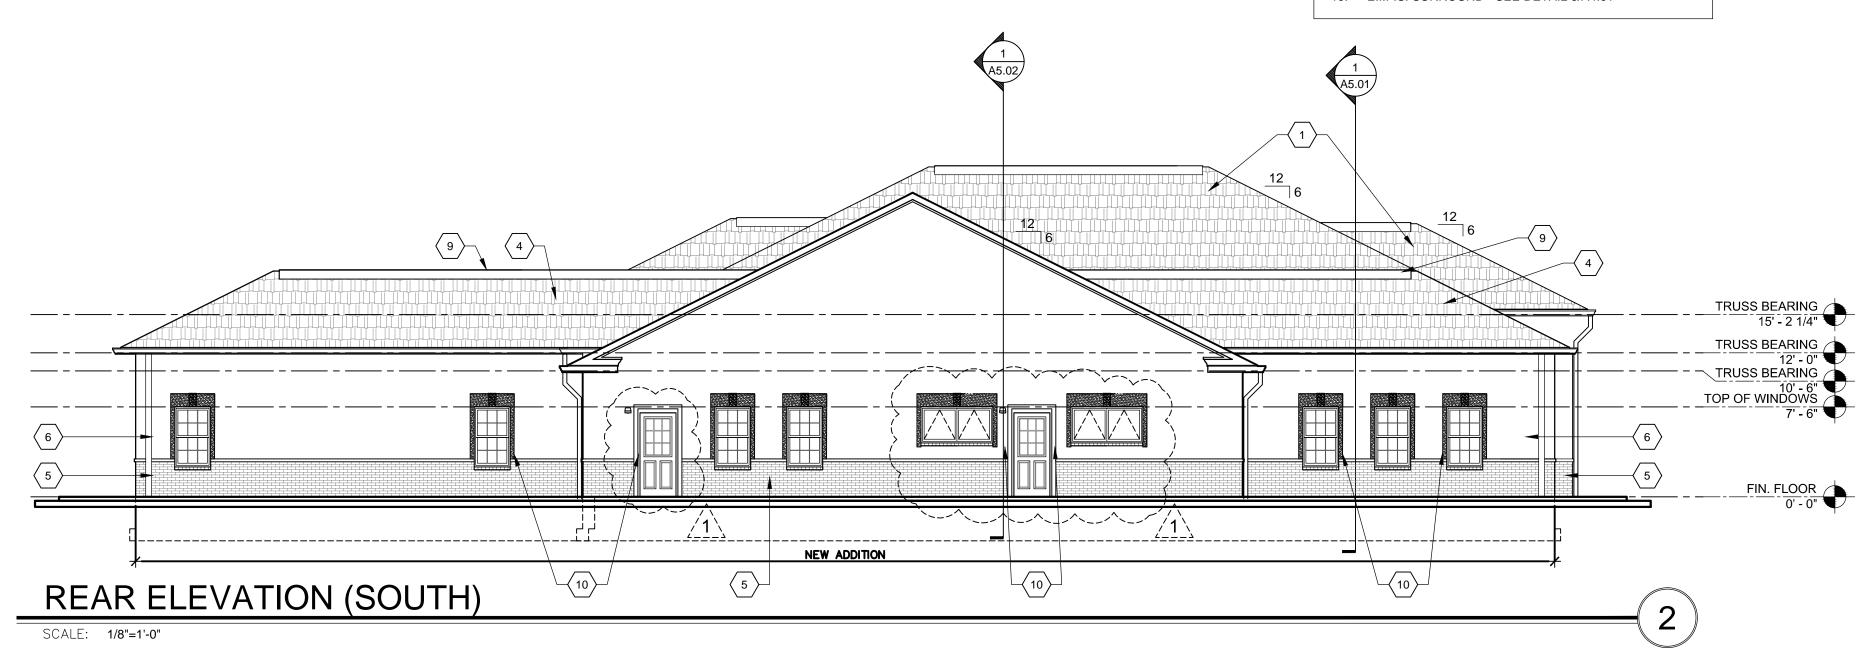
THE GODDARD SCHOOL

Issue Date 08-14-2015





- 3. EXISTING COLUMNS TO REMAIN
- 4. NEW FIBERGLASS SHINGLES TO MATCH EXISTING
- 5. NEW STONE VENEER TO MATCH EXISTING
- 6. NEW E.I.F.S. TO MATCH EXISTING
- 7. NEW CRICKET
- 8. EXISTING E.I.F.S. TO REMAIN
- 9. RIDGE VENT COLOR TO MATCH EXISTING
- 10. E.I.F.S. SURROUND SEE DETAIL 3/A4.01

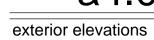

9-J-15-UR

Revised: 8/26/2015

FIN. FLOOR 0' - 0" NEW ADDITION

SIDE ELEVATION (EAST)

SCALE: 1/8"=1'-0"